

LEGAL DESCRIPTION

SAID LANDS SITUATE IN THE CITY OF PORT ST. LUCIE, ST. LUCIE COUNTY, FLORIDA.

CONSTRUCTION PLANS

FOR

LTC Ranch Pod 9 - Phase 1

LOCATED IN

CITY OF PORT ST LUCIE, FLORIDA SECTIONS 03, TOWNSHIP 36S, RANGE 39E

> N MIDWAY ROAD POD 2

> > **VICINITY MAP**

PROJECT TEAM

OWNER/DEVELOPER MIDWAY GLADES DEVELOPERS, LLC 7807 BAYMEADOWS ROAD E, SUITE 205 JACKSONVILLE, FL 32256 (904) 996-2485

PLANNER/L.A. STEVE GARRETT, R.L.A. LUCIDO AND ASSOCIATES, INC. 701 SE OCEAN BLVD. STUART, FL 34994 (772) 220-2100

KIMLEY-HORN AND ASSOCIATES, INC. 445 24TH STREET, SUITE 200 VERO BEACH, FLORIDA 32960 (772) 794-4100 FAX (772) 794-4130

CIVIL ENGINEER

KINAN HUSAINY, P.E.

SURVEYOR DAVID P. LINDLEY R.L.S. CAUFIELD & WHEELER 7900 GLADES ROAD SUITE 100 BOCA RATON, FL. 33434 ENVIRONMENTAL EW CONSULTANTS 601 HERITAGE DRIVE SUITE 108 JUPITER, FL. 33458

ADDITIONAL GOVERNING AGENCIES CONTACTS:

PLANNING/ZONING CITY OF PORT ST. LUCIE 121 S.W. PORT ST. LUCIE BLVD PORT ST. LUCIE, FL 34984 (772) 871-5212

PROJECT LOCATION

FIRE CHIEF **STORMWATER** ST. LUCIE COUNTY FIRE DEPT. GLEN GAREAU 5160 N.W. MILNER DRIVE PORT ST. LUCIE, FL 34983 3301 GUN CLUB ROAD (772) 621-3400 WEST PALM BEACH, FL 33406 (561) 686-8800

ENGINEERING CITY OF PORT ST. LUCIE S. FL. WATER MANAGEMENT DISTRICT 121 S.W. PORT ST. LUCIE BLVD PORT ST. LUCIE, FL 34984 (772) 871-5100

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GOVERNING DESIGN STANDARDS:

FLORIDA DEPARTMENT OF TRANSPORTATION, FY2023-2024 STANDARD PLANS FOR ROAD AND BRIDGE CONSTRUCTION AND APPLICABLE INTERIM REVISIONS (IRS). STANDARD PLANS FOR ROAD CONSTRUCTION AND ASSOCIATED IRS ARE AVAILABLE AR THE FOLLOWING WEBSITE

HTTP://WWW.FDOT.GOV/DESIGN/STANDARDPLANS

GOVERNING SPECIFICATIONS:

CITY OF PORT ST. LUCIE PUBLIC WORKS DEPARTMENT ENGINEERING STANDARDS FOR LAND DEVELOPMENT (MOST CURRENT EDITION). AS AMENDED BY CONTRACT DOCUMENTS.

> PREPARED BY: Kimley» Horn

THE SITE CONSTRUCTION STAKEOUT SHALL BE PERFORMED UNDER THE DIRECTION OF A FLORIDA REGISTERED SURVEYOR. AUTOCAD FILES WILL BE FURNISHED TO AID IN THE SITE CONSTRUCTION STAKEOUT. ANY DISCREPANCIES FOUND BETWEEN AUTOCAD FILES AND SITE CONSTRUCTION PLANS SHALL BE BROUGHT TO THE ENGINEER'S ATTENTION FOR CLARIFICATION PRIOR TO THAT STAKEOUT.

THIS PROJECT UTILIZES THE PSLUSD 2019 STANDARDS AND SPECIFICATIONS,

EFFECTIVE DATE OF 01/01/2019.

11-642-06

SUNSHINE STATE ONE CALL OF FLORIDA, INC. ELEVATIONS SHOWN HEREON ARE BASED ON THE NORTH AMERICAN VERTICAL DATUM OF 1988 (NAVE '88). SUBTRACT 1.50' FROM NGVD '29 ELEVATION TO GET THE NAVD '88 ELEVATION. CITY OF PORT ST. LUCIE PROJECT #

BEFORE YOU DIG

IT'S THE LAW! **DIAL 811**

P22-301 / P23-153

SHEE

GENERAL NOTES:

- 1. ALL WORK AND MATERIALS SHALL BE IN ACCORDANCE WITH ALL RELATIVE CITY OF PORT ST. LUCIE ENGINEERING STANDARDS FOR LAND DEVELOPMENT AND FDOT STANDARD SPECIFICATIONS FOR ROAD AND BRIDGE CONSTRUCTION (LATEST EDITION), AND FDEP REGULATIONS, EXCEPT AS MODIFIED HEREIN.
- 2. CONTRACTOR SHALL BE RESPONSIBLE FOR OBTAINING ALL NECESSARY PERMITS, NOC'S AND INSURANCE REQUIRED FOR THE WORK.
- 3. CONTRACTOR IS RESPONSIBLE FOR SCHEDULING A PRE-CONSTRUCTION INSPECTION OF THE SITE PRIOR TO THE BEGINNING OF THE WORK. CONTRACTOR SHALL INFORM THE OWNER, COMPANY REPRESENTATIVE, CEC, UTILITY AUTHORITY AND INTERESTED AGENCIES AT LEAST 48 HOURS PRIOR TO THE SCHEDULED INSPECTION.
- 4. THE LOCATION OF UTILITIES SHOWN ON THE DRAWINGS ARE FROM THE SURVEY PROVIDED BY CAUFIELD & WHEELER, INC. ON DECEMBER 2, 2020. IT IS THE CONTRACTOR'S RESPONSIBILITY TO CONFIRM, IN THE FIELD, THE LOCATION AND ELEVATION OF ALL UTILITIES PRIOR TO THE COMMENCEMENT OF CONSTRUCTION. SHOULD CONDITIONS VARY FROM THOSE SHOWN ON THE PLANS, THE CONTRACTOR SHALL IMMEDIATELY NOTIFY THE ENGINEER PRIOR TO CONTINUING CONSTRUCTION.
- 5. CONTRACTOR SHALL LOCATE, VERIFY AND IDENTIFY ALL EXISTING UNDERGROUND UTILITIES SHOWN, OR NOT SHOWN, ON THE PLANS PRIOR TO ANY EXCAVATING ACTIVITIES.
- 6. CONTRACTOR SHALL TAKE ALL MEASURES NECESSARY TO PROTECT EXISTING AND NEWLY CONSTRUCTED UTILITIES DURING THE CONSTRUCTION. SHOULD ANY UTILITY LINE OR COMPONENT BECOME DAMAGED OR REQUIRE RELOCATION, THE CONTRACTOR SHALL IMMEDIATELY NOTIFY THE RESPONSIBLE UTILITY COMPANY AND THE ENGINEER.
- 7. CONTRACTOR SHALL BE RESPONSIBLE FOR ANY DAMAGE TO EXISTING UTILITIES CAUSED BY HIS OPERATIONS.
- 8. CONTRACTOR SHALL COORDINATE ALL CONSTRUCTION WITH OTHER WORK WHICH MAY BE ONGOING ADJACENT TO, OR AFFECTING, THIS CONSTRUCTION. CONTRACTOR SHALL COOPERATE WITH OTHER CONTRACTORS AND ALL AFFECTED UTILITY COMPANIES.
- 9. CONTRACTOR SHALL NOTIFY ALL APPLICABLE UTILITY COMPANIES AND THE ENGINEER 48 HOURS PRIOR TO THE INITIATING OF ANY EXCAVATION ACTIVITIES, OR AS SPECIFIED BY THE UTILITY COMPANY AND ANY PERMITS REQUIRED FOR THE WORK.
- 10. CONTRACTOR SHALL PROTECT EXISTING SURVEY MARKERS, MONUMENTS, ETC. DURING CONSTRUCTION. CONTRACTOR SHALL RESTORE/REPLACE ANY SURVEY MARKERS DAMAGED DURING CONSTRUCTION ACTIVITIES.
- 11. CONTRACTOR SHALL BE RESPONSIBLE FOR THE REMOVAL/DISPOSAL OF ANY UNSUITABLE MATERIAL FROM THE CONSTRUCTION OPERATION, FURNISHING AND COMPACTING SUITABLE REPLACEMENT BACKFILL MATERIAL. DISPOSAL OF UNSUITABLE MATERIAL SHALL BE IN ACCORDANCE WITH ALL FEDERAL, STATE AND LOCAL REGULATIONS.
- 12. CONSTRUCTION WARNING SIGNS SHALL BE MOUNTED AND ERECTED BEFORE CONSTRUCTION CAN COMMENCE. THESE, AND ALL TRAFFIC CONTROL DEVICES, SHALL FOLLOW THE STANDARDS SET FORTH BY THE MANUAL OF UNIFORM TRAFFIC DEVICES (MUTCD) AND FLORIDA DEPARTMENT OF TRANSPORTATION (FDOT) STANDARD INDEX.
- 13. CONTRACTOR SHALL BE RESPONSIBLE FOR CLEARLY IDENTIFYING THE AREA OF CONSTRUCTION AND SAFELY ROUTING ALL VEHICULAR AND PEDESTRIAN TRAFFIC AROUND THE CONSTRUCTION AREA. THE CONSTRUCTION AREA SHALL BE CLEARLY MARKED AT ALL TIMES.
- 14. CONTRACTOR SHALL PROVIDE AND MAINTAIN ADEQUATE EROSION AND TURBIDITY CONTROLS IN ACCORDANCE WITH FDEP DURING AND FOLLOWING CONSTRUCTION, UNTIL ALL DISTURBED AREAS HAVE BEEN STABILIZED TO AVOID ADVERSE ENVIRONMENTAL IMPACTS TO OFF-SITE PROPERTY AND DRAINAGE SYSTEMS.
- 15. CONTRACTOR SHALL HYDRO SEED AND MULCH (OR SOD AS APPLICABLE) ALL AREAS DISTURBED BY THE CONSTRUCTION OF THIS PROJECT ACCORDING TO LOCAL REGULATIONS.
- 16. CONTRACTOR SHALL MAINTAIN "AS-BUILT" INFORMATION ON A REGULAR BASIS. CONTRACTOR SHALL EMPLOY THE SERVICES OF A SURVEYOR REGISTERED IN THE STATE OF FLORIDA TO DETERMINE ALL "AS-BUILT" INFORMATION. WITHIN 14 DAYS OF THE COMPLETION OF THE WORK, CONTRACTOR SHALL PROVIDE SIGNED AND SEALED COPIES AND THE DIGITAL CAD FILE OF THE "AS-BUILT" DRAWINGS AND SUPPORTING SURVEY RECORDS TO THE ENGINEER. "AS-BUILT" DRAWINGS ARE TO BE IN ACCORDANCE WITH THE CITY OF PORT ST. LUCIE REQUIREMENTS.
- 17. IT SHALL BE THE RESPONSIBILITY OF THE CONTRACTOR TO PRODUCE, AS-BUILT DRAWINGS FOR ANY JURISDICTIONAL AGENCIES AS MAY BE REQUIRED FOR PROJECT CERTIFICATION.
- 18. CONTRACTOR SHALL GIVE THE ENGINEER A MINIMUM OF 48 HOURS NOTICE OF ALL MEETINGS OR TESTING MEASURES REQUIRED TO BE WITNESSED BY THE CONSTRUCTION ACTIVITIES RELATED TO THE WORK.
- 19. THE CONTRACTOR SHALL SUBMIT FIVE (5) SETS OF STANDARD SHOP DRAWINGS AND MANUFACTURER'S CATALOGS WITH THE MODEL NUMBER OR TYPE OF THE ITEM ENCIRCLED OR OTHERWISE DESIGNATED. THE SUBMITTALS SHALL BEAR THE APPROVAL OF THE UNDERGROUND UTILITY CONTRACTOR. ALL UTILITY SHOP DRAWINGS WILL NEED TO BE APPROVED BY THE ENGINEER OF RECORD AND CITY OF PORT ST. LUCIE PRIOR TO CONSTRUCTION.
- 20. THE CONTRACTOR SHALL SUBMIT FIVE (5) SETS OF COMPLETE DETAILED SHOP DRAWINGS FOR ALL SANITARY MANHOLES, WET WELLS, OTHER CASTINGS, AND PUMPS. THE SUBMITTALS SHALL BEAR THE APPROVAL OF THE UNDERGROUND UTILITY CONTRACTOR ON EACH SHEET. A COMPLETE SET OF THE LIFT STATION ELECTRICAL SHOP DRAWINGS IS ALSO REQUIRED IF APPLICABLE. ALL UTILITY SHOP DRAWINGS WILL NEED TO BE APPROVED BY THE ENGINEER OF RECORD AND CITY OF PORT ST. LUCIE PRIOR TO CONSTRUCTION.

GENERAL UTILITY NOTES:

- 1. ALL WORK SHALL BE PERFORMED IN ACCORDANCE WITH THE CITY OF PORT ST LUCIE UTILITY SYSTEMS DEPARTMENT UTILITY STANDARDS MANUAL AND THE CITY OF PORT ST. LUCIE LAND DEVELOPMENT CODE, DETAILS AND SPECIFICATIONS, AS WELL AS ALL APPLICABLE STATE AND LOCAL REGULATIONS, EXCEPT AS MODIFIED HEREIN.
- 2. IF SOLVENT CONTAMINATION IS FOUND IN ANY TRENCH, WORK WILL BE STOPPED AND THE CEC, OWNER, AND THE PROPER AUTHORITIES NOTIFIED. THE ST. LUCIE COUNTY HEALTH DEPARTMENT MAY GRANT APPROVAL OF THE USE OF DUCTILE IRON PIPE, FITTINGS AND APPROVED SOLVENT RESISTANT GASKET MATERIAL IN THE CONTAMINATED AREA. THIS APPROVAL MUST BE GRANTED IN WRITING AND PROVIDED TO CEC, AND PROPERTY OWNER. DUCTILE IRON PIPE SHALL EXTEND AT LEAST 100 FEET BEYOND ANY CONTAMINATED
- 3. VERTICAL LOCATIONS OF ALL EXISTING UTILITIES SHOWN ON THE PLAN AND PROFILE SHEETS HAVE BEEN ASSUMED. CONTRACTOR SHALL EXERCISE CAUTION DURING EXCAVATION NEAR EXISTING UTILITIES SHOWN ON THE PLANS AND NOTIFY THE ENGINEER IF THE LOCATION DIFFERS FROM THAT SHOWN BEFORE CONTINUING WITH THE CONSTRUCTION.
- 4. UNSUITABLE MATERIALS UNDER PROPOSED PIPING SHALL BE REMOVED AND REPLACED WITH SELECT BACKFILL, PROPERLY COMPACTED TO 95% OF MAXIMUM DENSITY PER AASHTO T-180.
- 5. FITTINGS SHALL BE USED AT LOCATIONS INDICATED ON THE PLANS, UNLESS OTHERWISE APPROVED BY THE ENGINEER. THRUST BLOCKING SHALL BE USED WHERE REQUIRED BY THE CITY OF PORT ST. LUCIE.
- 6. THE LENGTH OF TRENCH OPEN AT ANY ONE TIME SHALL BE CONTROLLED BY THE PARTICULAR SURROUNDING CONDITIONS, BUT SHALL BE LIMITED TO 300 LINEAR FEET UNLESS APPROVED BY THE ENGINEER IN WRITING.
- 7. NO CONNECTIONS TO EXISTING POTABLE WATER SYSTEMS SHALL BE ALLOWED UNTIL ALL PROPOSED WATER LINES HAVE BEEN PRESSURE TESTED, DISINFECTED, CLEARED FOR SERVICE AND ACCEPTED BY THE CITY OF PORT ST. LUCIE AND FDEP.
- 8. THE BACTERIOLOGICAL SAMPLE POINTS SHALL BE INDICATED IN RED ON THE "AS BUILT" DRAWINGS PRIOR TO THE REQUEST FOR A LETTER OF RELEASE TO PLACE THE CONSTRUCTION INTO SERVICE. THE SAMPLE NUMBERS WILL CORRESPOND TO THOSE ON THE BACTERIOLOGICAL SAMPLE LAB SHEETS.

<u>WATER / SEWER SEPARATION:</u>

- 1. SANITARY SEWERS (INCLUDING LATERALS), FORCE MAINS, AND STORM SEWERS SHALL CROSS UNDER WATER MAINS WHENEVER POSSIBLE. SANITARY SEWERS, FORCE MAINS AND STORM SEWERS CROSSING WATER MAINS SHALL BE INSTALLED TO PROVIDE A MINIMUM VERTICAL DISTANCE OF 18 INCHES BETWEEN THE INVERT OF THE UPPER PIPE AND THE CROWN OF THE LOWER PIPE.
- 2. A FULL, UNCUT LENGTH OF WATER MAIN PIPE, AT LEAST 20 FEET IN LENGTH, SHALL BE CENTERED AT THE POINT OF CROSSING OF ALL WATER AND SEWER PIPING, REGARDLESS OF THE VERTICAL SEPARATION.
- 3. WATER MAINS SHALL BE LOCATED AT LEAST 10 FEET HORIZONTALLY FROM PIPES CARRYING RAW WASTEWATER, AND 10 FEET HORIZONTALLY FROM PIPES CARRYING RECLAIMED WATER. THE DISTANCE SHALL BE MEASURED FROM OUTSIDE EDGE OF PIPE TO OUTSIDE EDGE OF PIPE. WATER MAINS SHALL BE LAID TO PROVIDE A SEPARATION OF AT LEAST 18 INCHES BETWEEN THE BOTTOM OF WATER MAIN AND THE TOP OF SEWER OR RECLAIMED WATER PIPE. WATER MAINS SHALL CROSS ABOVE SEWER OR RECLAIMED WATER PIPE WITH A VERTICAL SEPARATION OF AT LEAST 18 INCHES.

WASTEWATER COLLECTION SYSTEMS

- 1. MATERIALS AND INSTALLATION FOR WASTEWATER COLLECTION SYSTEM INCLUDING, BUT NOT LIMITED TO, GRAVITY SEWERS, MANHOLES, SERVICE LATERALS, FORCEMAINS, LIFT STATIONS, AND TESTING REQUIREMENTS SHALL CONFORM TO THE CITY OF PORT ST LUCIE UTILITY SYSTEMS DEPARTMENT UTILITY STANDARDS MANUAL AND THE CITY OF PORT ST. LUCIE LAND DEVELOPMENT CODE AND ALL APPLICABLE FDEP REGULATIONS. ALL PVC GRAVITY SEWER SHALL BE SDR-26.
- 2. WYE GRAVITIES FOR LATERAL SERVICE SHALL BE SIX (6) INCHES I.D.
- 3. PLUGS SHALL BE OF THE SAME MATERIAL AS THE PIPE, GASKETED, AND SHALL WITHSTAND THE REQUIRED TEST PRESSURE.
- 4. LEAKAGE TEST SHALL BE IN ACCORDANCE WITH CITY OF PORT ST. LUCIE AND AWWA C-600, SECTION 5.2.

GENERAL SEPARATION NOTE:

1. ALL UTILITIES SHOULD BE KEPT TEN (10') APART (PARALLEL) OR WHEN CROSSING 18" VERTICAL CLEARANCE (OUTSIDE EDGE OF PIPE TO OUTSIDE EDGE OF PIPE)

WATER DISTRIBUTION SYSTEMS

1. MATERIALS AND INSTALLATION FOR WATER DISTRIBUTION SYSTEM INCLUDING, BUT NOT LIMITED TO, PIPE FITTINGS, VALVES, JOINT RESTRAINTS, FIRE HYDRANTS, SERVICE LINES, TESTING, AND DISINFECTION SHALL CONFORM TO THE CITY OF PORT ST LUCIE UTILITY SYSTEMS DEPARTMENT UTILITY STANDARDS MANUAL AND THE CITY OF PORT ST. LUCIE LAND DEVELOPMENT CODE AND ALL APPLICABLE FDEP REGULATIONS. ALL PVC PIPE SHALL BE SDR-18 UNLESS SPECIFIED OTHERWISE.

WATER AND SEWER UTILITY NOTES

- 1. THE CONTRACTOR SHALL CONSTRUCT GRAVITY SEWER LATERALS, MANHOLES GRAVITY SEWER LINES AND DOMESTIC WATER AND FIRE PROTECTION SYSTEM AS SHOWN ON THESE PLANS. THE CONTRACTOR SHALL FURNISH ALL NECESSARY MATERIALS, EQUIPMENT, MACHINERY, TOOLS, MEANS OF TRANSPORTATION AND LABOR NECESSARY TO COMPLETE THE WORK IN FULL AND COMPLETE ACCORDANCE WITH THE SHOWN, DESCRIBED AND REASONABLY INTENDED REQUIREMENTS OF THE CONTRACT DOCUMENTS AND JURISDICTIONAL AGENCY REQUIREMENTS. IN THE EVENT THAT THE CONTRACT DOCUMENTS AND THE JURISDICTIONAL AGENCY REQUIREMENTS ARE NOT IN AGREEMENT, THE MOST STRINGENT SHALL GOVERN.
- 2. ALL EXISTING UNDERGROUND UTILITY LOCATIONS SHOWN ARE APPROXIMATE. THE CONTRACTOR SHALL COMPLY WITH ALL REQUIREMENTS FOR UTILITY LOCATION AND COORDINATION IN ACCORDANCE WITH THE NOTES CONTAINED IN THE GENERAL CONSTRUCTION SECTION OF THIS SHEET.
- 3. THE CONTRACTOR SHALL RESTORE ALL DISTURBED VEGETATION IN KIND, UNLESS SHOWN OTHERWISE.
- 4. DEFLECTION OF PIPE JOINTS AND CURVATURE OF PIPE SHALL NOT EXCEED THE MANUFACTURER'S SPECIFICATIONS. SECURELY CLOSE ALL OPEN ENDS OF PIPE AND FITTINGS WITH A WATERTIGHT PLUG WHEN WORK IS NOT IN PROGRESS. THE INTERIOR OF ALL PIPES SHALL BE CLEAN AND JOINT SURFACES WIPED CLEAN AND DRY AFTER THE PIPE HAS BEEN LOWERED INTO THE TRENCH. VALVES SHALL BE PLUMB AND LOCATED ACCORDING TO THE
- 5. ALL PHASES OF INSTALLATION, INCLUDING UNLOADING, TRENCHING, LAYING AND BACK FILLING, SHALL BE DONE IN A FIRST CLASS WORKMANLIKE MANNER. ALL PIPE AND FITTINGS SHALL BE CAREFULLY STORED FOLLOWING MANUFACTURER'S RECOMMENDATIONS. CARE SHALL BE TAKEN TO AVOID DAMAGE TO THE COATING OR LINING IN ANY D.I. PIPE FITTINGS. ANY PIPE OR FITTING WHICH IS DAMAGED OR WHICH HAS FLAWS OR IMPERFECTIONS WHICH, IN THE OPINION OF THE ENGINEER OR OWNER, RENDERS IT UNFIT FOR USE, SHALL NOT BE USED. ANY PIPE NOT SATISFACTORY FOR USE SHALL BE CLEARLY MARKED AND IMMEDIATELY REMOVED FROM THE JOB SITE, AND SHALL BE REPLACED AT THE CONTRACTOR'S EXPENSE.
- 6. WATER FOR FIRE FIGHTING SHALL BE AVAILABLE FOR USE PRIOR TO COMBUSTIBLES BEING BROUGHT ON SITE.
- 7. ALL UTILITY AND STORM DRAIN TRENCHES LOCATED UNDER AREAS TO RECEIVE PAVING SHALL BE COMPLETELY BACK FILLED IN ACCORDANCE WITH THE GOVERNING JURISDICTIONAL AGENCY'S SPECIFICATIONS. IN THE EVENT THAT THE CONTRACT DOCUMENTS AND THE JURISDICTIONAL AGENCY REQUIREMENTS ARE NOT IN AGREEMENT, THE MOST STRINGENT SHALL GOVERN.
- 8. UNDERGROUND LINES SHALL BE SURVEYED BY A STATE OF FLORIDA PROFESSIONAL LAND SURVEYOR PRIOR TO BACK FILLING.
- 9. CONTRACTOR SHALL PERFORM, AT HIS OWN EXPENSE, ANY AND ALL TESTS REQUIRED BY THE SPECIFICATIONS AND/OR ANY AGENCY HAVING JURISDICTION. THESE TESTS MAY INCLUDE. BUT MAY NOT BE LIMITED TO. INFILTRATION AND EXFILTRATION, TELEVISION INSPECTION AND A MANDREL TEST ON GRAVITY SEWER. A COPY OF THE TEST RESULTS SHALL BE PROVIDED TO THE UTILITY PROVIDER, OWNER AND JURISDICTIONAL AGENCY AS REQUIRED.
- 10. IF THERE IS CONFLICT BETWEEN THESE STANDARDS AND THE PSLUSD UTILITY STANDARDS MANUAL, THE MORE STRINGENT SHALL APPLY.

GENERAL STRIPING AND SIGNAGE NOTES:

1. ALL STRIPING AND SIGNAGE SHALL BE IN ACCORDANCE WITH FDOT AND LATEST EDITION OF MUTCD

PAVING, GRADING AND DRAINAGE NOTES

- 1. THE CONTRACTOR AND SUBCONTRACTORS SHALL OBTAIN A COPY OF THE FLORIDA DEPARTMENT OF TRANSPORTATION "STANDARD SPECIFICATIONS FOR ROAD AND BRIDGE CONSTRUCTION" (LATEST EDITION) AND BECOME FAMILIAR WITH THE CONTENTS PRIOR TO COMMENCING WORK, AND, UNLESS OTHERWISE NOTED, ALL WORK SHALL CONFORM AS APPLICABLE TO THESE STANDARDS AND SPECIFICATIONS.
- 2. THE CONTRACTOR SHALL BE RESPONSIBLE FOR FURNISHING ALL MATERIAL AND LABOR TO CONSTRUCT THE FACILITY AS SHOWN AND DESCRIBED IN THE CONSTRUCTION DOCUMENTS IN ACCORDANCE WITH THE APPROPRIATE APPROVING AUTHORITIES. SPECIFICATIONS AND REQUIREMENTS. CONTRACTOR SHALL CLEAR AND GRUB ALL AREAS UNLESS OTHERWISE INDICATED, REMOVING TREES, STUMPS, ROOTS, MUCK, EXISTING PAVEMENT AND ALL OTHER DELETERIOUS MATERIAL.
- 3. ALL PAVING, CONSTRUCTION, MATERIALS, AND WORKMANSHIP WITHIN CITY'S RIGHT-OF-WAY SHALL BE IN ACCORDANCE WITH CITY OF PORT ST. LUCIE ENGINEERING STANDARDS FOR LAND DEVELOPMENT LOCAL REGULATIONS.
- 4. ALL UNPAVED AREAS IN EXISTING RIGHTS-OF-WAY DISTURBED BY CONSTRUCTION SHALL BE REGRADED AND SODDED.
- 5. TRAFFIC CONTROL ON ALL FDOT, LOCAL AND COUNTY RIGHTS-OF-WAY SHALL MEET THE REQUIREMENTS OF THE MANUAL OF UNIFORM TRAFFIC CONTROL DEVICES (U.S. DOT/FHA) AND THE REQUIREMENTS OF THE STATE AND ANY LOCAL AGENCY HAVING JURISDICTION. IN THE EVENT THAT THE CONTRACT DOCUMENTS AND THE JURISDICTIONAL AGENCY REQUIREMENTS ARE NOT IN AGREEMENT, THE MOST STRINGENT SHALL GOVERN.
- 6. THE CONTRACTOR SHALL GRADE THE SITE TO THE ELEVATIONS INDICATED AND SHALL REGRADE WASHOUTS WHERE THEY OCCUR AFTER EVERY RAINFALL UNTIL A GRASS STAND IS WELL ESTABLISHED OR ADEQUATE STABILIZATION OCCURS.
- 7. ALL OPEN AREAS WITHIN THE PROJECT SITE SHALL BE SODDED UNLESS INDICATED OTHERWISE ON THE LANDSCAPE PLAN.
- 8. ALL AREAS INDICATED AS PAVEMENT SHALL BE CONSTRUCTED IN ACCORDANCE WITH THE TYPICAL PAVEMENT SECTIONS AS INDICATED ON THE DRAWINGS.
- 9. WHERE EXISTING PAVEMENT IS INDICATED TO BE REMOVED AND REPLACED, THE CONTRACTOR SHALL SAW CUT A MINIMUM 2" DEEP FOR A SMOOTH AND STRAIGHT JOINT AND REPLACE THE PAVEMENT WITH THE SAME TYPE AND DEPTH OF MATERIAL AS EXISTING OR AS INDICATED.
- 10. WHERE NEW PAVEMENT MEETS THE EXISTING PAVEMENT, THE CONTRACTOR SHALL SAW CUT THE EXISTING PAVEMENT A MINIMUM 2" DEEP FOR A SMOOTH AND STRAIGHT JOINT AND MATCH THE EXISTING PAVEMENT ELEVATION WITH THE PROPOSED PAVEMENT UNLESS OTHERWISE INDICATED.
- 11. THE CONTRACTOR SHALL INSTALL FILTER FABRIC OVER ALL DRAINAGE STRUCTURES FOR THE DURATION OF CONSTRUCTION AND UNTIL ACCEPTANCE OF THE PROJECT BY THE OWNER. ALL DRAINAGE STRUCTURES SHALL BE CLEANED OF DEBRIS AS REQUIRED DURING AND AT THE END OF CONSTRUCTION TO PROVIDE POSITIVE DRAINAGE FLOWS.
- 12. STRIP TOPSOIL AND ORGANIC MATTER FROM ALL AREAS OF THE SITE AS REQUIRED. IN SOME CASES TOPSOIL MAY BE STOCKPILED ON SITE FOR PLACEMENT WITHIN LANDSCAPED AREAS BUT ONLY AS DIRECTED BY THE OWNER.
- 13. FIELD DENSITY TESTS SHALL BE TAKEN AT INTERVALS IN ACCORDANCE WITH THE LOCAL JURISDICTIONAL AGENCY OR TO FDOT STANDARDS. IN THE EVENT THAT THE CONTRACT DOCUMENTS AND THE JURISDICTIONAL AGENCY REQUIREMENTS ARE NOT IN AGREEMENT, THE MOST STRINGENT SHALL GOVERN.
- 14. ALL SLOPES AND AREAS DISTURBED BY CONSTRUCTION SHALL BE GRADED AS PER PLANS. THE AREAS SHALL THEN BE SODDED OR SEEDED AS SPECIFIED IN THE PLANS, FERTILIZED, MULCHED, WATERED AND MAINTAINED UNTIL HARDY GRASS GROWTH IS ESTABLISHED IN ALL AREAS. ANY AREAS DISTURBED FOR ANY REASON PRIOR TO FINAL ACCEPTANCE OF THE JOB SHALL BE CORRECTED BY THE CONTRACTOR AT NO ADDITIONAL COST TO THE OWNER. ALL EARTHEN AREAS WILL BE SODDED OR SEEDED AND MULCHED AS SHOWN ON THE LANDSCAPING PLAN.
- 15. ALL CUT OR FILL SLOPES SHALL BE 4 (HORIZONTAL) :1 (VERTICAL) OR FLATTER UNLESS OTHERWISE SHOWN.
- 16. THE CONTRACTOR SHALL BE RESPONSIBLE FOR THE CONTROL OF DUST AND DIRT RISING AND SCATTERING IN THE AIR DURING CONSTRUCTION AND SHALL PROVIDE WATER SPRINKLING OR OTHER SUITABLE METHODS OF CONTROL. THE CONTRACTOR SHALL COMPLY WITH ALL GOVERNING REGULATIONS PERTAINING TO ENVIRONMENTAL PROTECTION.
- 17. THE CONTRACTOR SHALL TAKE ALL REQUIRED MEASURES TO CONTROL TURBIDITY. INCLUDING BUT NOT LIMITED TO THE INSTALLATION OF TURBIDITY BARRIERS AT ALL LOCATIONS WHERE THE POSSIBILITY OF TRANSFERRING SUSPENDED SOLIDS INTO THE RECEIVING WATER BODY EXISTS DUE TO THE PROPOSED WORK. TURBIDITY BARRIERS MUST BE MAINTAINED IN EFFECTIVE CONDITION AT ALL LOCATIONS UNTIL CONSTRUCTION IS COMPLETED AND DISTURBED SOIL AREAS ARE STABILIZED. THEREAFTER. THE CONTRACTOR MUST REMOVE THE BARRIERS. AT NO TIME SHALL THERE BE ANY OFF-SITE DISCHARGE WHICH VIOLATES THE WATER QUALITY STANDARDS IN CHAPTER 17-302, FLORIDA ADMINISTRATIVE CODE.
- 18. SOD, WHERE CALLED FOR, MUST BE INSTALLED AND MAINTAINED ON EXPOSED SLOPES WITHIN 48 HOURS OF COMPLETING FINAL GRADING, AND AT ANY OTHER TIME AS NECESSARY, TO PREVENT EROSION, SEDIMENTATION OR TURBID DISCHARGES.
- 19. THE CONTRACTOR MUST REVIEW AND MAINTAIN A COPY OF THE ENVIRONMENTAL RESOURCE PERMIT COMPLETE WITH ALL CONDITIONS, ATTACHMENTS, EXHIBITS, AND PERMIT MODIFICATIONS IN GOOD CONDITION AT THE CONSTRUCTION SITE. THE COMPLETE PERMIT MUST BE AVAILABLE FOR REVIEW UPON REQUEST BY WATER MANAGEMENT DISTRICT REPRESENTATIVES.
- 20. THE CONTRACTOR SHALL ENSURE THAT ISLAND PLANTING AREAS AND OTHER PLANTING AREAS ARE NOT COMPACTED AND DO NOT CONTAIN ROAD BASE MATERIALS. THE CONTRACTOR SHALL ALSO EXCAVATE AND REMOVE ALL UNDESIRABLE MATERIAL FROM ALL AREAS ON THE SITE TO BE PLANTED AND PROPERLY DISPOSED OF IN A LEGAL MANNER.
- 21. THE CONTRACTOR SHALL INSTALL ALL UNDERGROUND STORM WATER PIPING PER MANUFACTURER'S RECOMMENDATIONS.

CALL 48 HOURS BEFORE YOU DIG IT'S THE LAW! Know what's **below. DIAL 811** Call before you dig. SUNSHINE STATE ONE CALL OF FLORIDA, INC.

VERTICAL DATUM **ELEVATIONS SHOWN HEREON ARE BASED ON THE** NORTH AMERICAN VERTICAL DATUM OF 1988 (NAVE '88). SUBTRACT 1.50' FROM NGVD '29 ELEVATION TO GET THE NAVD '88 ELEVATION.

CITY OF PORT ST. LUCIE PROJECT # P22-301 / P23-153

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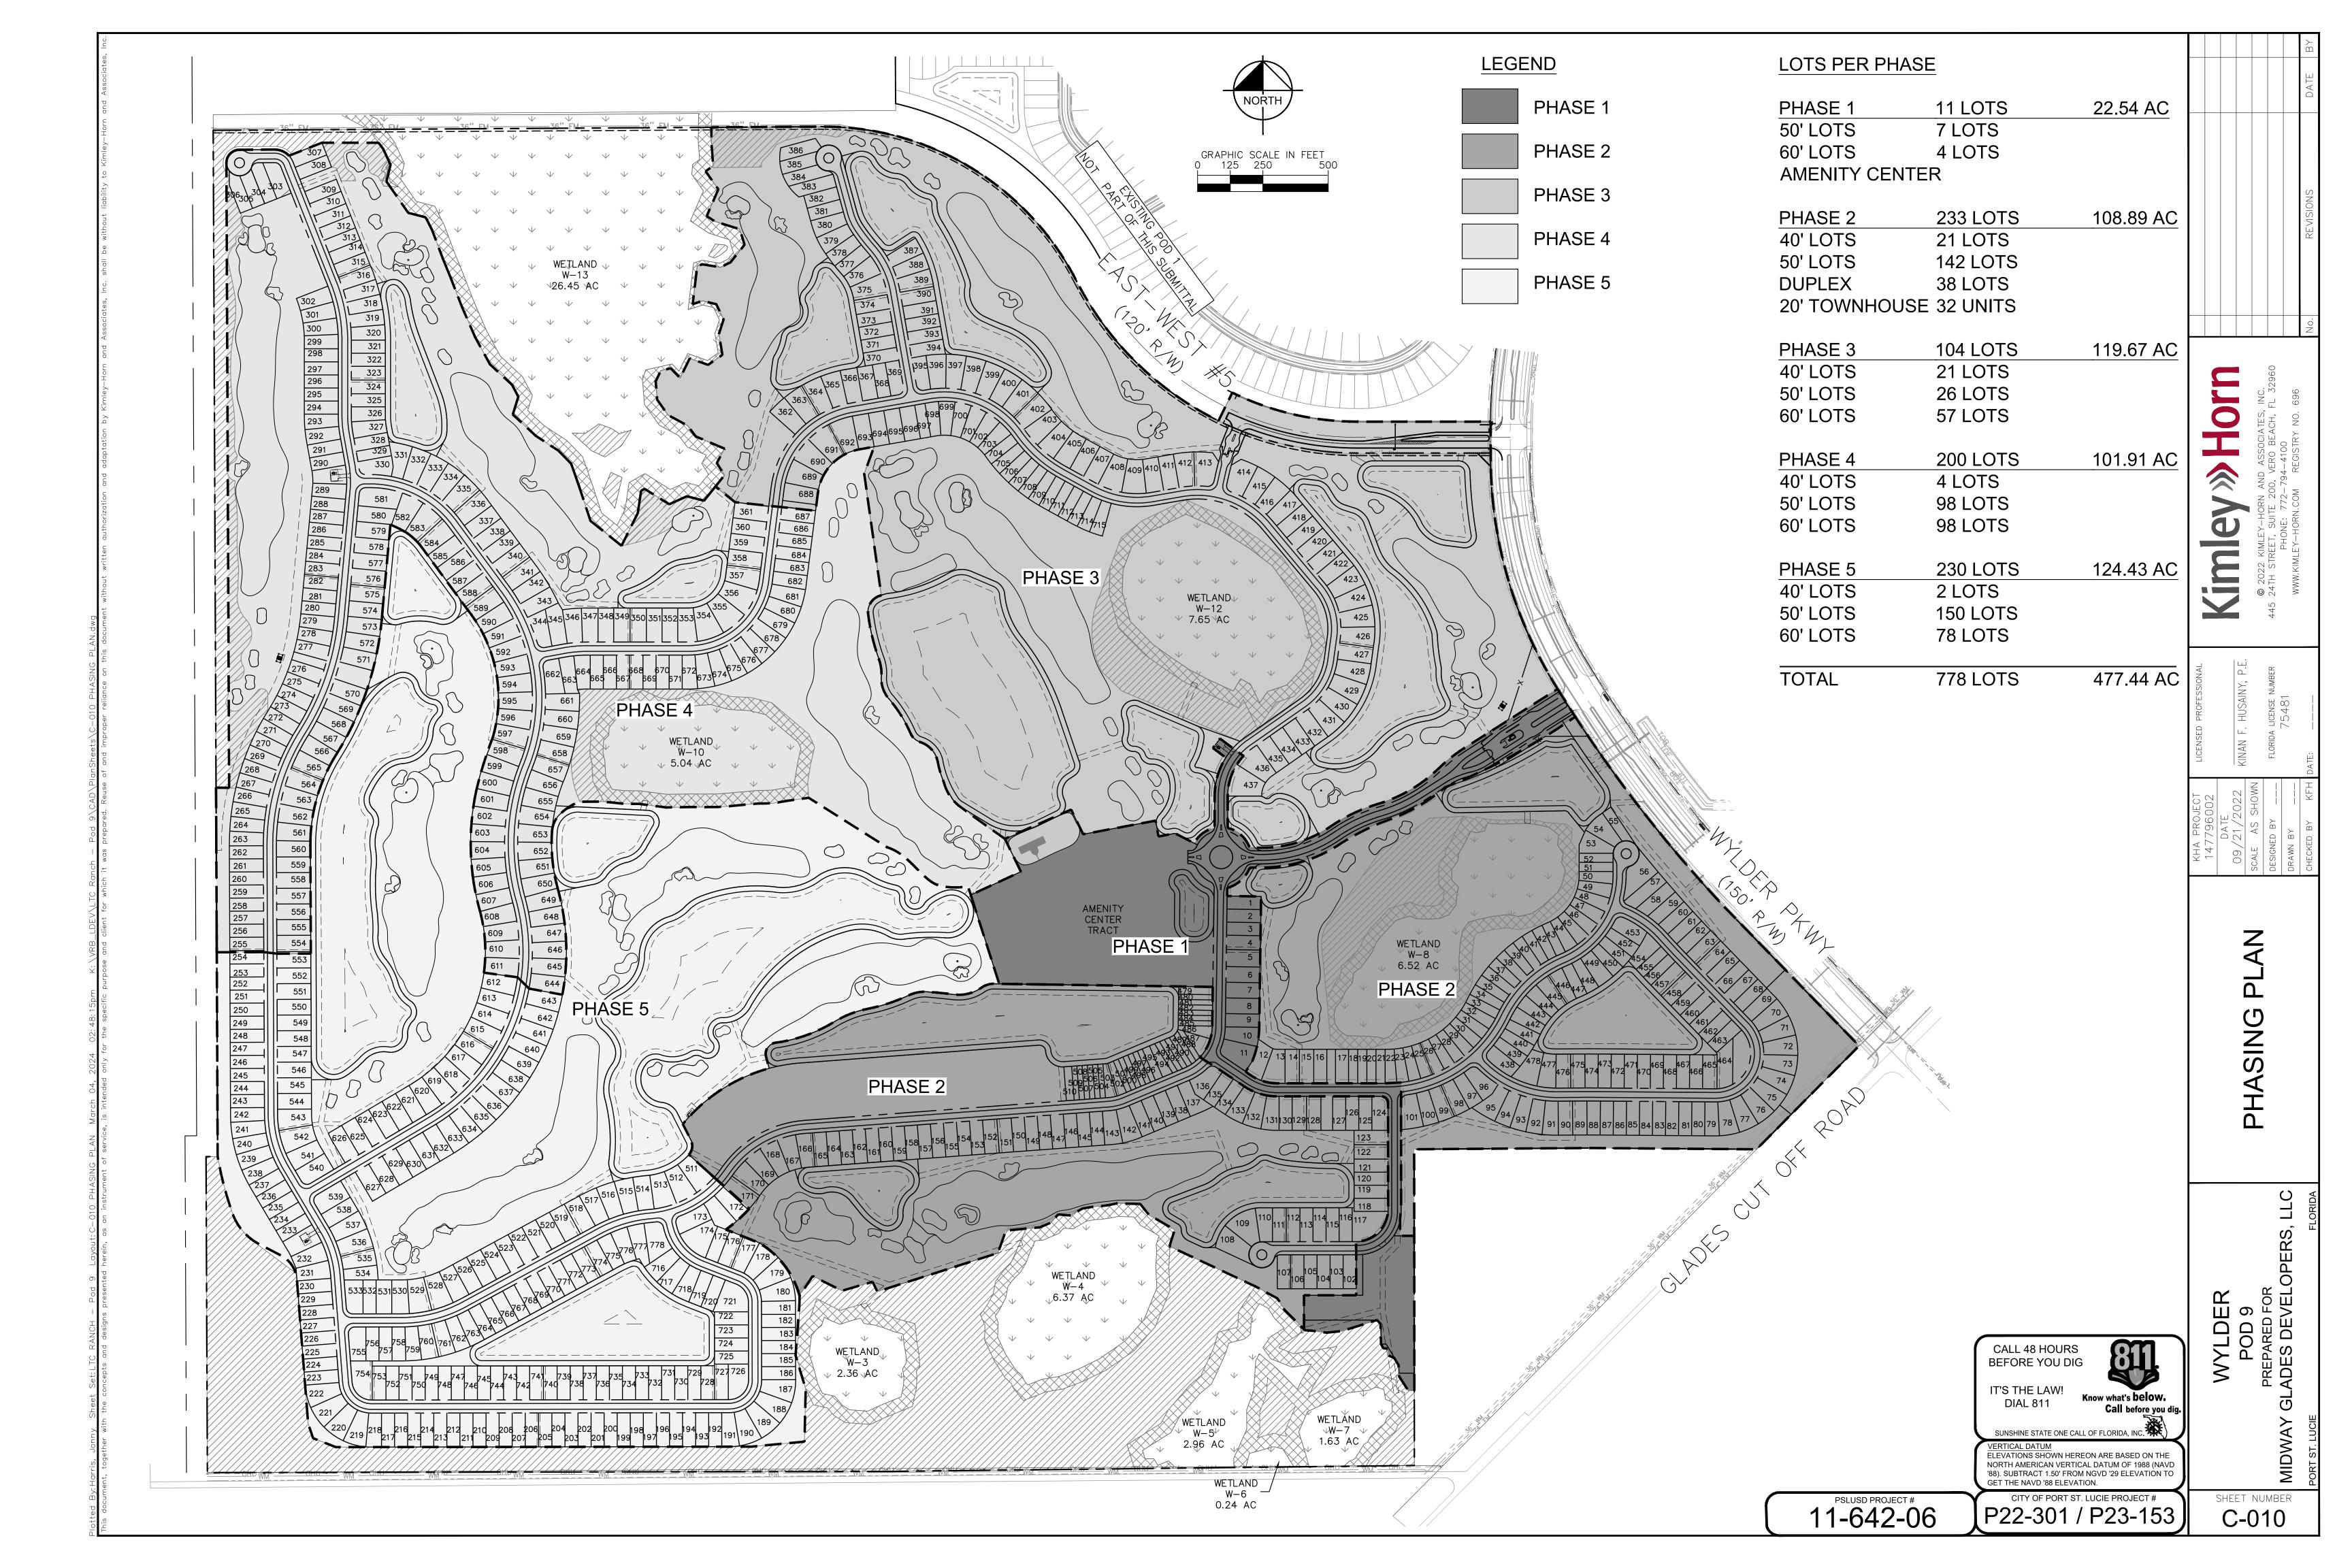
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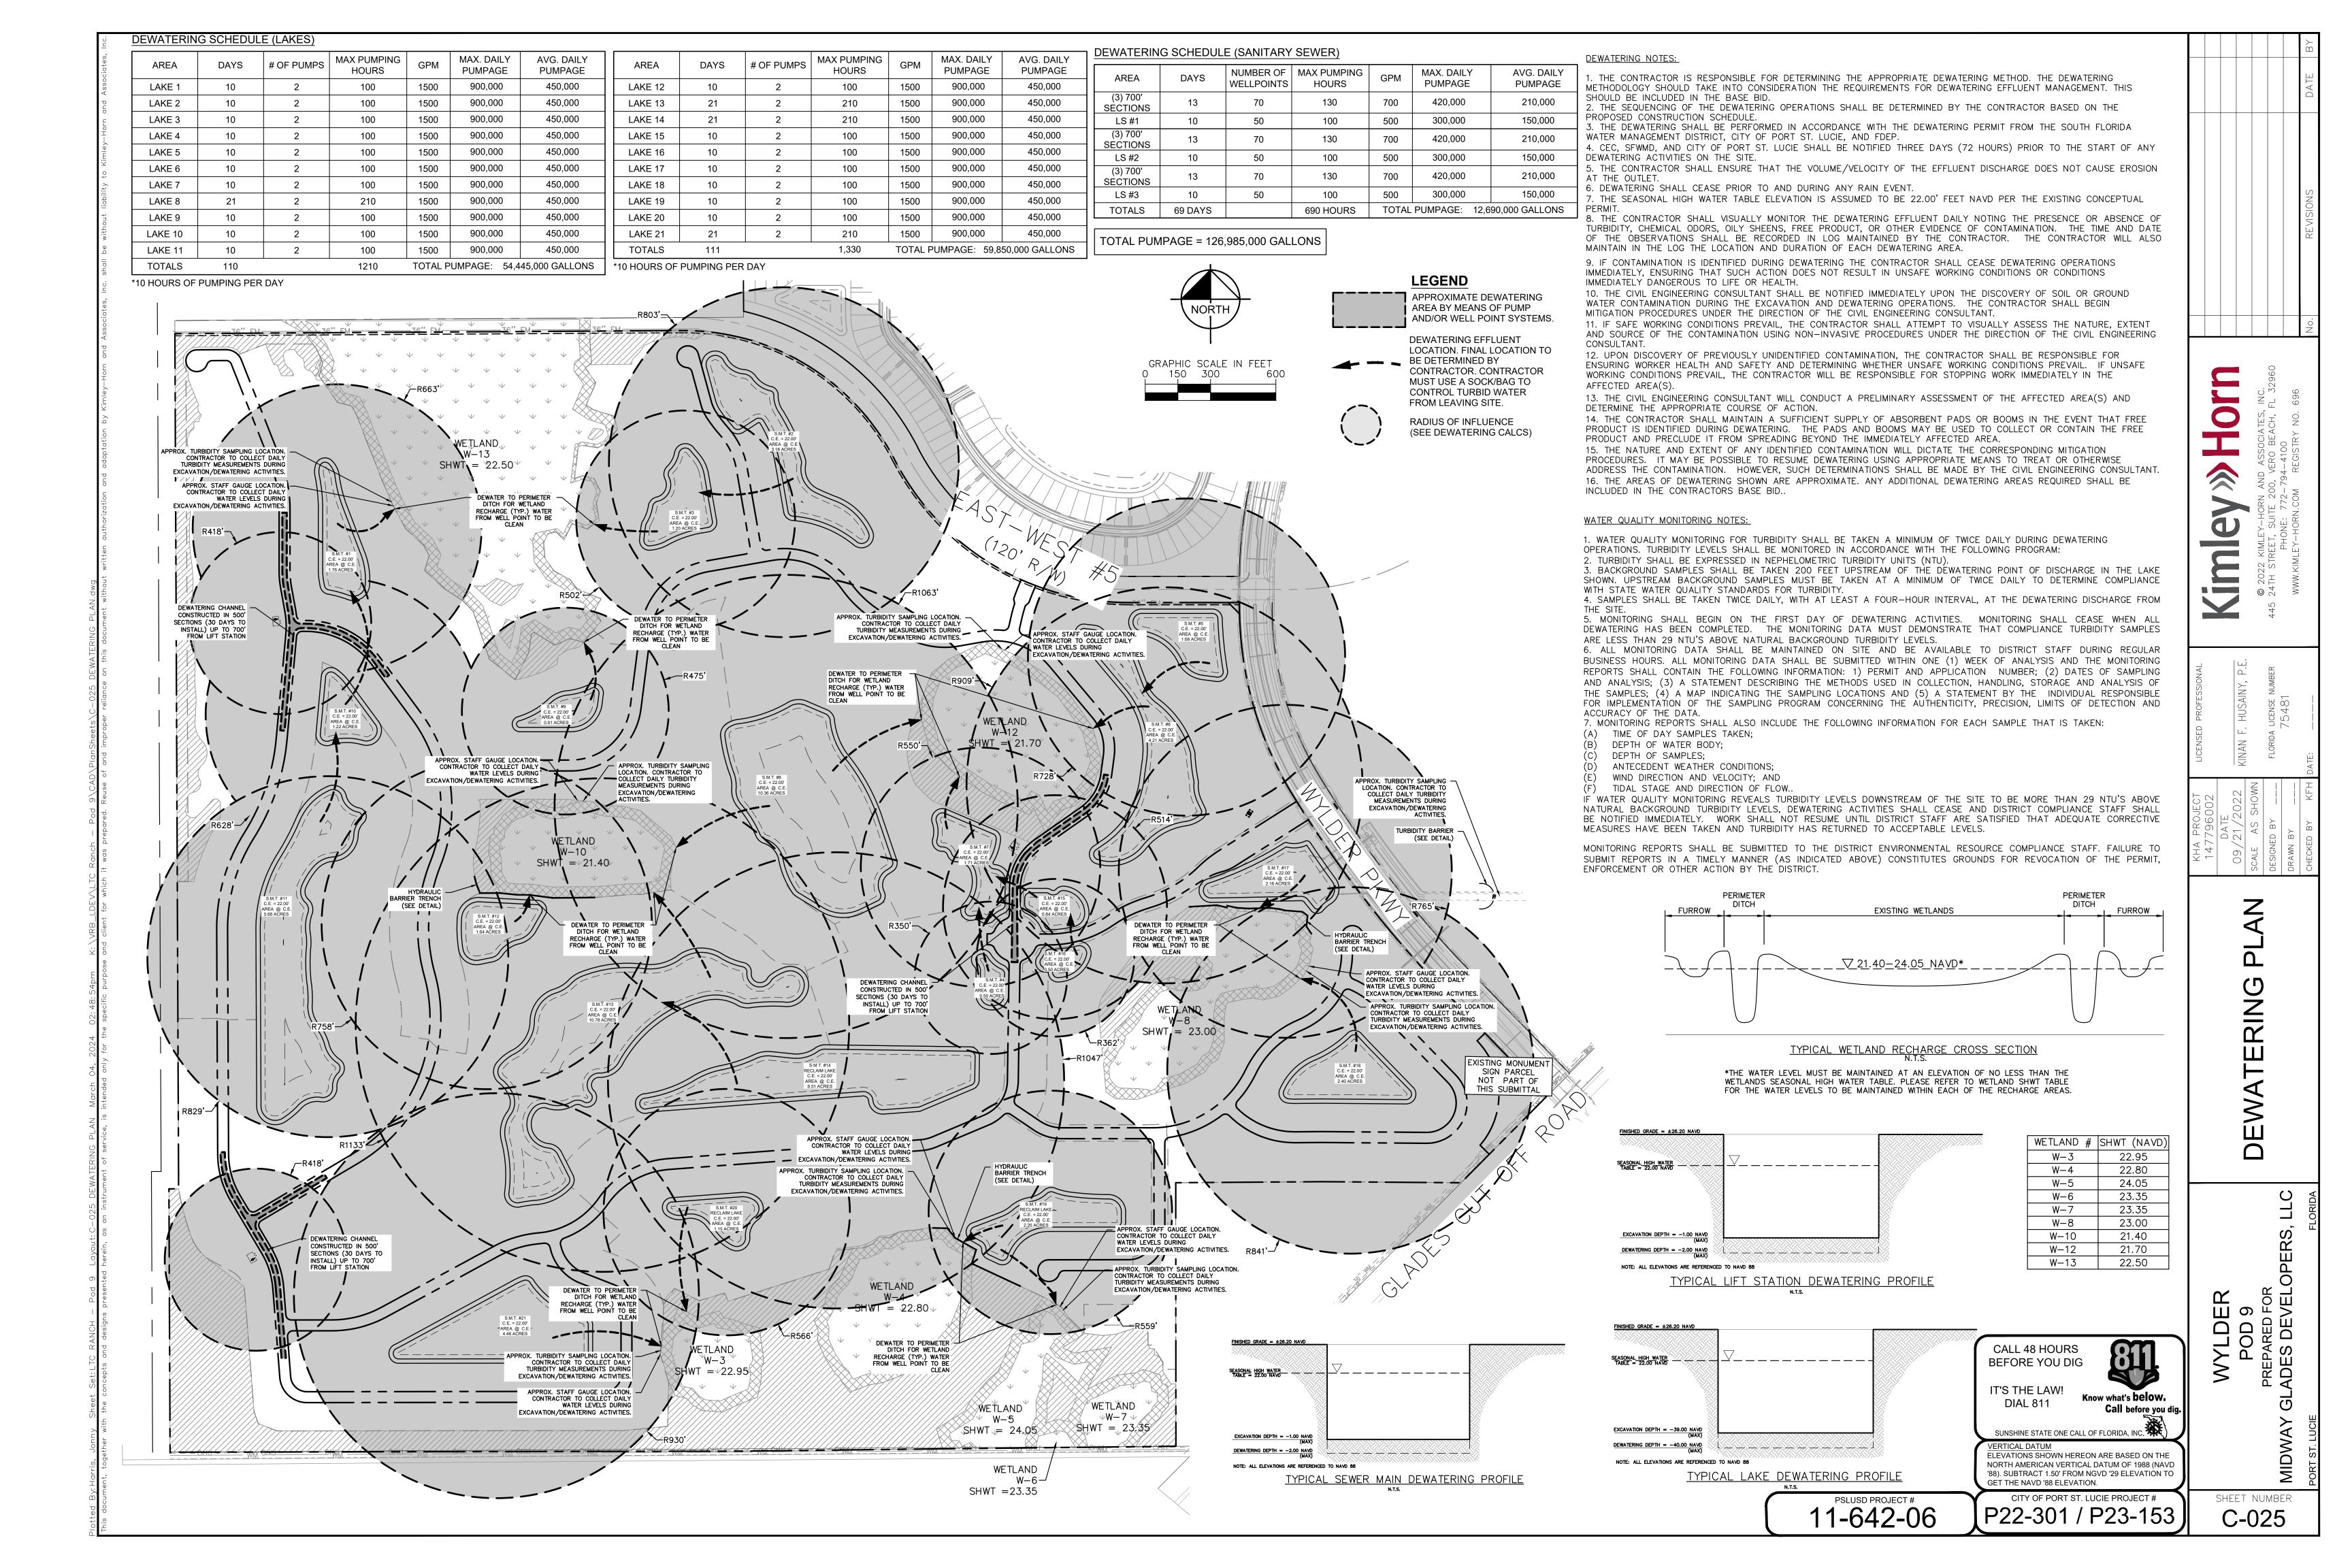
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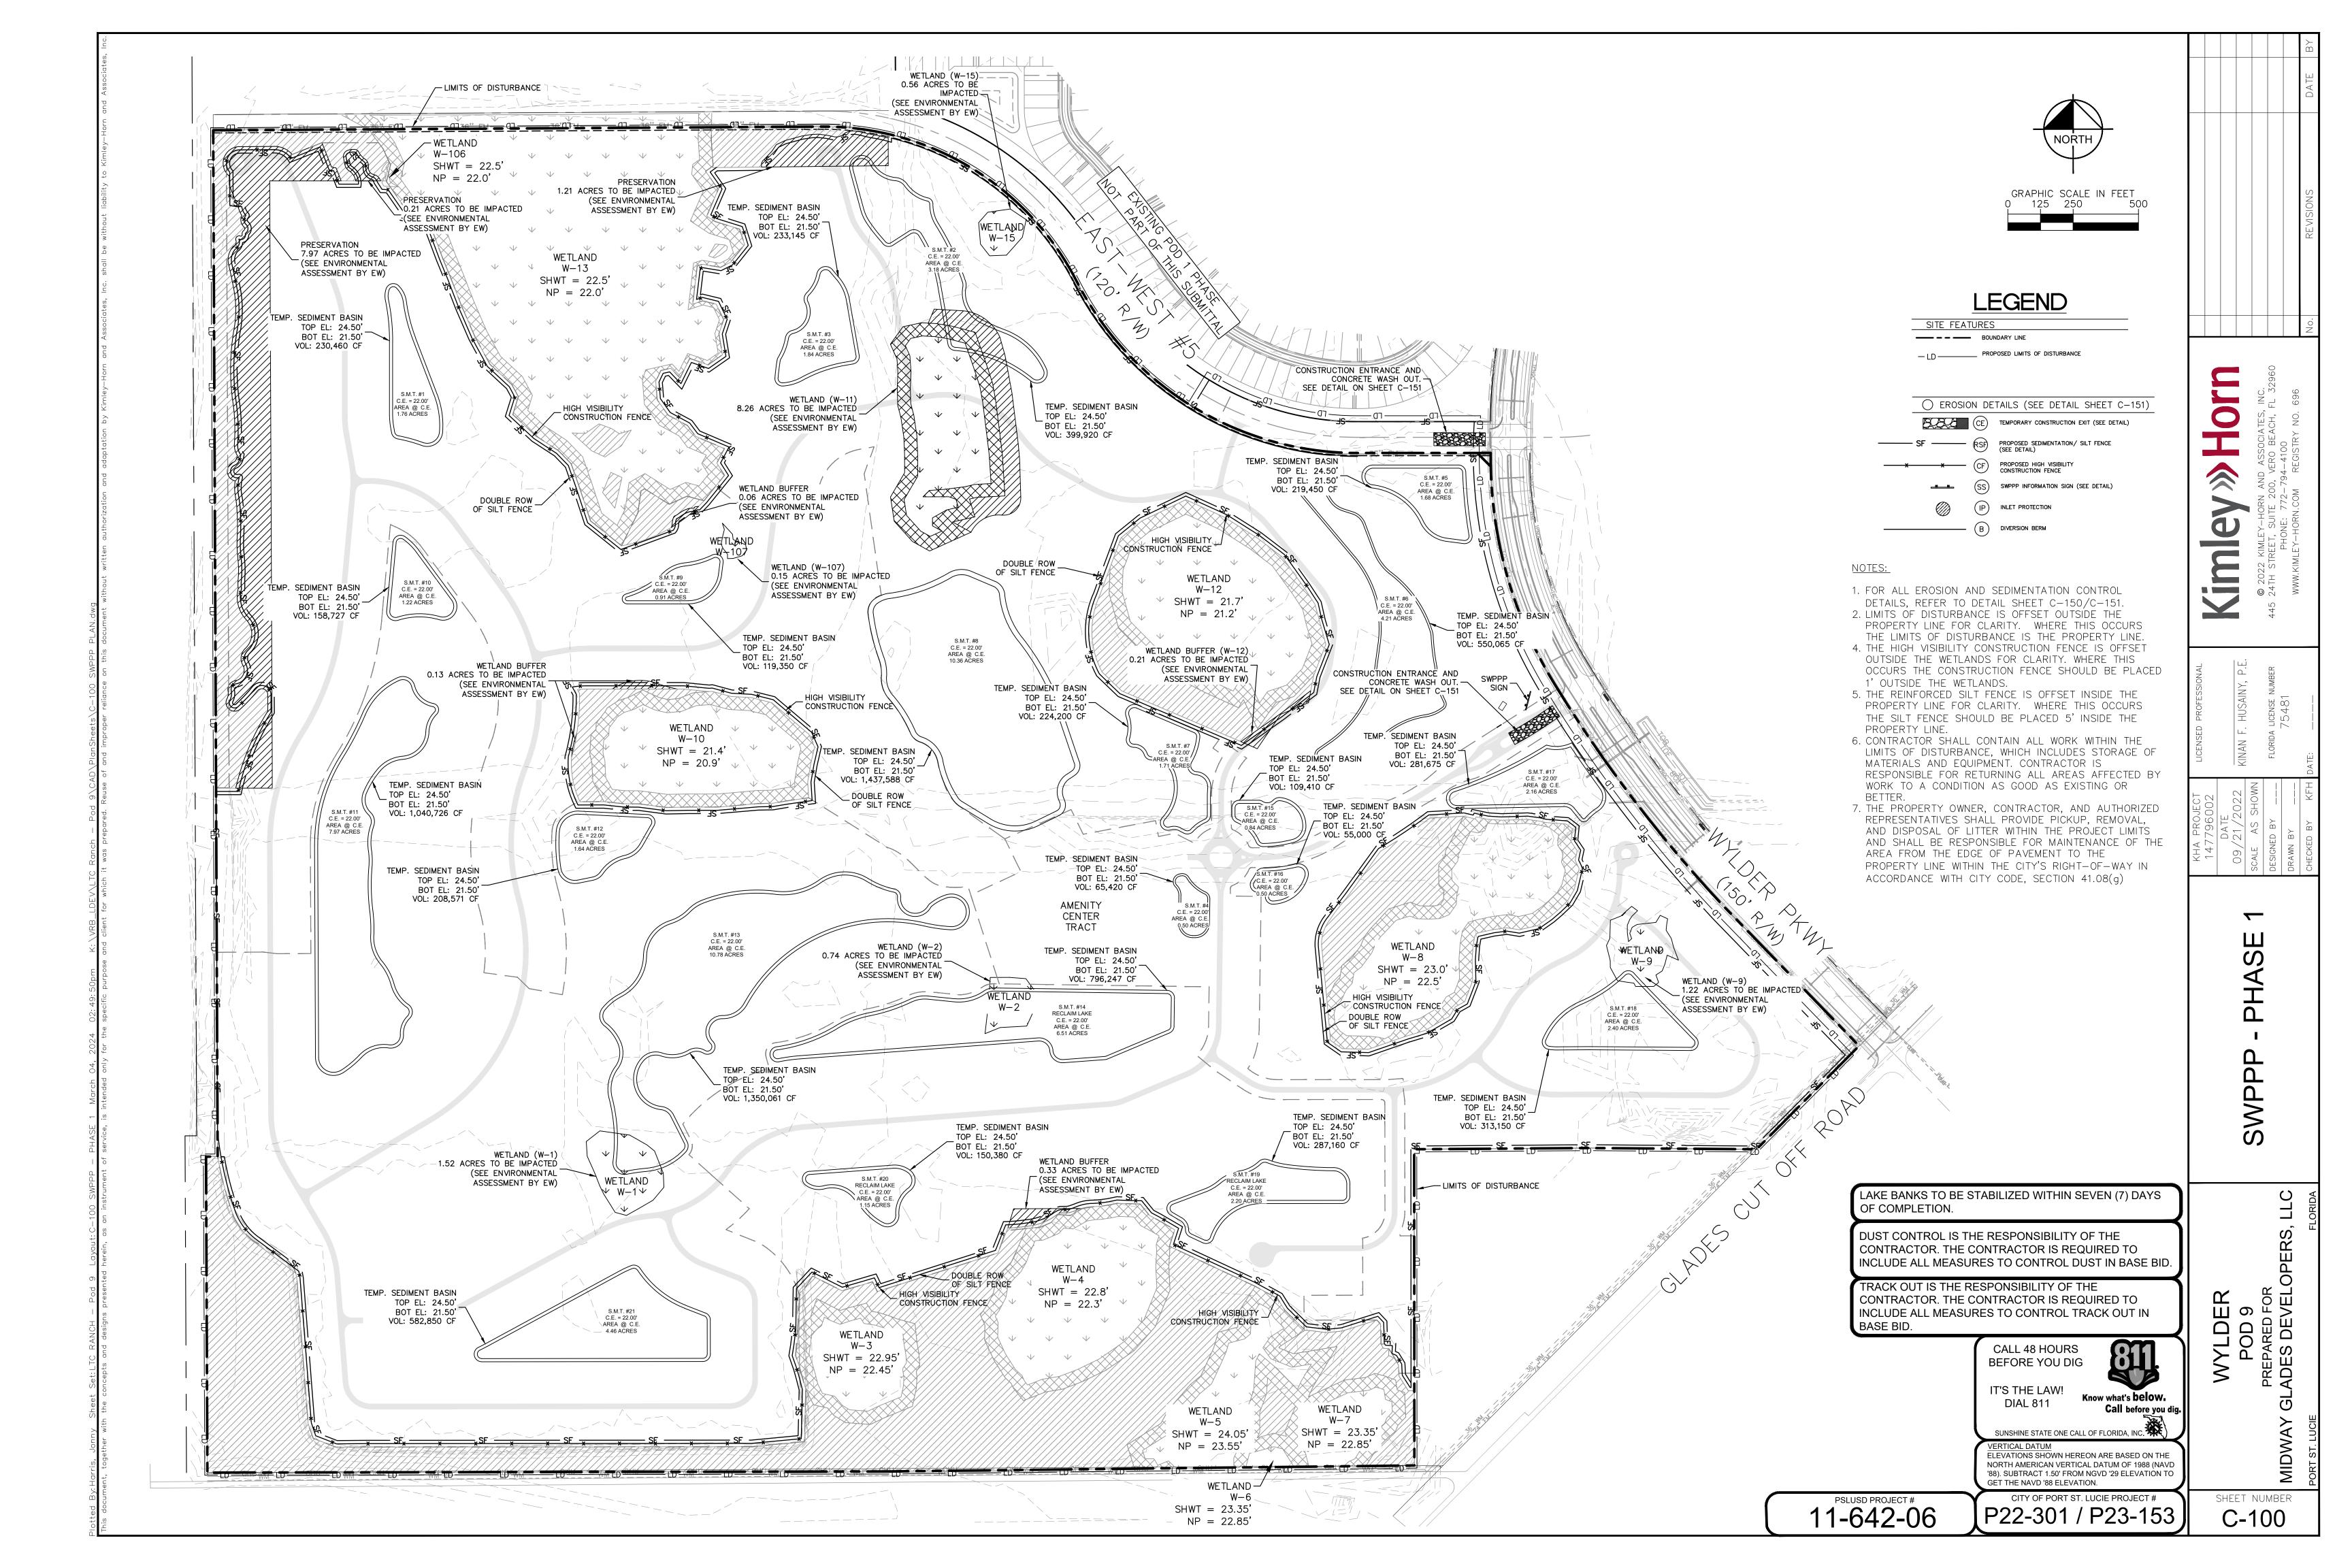
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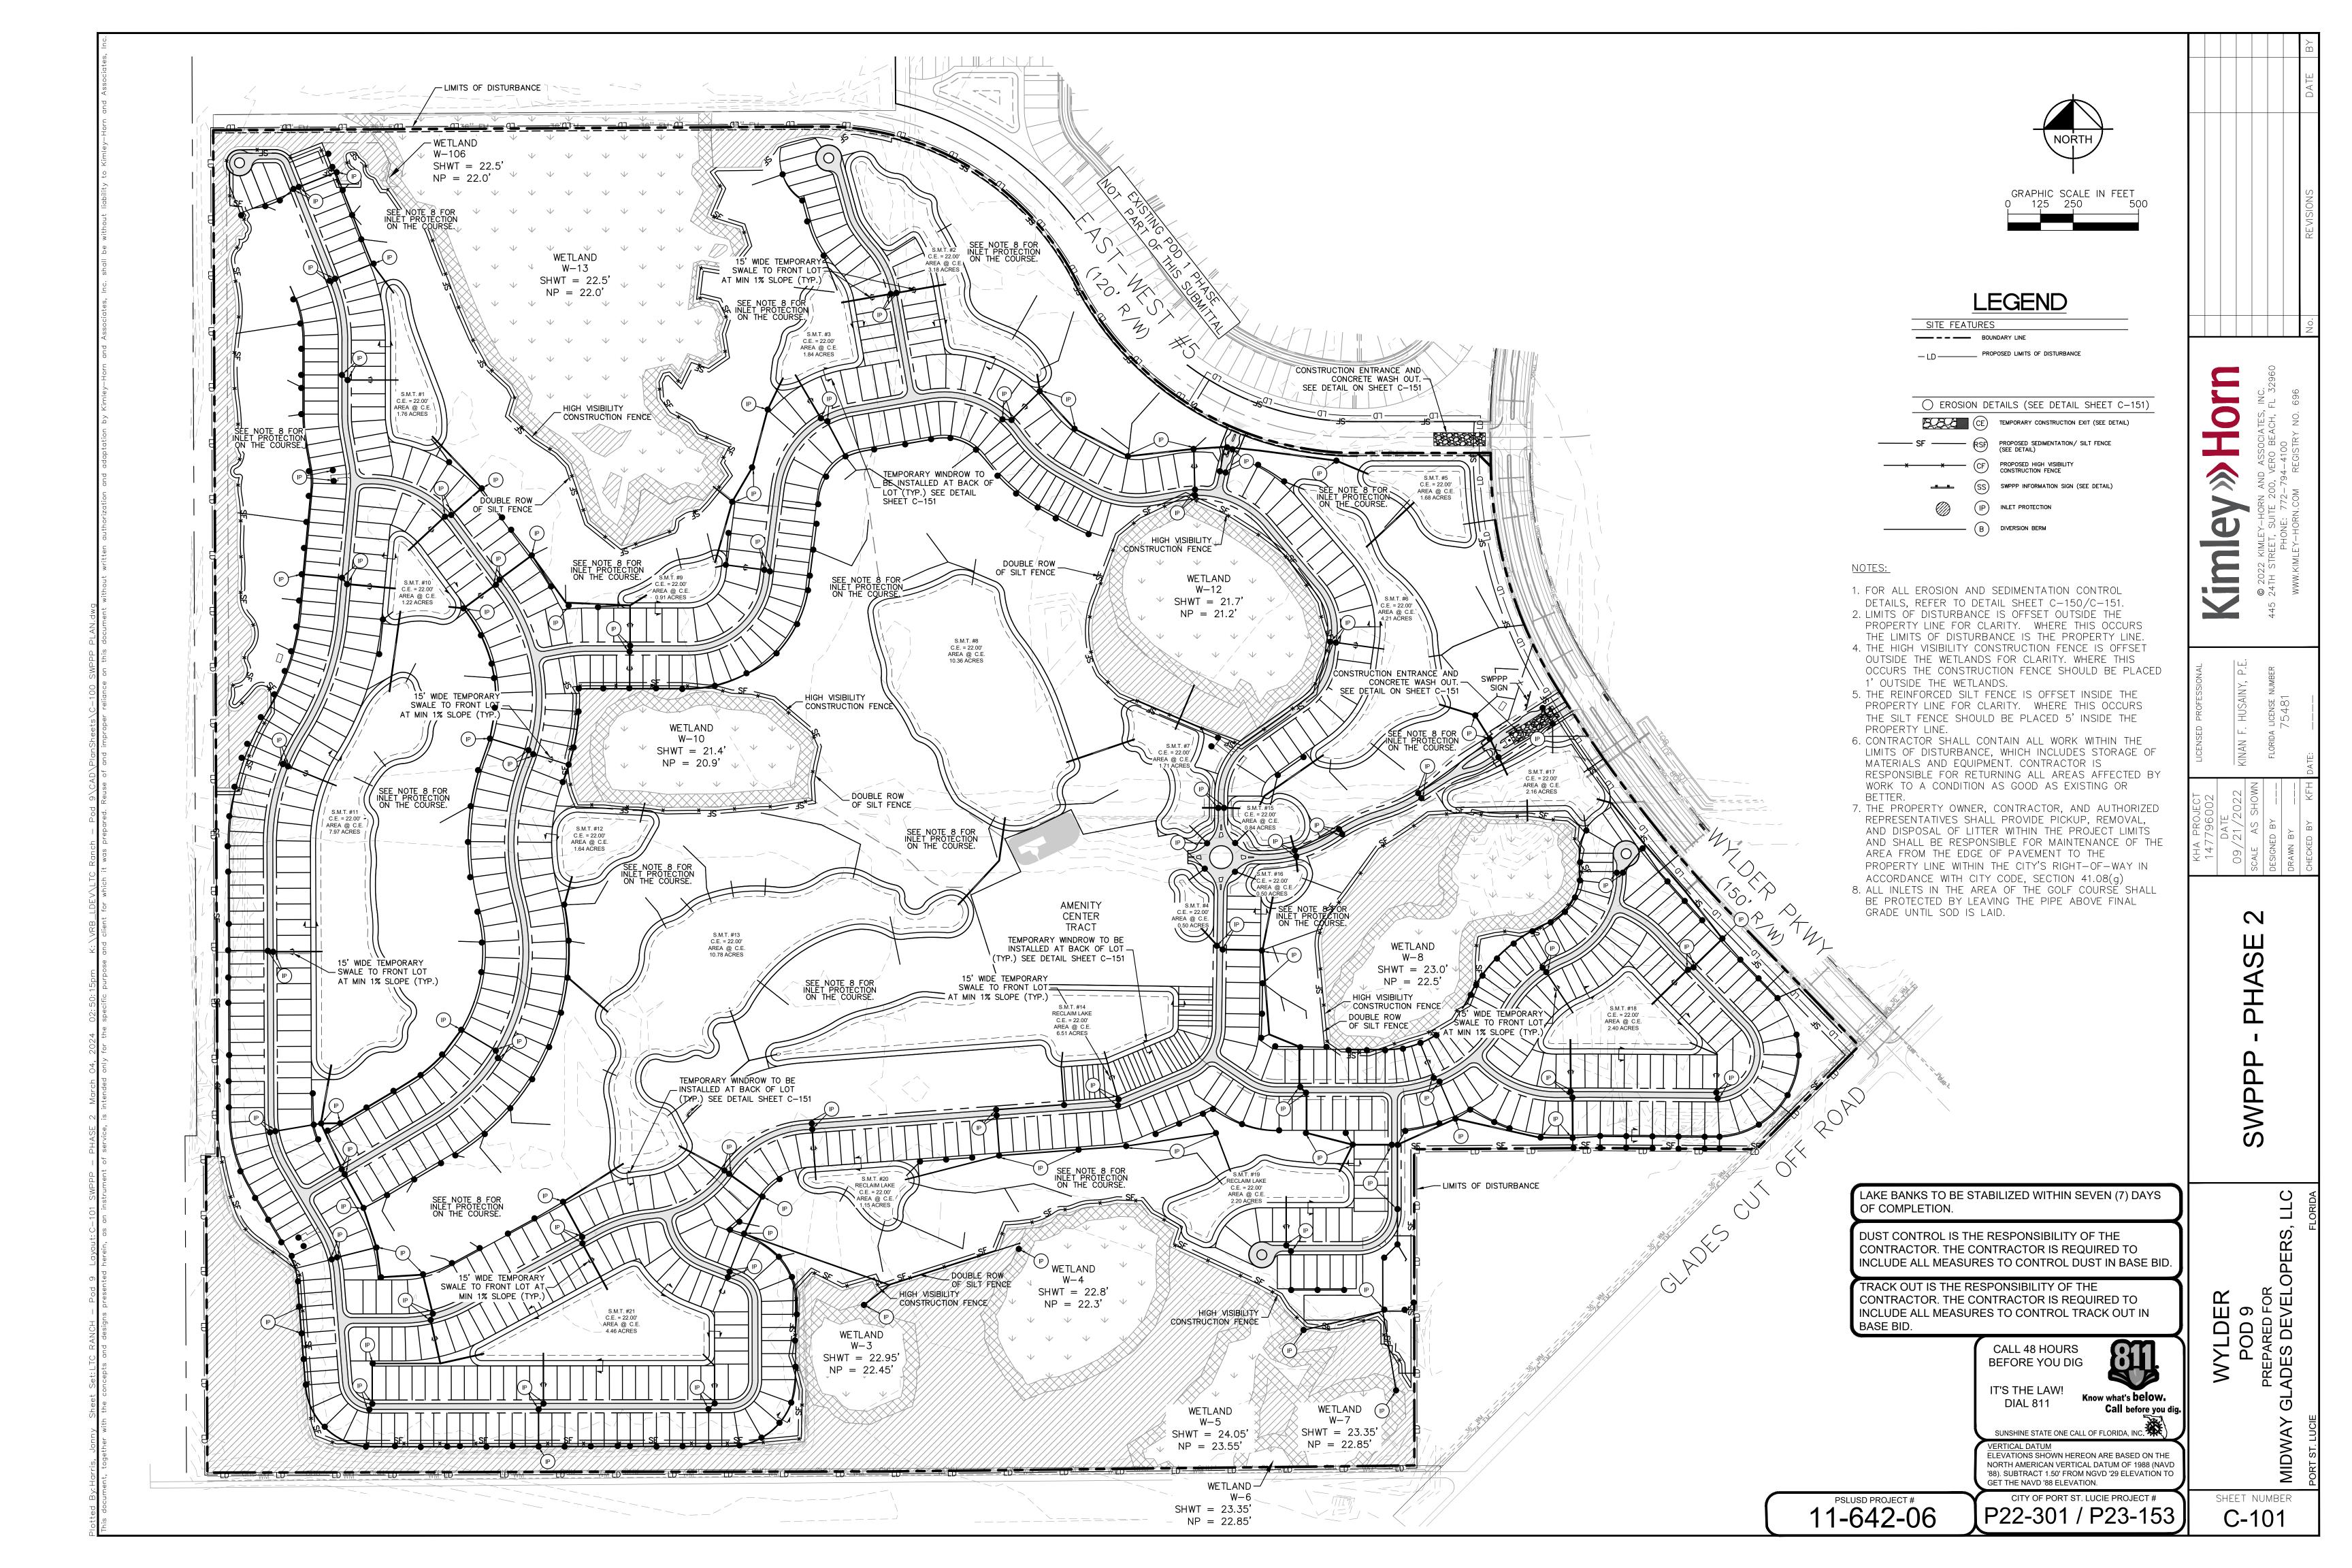
11-642-06

1. THE PROPERTY OWNER, CONTRACTOR AND AUTHORIZED REPRESENTATIVES SHALL PROVIDE PICKUP. REMOVAL AND DISPOSAL OF LITTER WITHIN THE PROJECT LIMITS AND SHALL BE RESPONSIBLE FOR MAINTENANCE OF THE AREA FROM THE EDGE OF PAVEMENT TO THE PROPERTY LINE WITHIN THE CITY'S RIGHT-OF-WAY IN ACCORDANCE WITH CITY CODE. SECTION 41.08(a).









Section 1	Project Name and location information:	WYLDER POD 9, PORT ST. LUCIE, FLORIDA.
Section 2	Describe the nature of the construction activity:	Construction activities consist of the development of a 561.04 AC residential property totaling 820 units within the City of Port St. Lucie, Florida.
Section 3	Describe the intended sequence of major soil disturbing activities:	- 0-5 DAYS - SITE PREP AND STABILIZED CONSTRUCTION ENTRANCE - 6-15 DAYS - INSTALL PERIMETER SEDIMENT AND EROSION CONTROLS - 16-25 DAYS - CLEARING/GRUBBING OVER ALL AREAS - 16-120 DAYS - INSTALL STORMWATER RETENTION BASIN - 26-180 DAYS - SITE GRADING - 180-300 DAYS - INSTALL STORM SEWER AND UTILITIES - 301-365 DAYS - STABILIZE SITE
Section 4	Total area of the site: Total area of the site to be disturbed:	561.04 AC 475.69 AC
Section 6	Existing data describing the soil or quality of any stormwater discharge from the site:	The soils on site are mostly sand, consisting of Ankona—Urban, Ankona and Farmton, and Nettles and Oldsmar sands.
Section 7	Estimate the drainage area size for each discharge point:	561.04 AC
Section 8	Latitude and longitude of each discharge point and identify the receiving water or MS4 for each	LAT: 27° 20' 48" N LON: 80° 26' 30" W
	discharge point:	Discharges through control structure from onsite Basin 6 into C-107 canal to the east.
	contained in the State of Florida Erosion and Sedim FDEP, and any subsequent amendments. PHASE I 1. INSTALL STABILIZED CONSTRUCTION EXIT(S) AND SM 2. INSTALL SILT FENCE(S) ON THE SITE (CLEAR ONLY TM 3. PREPARE TEMPORARY PARKING AND STORAGE ARE 4. ORANGE PROTECTIVE FENCE AROUND ANY LAND TO	which the controls will be implemented. mance standards for erosion and sediment control F.A.C., the applicable Stormwater or Environmental nt or a Water Management District, and the guidelines tent Control Designer and Reviewer Manual, FDOT, WPPP ENTRANCE SIGN. HOSE AREAS NECESSARY TO INSTALL SILT FENCE). A.
	TREES/WETLANDS. 5. INSTALL AND STABILIZE HYDRAULIC CONTROL STRU 6. BEGIN CLEARING AND GRUBBING THE SITE. 7. BEGIN GRADING THE SITE.	
Section 10	5. INSTALL AND STABILIZE HYDRAULIC CONTROL STRU 6. BEGIN CLEARING AND GRUBBING THE SITE. 7. BEGIN GRADING THE SITE. Describe all temporary and permanent stabilization temporary seeding, mulching, permanent seeding, gestrips, protection of trees, vegetative preservations, experiments.	practices. Stabilization practices include eotextiles, sod stabilization, vegetative buffer etc.
Section 10	5. INSTALL AND STABILIZE HYDRAULIC CONTROL STRUE 6. BEGIN CLEARING AND GRUBBING THE SITE. 7. BEGIN GRADING THE SITE. 7. BEGIN GRADING THE SITE. Describe all temporary and permanent stabilization of temporary seeding, mulching, permanent seeding, go strips, protection of trees, vegetative preservations, of the strips, protection of trees, vegetative preservations of APPLIED WITHIN SEVEN (7) DAYS TO DENUDED AREAS TO UNDISTURBED FOR LONGER THAN 30 DAYS. PERMANEI BE LEFT UNDISTURBED FOR MORE THAN ONE YEAR. 2. DURING CONSTRUCTION OF THE PROJECT, SOIL STOWITH SEDIMENT TRAPPING MEASURES. THE APPLICAN PERMANENT STABILIZATION OF ALL SOIL STOCKPILES OF FROM THE PROJECT SITE. 3. A PERMANENT VEGETATIVE COVER SHALL BE ESTABISTABILIZED. 4. WHEN WORK IN A LIVE WATERCOURSE IS PERFORME ENCROACHMENT, CONTROL SEDIMENT TRANSPORT AN POSSIBLE DURING CONSTRUCTION. 5. ALL CLEARED AREAS WILL RECEIVE SEED AND MULCITAKING PLACE OR PLANNED FOR 7 DAYS OR MORE AND 6. VEGETATIVE COVER OR OTHER EROSION CONTROL REQUIREMENTS SHALL BE PROPERLY MAINTAINED DUBLIC TAKING PLACE OR PLANNED FOR 7 DAYS OR MORE AND 6. VEGETATIVE COVER OR OTHER EROSION CONTROL REQUIREMENTS SHALL BE PROPERLY MAINTAINED DUBLIC TRACKING PLACE OR PLANNED FOR 7 DAYS OR MORE AND 6. VEGETATIVE COVER OR OTHER EROSION CONTROL REQUIREMENTS SHALL BE PROPERLY MAINTAINED DUBLIC TRACKING PLACE OR PLANNED FOR 7 DAYS OR MORE AND 6. VEGETATIVE COVER OR OTHER EROSION CONTROL REQUIREMENTS SHALL BE PROPERLY MAINTAINED DUBLIC TRACKING PLACE OR PLANNED FOR 7 DAYS OR MORE AND 6. VEGETATIVE COVER OR OTHER EROSION CONTROL OR THE PROPERLY MAINTAINED DUBLIC TRACKING PLACE OR PLANNED FOR 7 DAYS OR MORE AND 6. VEGETATIVE COVER OR OTHER EROSION CONTROL OR THE PROPERLY MAINTAINED DUBLIC TRACKING PLACE OR PLANNED FOR 7 DAYS OR MORE AND 6. VEGETATIVE COVER OR OTHER EROSION CONTROL OR THE PROPERLY MAINTAINED DUBLIC TRACKING PLACE OR THE PROPERLY MAINTAINED DU	practices. Stabilization practices include extentiles, sod stabilization, vegetative buffer etc. IALL BE APPLIED TO DENUDED AREAS WITHIN SEVEN (7) DAYS THE SITE. TEMPORARY SOIL STABILIZATION SHALL BE THAT MAY NOT BE AT FINAL GRADE BUT WILL REMAIN NT STABILIZATION SHALL BE APPLIED TO AREAS THAT ARE TO CK PILES SHALL BE STABILIZED, COVERED OR CONTAINED T IS RESPONSIBLE FOR THE TEMPORARY PROTECTION AND EN SITE AS WELL AS SOIL INTENTIONALLY TRANSPORTED LISHED ON DENUDED AREAS NOT OTHERWISE PERMANENTLY DESTABILIZE THE WORK AREA TO THE GREATEST EXTENT H WITHIN 7 DAYS IF NO CONSTRUCTION ACTIVITIES ARE DIOR COMPLETION OF A PHASE OF GRADING. DEVICES OR STRUCTURES USED TO MEET THESE RING AND AFTER CONSTRUCTION TO divert stormwater flow from exposed soils and structural and any other way limit stormwater runoff. These controls diment traps, check dams, subsurface drains, pipe slope rock outlet stormwater and temporary or permanent
	5. INSTALL AND STABILIZE HYDRAULIC CONTROL STRU 6. BEGIN CLEARING AND GRUBBING THE SITE. 7. BEGIN GRADING THE SITE. 7. PERMANENT OR TEMPORARY SOIL STABILIZATION SHAFTER FINAL GRADE IS REACHED ON ANY PORTION OF APPLIED WITHIN SEVEN (7) DAYS TO DENUDED AREAS TO UNDISTURBED FOR LONGER THAN 30 DAYS. PERMANET BE LEFT UNDISTURBED FOR MORE THAN ONE YEAR. 7. DURING CONSTRUCTION OF THE PROJECT, SOIL STOWITH SEDIMENT TRAPPING MEASURES. THE APPLICAN PERMANENT STABILIZATION OF ALL SOIL STOCKPILES OF FROM THE PROJECT SITE. 7. A PERMANENT YEGETATIVE COVER SHALL BE ESTABISTABILIZED. 7. WHEN WORK IN A LIVE WATERCOURSE IS PERFORMED FOR PROJECT SITE. 7. A PERMANENT CONTROL SEDIMENT TRANSPORT AN POSSIBLE DURING CONSTRUCTION. 7. ALL CLEARED AREAS WILL RECEIVE SEED AND MULCITAKING PLACE OR PLANNED FOR 7 DAYS OR MORE AND CONTROL TRANSPORT SHALL BE PROPERLY MAINTAINED DUB DESCRIBE AND STABILIZED. 8. WHEN WORK IN A LIVE WATER COURSE IS PERFORMED FOR TO ANY SOR MORE AND CONTROL TO THE PROJECT SITE. 8. A PERMANDENT SHALL BE PROPERLY MAINTAINED DUB DESCRIBE AND THE STABILIZED. 9. CONTROL TO THE PROJECT SITE. 9. SEED AND MULCITAKING SET STABLED TO THE PROJECT SITE. 9. SEED AND SECRET SET SET SET SET SET SET SET SET SET S	practices. Stabilization practices include extextiles, sod stabilization, vegetative buffer etc. JALL BE APPLIED TO DENUDED AREAS WITHIN SEVEN (7) DAYS THE SITE. TEMPORARY SOIL STABILIZATION SHALL BE HAT MAY NOT BE AT FINAL GRADE BUT WILL REMAIN NT STABILIZATION SHALL BE APPLIED TO AREAS THAT ARE TO CK PILES SHALL BE STABILIZED, COVERED OR CONTAINED IT IS RESPONSIBLE FOR THE TEMPORARY PROTECTION AND DISTER AS WELL AS SOIL INTENTIONALLY TRANSPORTED LISHED ON DENUDED AREAS NOT OTHERWISE PERMANENTLY DESTABILIZE THE WORK AREA TO THE GREATEST EXTENT HE WITHIN 7 DAYS IF NO CONSTRUCTION ACTIVITIES ARE DOOR COMPLETION OF A PHASE OF GRADING. DEVICES OR STRUCTURES USED TO MEET THESE WING AND AFTER CONSTRUCTION OF MEET THESE WING AND AFTER CONSTRUCTION OF A PHASE OF GRADING. DEVICES OR STRUCTURES USED TO MEET THESE WING AND AFTER CONSTRUCTION OF A PHASE OF GRADING OF A PHASE OF THE A PHASE OF TH
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PERIMETER BERMS AND WET PONDS

Section 14	Waste disposal, this may include construction debris, chemicals, litter, and sanitary wastes:	All construction materials and debris will be placed in a dumpster and hauled off site to a landfill or other proper disposal site. No materials will be buried on site.	
Section 15	Offsite vehicle tracking from construction entrances/exits:	Off site vehicle tracking of sediments and dust generation will be minimized via a rock construction entrance, street sweeping and the use of water to keep dust down.	
Section 16	The proper application rates of all fertilizers, herbicides and pesticides used at the construction site:	Florida-friendly fertilizers and pesticides will be used at a minimum and in accordance with the manufacturer's suggested application rates.	
Section 17	The storage, application, generation and migration of all toxic substances:	All paints and other chemicals will be stored in a locked covered shed.	
Section 18	Other:	Port-o-lets will be placed away from storm sewer systems, storm inlet(s), surface waters and wetlands. No vehicle maintenance shall be conducted on-site. A washdown area shall be designated at all times and will not be located in any area that will allow for the discharge of polluted runoff.	
Section 19	Provide a detailed description of the maintenance plan for all structural and non-structural controls to assure that they remain in good and effective operating condition.		
	control features in accordance with the technical spestringent: • Silt fence shall be inspected at least weekly. Any rescediment deposits shall be removed when they reach barrier. • Maintenance shall be performed on the rock entrains sediment. • Inlet(s)/outfalls shall be inspected immediately after to the filter inlets, silt fence, or filter fabric shall be performed on the rock entrains sediment. • Bare areas of the site that were previously seeded so instructions. • Mulch and sod that has been washed out shall be reformed in the rock entrains sediment.	quired repairs shall be made immediately. In approximately one-half the height of the Ince when any void spaces are full of Iter each rain event and any required repairs Iter or each r	
Section 20	Inspections: Describe the inspection and inspection NPDES Generic Permit for Stormwater Discharge	documentation procedures, as required by the FDEI from Large and Small Construction Activities.	
	Qualified personnel will inspect all points of dischar, not been stabilized, constructed areas and locations BMPs at least once every 7 calendar days and within inches or greater. Where sites have been finally stabionce every month until the Notice of Termination is	where vehicles enter and exit the site, and all 24 hours of the end of a rainfall event that is 0.5 lized, said inspections shall be conducted at least	
Section 21	Identify and describe all sources of non-stormwater discharges as allowed by the FDEP NPDES Ger Permit for Stormwater Discharge from Large and Small Construction Activities.		
	Contractor is responsible for all surface water discharges, ra Contractor must incorporate all BMP's necessary to meet or Dewatering from construction activities shall be maintained a systems.	exceed state water quality and SWPPPP requirements.	
Section 22	All contractor(s) and subcontractor(s) identified in the certification:	he SWPPP must sign the following	
	"I certify under penalty of law that I understand, and conditions of the State of Florida Generic Permit fo		


Section 22	Name	Title	Company Name, Address and Phone Number	Date

NOTE: CONTRACTOR SHALL FILL OUT THE RESPONSIBLE ENTITIES TABLE ABOVE.

RESPONSIBLE ENTITIES

THE SWPPP MUST CLEARLY IDENTIFY, FOR EACH MEASURE IDENTIFIED WITHIN THE SWPPP, THE CONTRACTOR(S) OR SUBCONTRACTOR(S) THAT WILL IMPLEMENT EACH MEASURE. ALL CONTRACTOR(S) AND SUBCONTRACTOR(S) THAT WILL BE RESPONSIBLE FOR THE IMPLEMENTATION AND MAINTENANCE OF THE MEASURES IDENTIFIED IN THE SWPPP MUST SIGN THE FOLLOWIN

"I CERTIFY UNDER PENALTY OF LAW THAT I UNDERSTAND, AND SHALL COMPLY WITH, THE TERMS AND CONDITIONS OF THE STATE OF FLORIDA GENERIC PERMIT FOR STORMWATER DISCHARGE FROM LARGE AND SMALL CONSTRUCTION ACTIVITIES AND THIS STORMWATER POLLUTION PREVENTION PLAN PREPARED THERE UNDER."

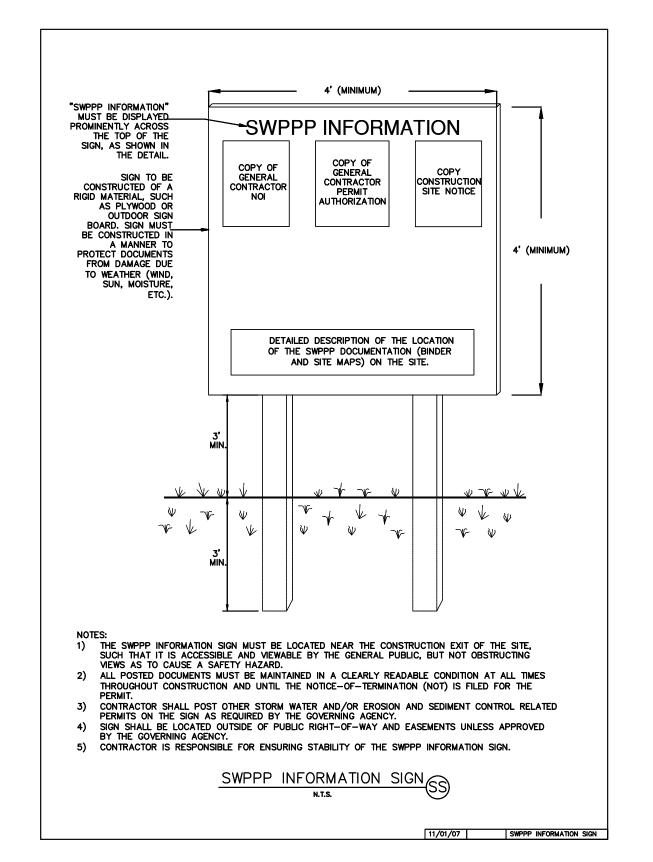

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PSLUSD PROJECT # 11-642-06

Know what's **below**. SUNSHINE STATE ONE CALL OF FLORIDA, INC.

VERTICAL DATUM

ELEVATIONS SHOWN HEREON ARE BASED ON THE NORTH AMERICAN VERTICAL DATUM OF 1988 (NAVD '88). SUBTRACT 1.50' FROM NGVD '29 ELEVATION TO GET THE NAVD '88 ELEVATION.

CITY OF PORT ST. LUCIE PROJECT #

P22-301 / P23-153


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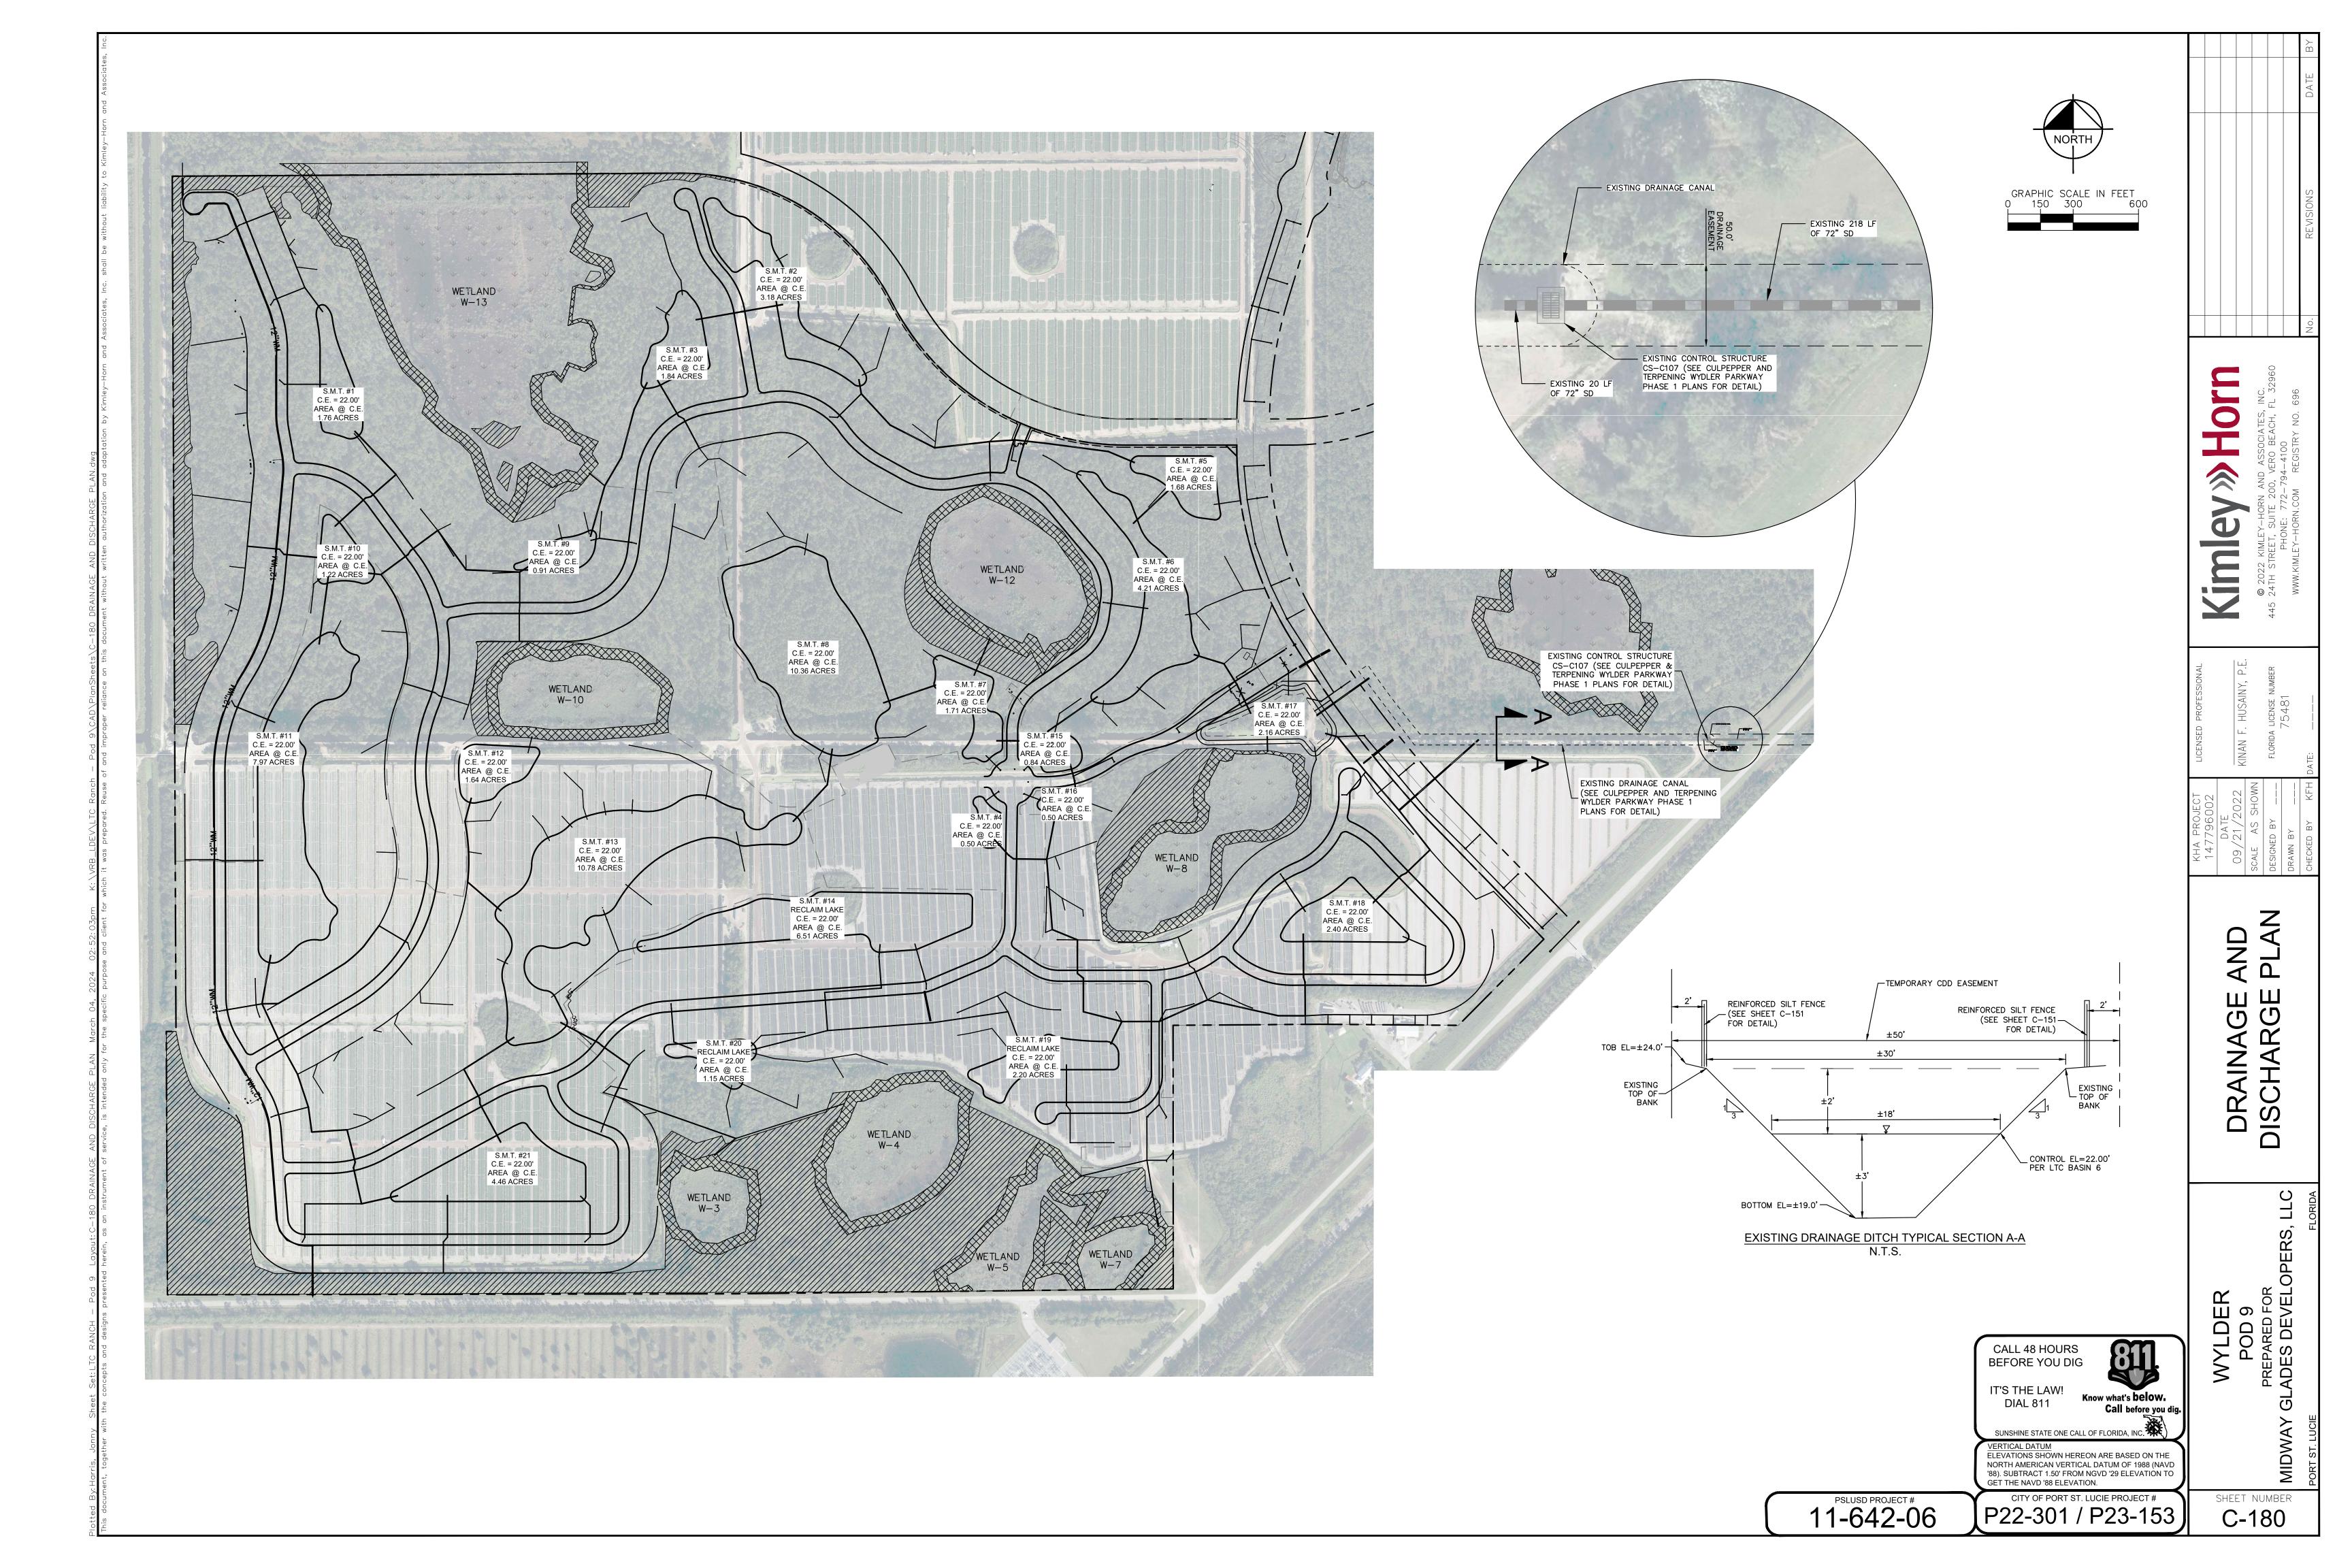
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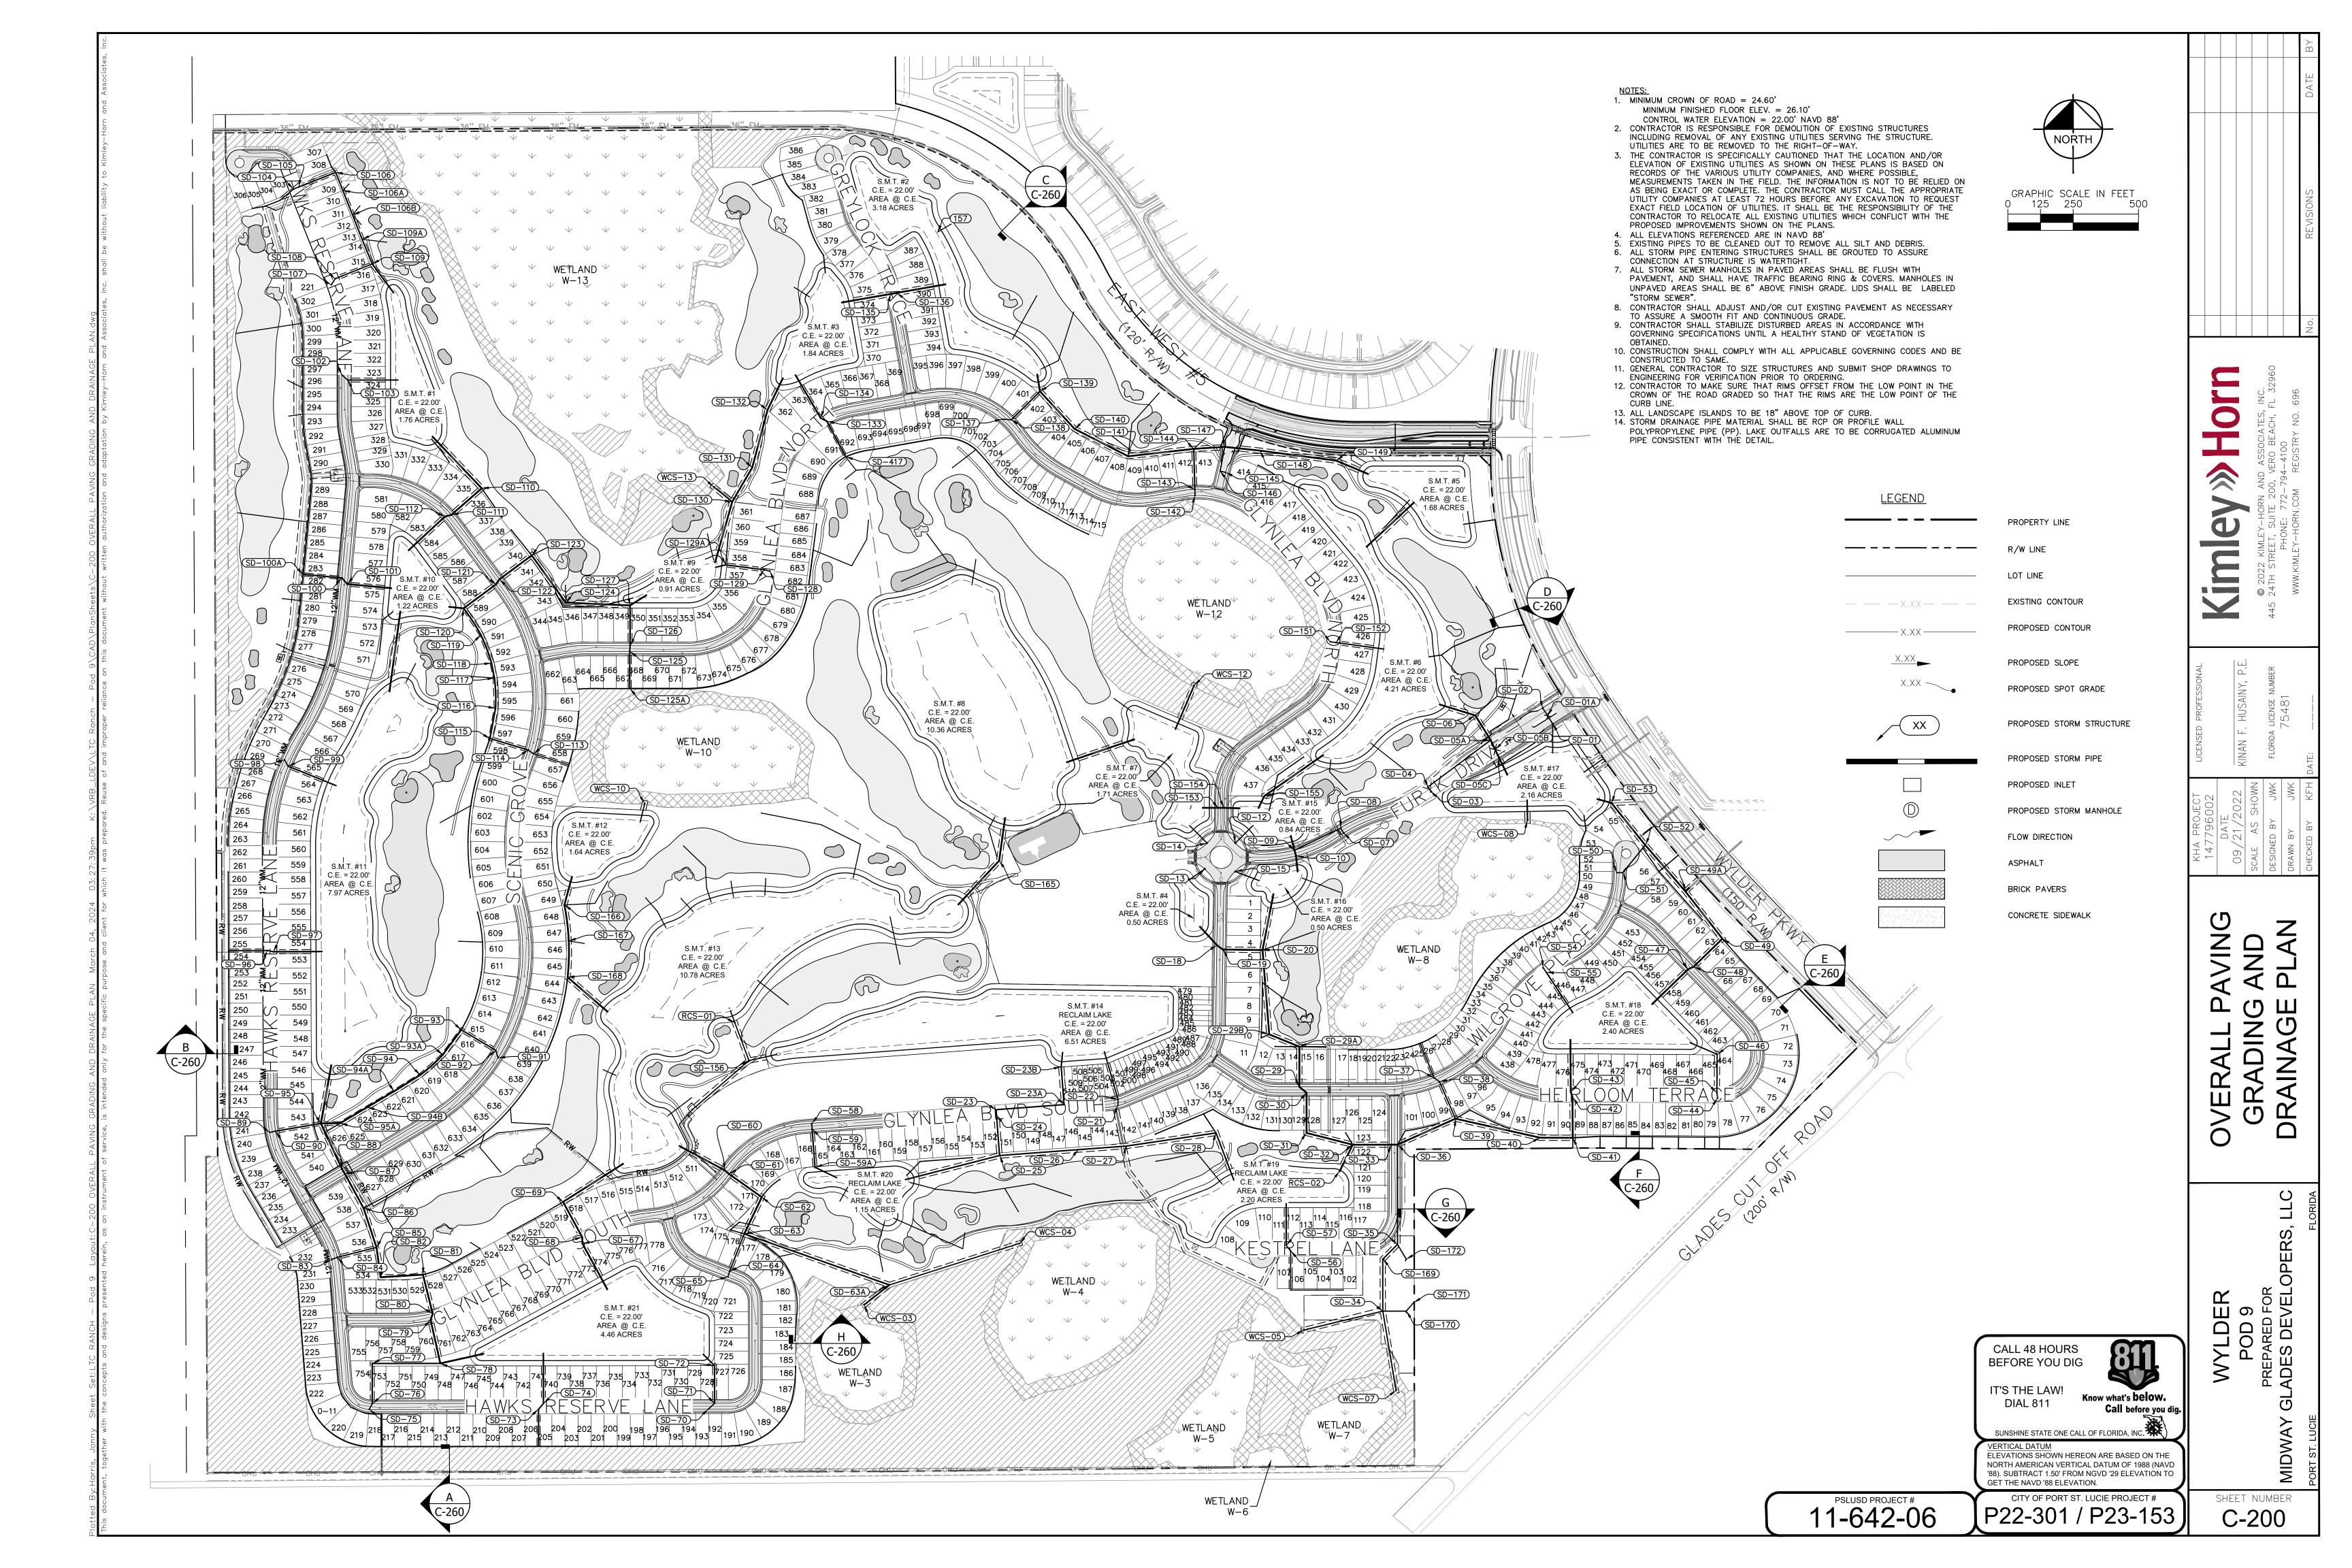
SWPPP


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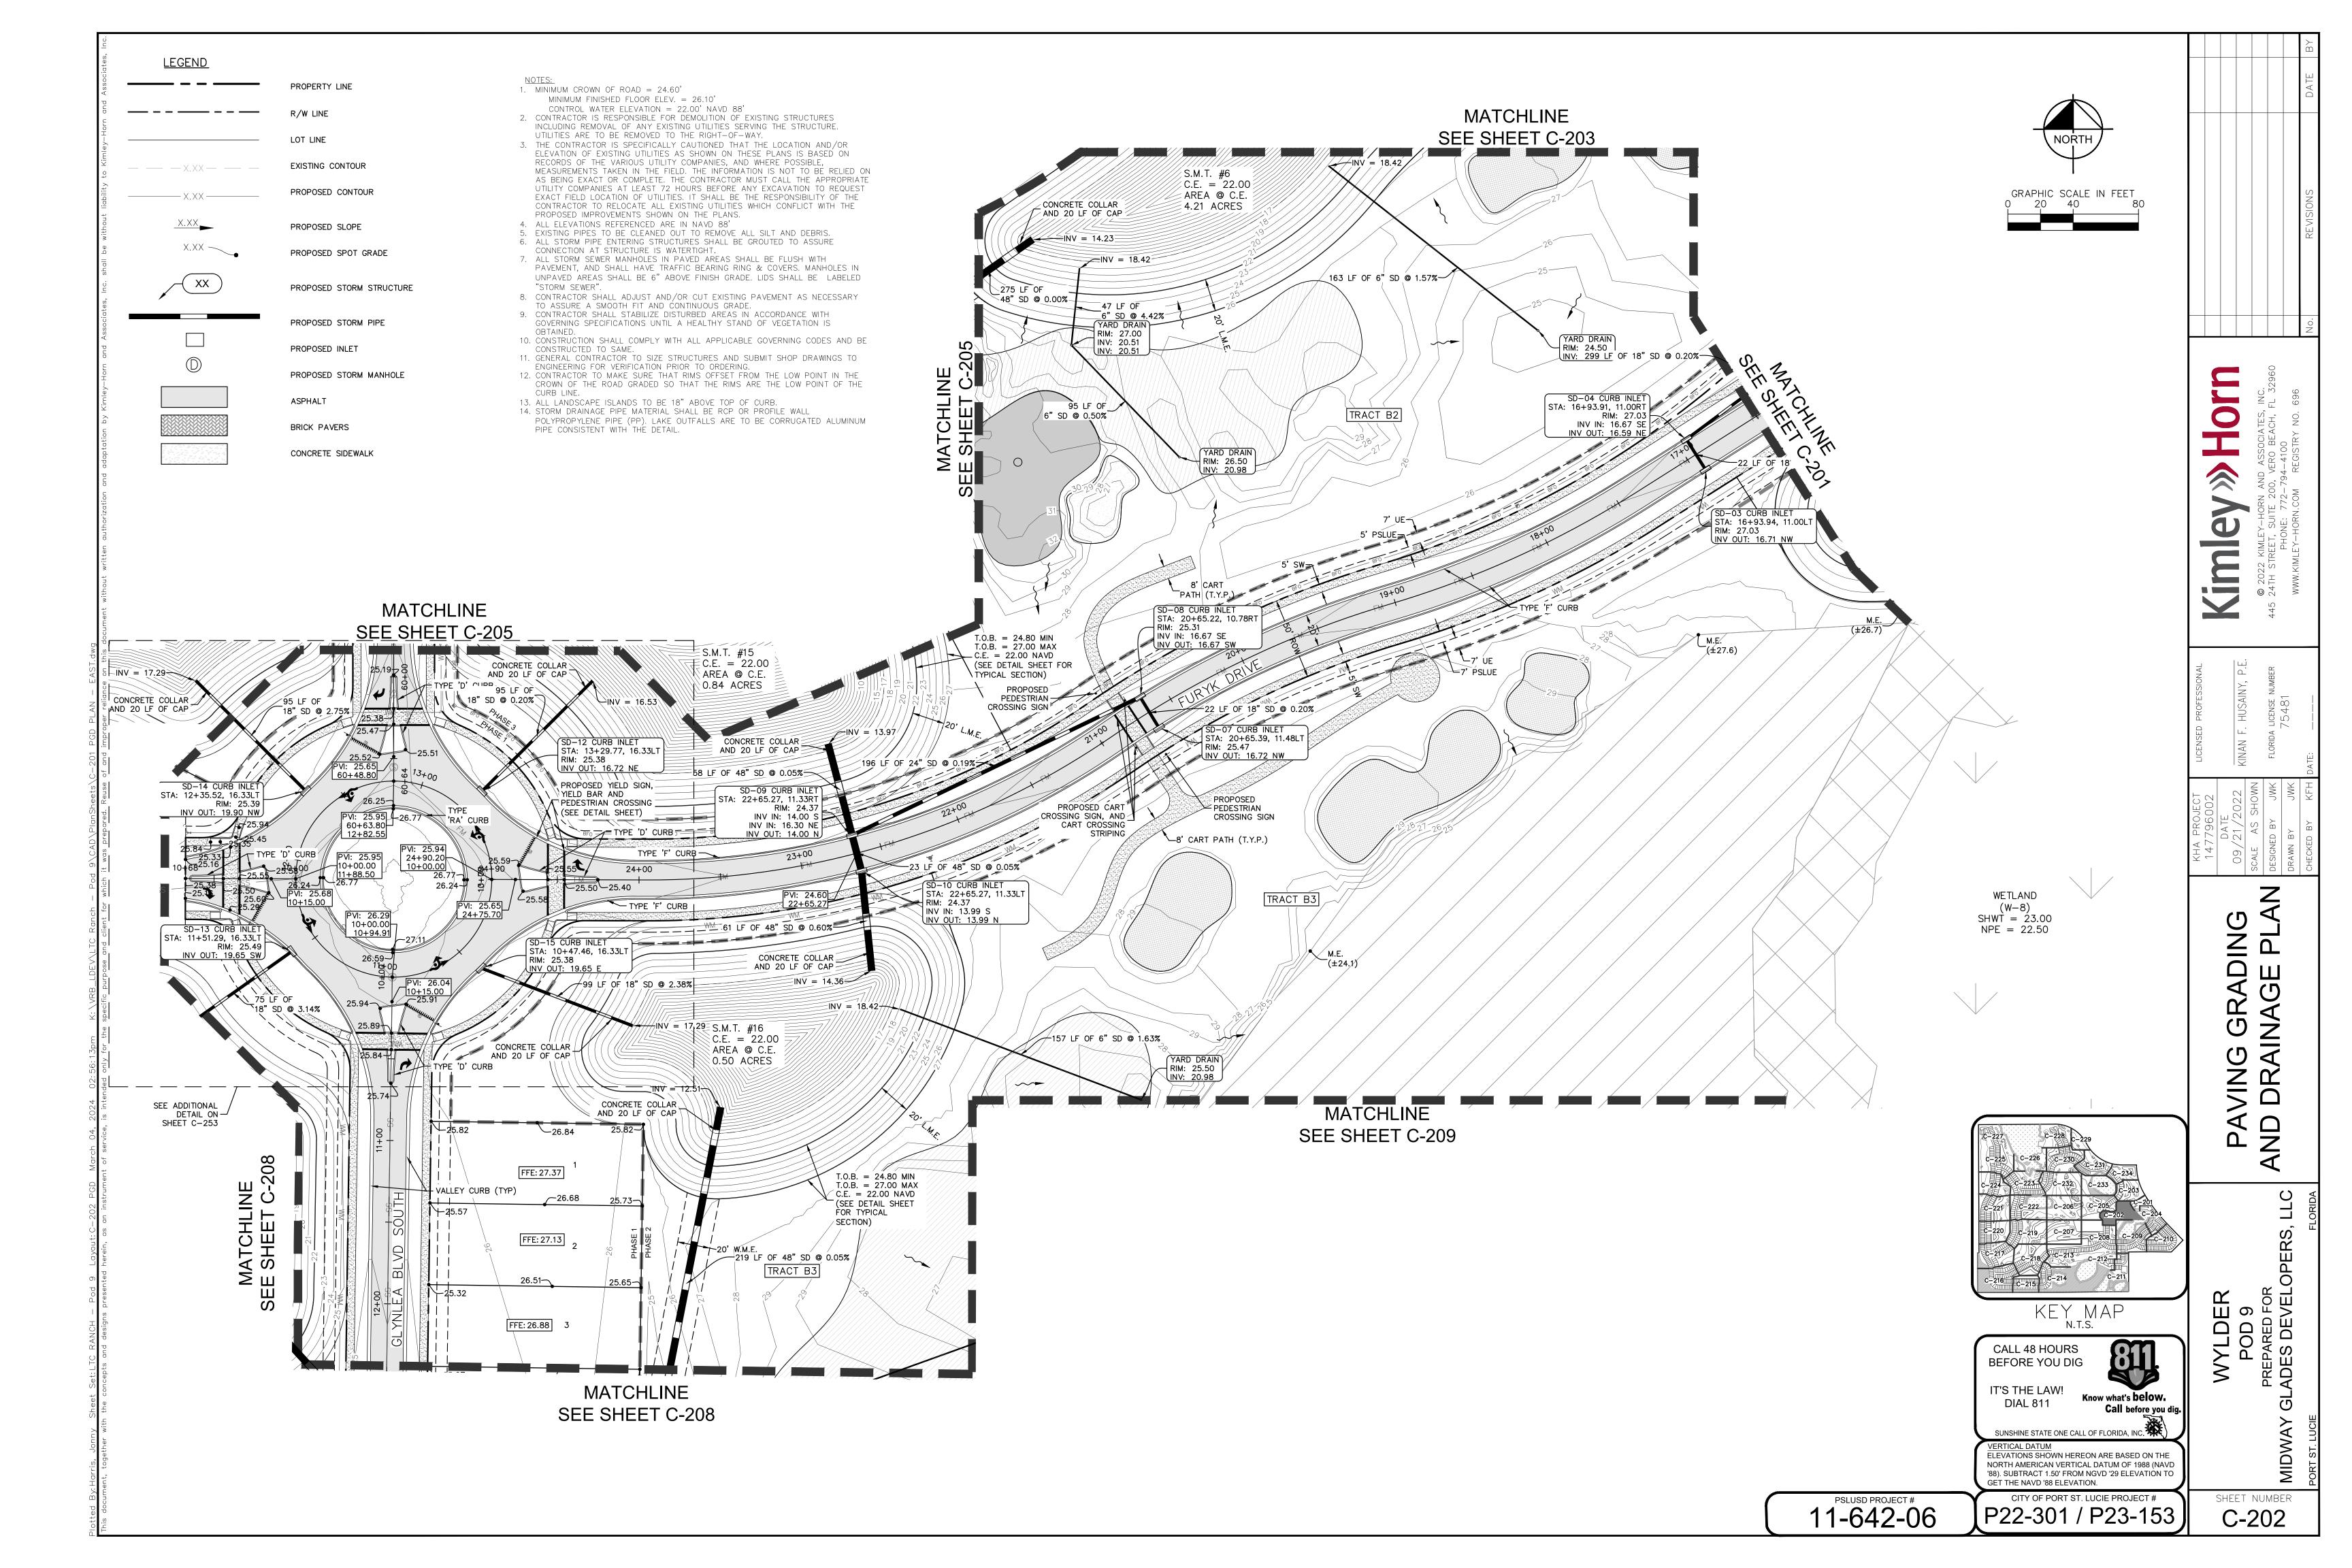
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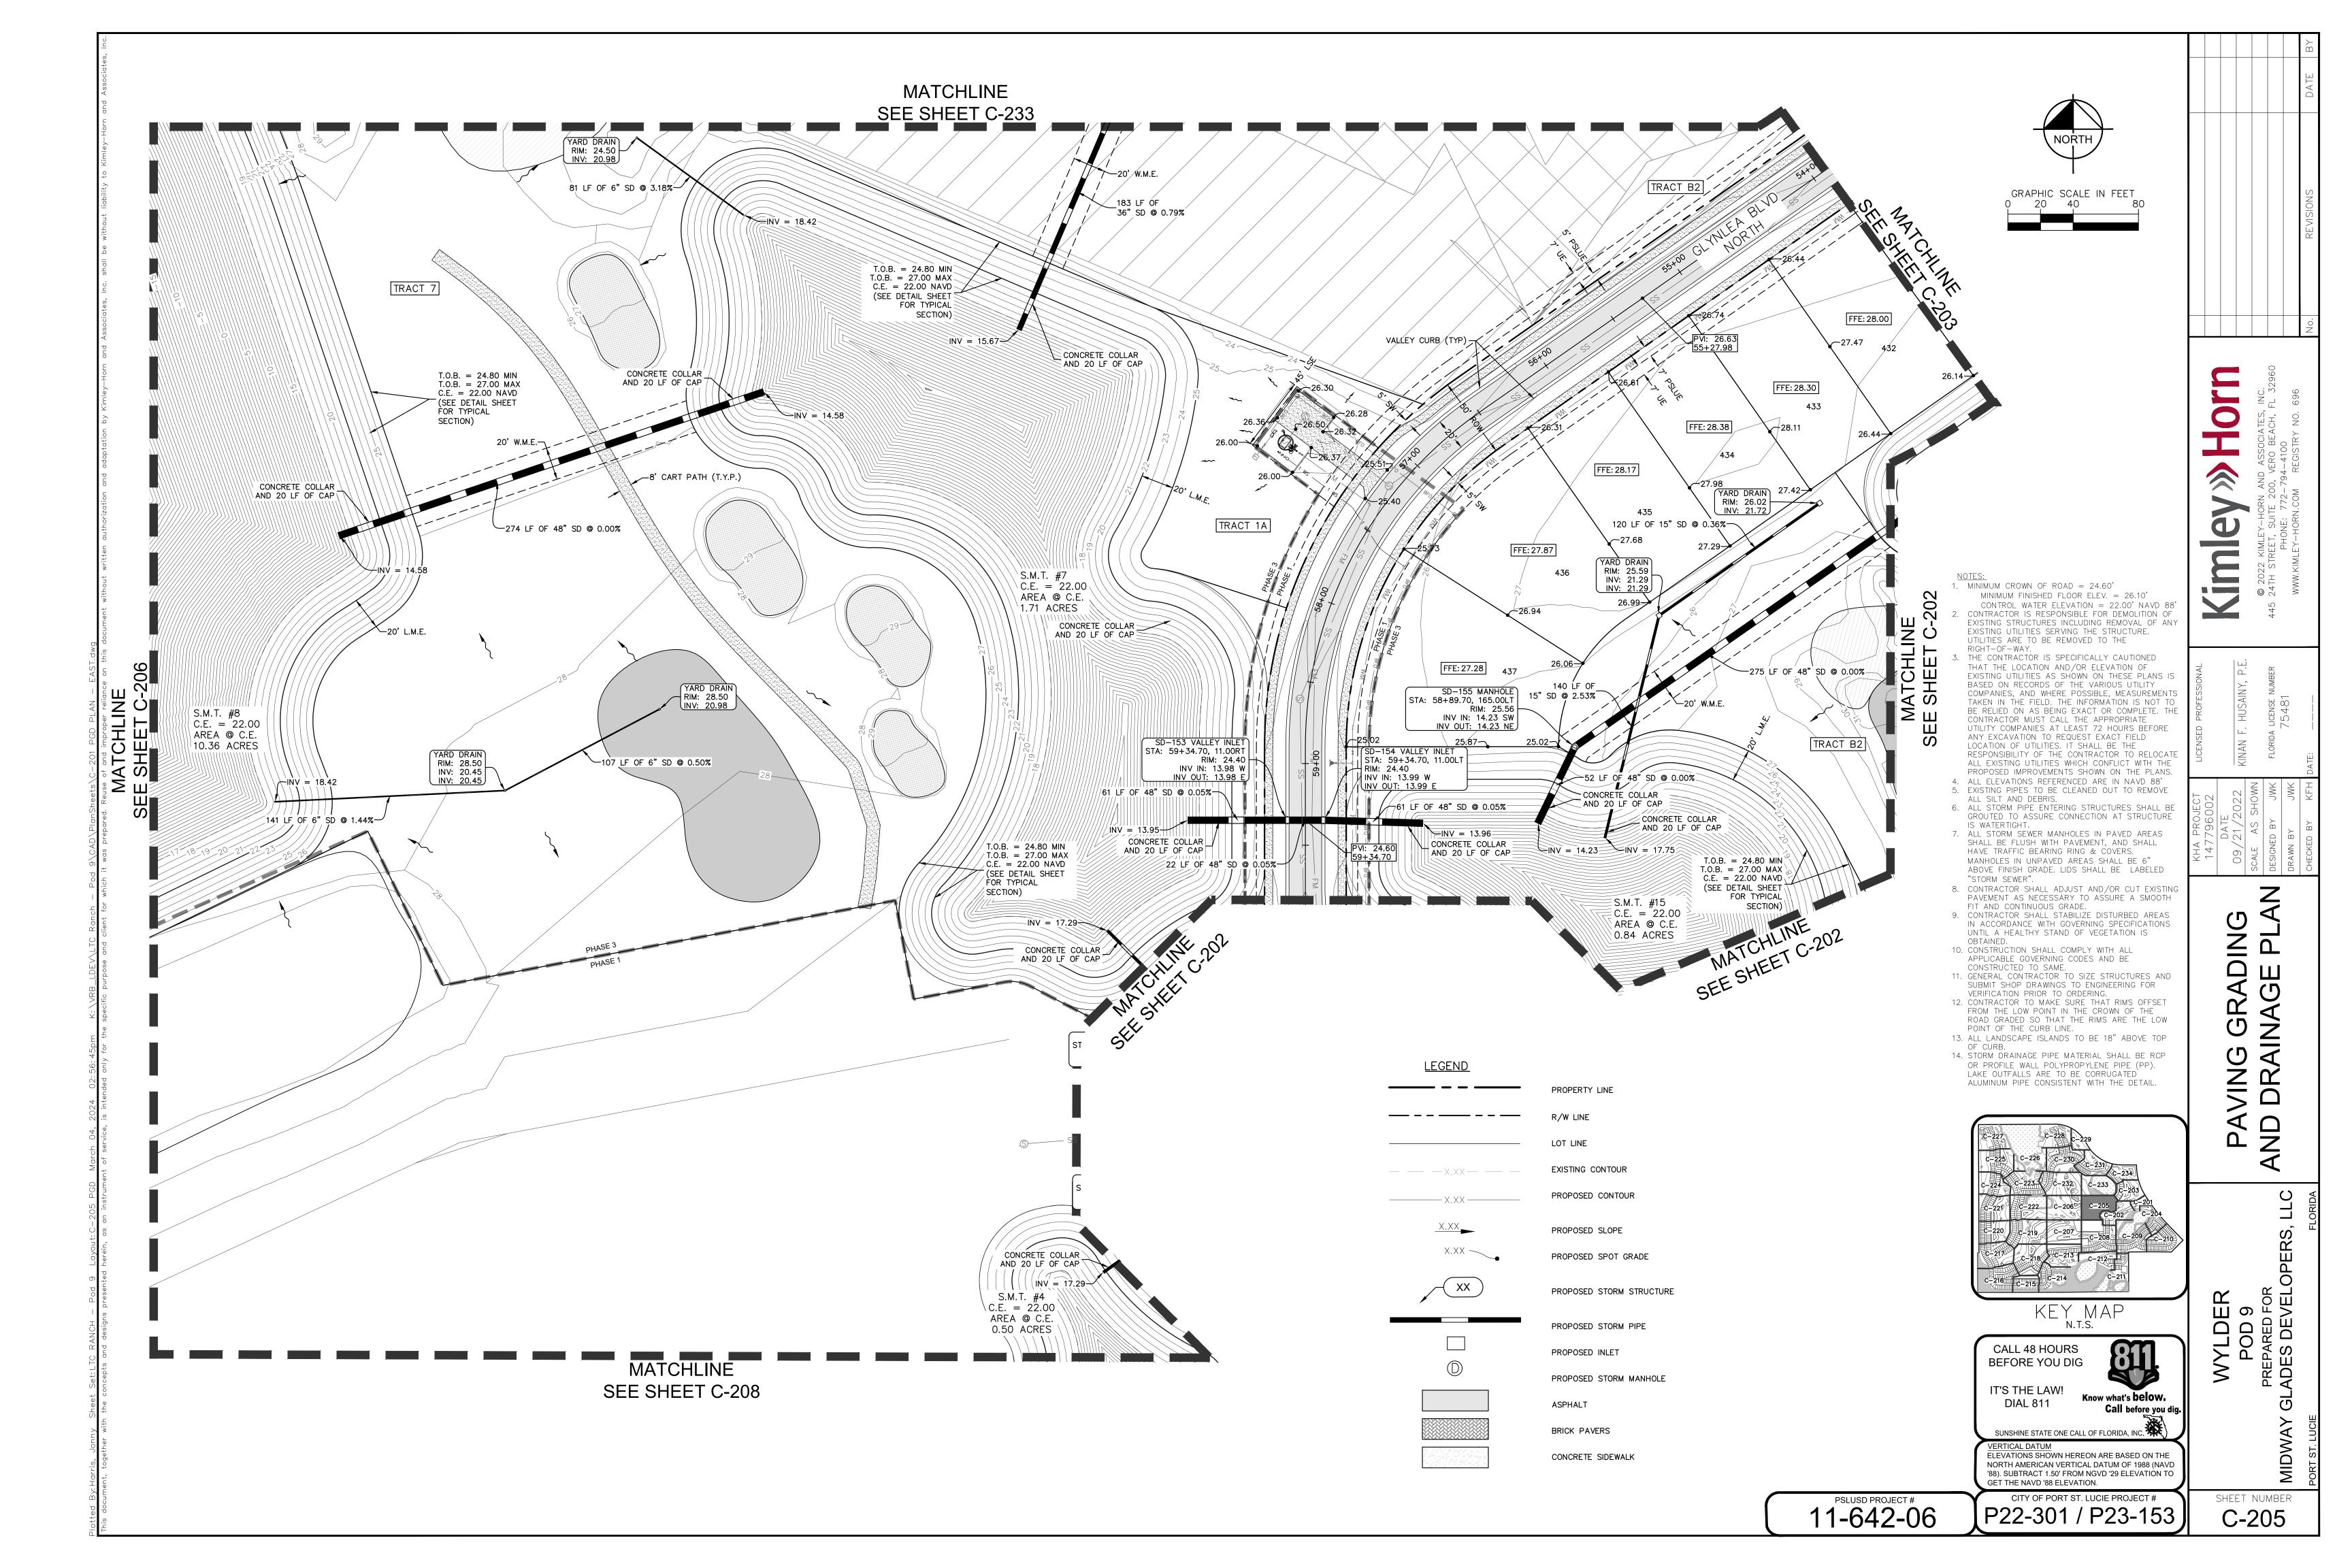











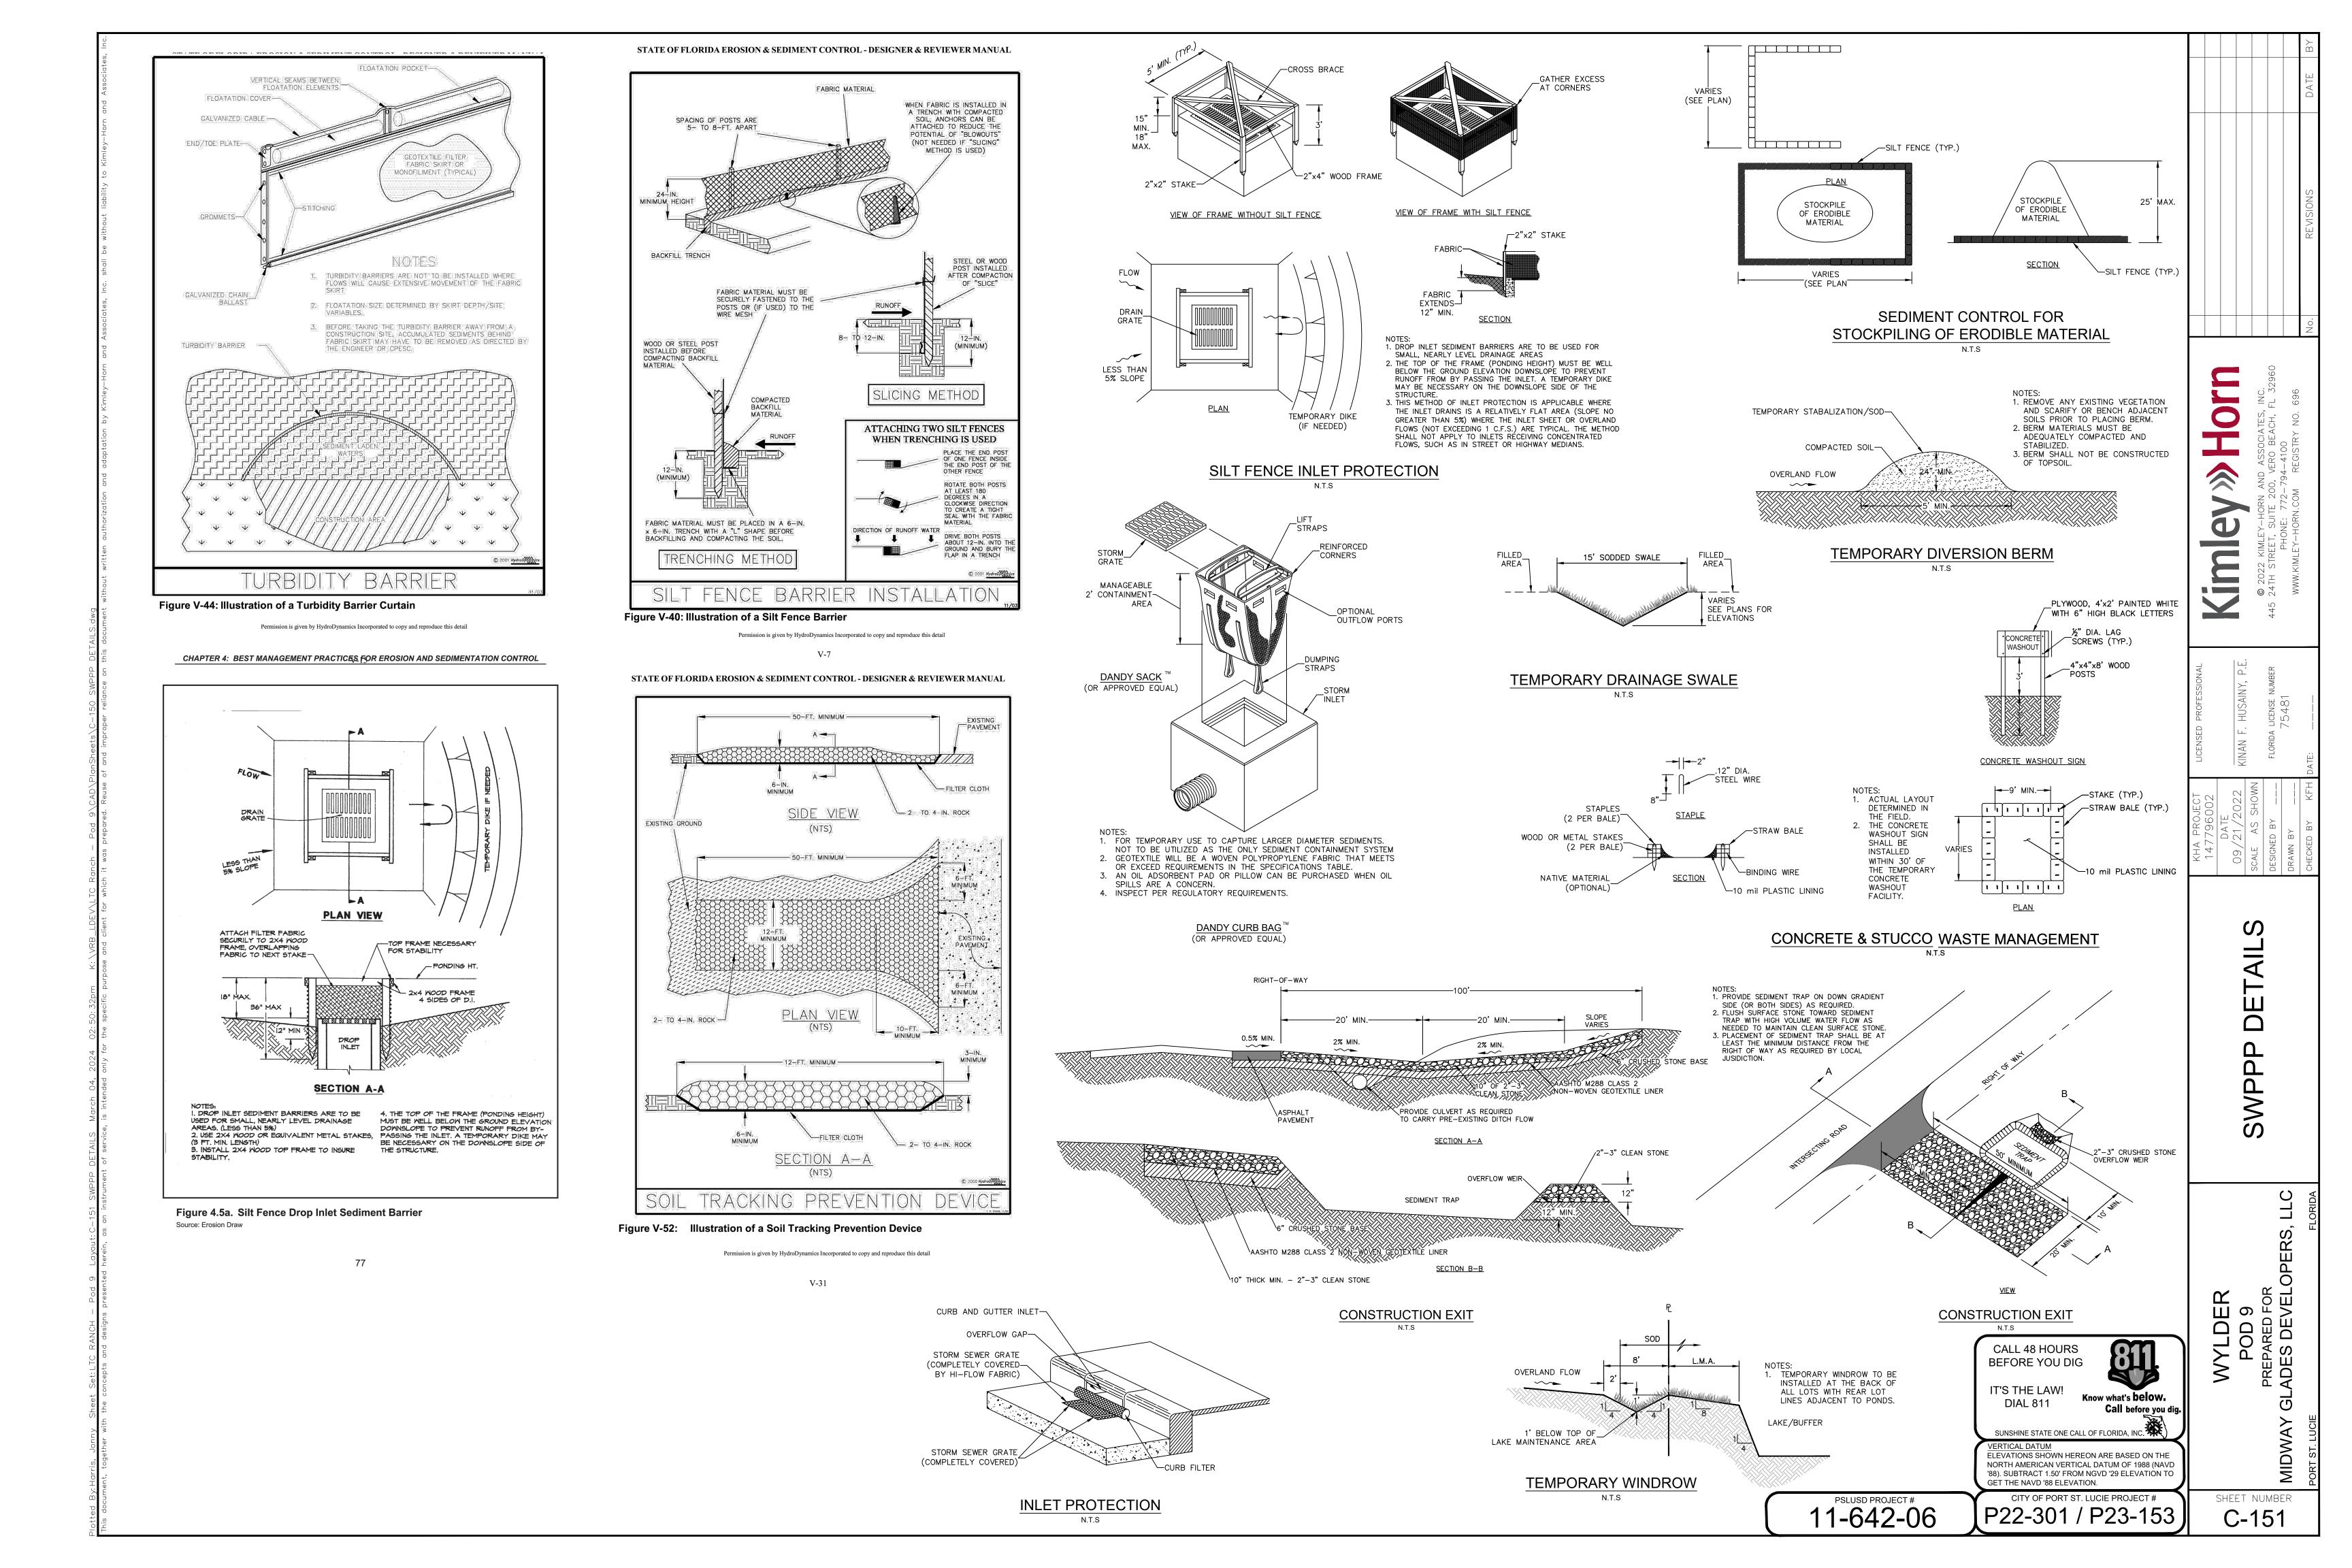


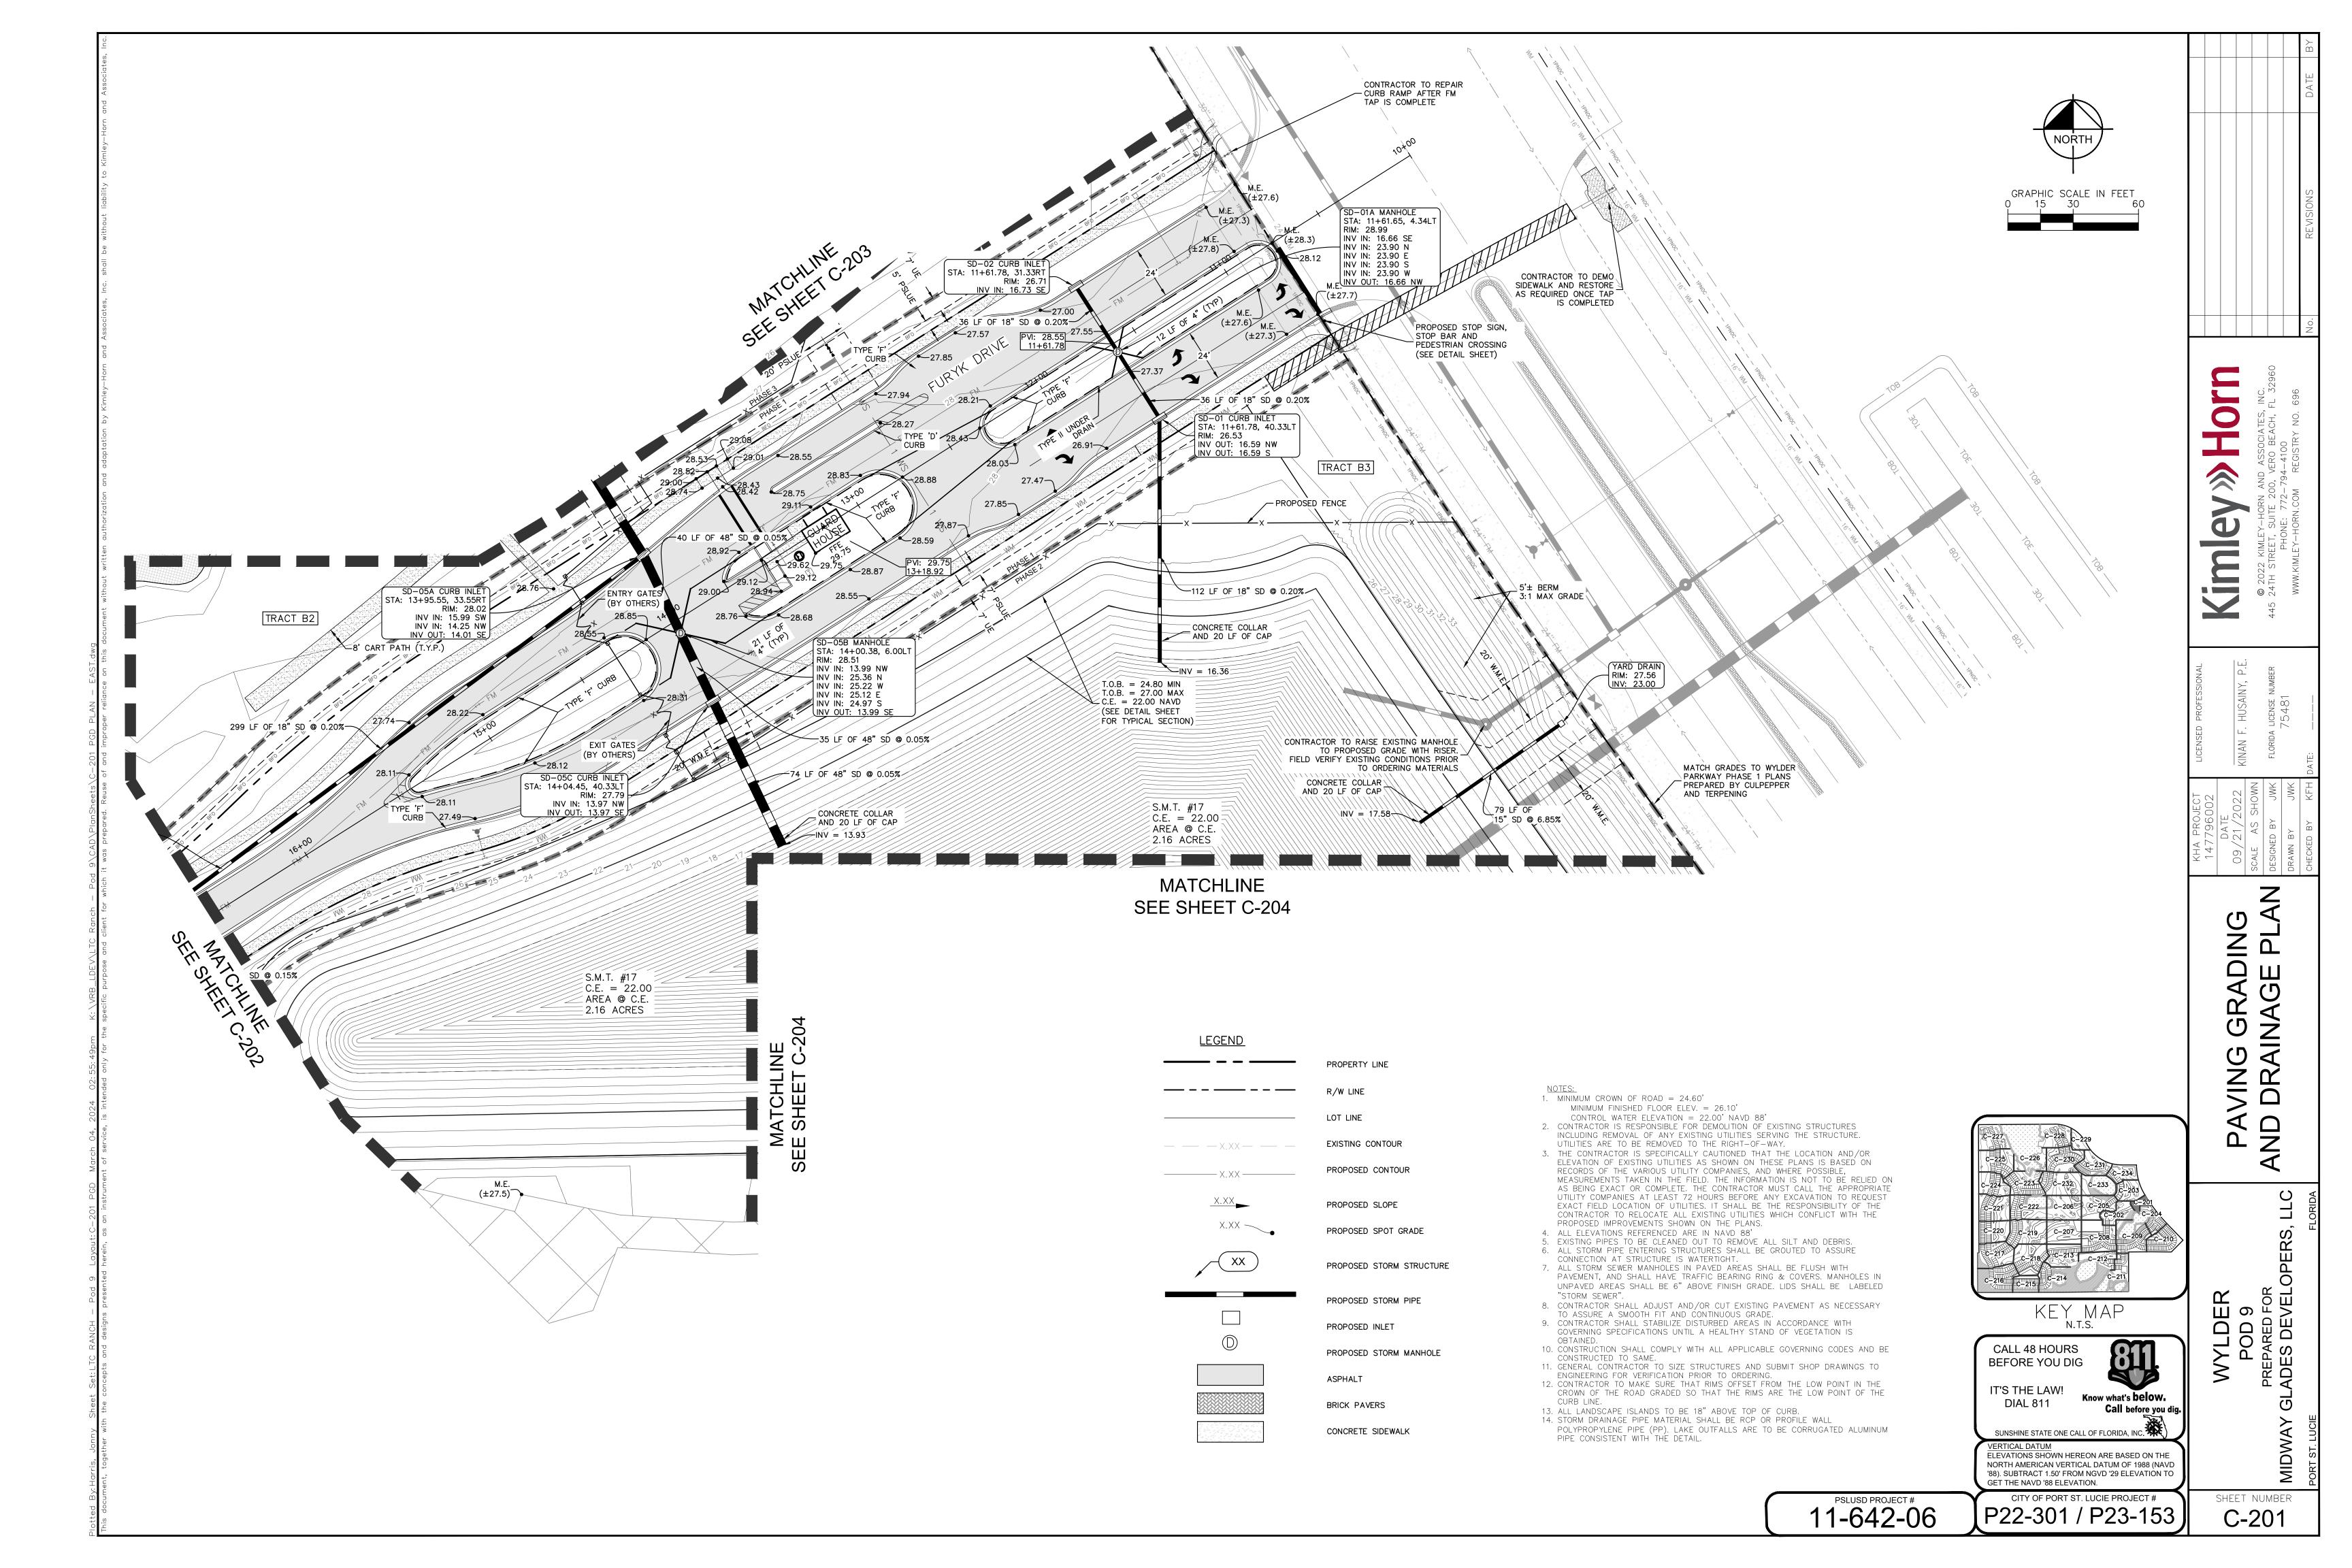


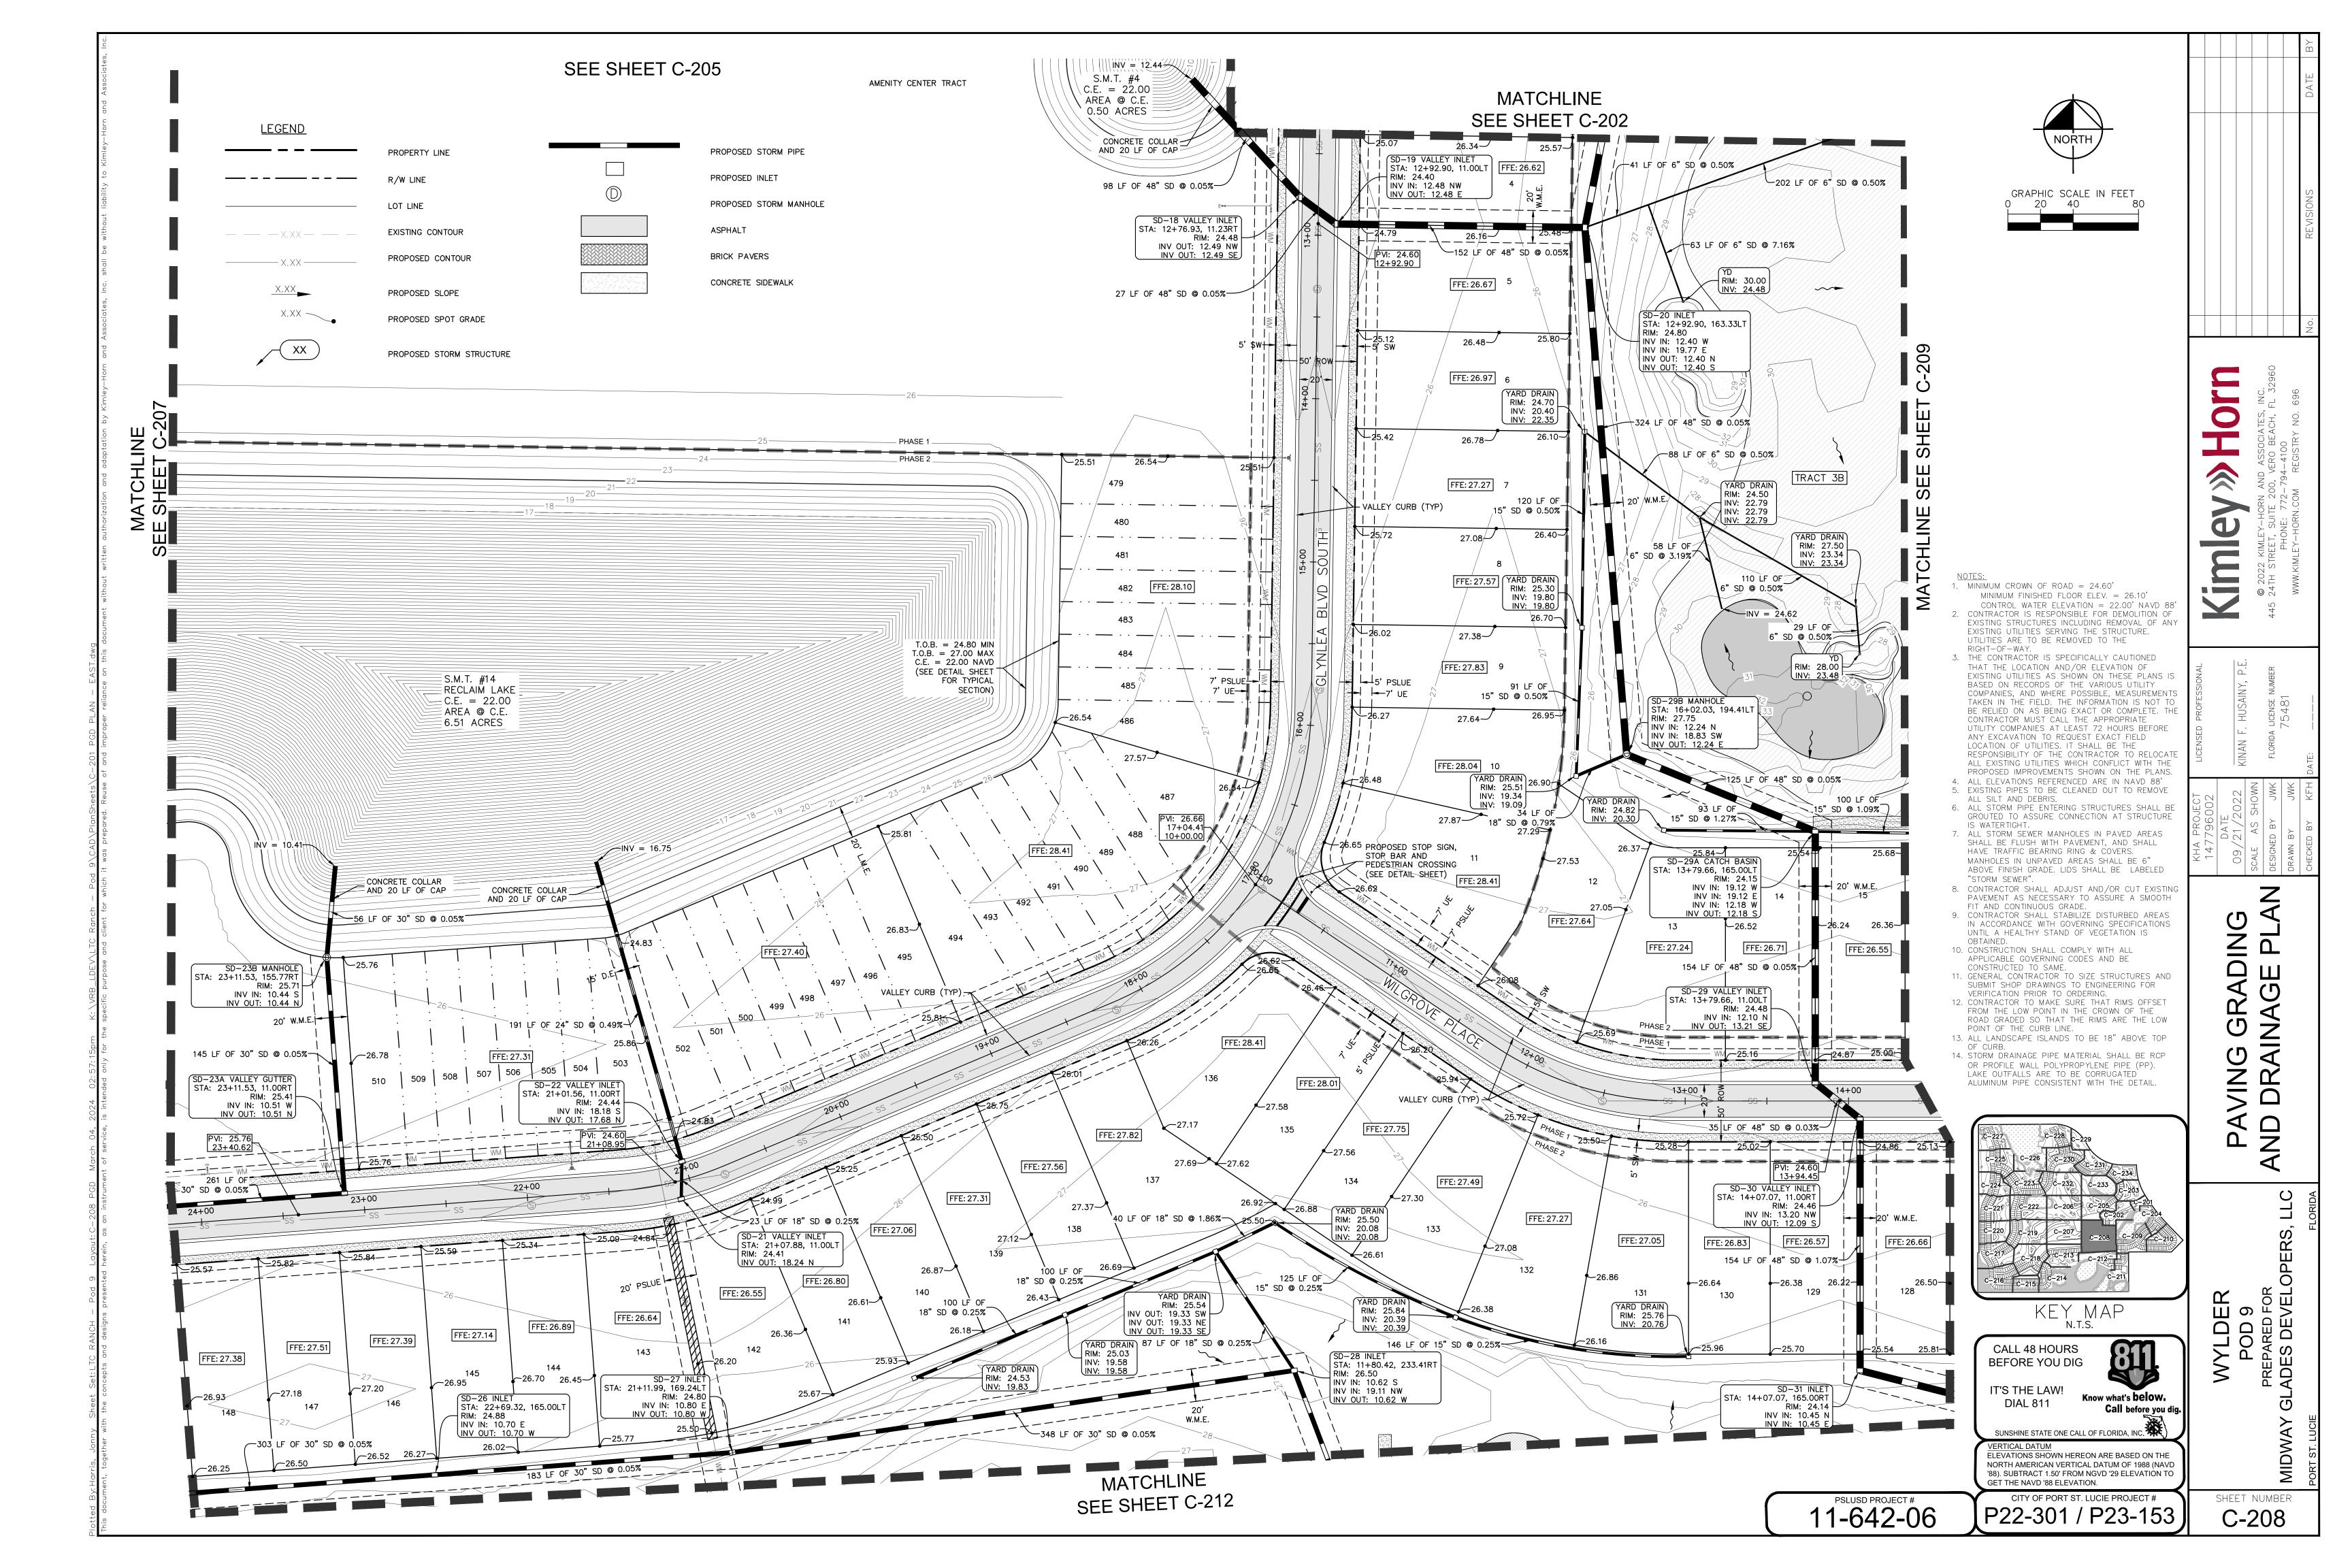


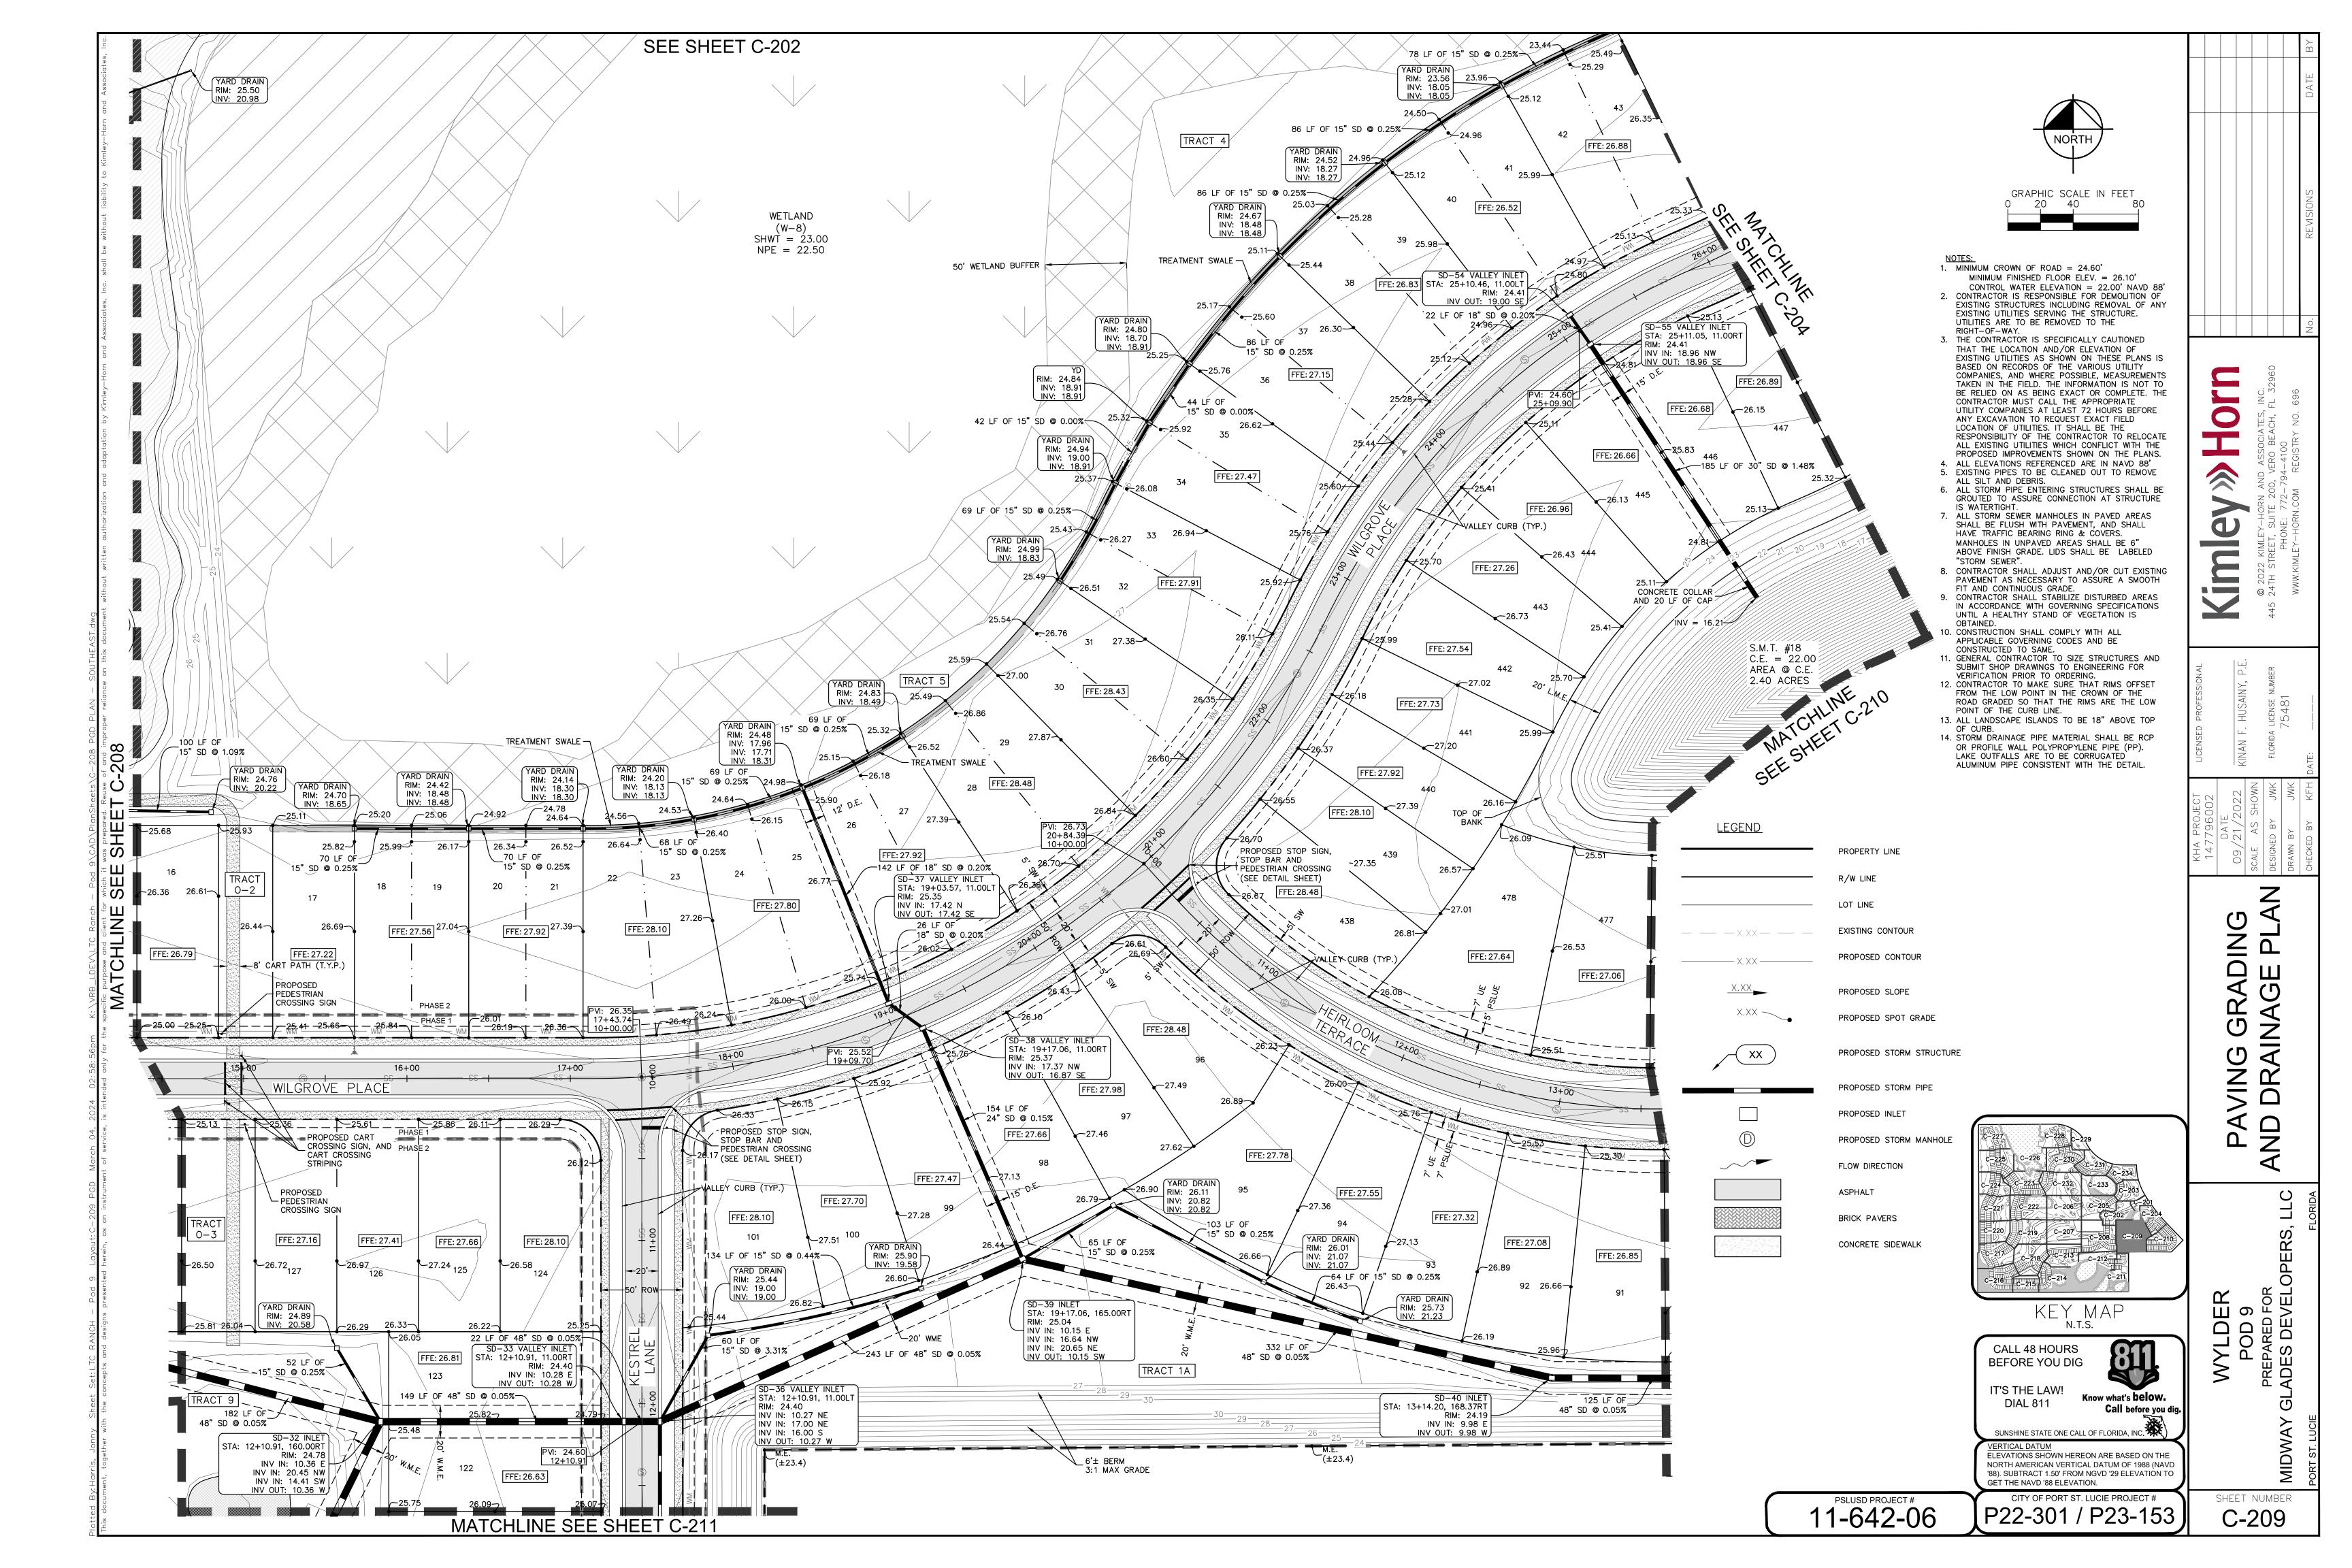

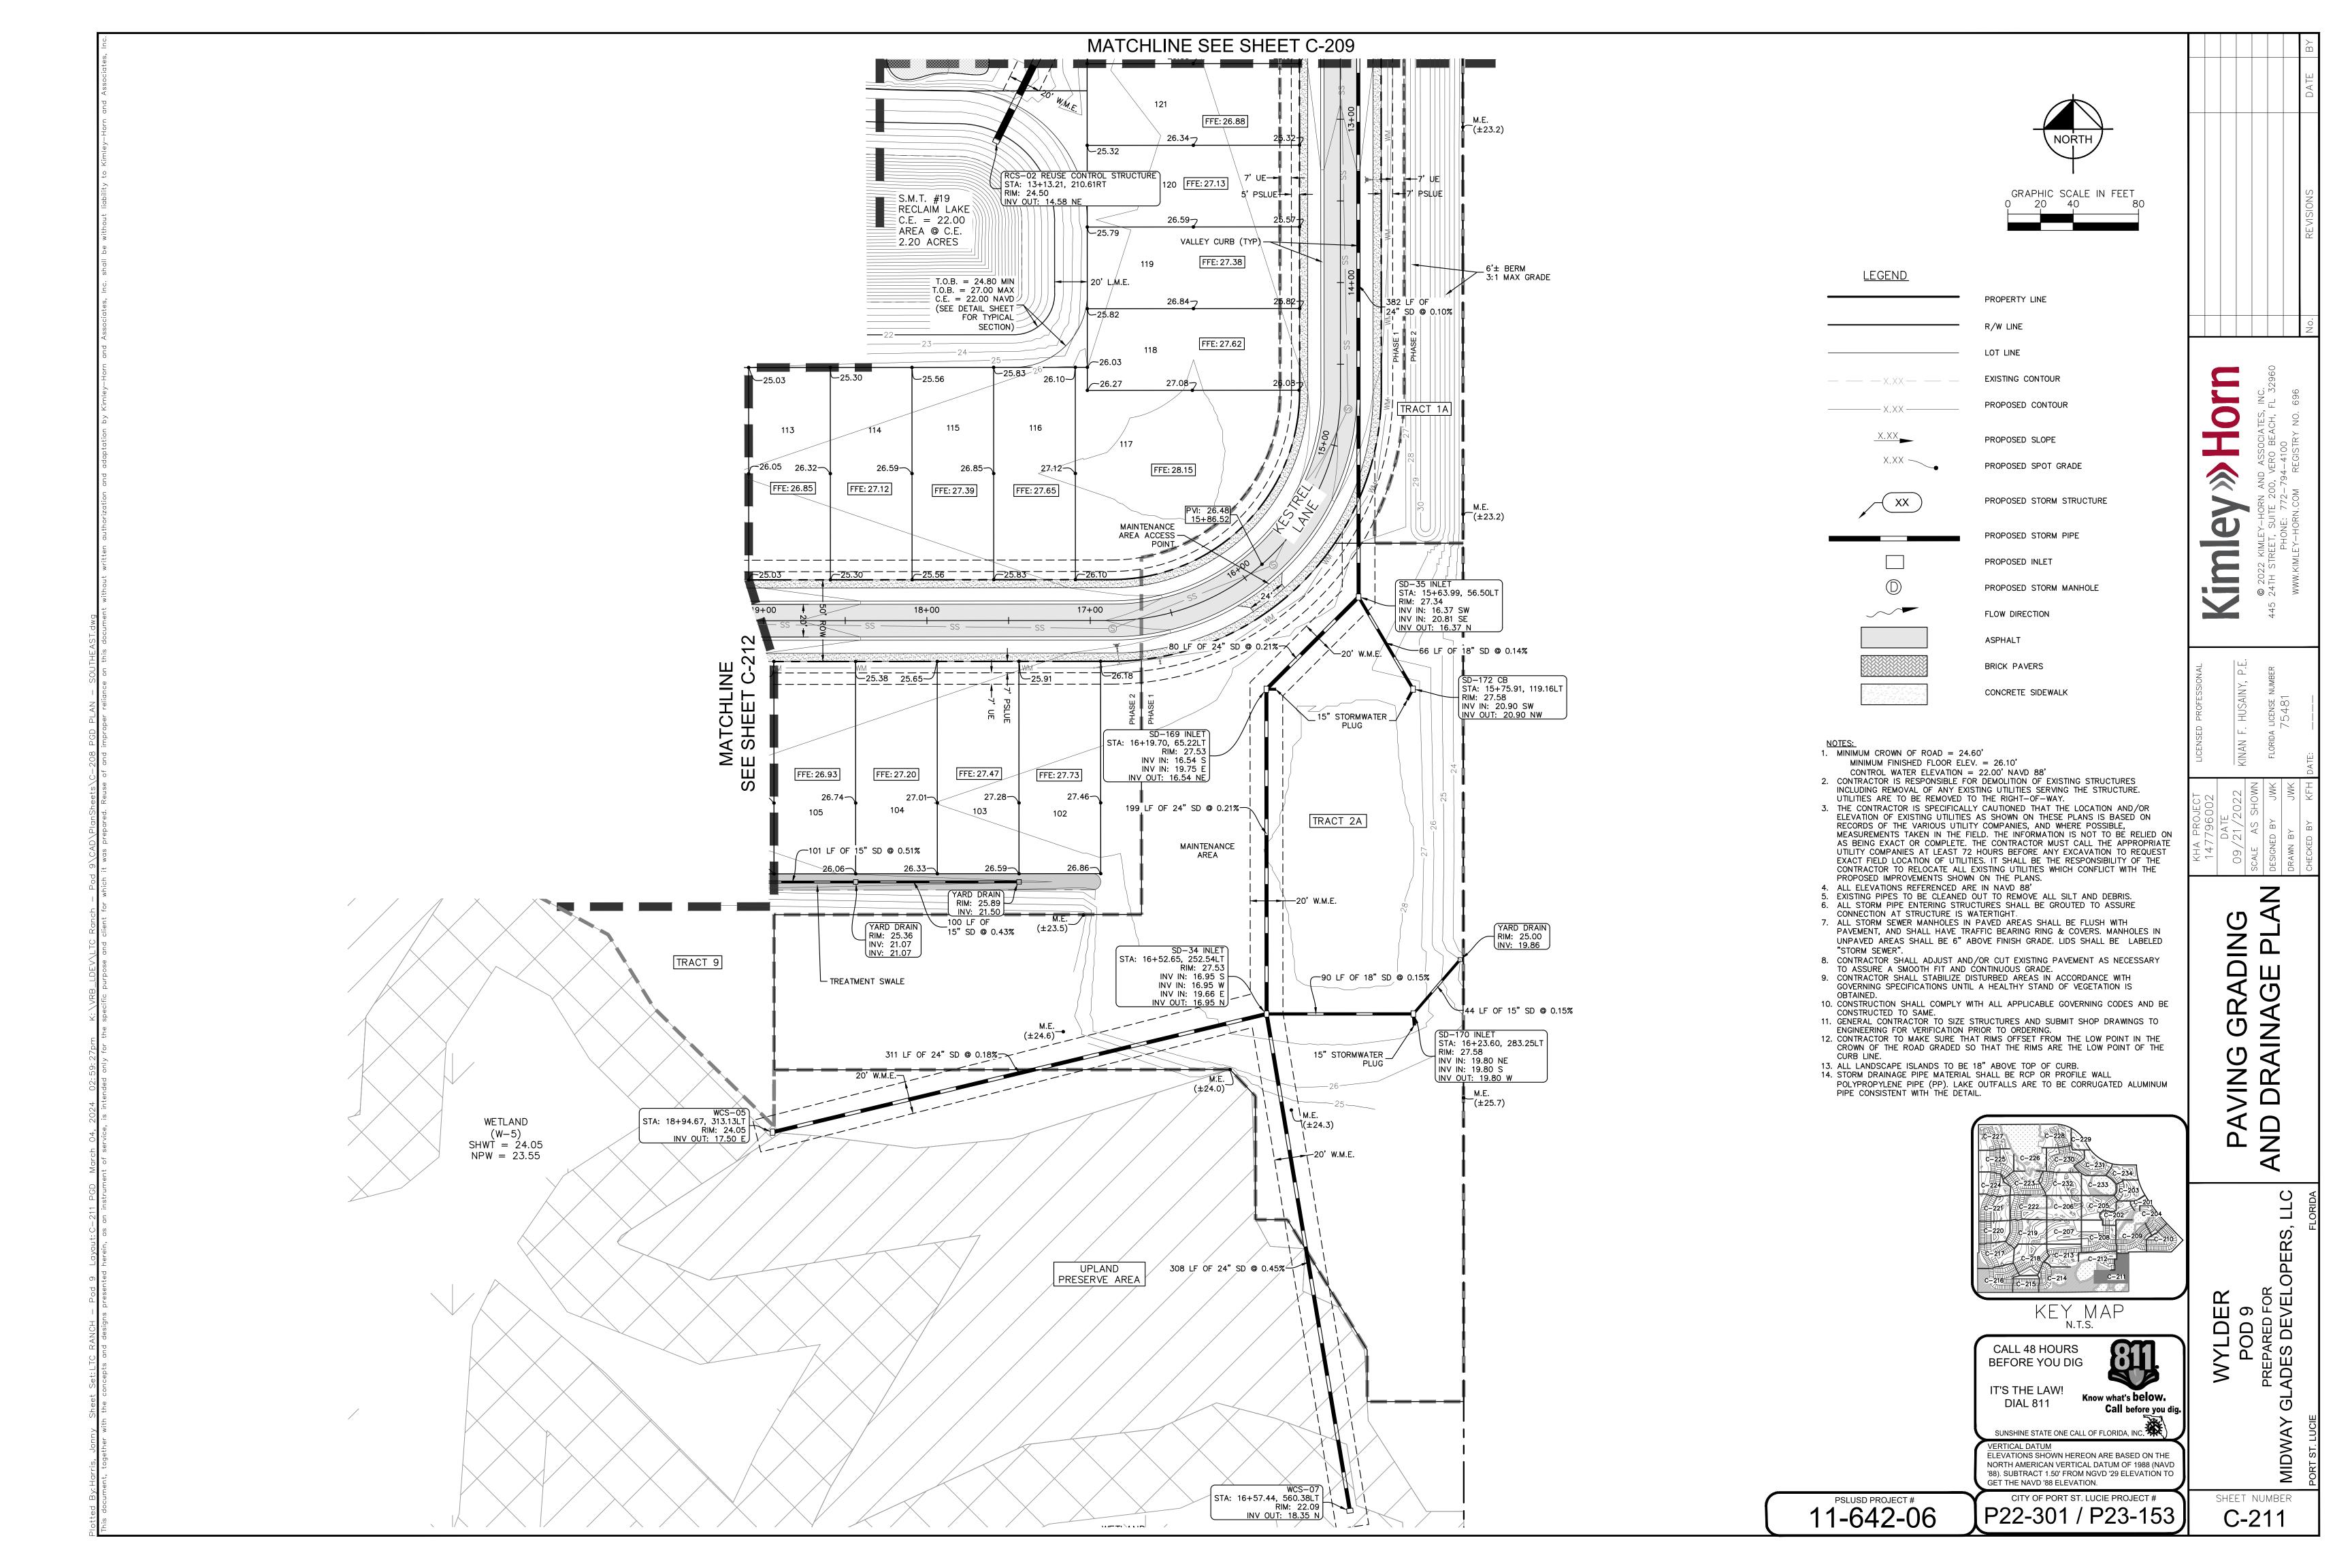


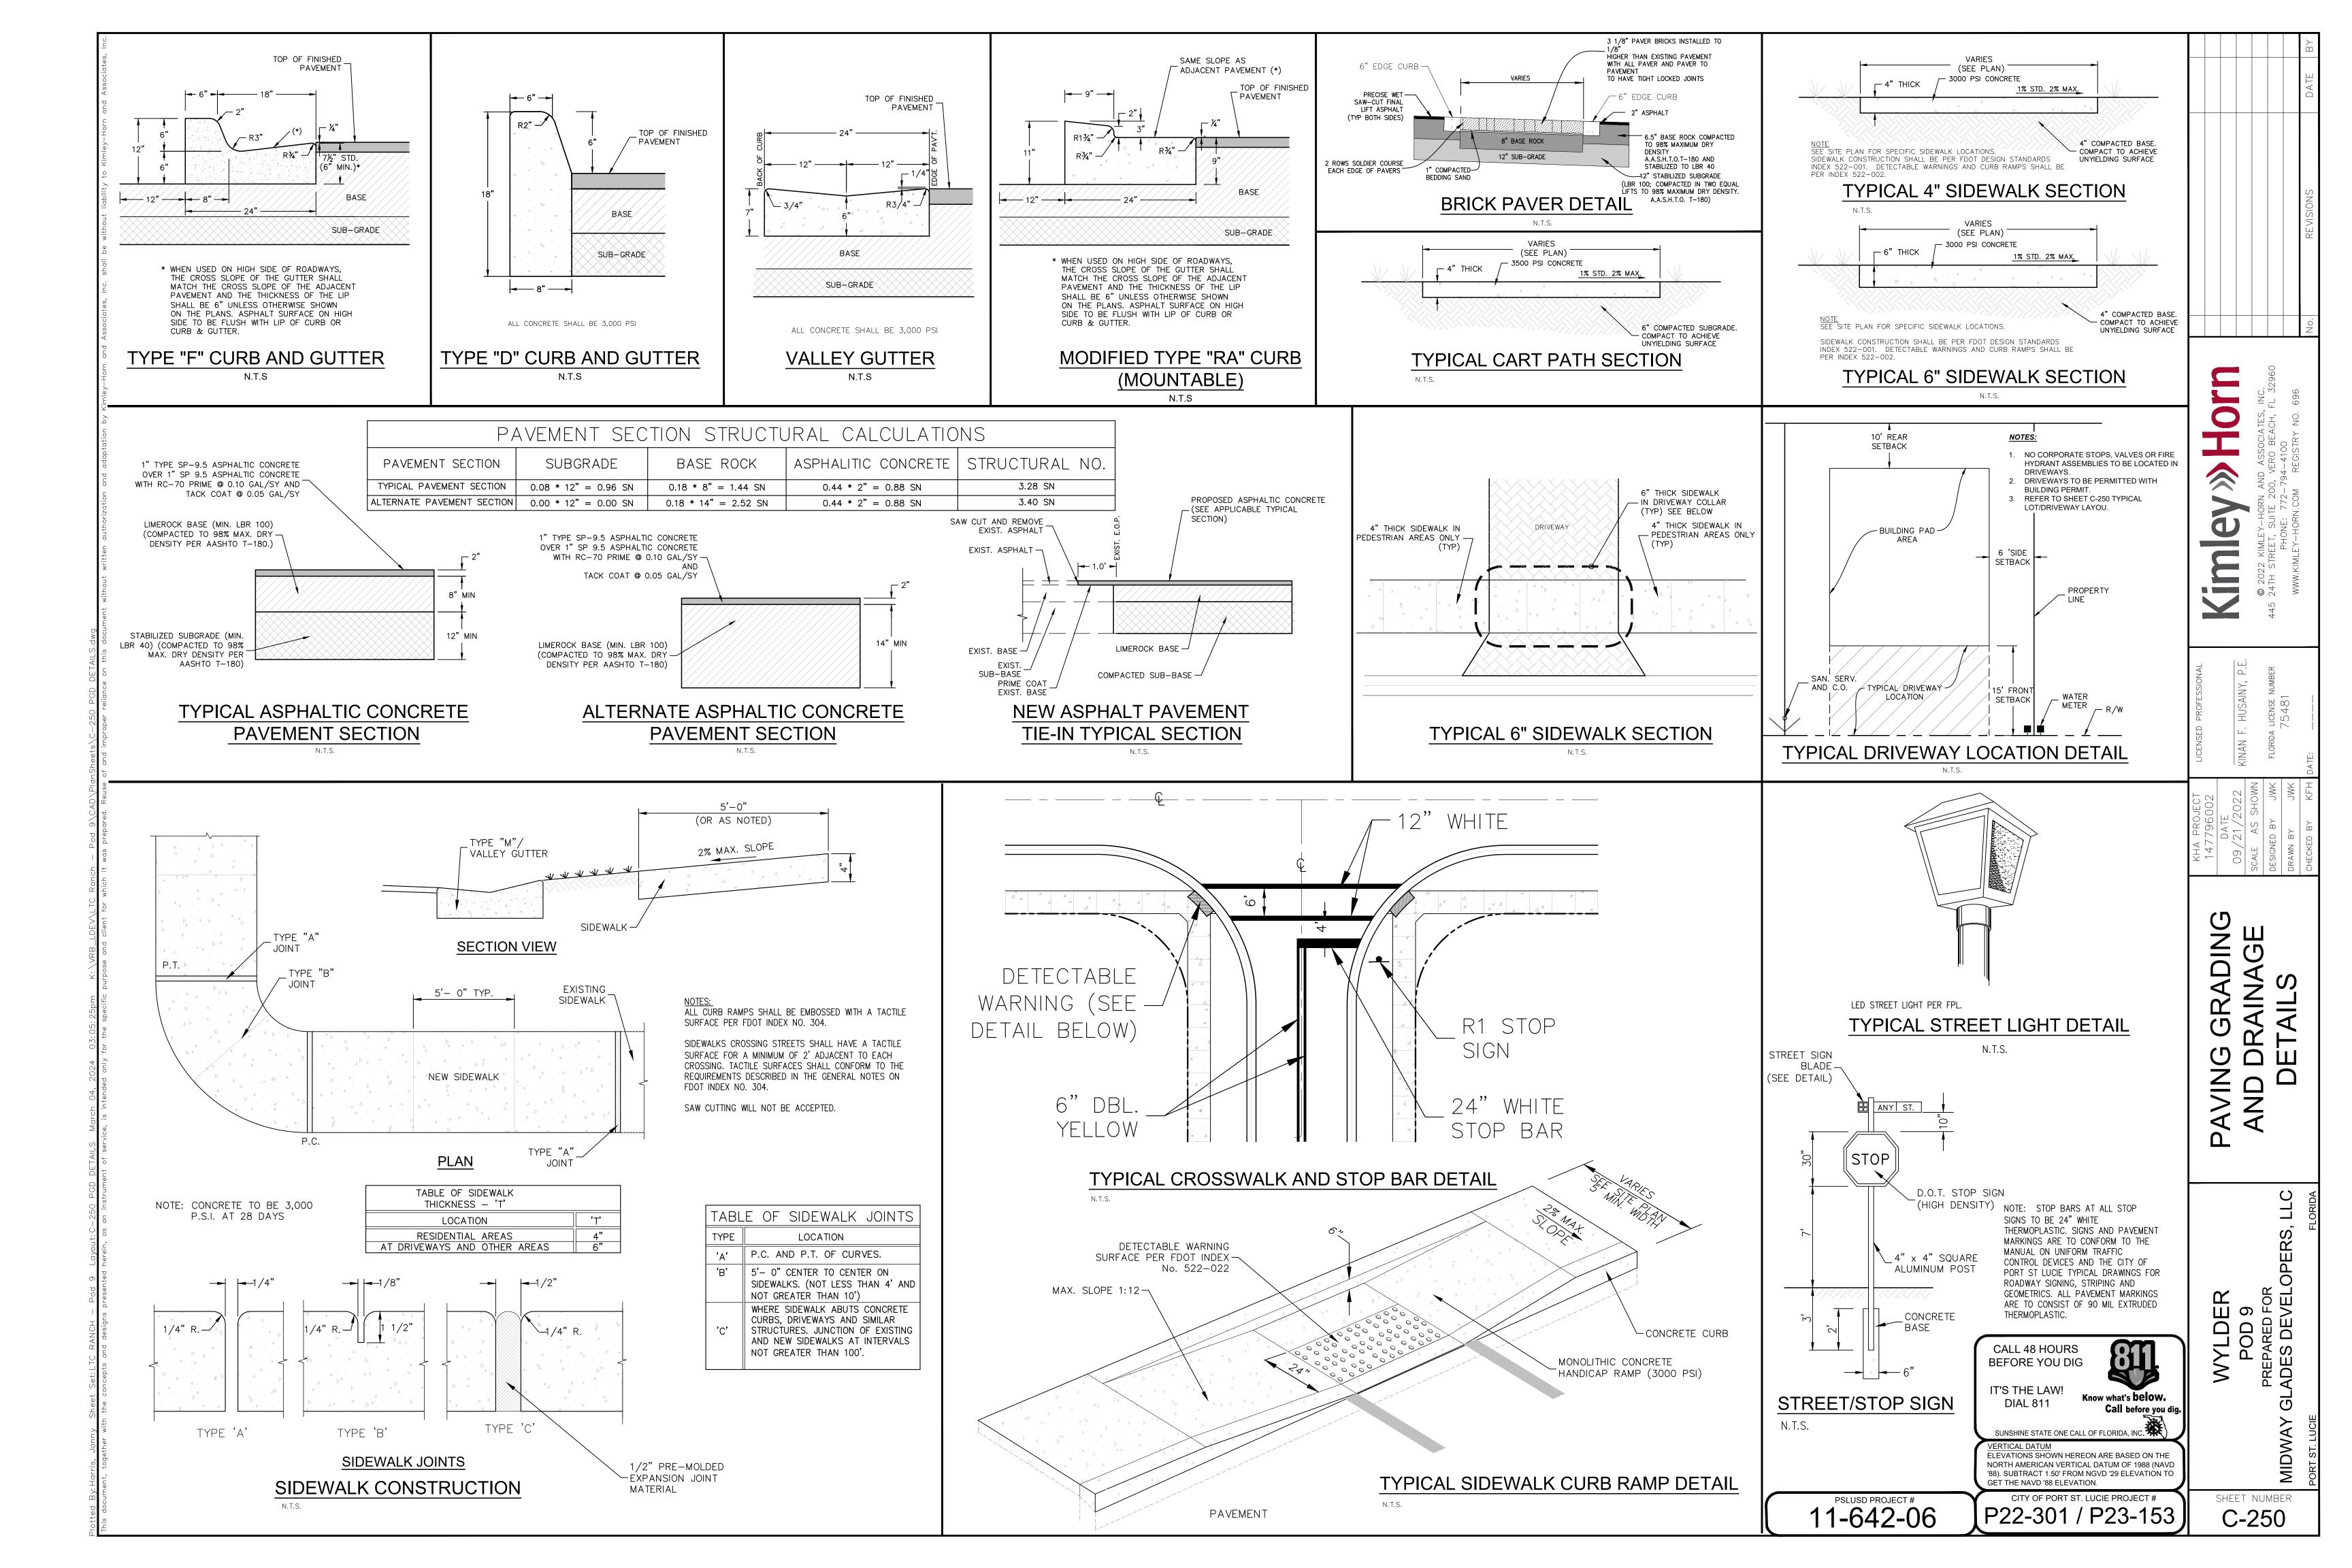

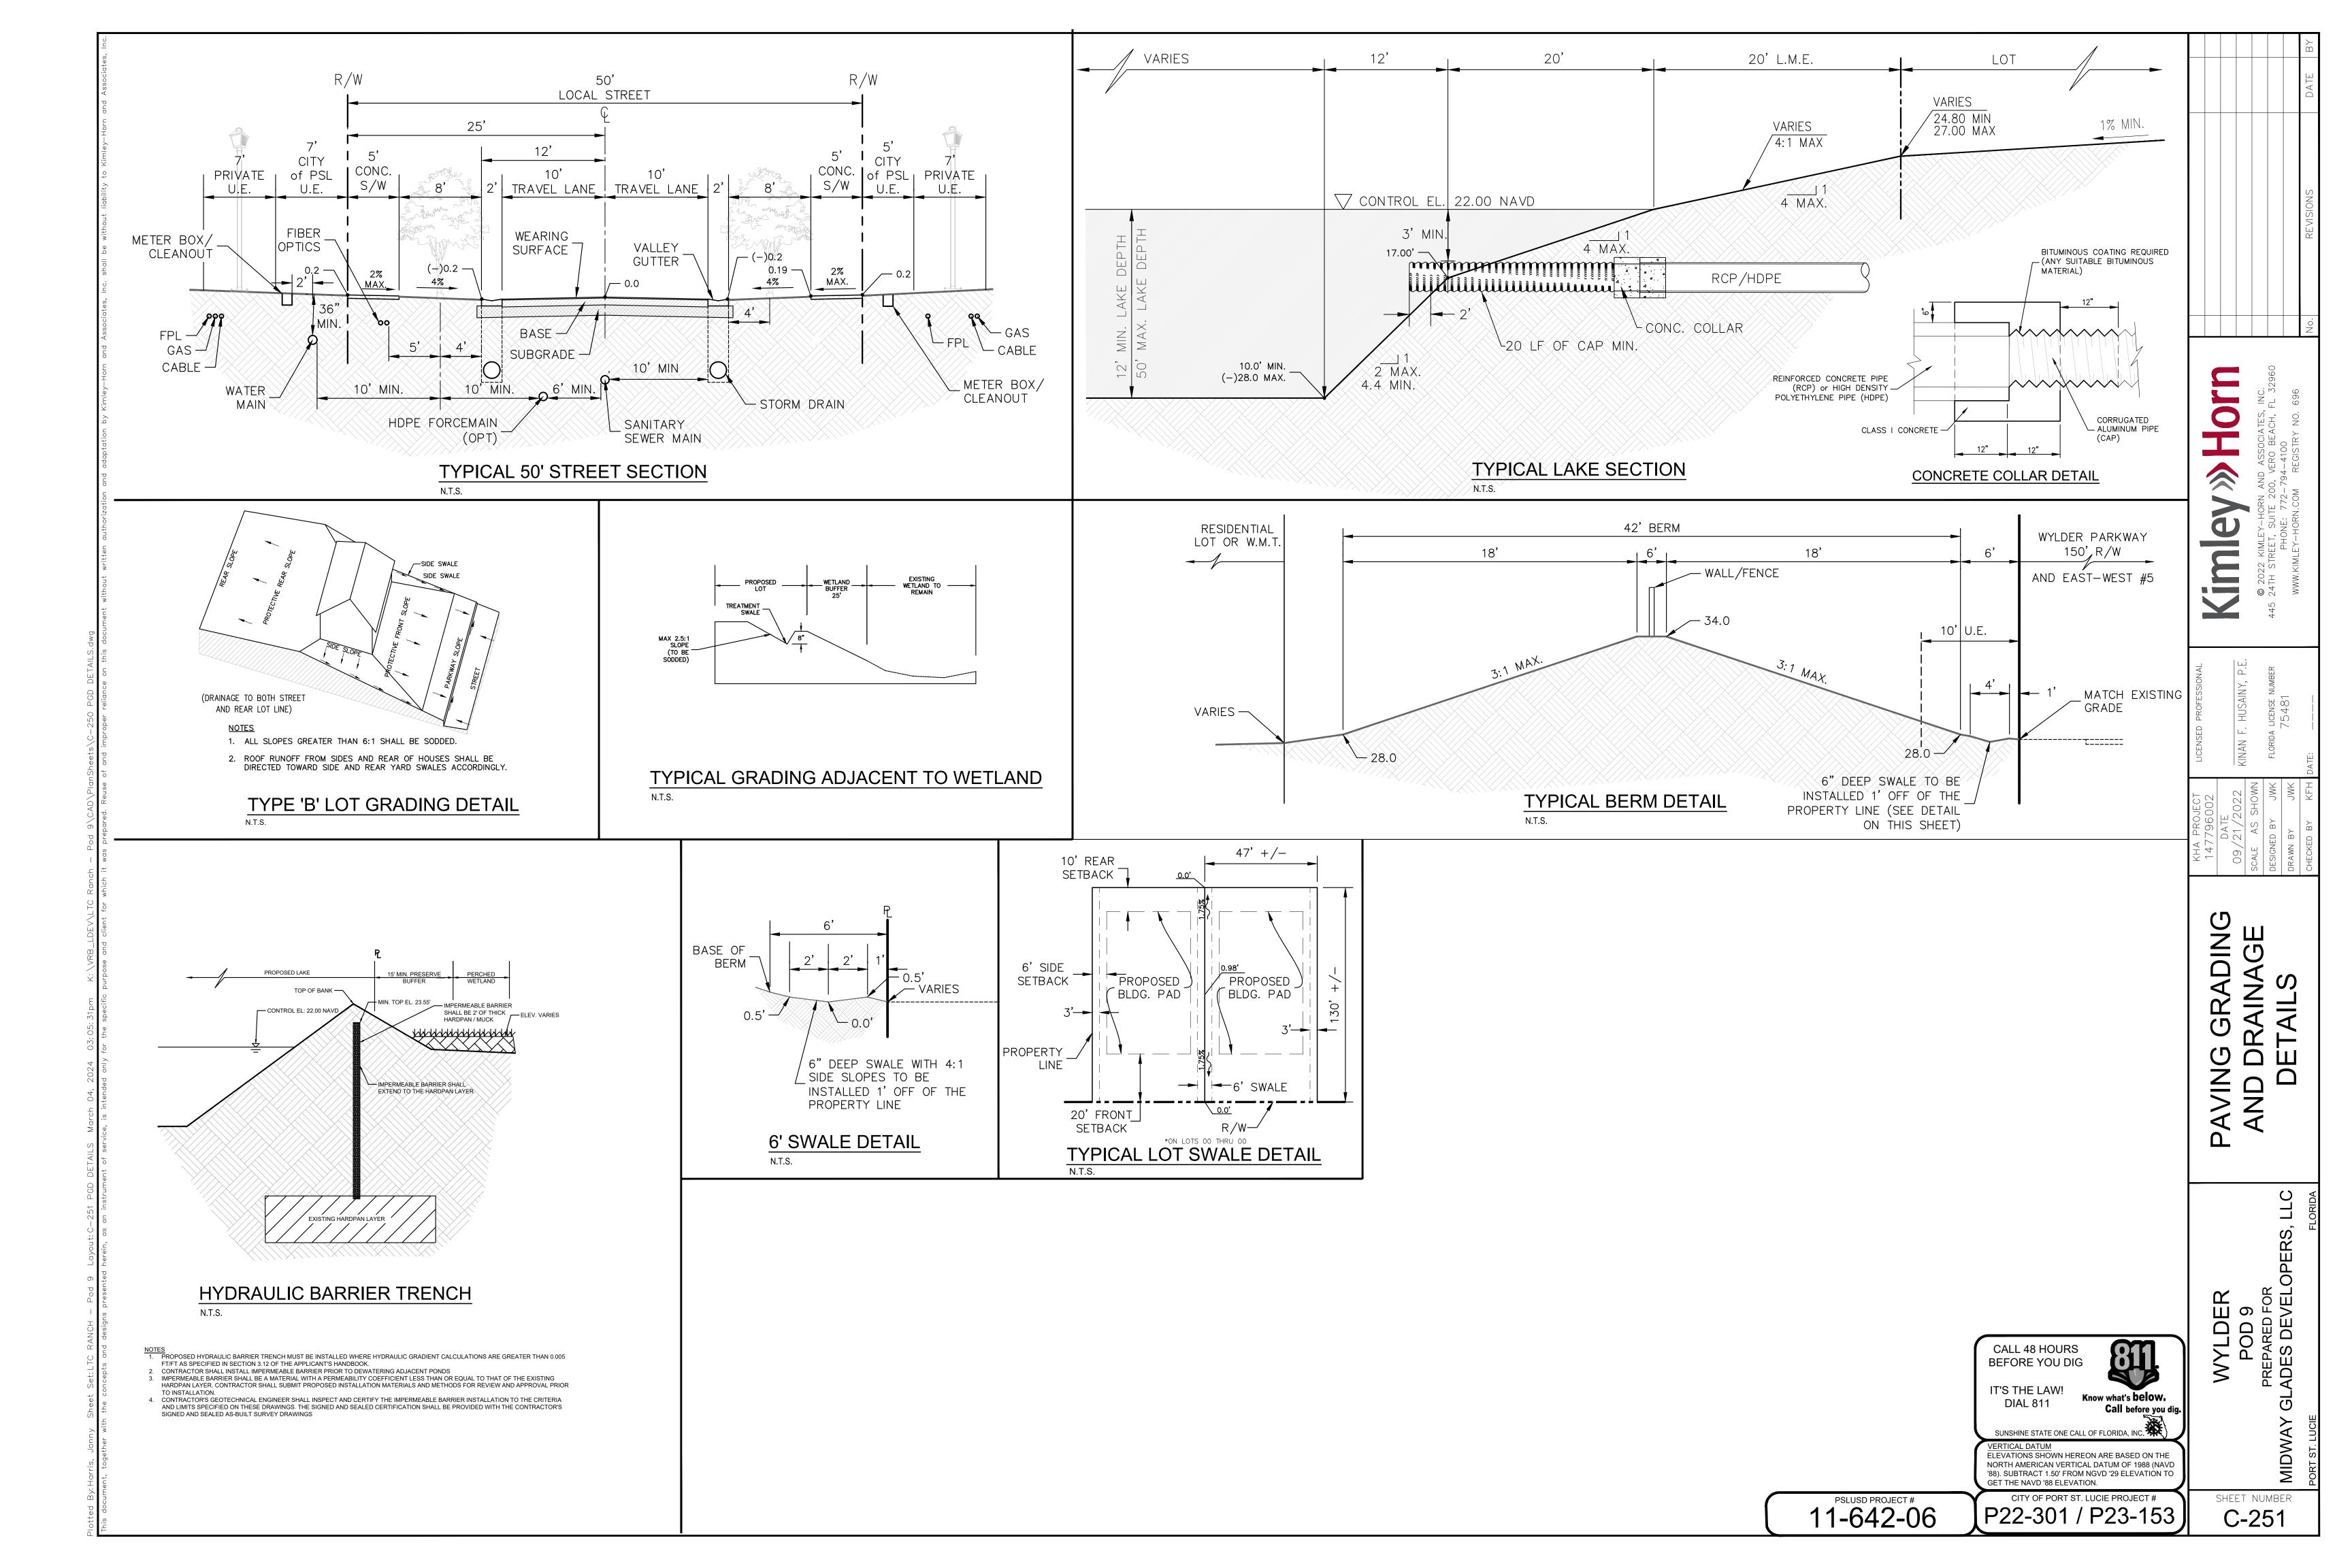

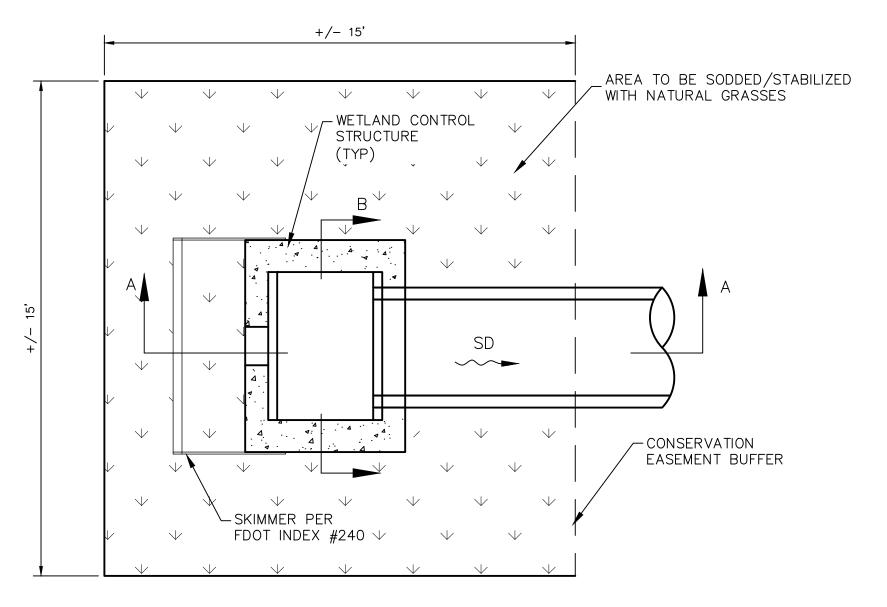

TYPICAL WETLAND CONTROL STRUCTURE PLANTING DETAIL

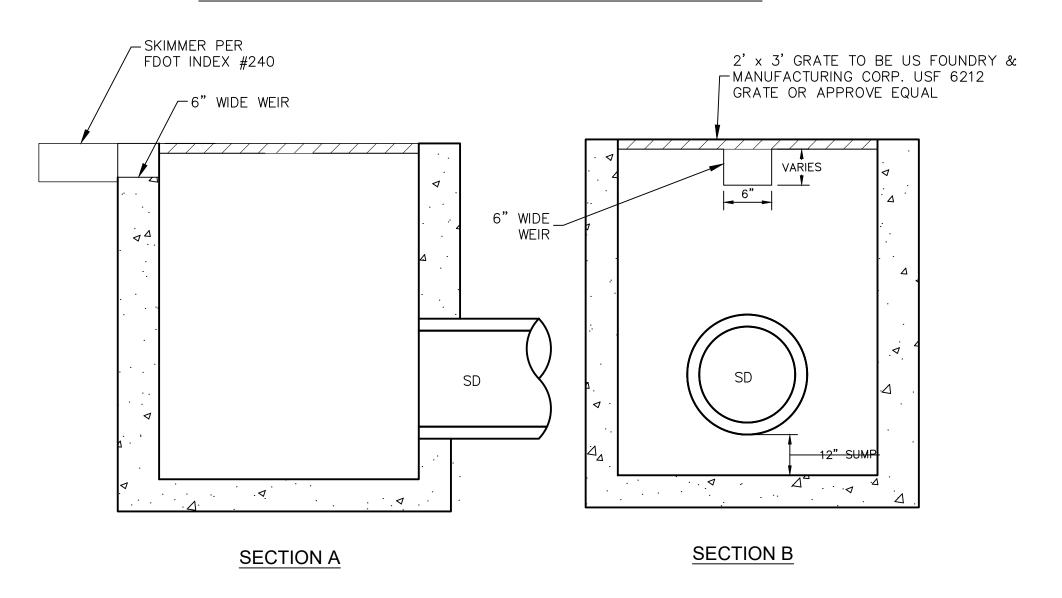

TYPICAL WETLAND CONTROL STRUCTURE DETAIL

STRUCTURE NO.	GRATE ELEVATION	WEIR ELEVATION	PIPE SIZE
WCS-03	22.95	22.45	36"
WCS-04	22.80	22.30	18"
WCS-05	24.05	23.55	18"
WCS-07	23.35	22.85	18"
WCS-08	23.00	22.50	36"
WCS-10	22.71	22.00	18"
WCS-12	22.71	22.00	24"
WCS-13	22.71	22.00	24"

IT'S THE LAW! DIAL 811 SUNSHINE STATE ONE CALL OF FLORIDA, IN VERTICAL DATUM
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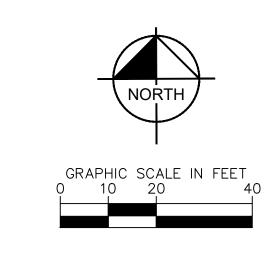
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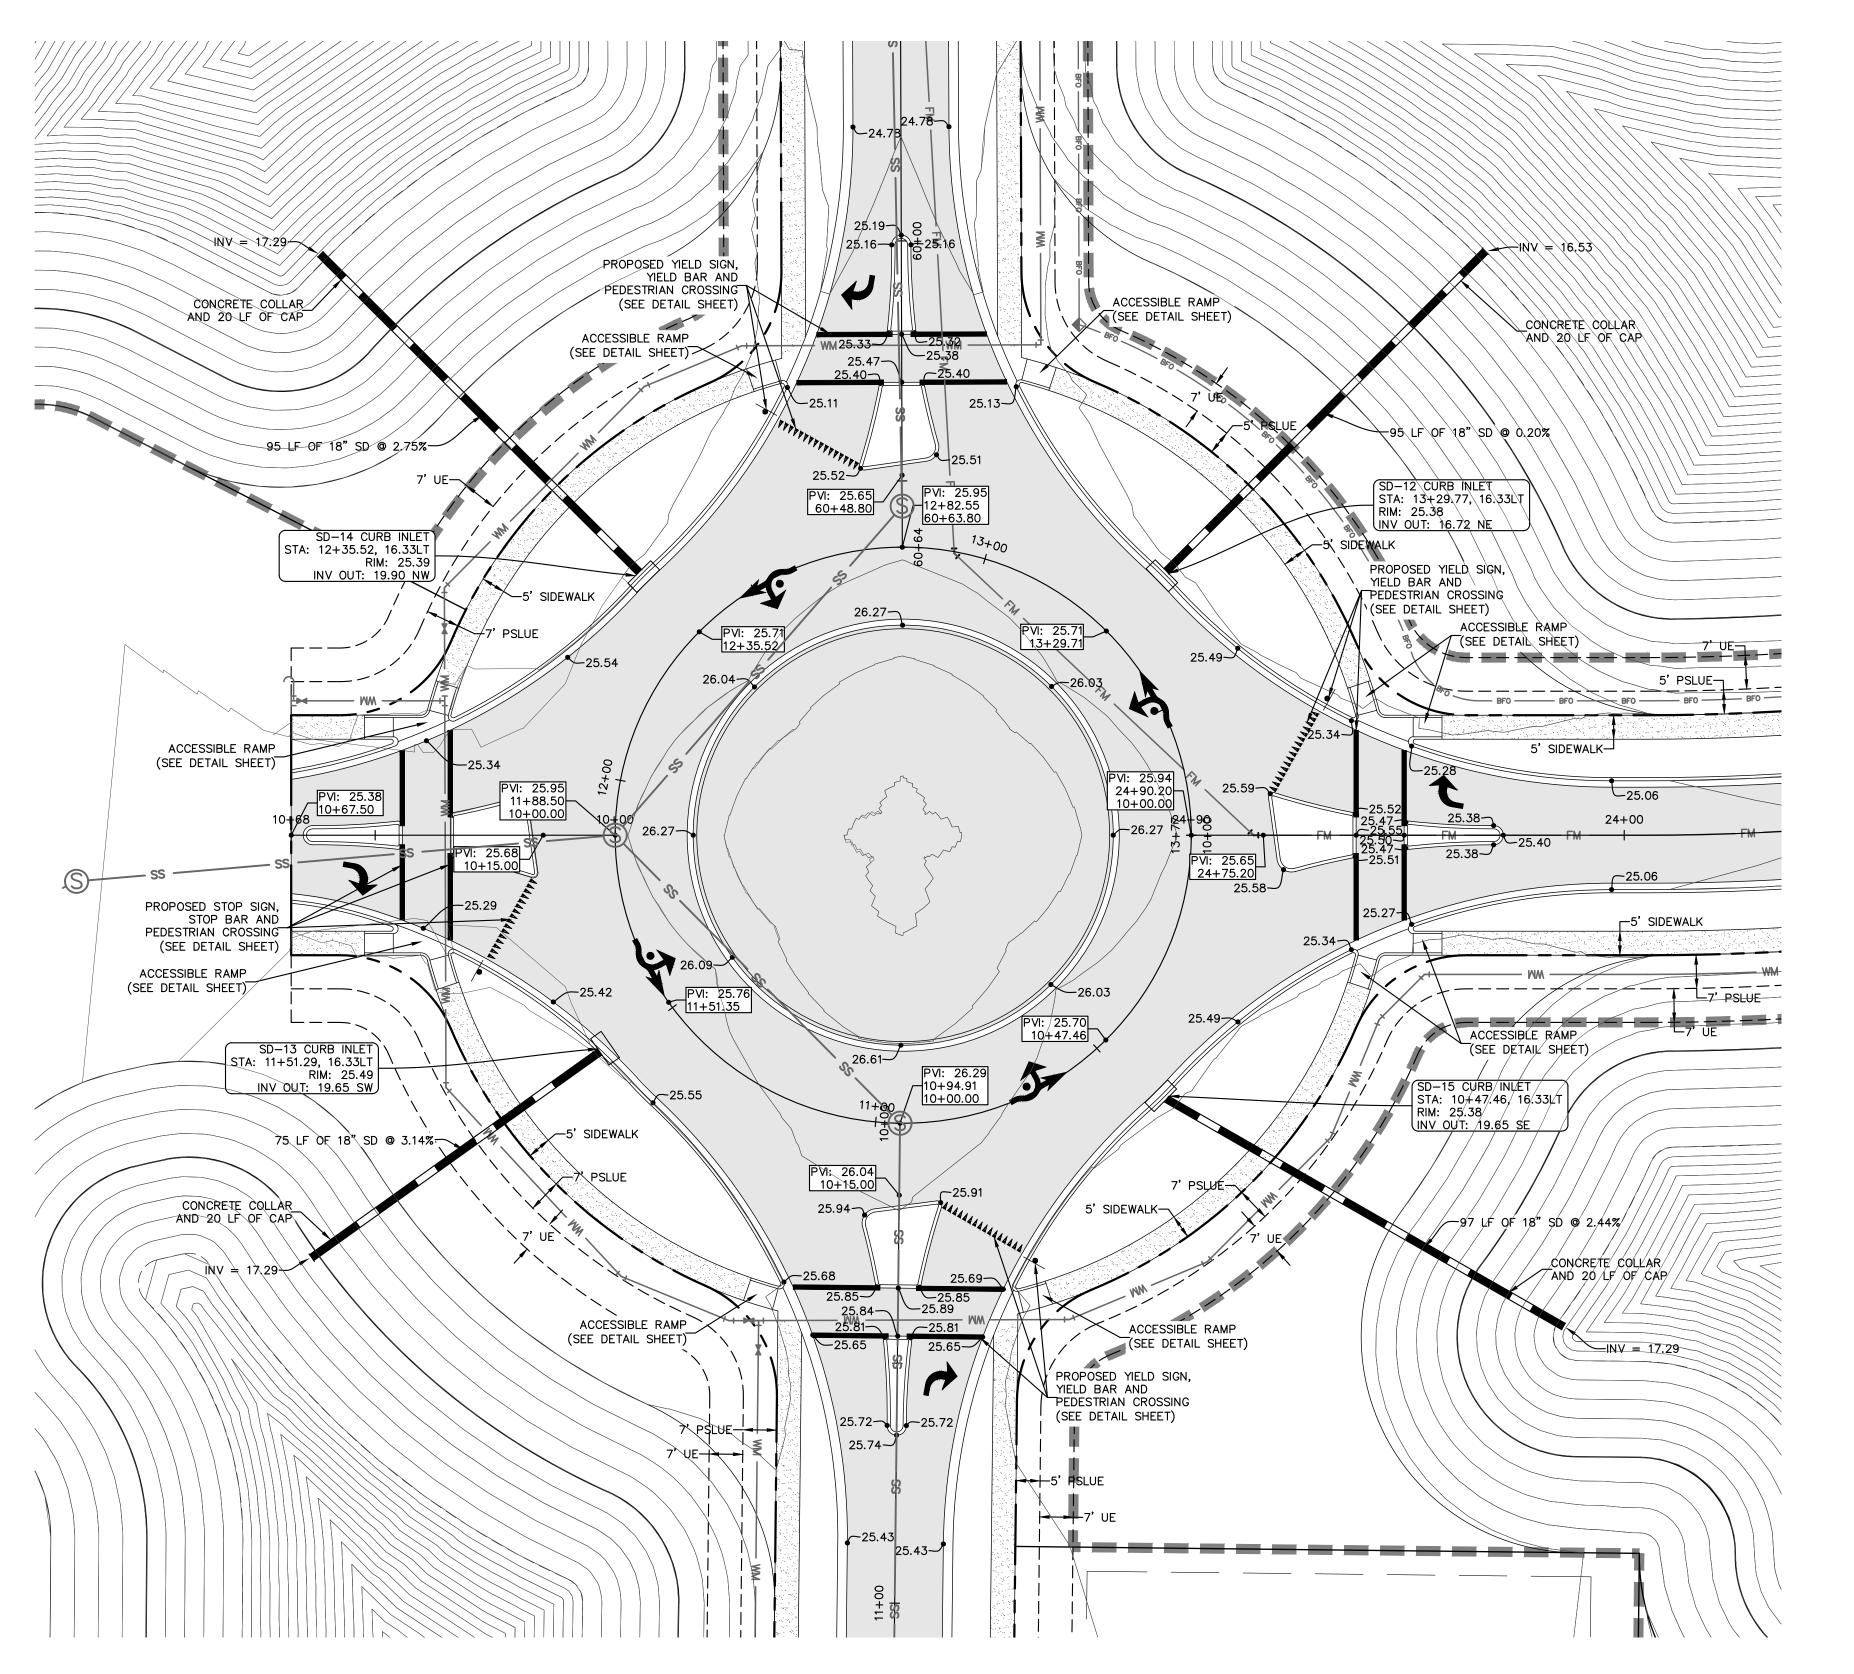
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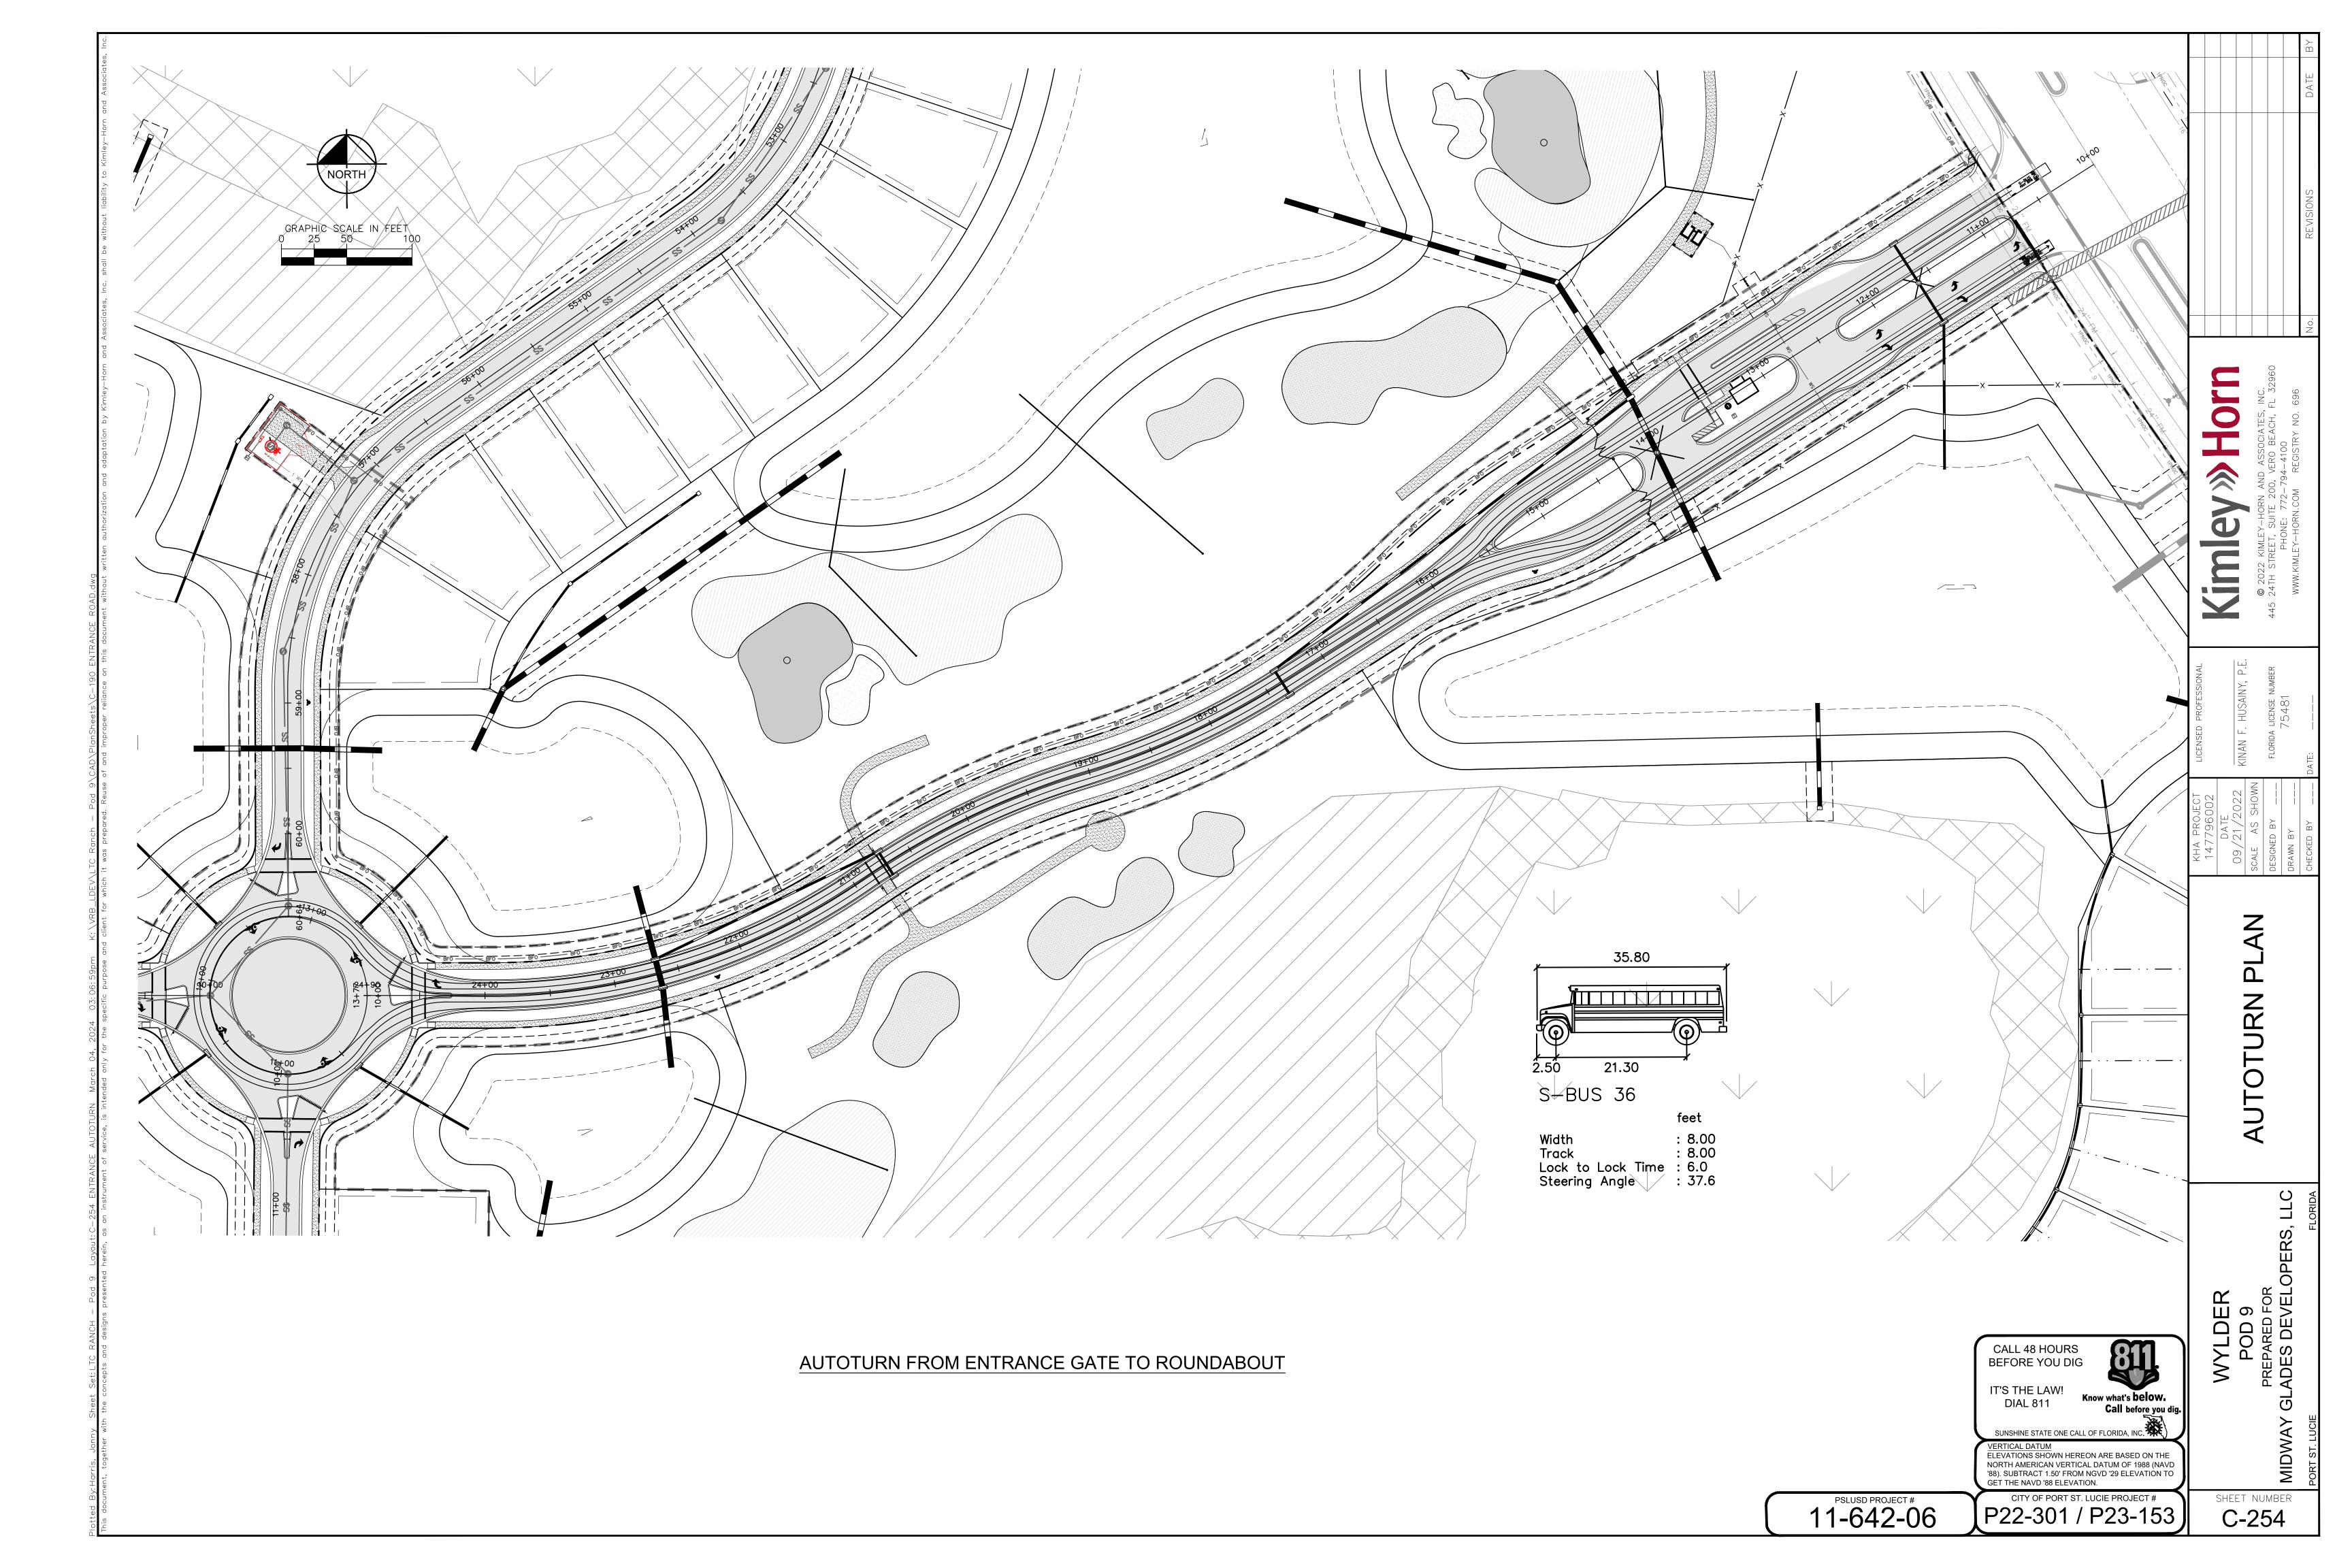
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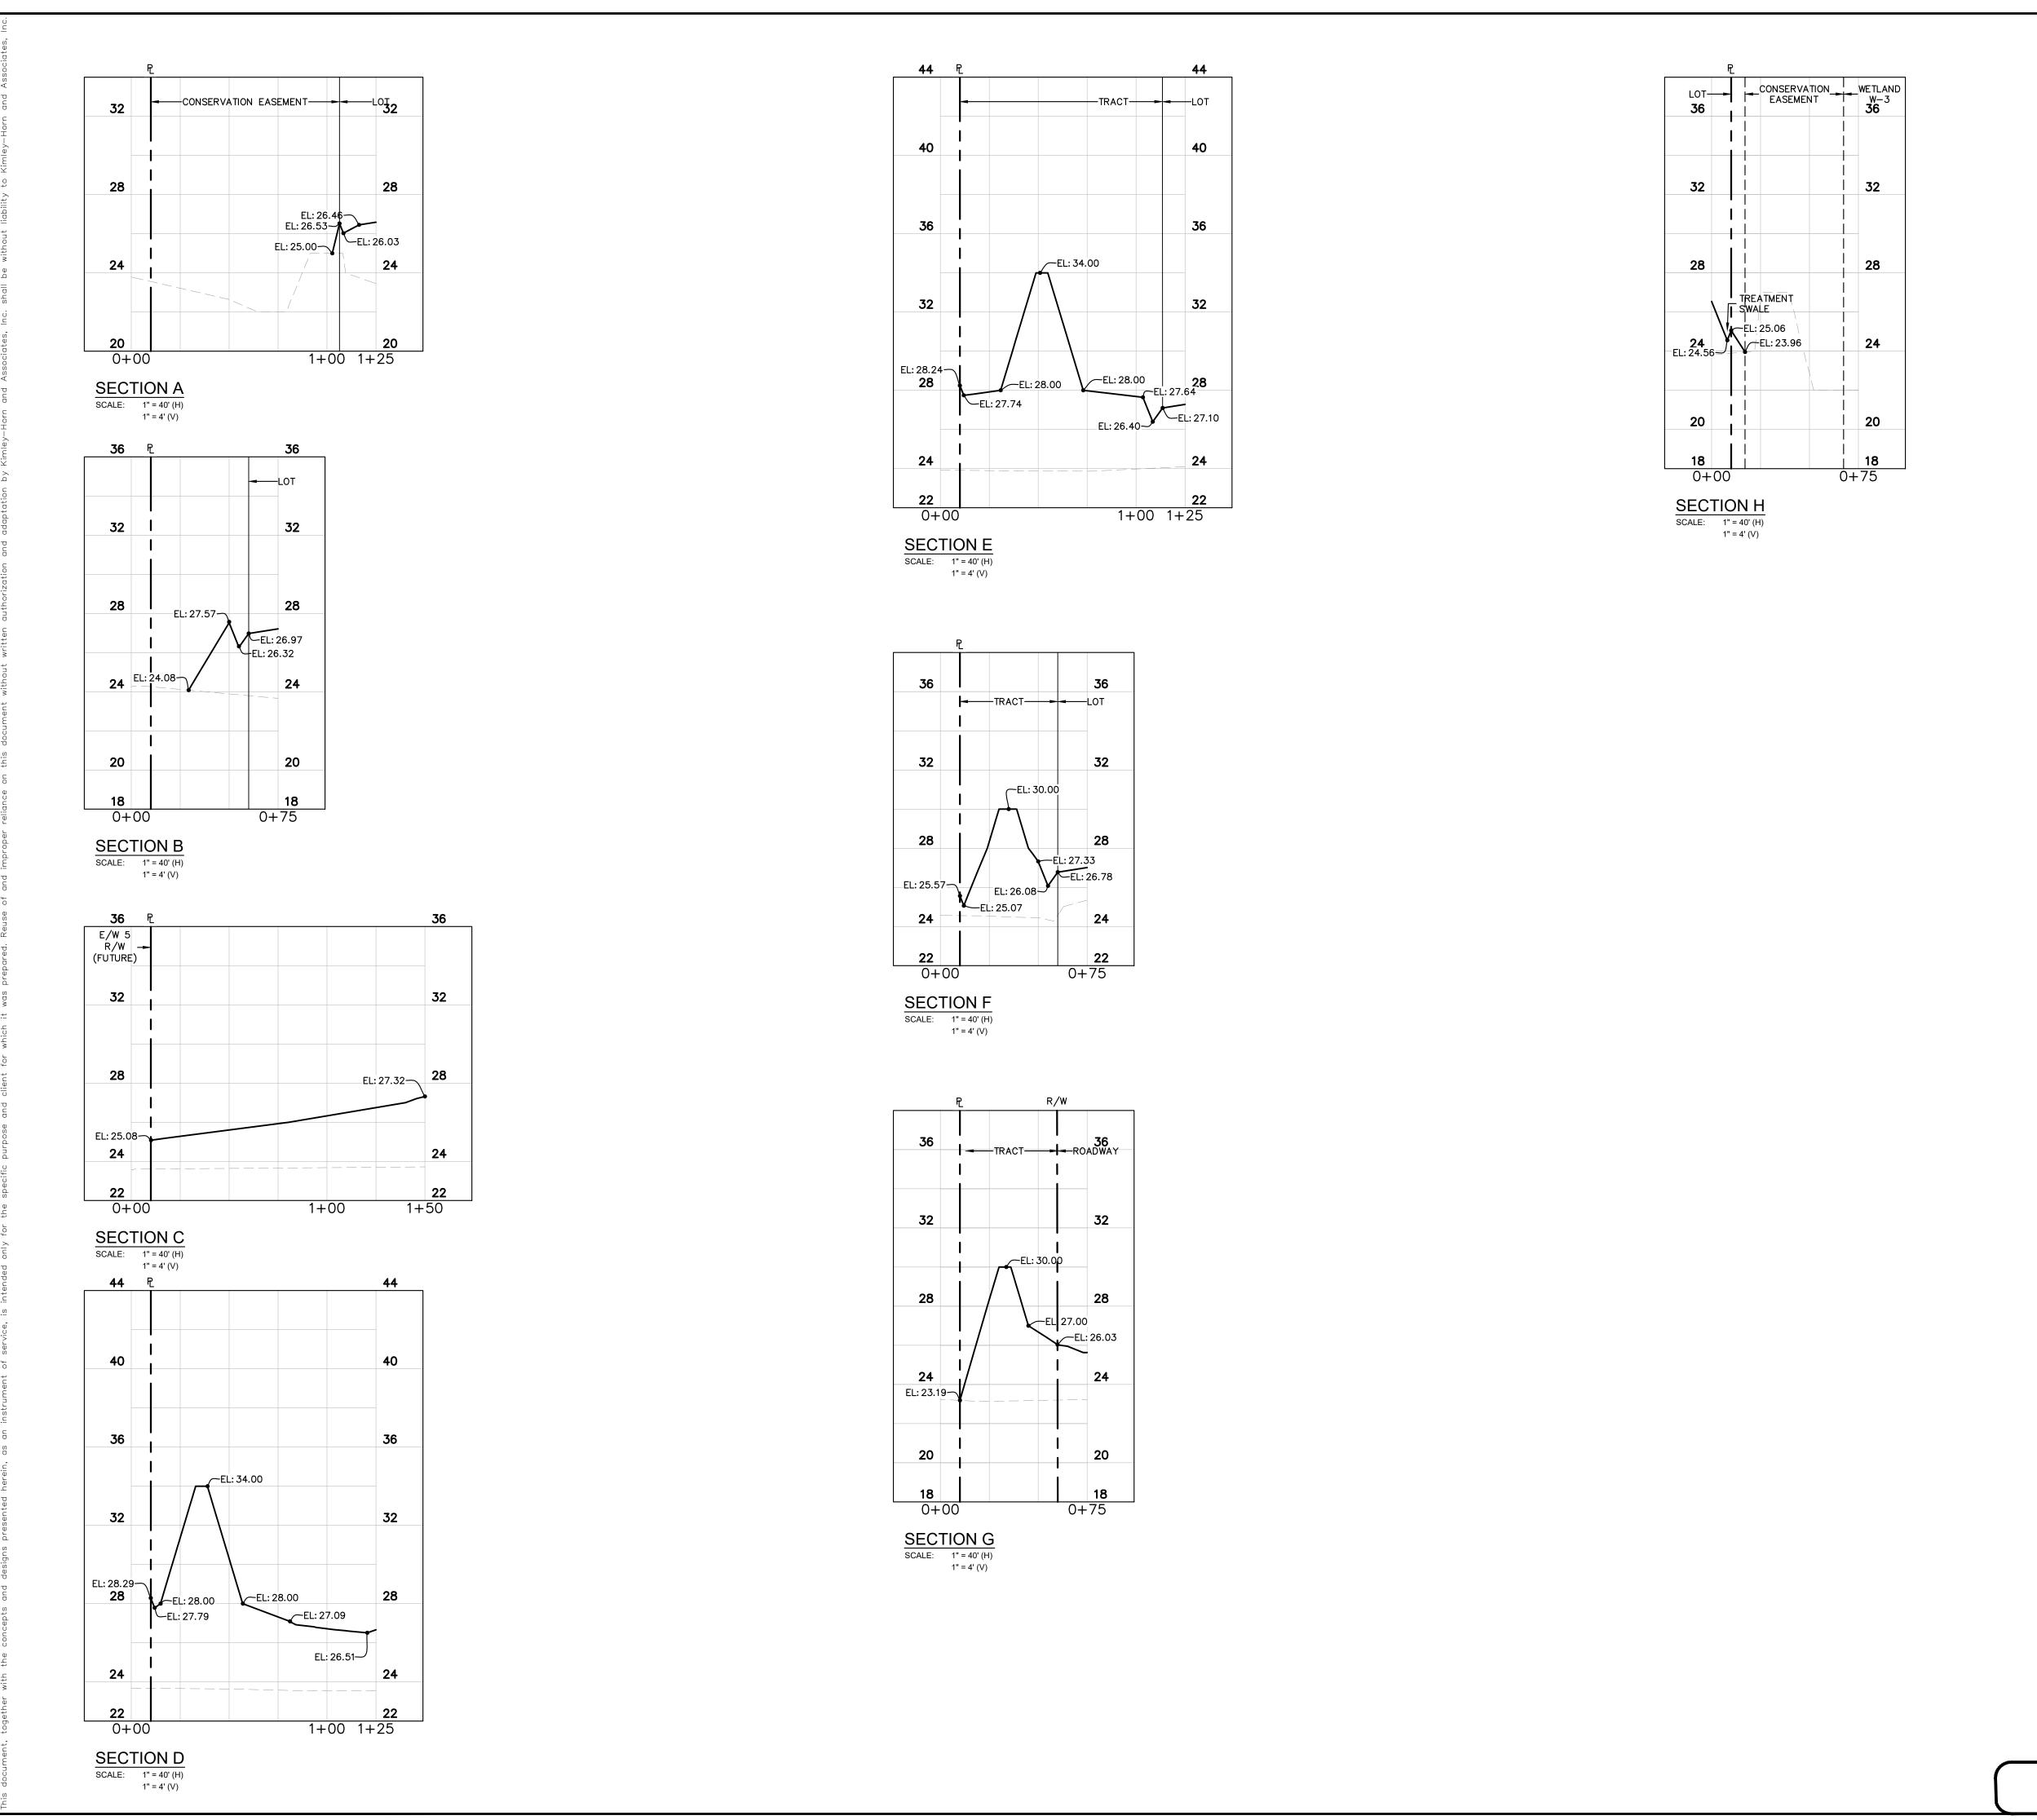
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SECTIONS **CROSS**

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LADES DEVELOPERS, L

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SHEET NUMBER C-260

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NORTH AMERICAN VERTICAL DATUM OF 1988 (NAVD
'88). SUBTRACT 1.50' FROM NGVD '29 ELEVATION TO
GET THE NAVD '88 ELEVATION. PSLUSD PROJECT # 11-642-06 CITY OF PORT ST. LUCIE PROJECT # P22-301 / P23-153


CALL 48 HOURS BEFORE YOU DIG


SUNSHINE STATE ONE CALL OF FLORIDA, INC.


Know what's **below.**

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----- WS ------ PROPOSED WATER SERVICE

- PROPOSED IRRIGATION MAIN PROPOSED GATE VALVE

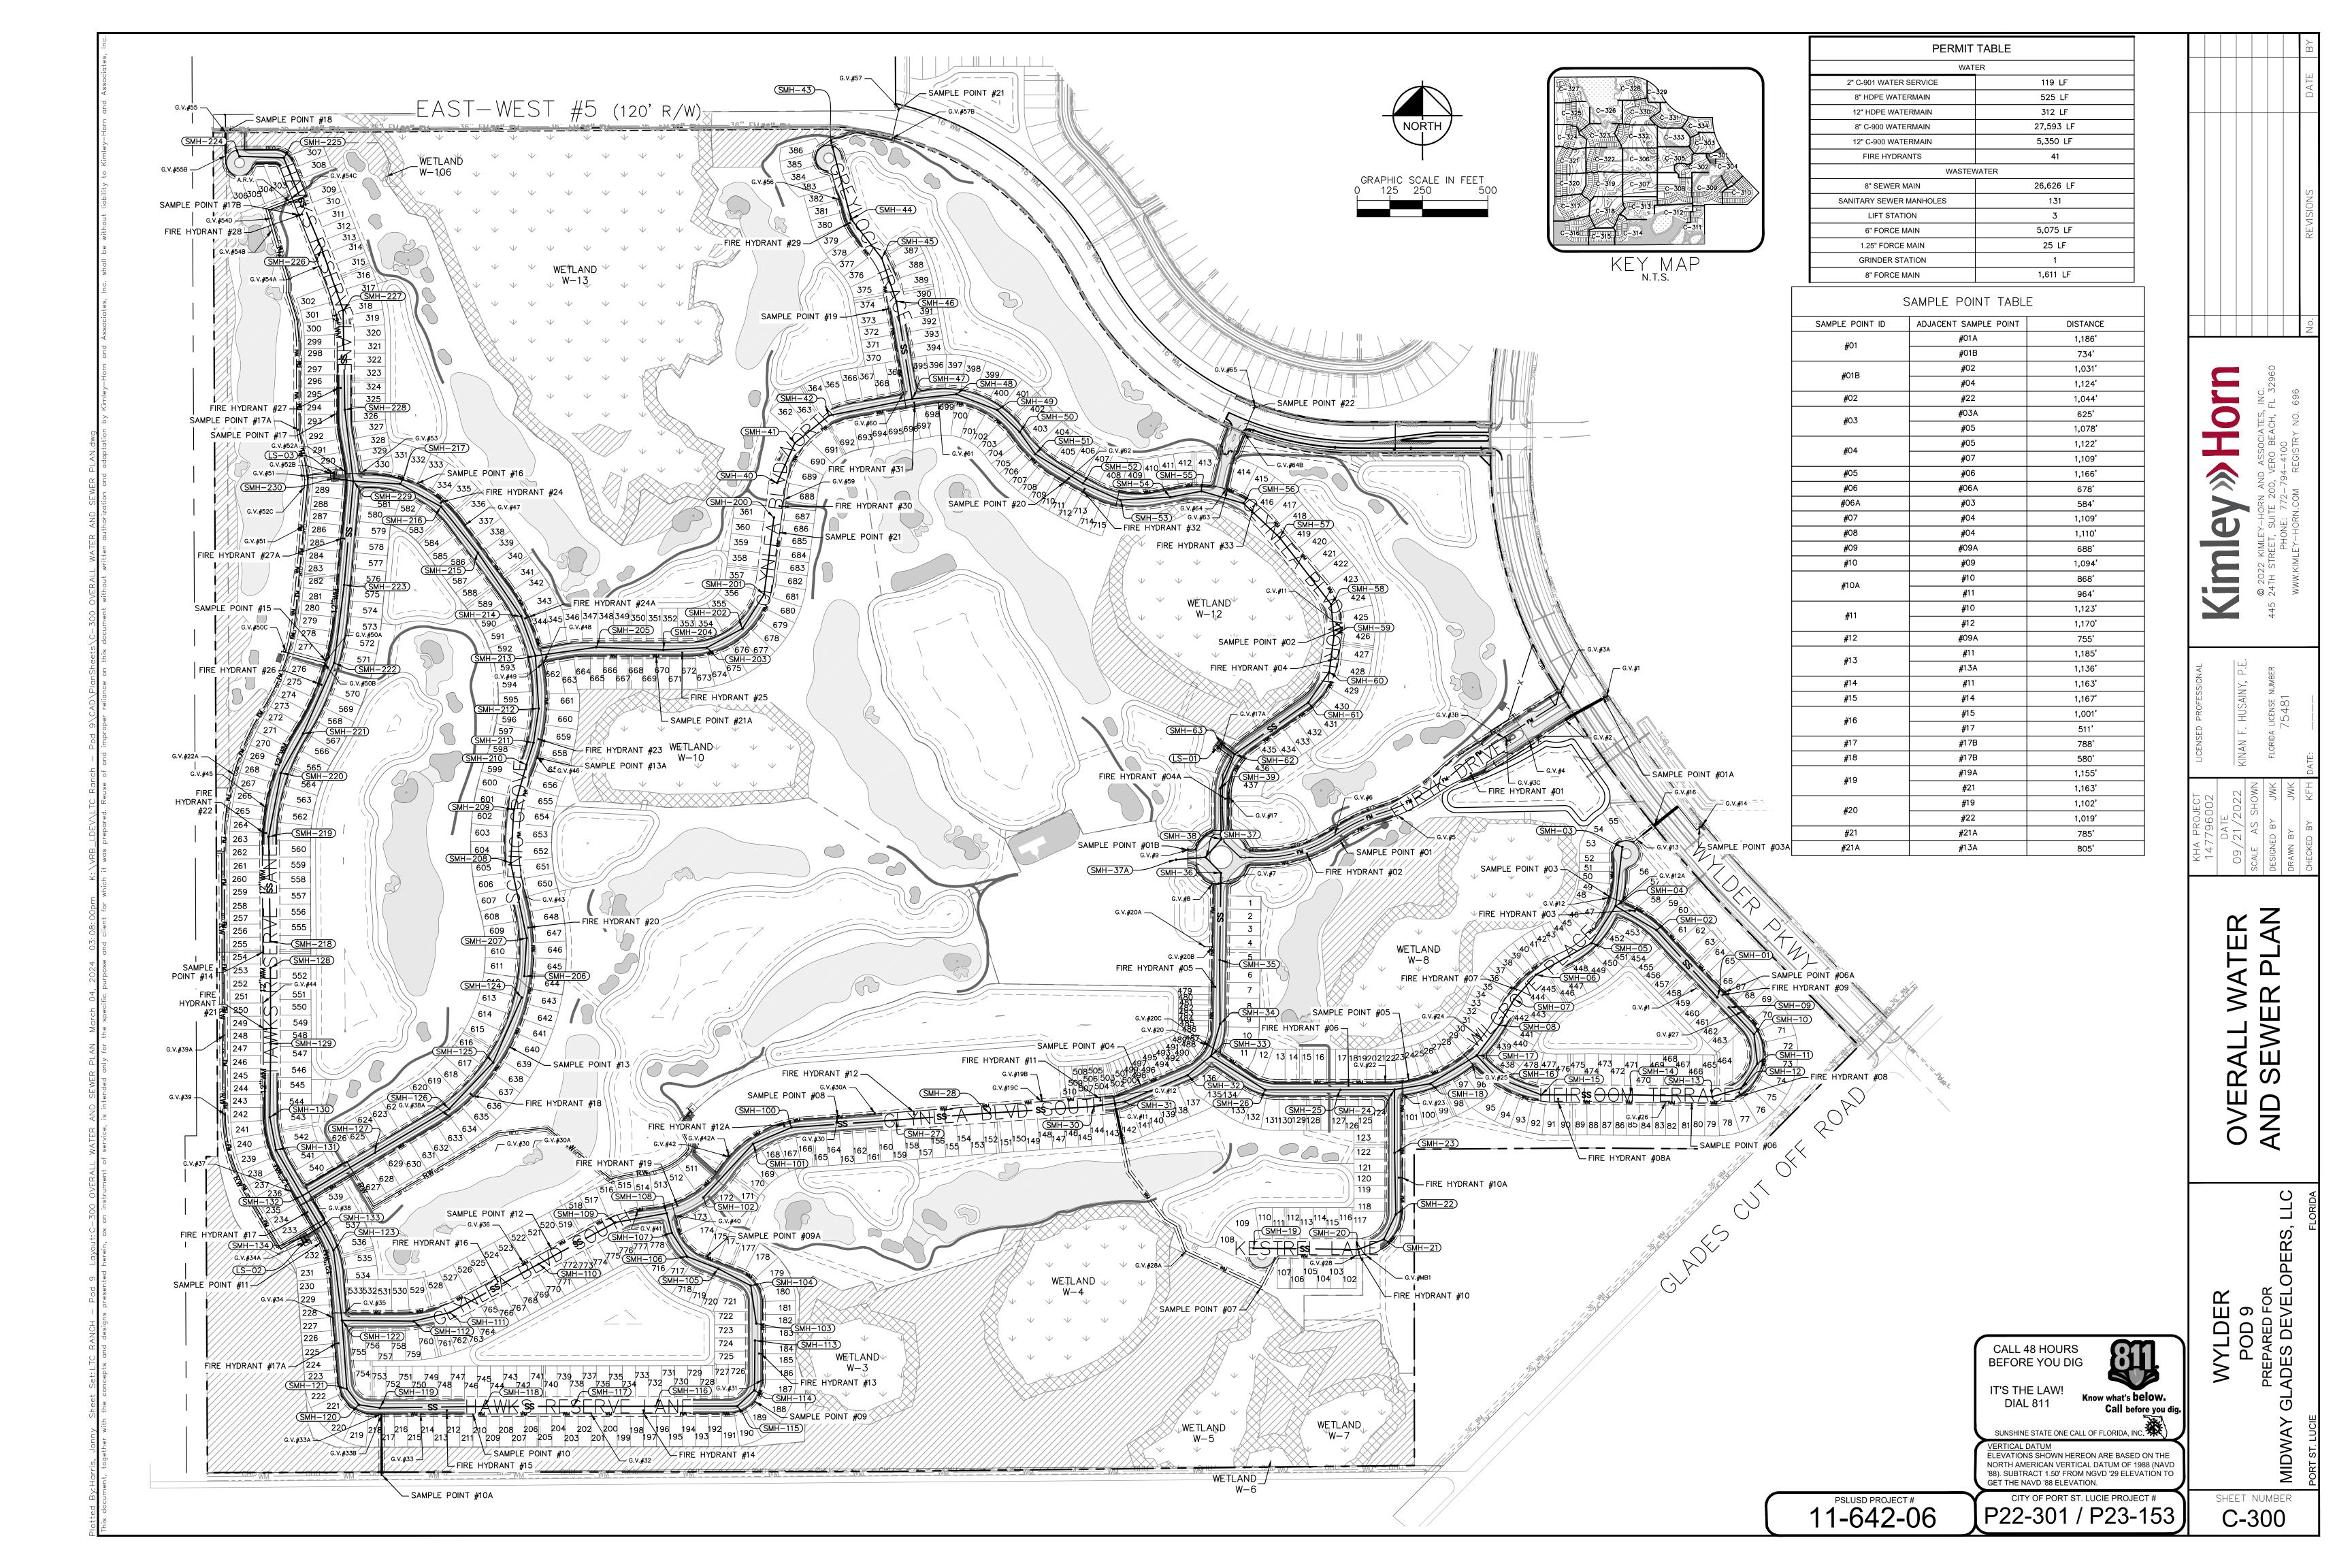PROPOSED FIRE HYDRANT

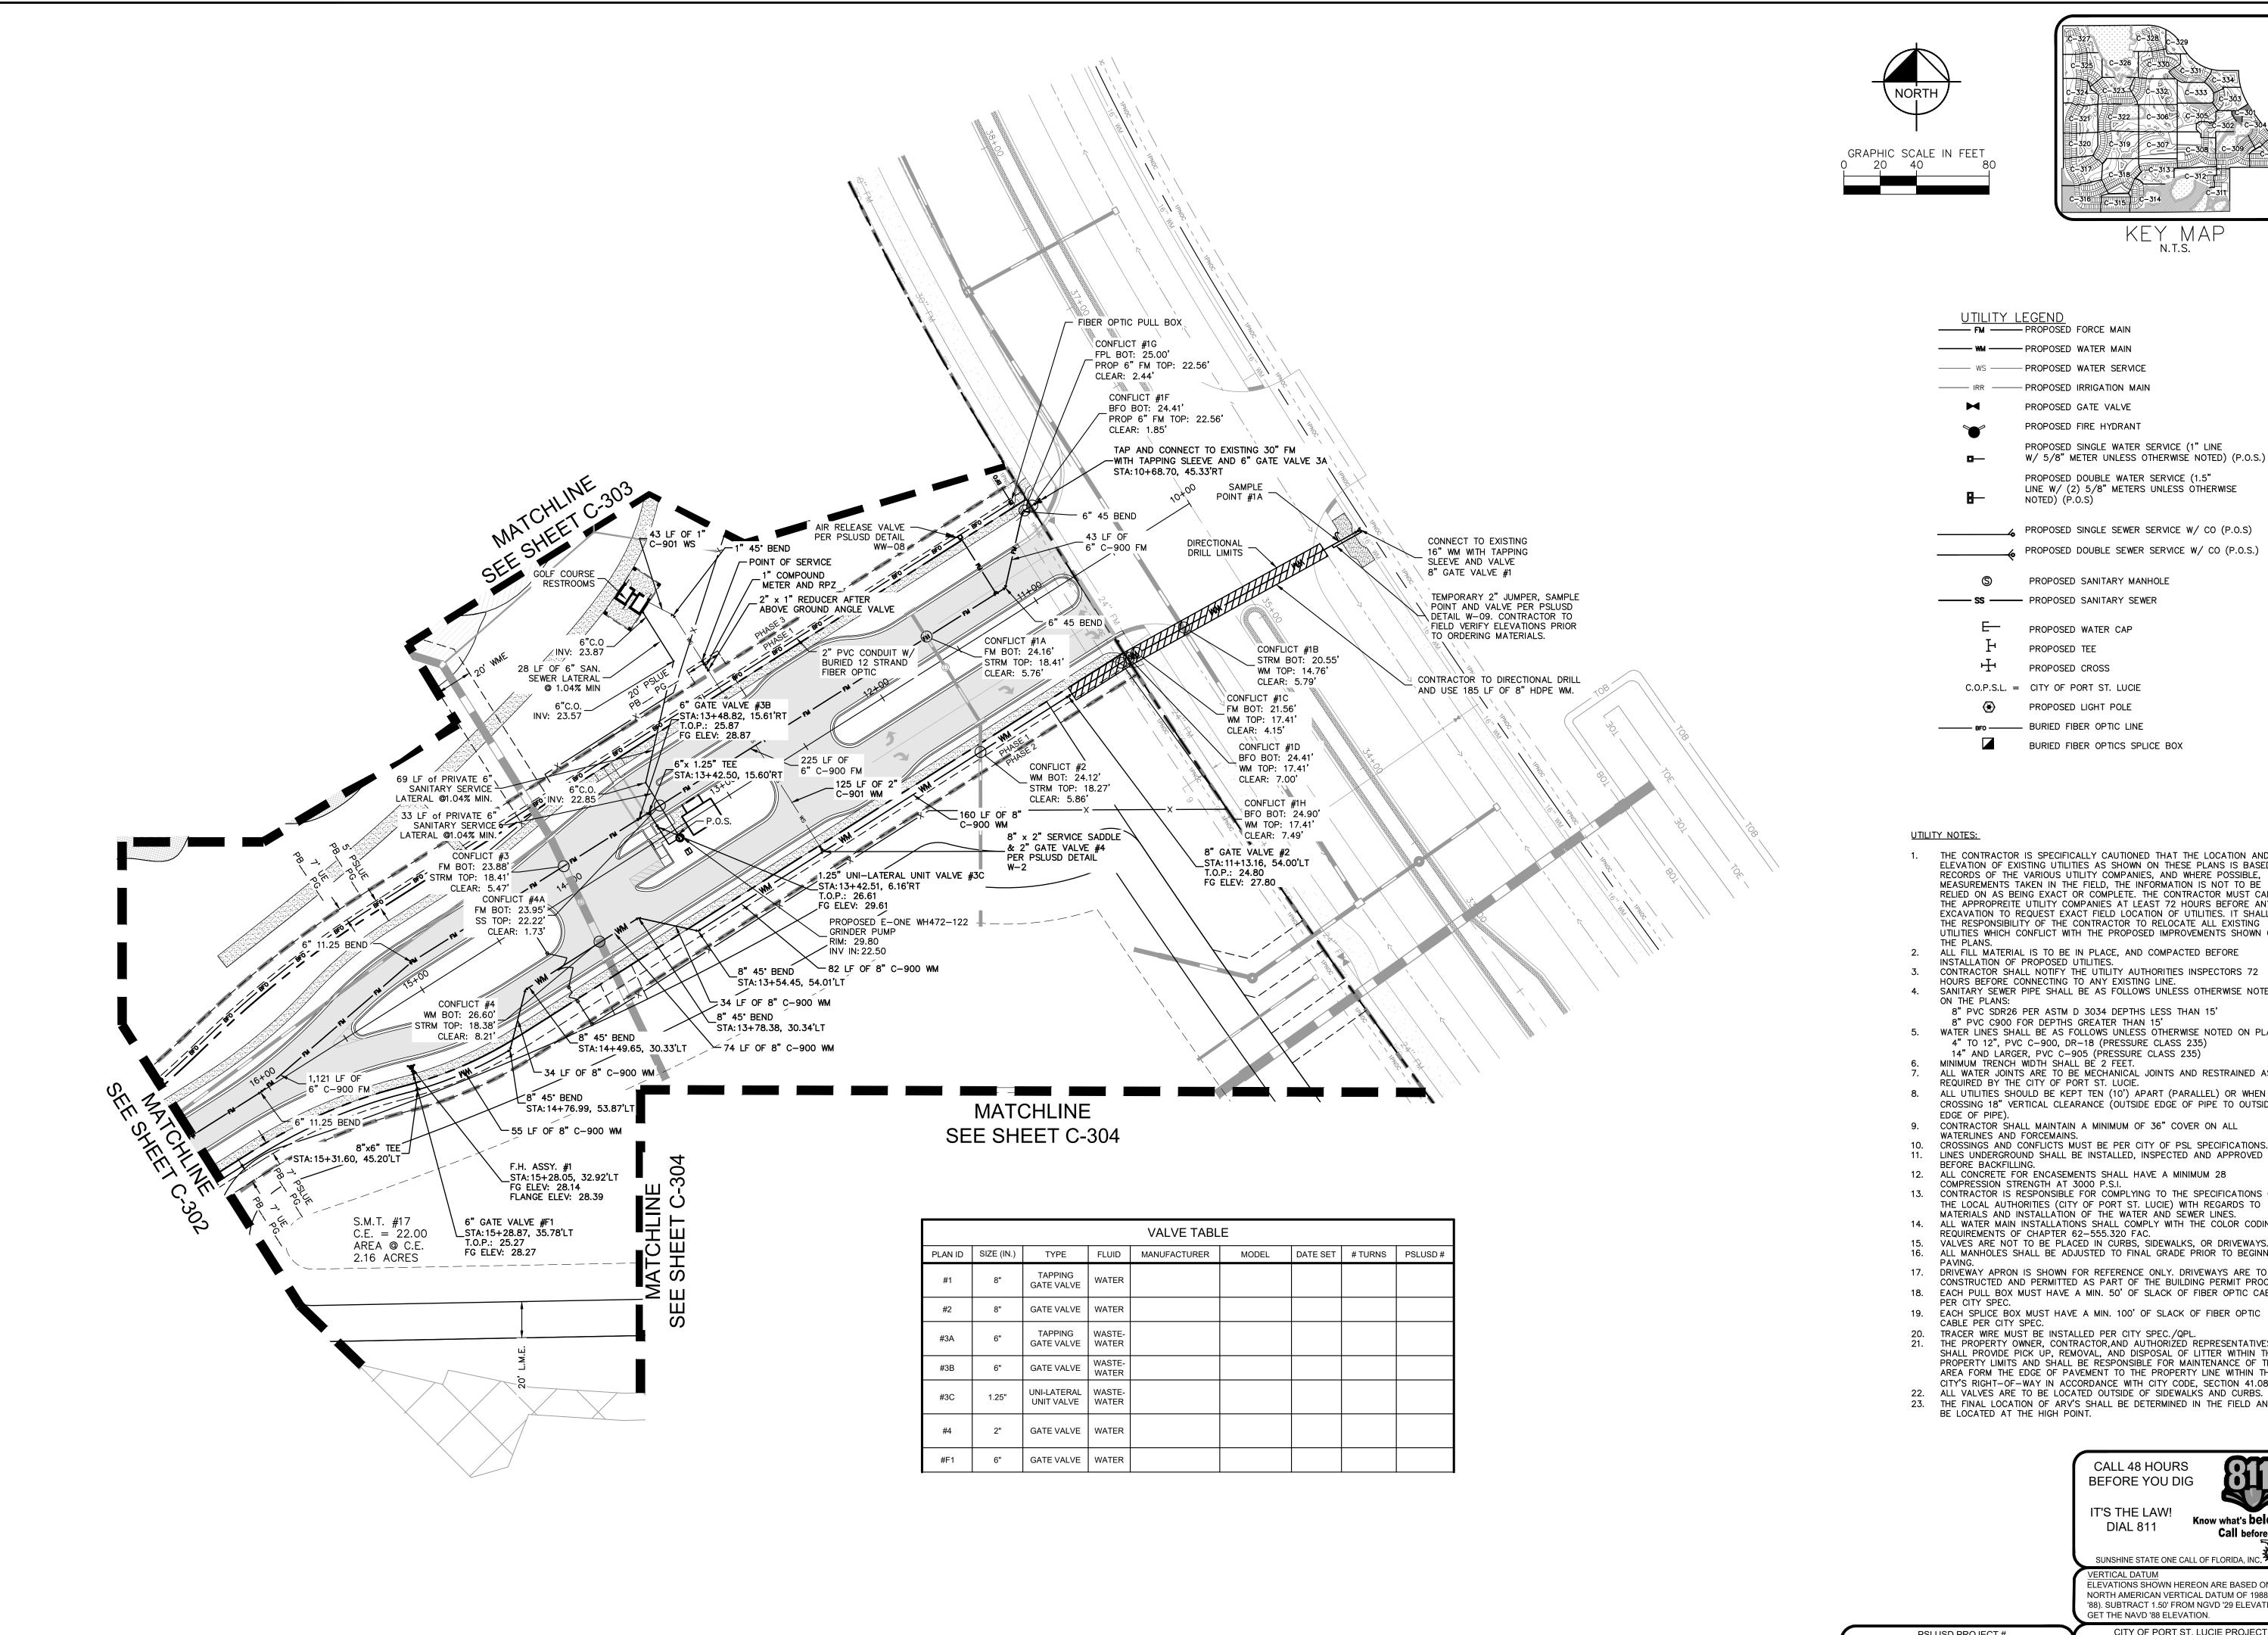PROPOSED SINGLE WATER SERVICE (1" LINE W/ 5/8" METER UNLESS OTHERWISE NOTED) (P.O.S.)

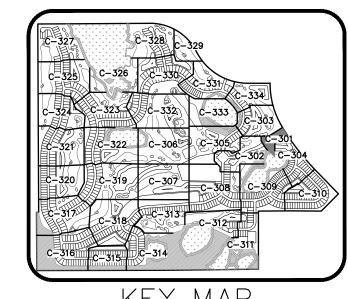PROPOSED DOUBLE WATER SERVICE (1.5" LINE W/ (2) 5/8" METERS UNLESS OTHERWISE NOTED) (P.O.S)

PROPOSED SINGLE SEWER SERVICE W/ CO (P.O.S) PROPOSED DOUBLE SEWER SERVICE W/ CO (P.O.S.)

PROPOSED SANITARY MANHOLE

PROPOSED WATER CAP

PROPOSED TEE

PROPOSED CROSS

C.O.P.S.L. = CITY OF PORT ST. LUCIE

PROPOSED LIGHT POLE

BURIED FIBER OPTIC LINE

BURIED FIBER OPTICS SPLICE BOX

- THE CONTRACTOR IS SPECIFICALLY CAUTIONED THAT THE LOCATION AND/OR ELEVATION OF EXISTING UTILITIES AS SHOWN ON THESE PLANS IS BASED ON RECORDS OF THE VARIOUS UTILITY COMPANIES. AND WHERE POSSIBLE MEASUREMENTS TAKEN IN THE FIELD, THE INFORMATION IS NOT TO BE RELIED ON AS BEING EXACT OR COMPLETE. THE CONTRACTOR MUST CALL THE APPROPREITE UTILITY COMPANIES AT LEAST 72 HOURS BEFORE ANY EXCAVATION TO REQUEST EXACT FIELD LOCATION OF UTILITIES. IT SHALL BE THE RESPONSIBILITY OF THE CONTRACTOR TO RELOCATE ALL EXISTING UTILITIES WHICH CONFLICT WITH THE PROPOSED IMPROVEMENTS SHOWN ON
- ALL FILL MATERIAL IS TO BE IN PLACE, AND COMPACTED BEFORE
- INSTALLATION OF PROPOSED UTILITIES. CONTRACTOR SHALL NOTIFY THE UTILITY AUTHORITIES INSPECTORS 72
- HOURS BEFORE CONNECTING TO ANY EXISTING LINE.
 SANITARY SEWER PIPE SHALL BE AS FOLLOWS UNLESS OTHERWISE NOTED
- 8" PVC SDR26 PER ASTM D 3034 DEPTHS LESS THAN 15' 8" PVC C900 FOR DEPTHS GREATER THAN 15' WATER LINES SHALL BE AS FOLLOWS UNLESS OTHERWISE NOTED ON PLANS:
- 4" TO 12", PVC C-900, DR-18 (PRESSURE CLASS 235) 14" AND LARGER, PVC C-905 (PRESSURE CLASS 235) MINIMUM TRENCH WIDTH SHALL BE 2 FEET.
 ALL WATER JOINTS ARE TO BE MECHANICAL JOINTS AND RESTRAINED AS
- REQUIRED BY THE CITY OF PORT ST. LUCIE. ALL UTILITIES SHOULD BE KEPT TEN (10') APART (PARALLEL) OR WHEN CROSSING 18" VERTICAL CLEARANCE (OUTSIDE EDGE OF PIPE TO OUTSIDE
- CONTRACTOR SHALL MAINTAIN A MINIMUM OF 36" COVER ON ALL
- CROSSINGS AND CONFLICTS MUST BE PER CITY OF PSL SPECIFICATIONS. LINES UNDERGROUND SHALL BE INSTALLED, INSPECTED AND APPROVED
- ALL CONCRETE FOR ENCASEMENTS SHALL HAVE A MINIMUM 28
- COMPRESSION STRENGTH AT 3000 P.S.I. 13. CONTRACTOR IS RESPONSIBLE FOR COMPLYING TO THE SPECIFICATIONS OF
- 14. ALL WATER MAIN INSTALLATIONS SHALL COMPLY WITH THE COLOR CODING REQUIREMENTS OF CHAPTER 62-555.320 FAC.
- VALVES ARE NOT TO BE PLACED IN CURBS, SIDEWALKS, OR DRIVEWAYS. ALL MANHOLES SHALL BE ADJUSTED TO FINAL GRADE PRIOR TO BEGINNING
- 17. DRIVEWAY APRON IS SHOWN FOR REFERENCE ONLY. DRIVEWAYS ARE TO BE CONSTRUCTED AND PERMITTED AS PART OF THE BUILDING PERMIT PROCESS.
- 18. EACH PULL BOX MUST HAVE A MIN. 50' OF SLACK OF FIBER OPTIC CABLE
- 19. EACH SPLICE BOX MUST HAVE A MIN. 100' OF SLACK OF FIBER OPTIC
- CABLE PER CITY SPEC.
- TRACER WIRE MUST BE INSTALLED PER CITY SPEC./QPL. THE PROPERTY OWNER, CONTRACTOR, AND AUTHORIZED REPRESENTATIVES SHALL PROVIDE PICK UP, REMOVAL, AND DISPOSAL OF LITTER WITHIN THE PROPERTY LIMITS AND SHALL BE RESPONSIBLE FOR MAINTENANCE OF THE AREA FORM THE EDGE OF PAVEMENT TO THE PROPERTY LINE WITHIN THE
- CITY'S RIGHT-OF-WAY IN ACCORDANCE WITH CITY CODE, SECTION 41.08 (g). ALL VALVES ARE TO BE LOCATED OUTSIDE OF SIDEWALKS AND CURBS. 23. THE FINAL LOCATION OF ARV'S SHALL BE DETERMINED IN THE FIELD AND BE LOCATED AT THE HIGH POINT.

11-642-06

CALL 48 HOURS BEFORE YOU DIG IT'S THE LAW!

Know what's **below.** DIAL 811 Call before you dig.

SUNSHINE STATE ONE CALL OF FLORIDA, INC. VERTICAL DATUM **ELEVATIONS SHOWN HEREON ARE BASED ON THE** NORTH AMERICAN VERTICAL DATUM OF 1988 (NAVD

GET THE NAVD '88 ELEVATION. CITY OF PORT ST. LUCIE PROJECT #

C-301

P22-301 / P23-153


'88). SUBTRACT 1.50' FROM NGVD '29 ELEVATION TO


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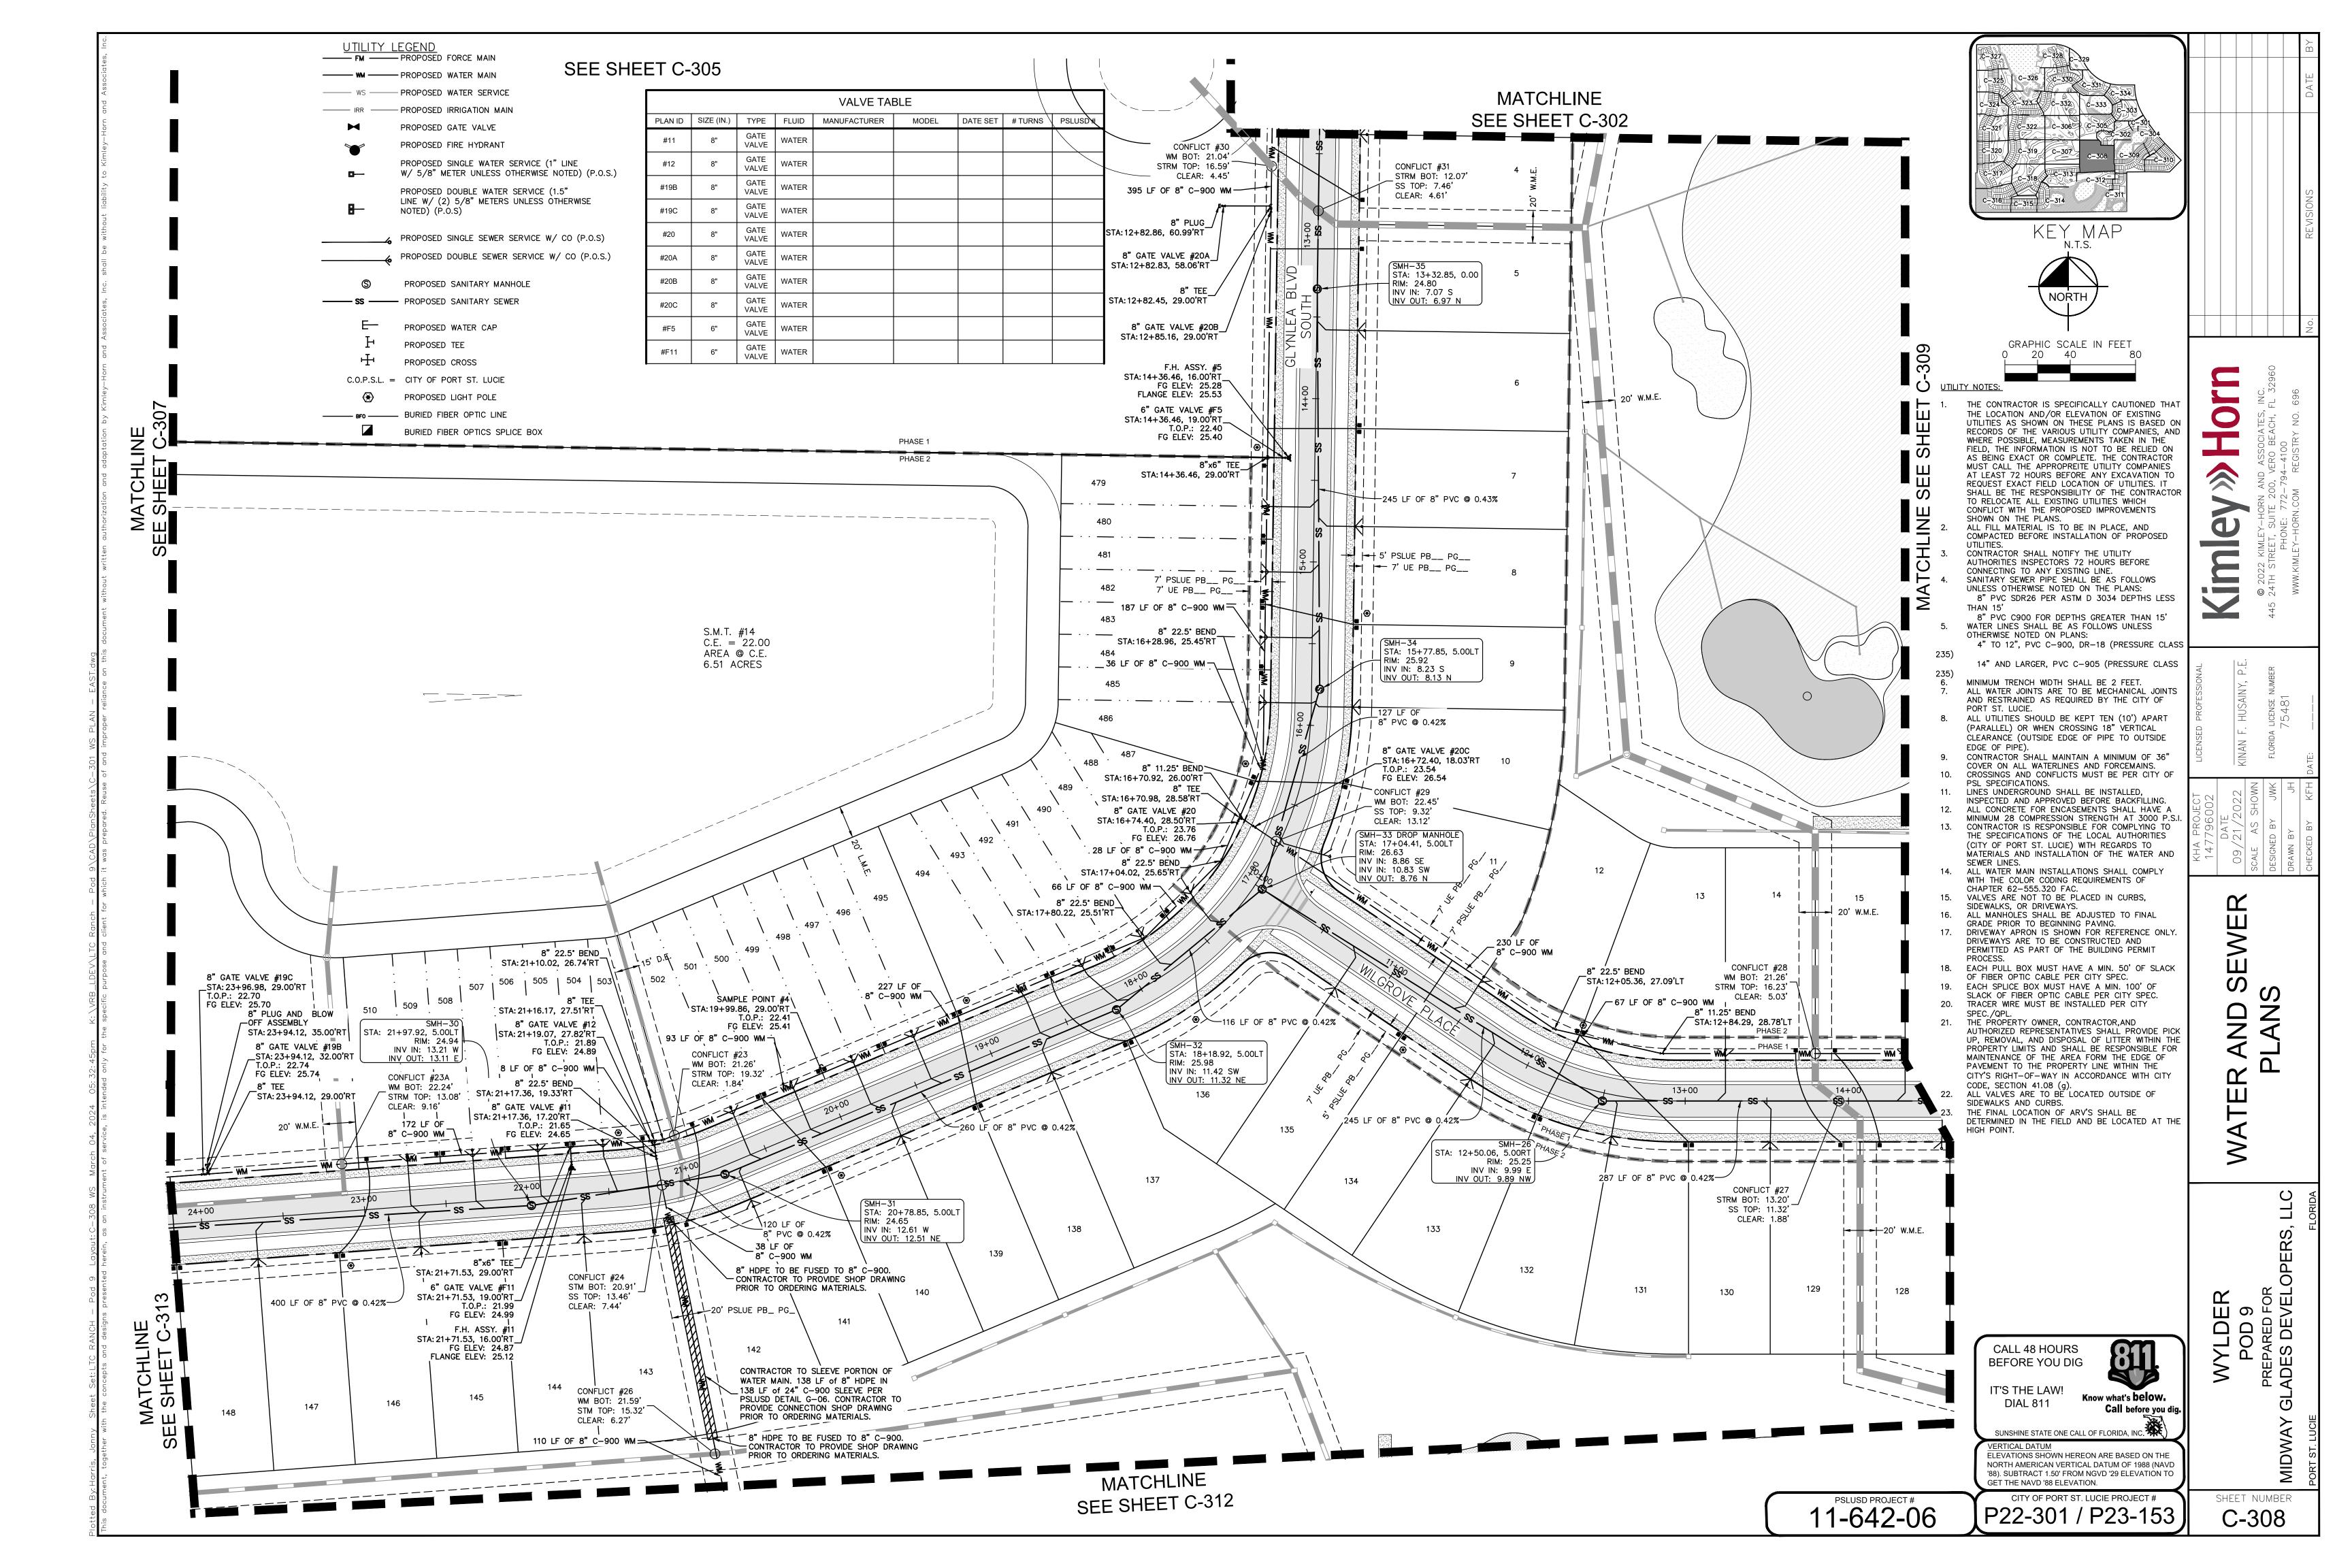
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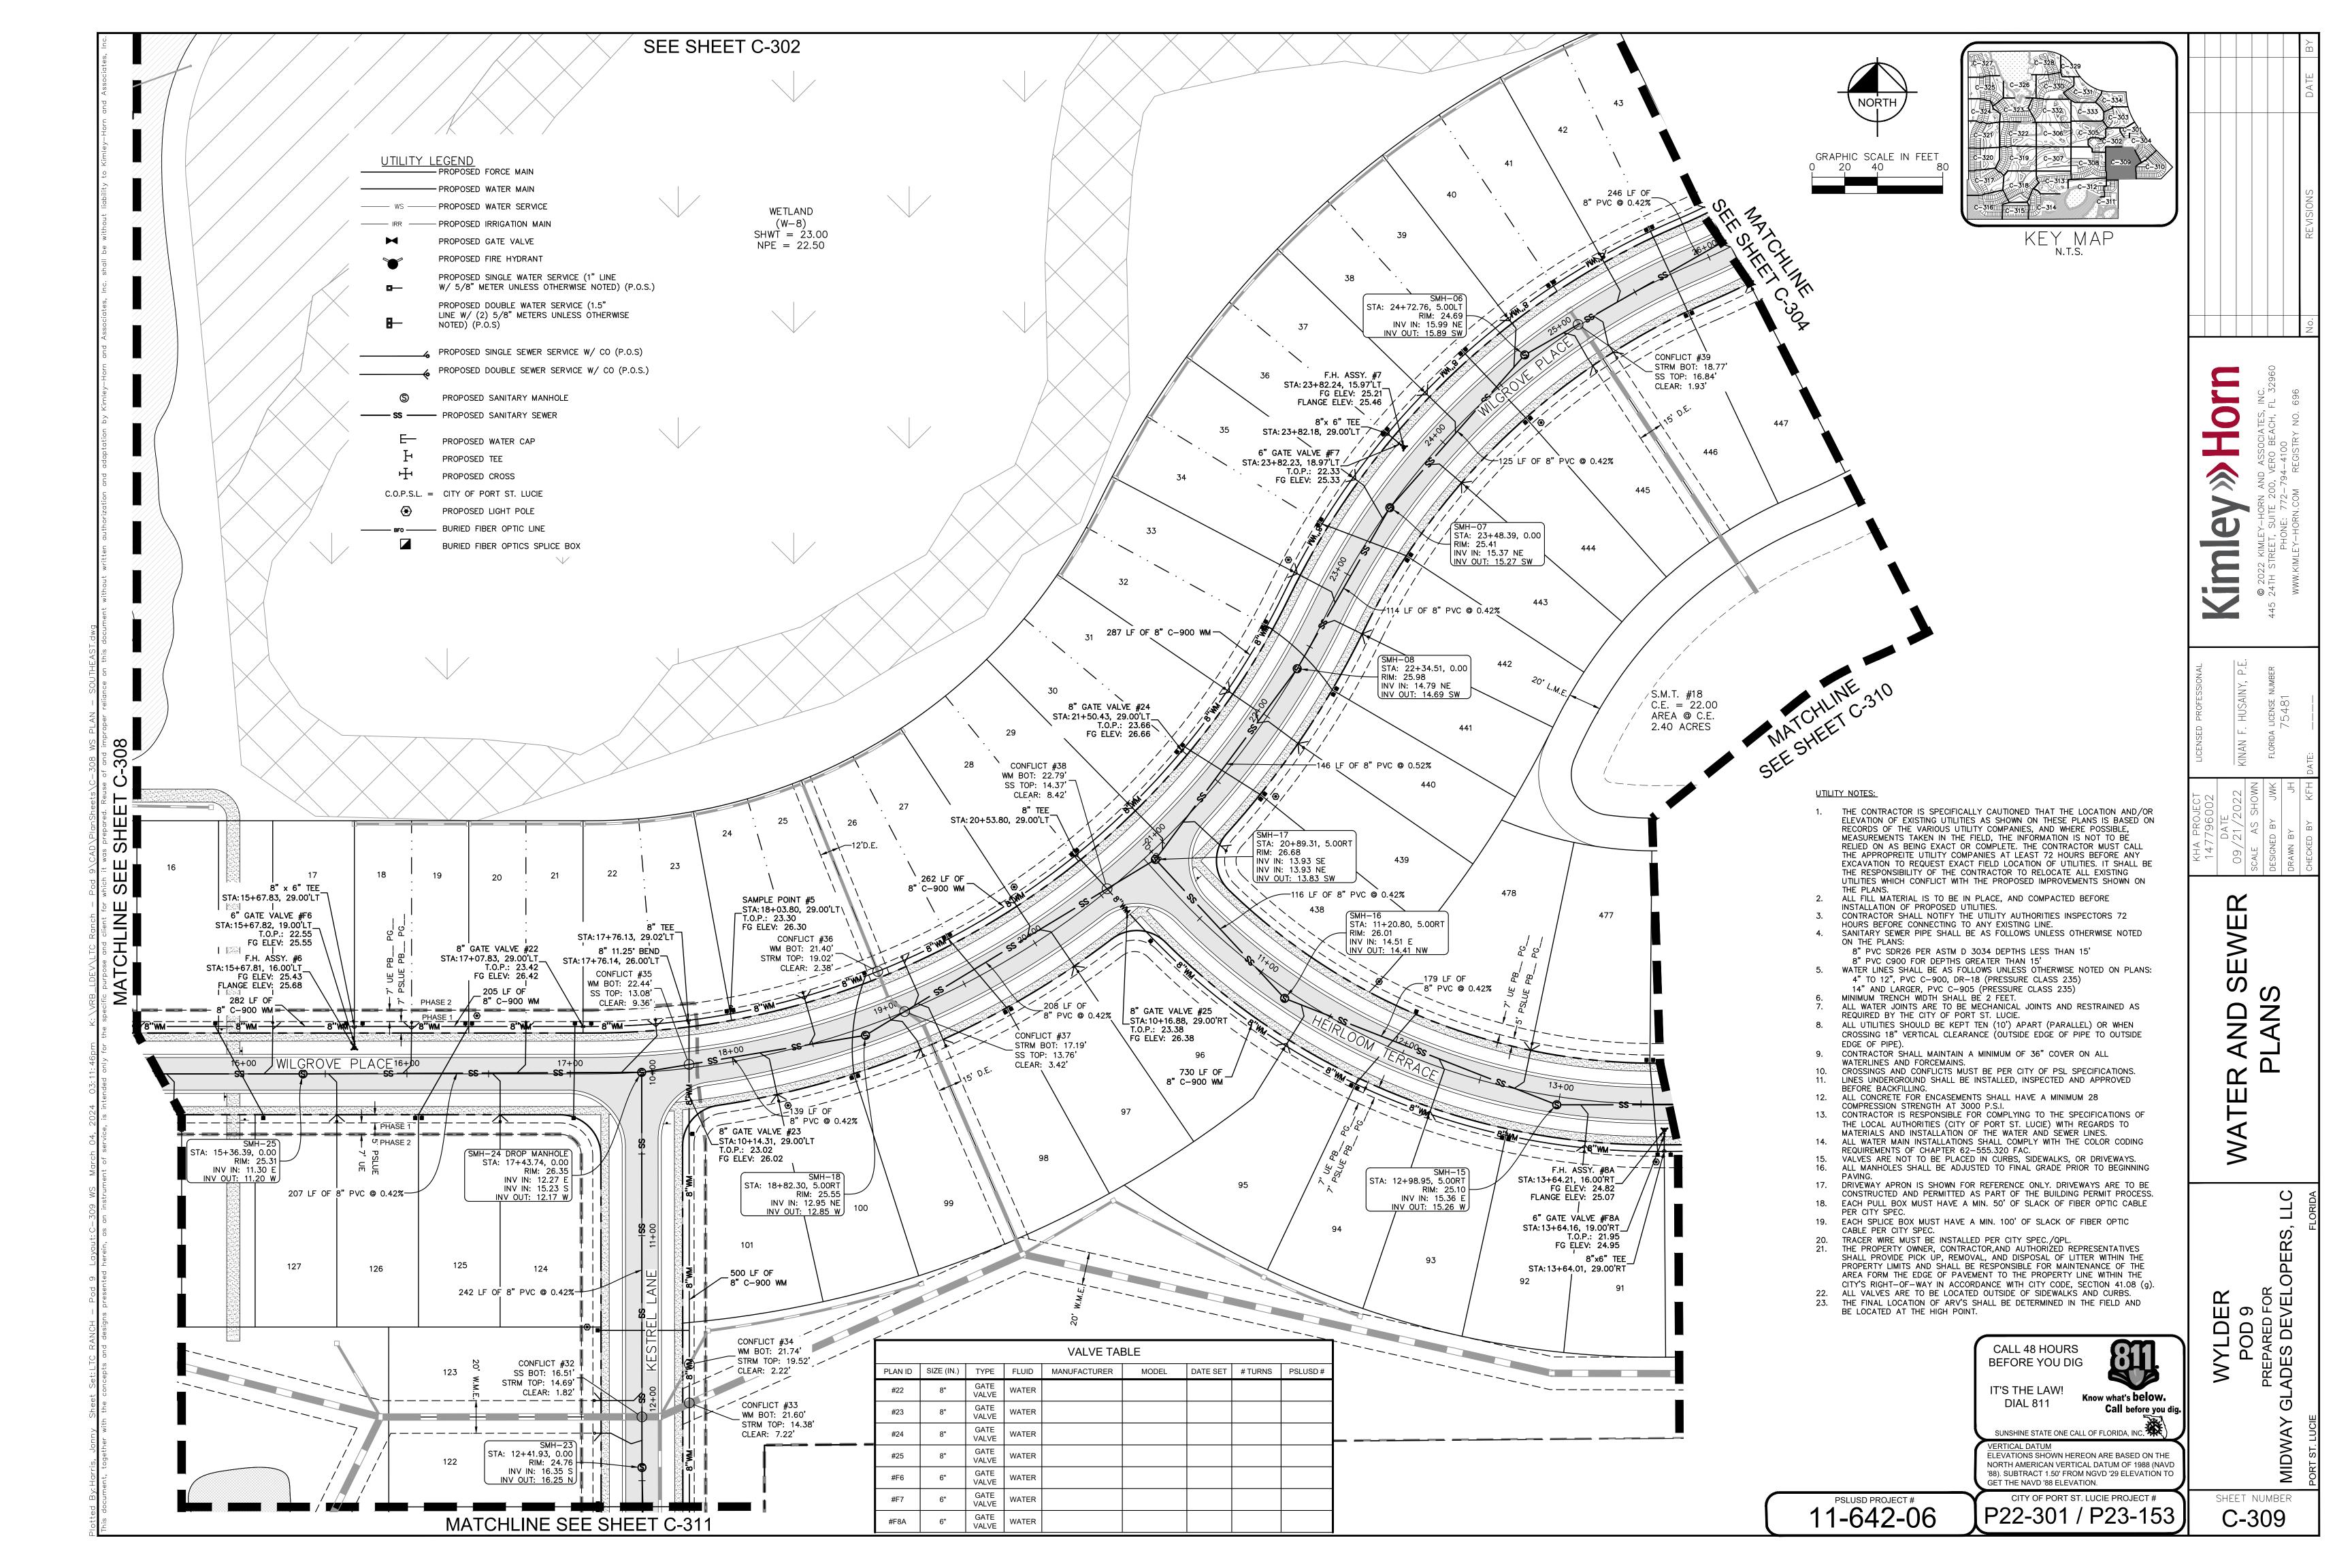
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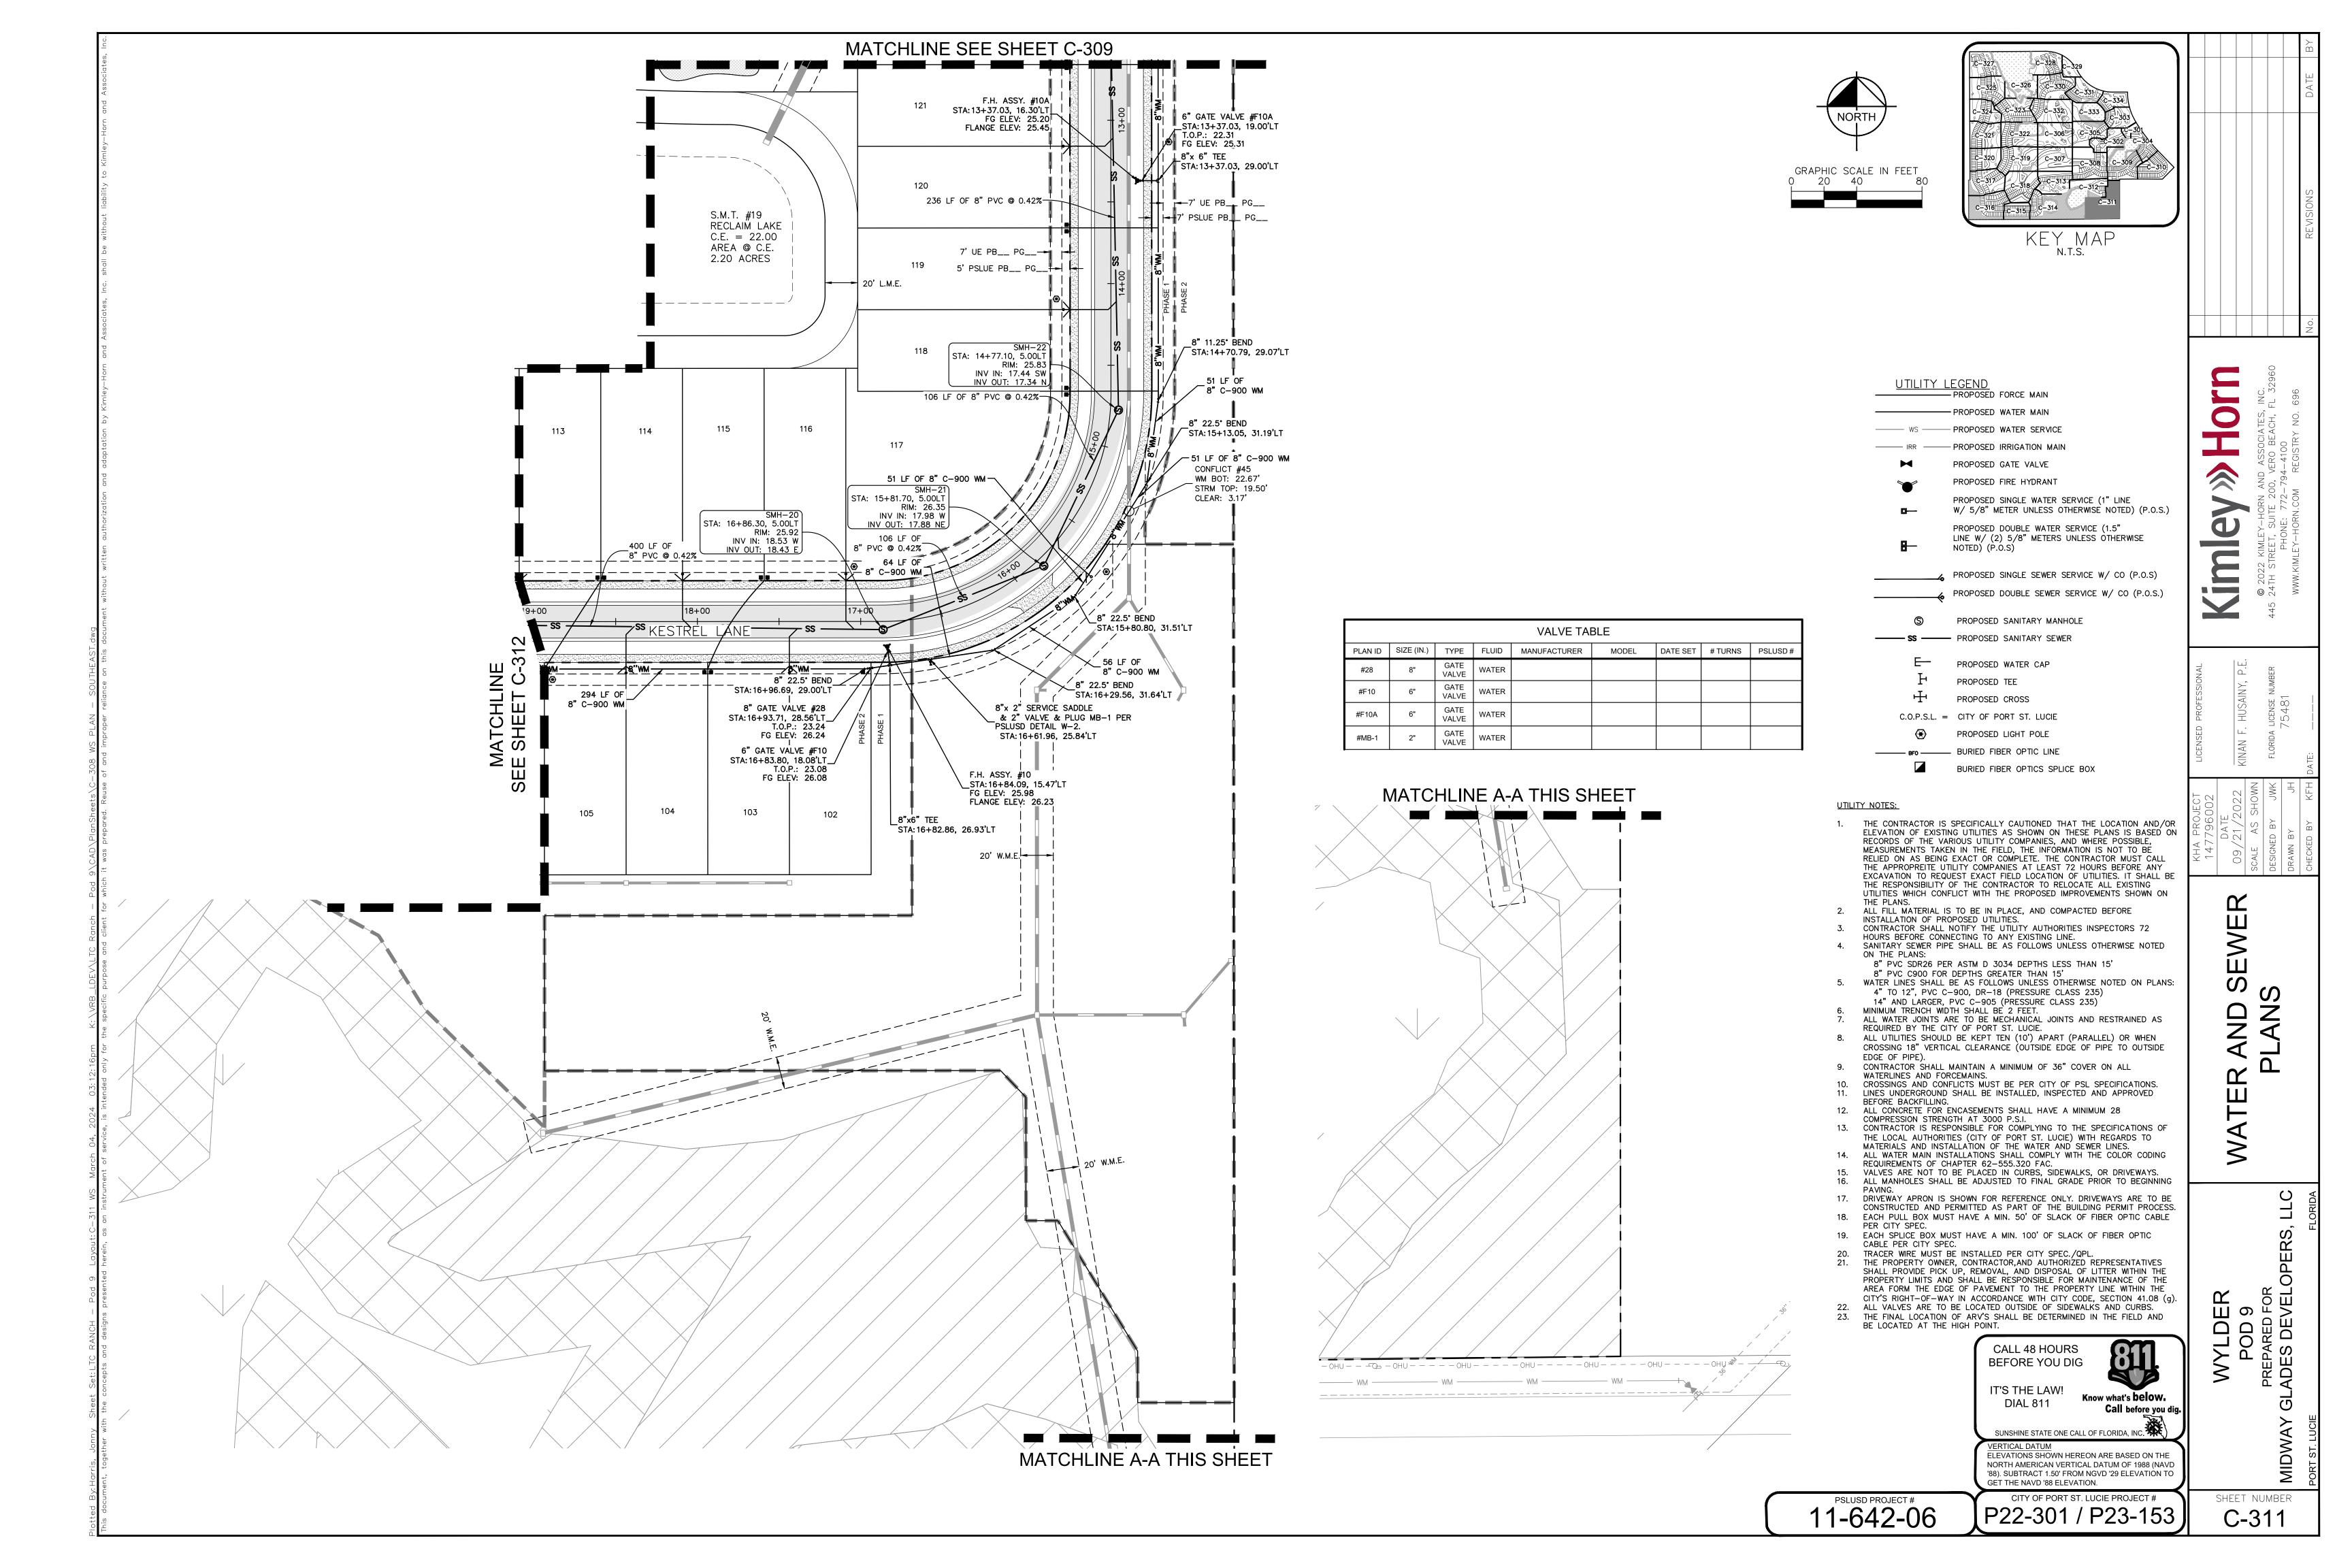
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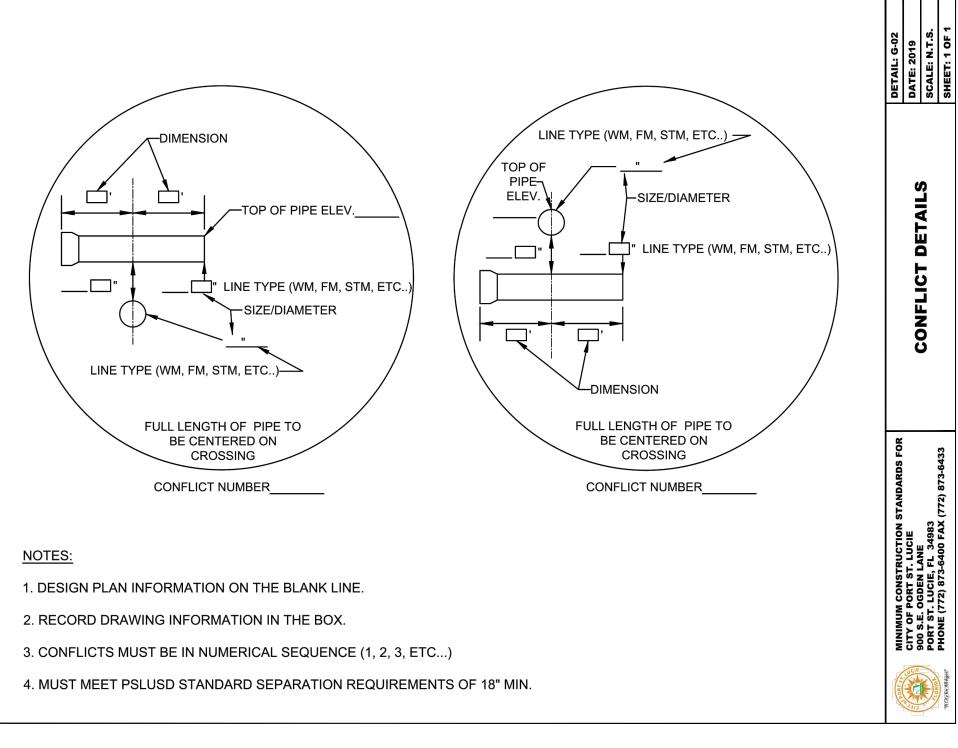








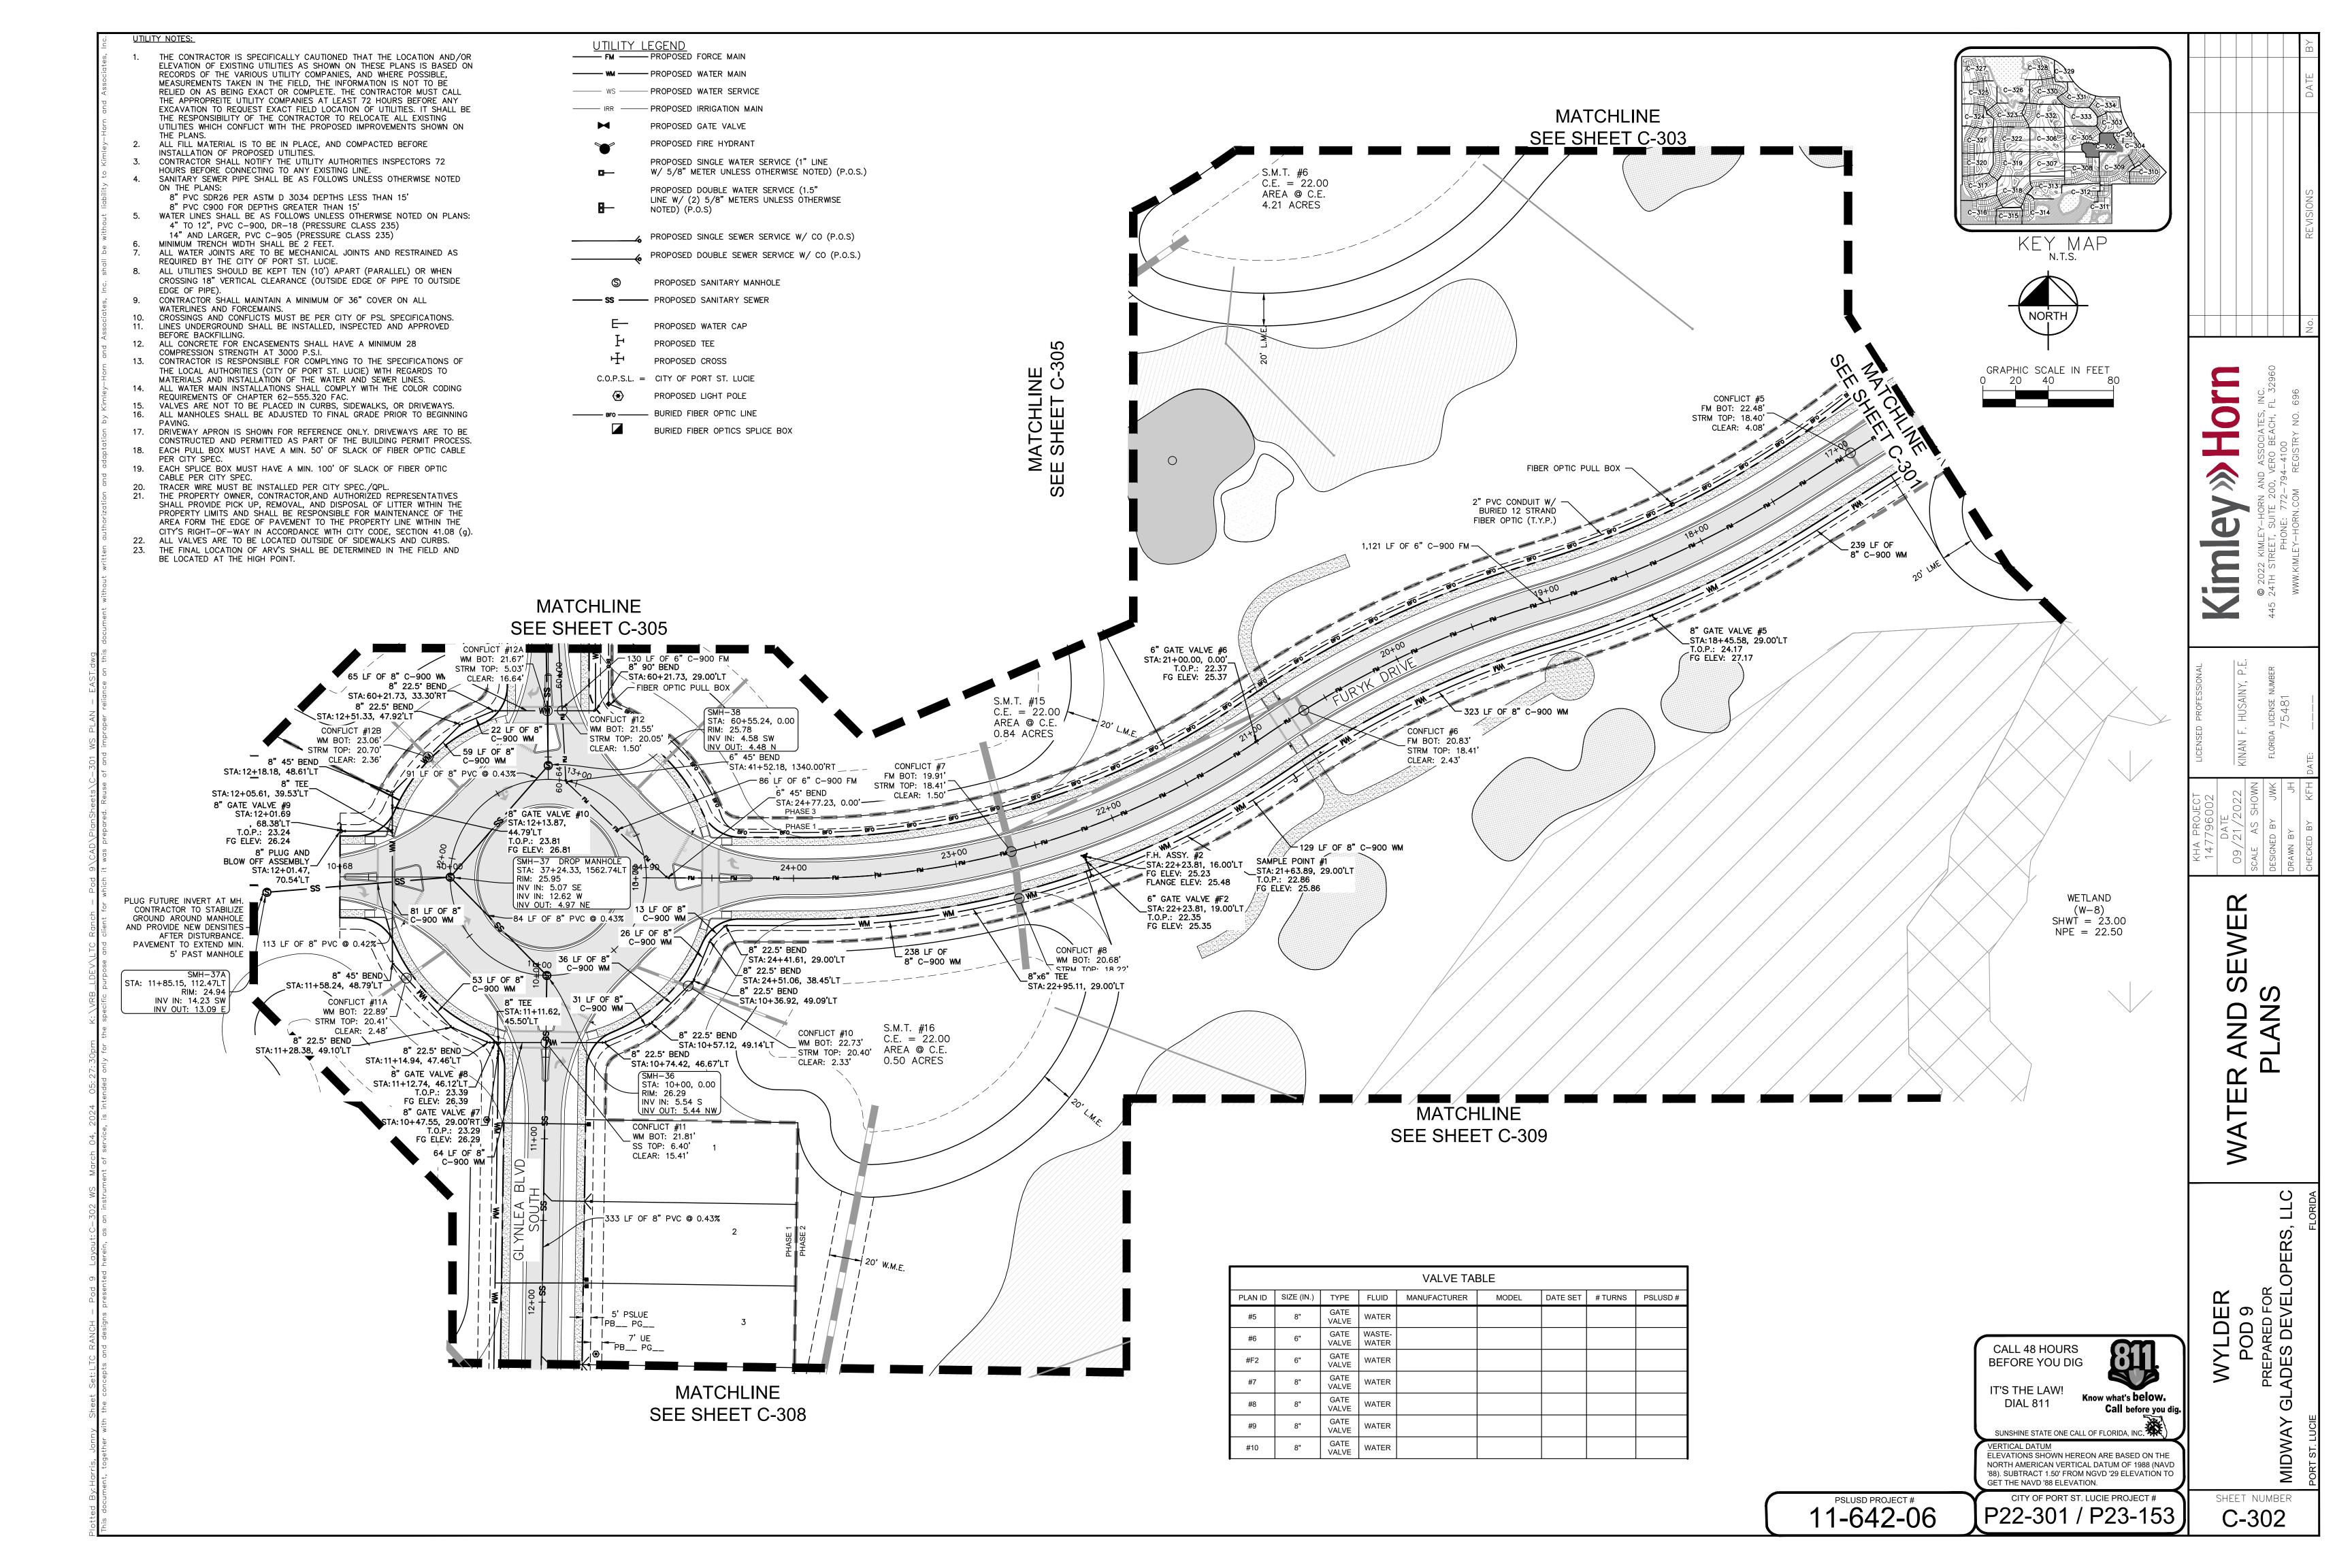



(4) A PSLUSD FACILITY INCLUDES MAINS AND STRUCTURES FOR POTABLE WATER, WASTEWATER AND RECLAIMED WATER.

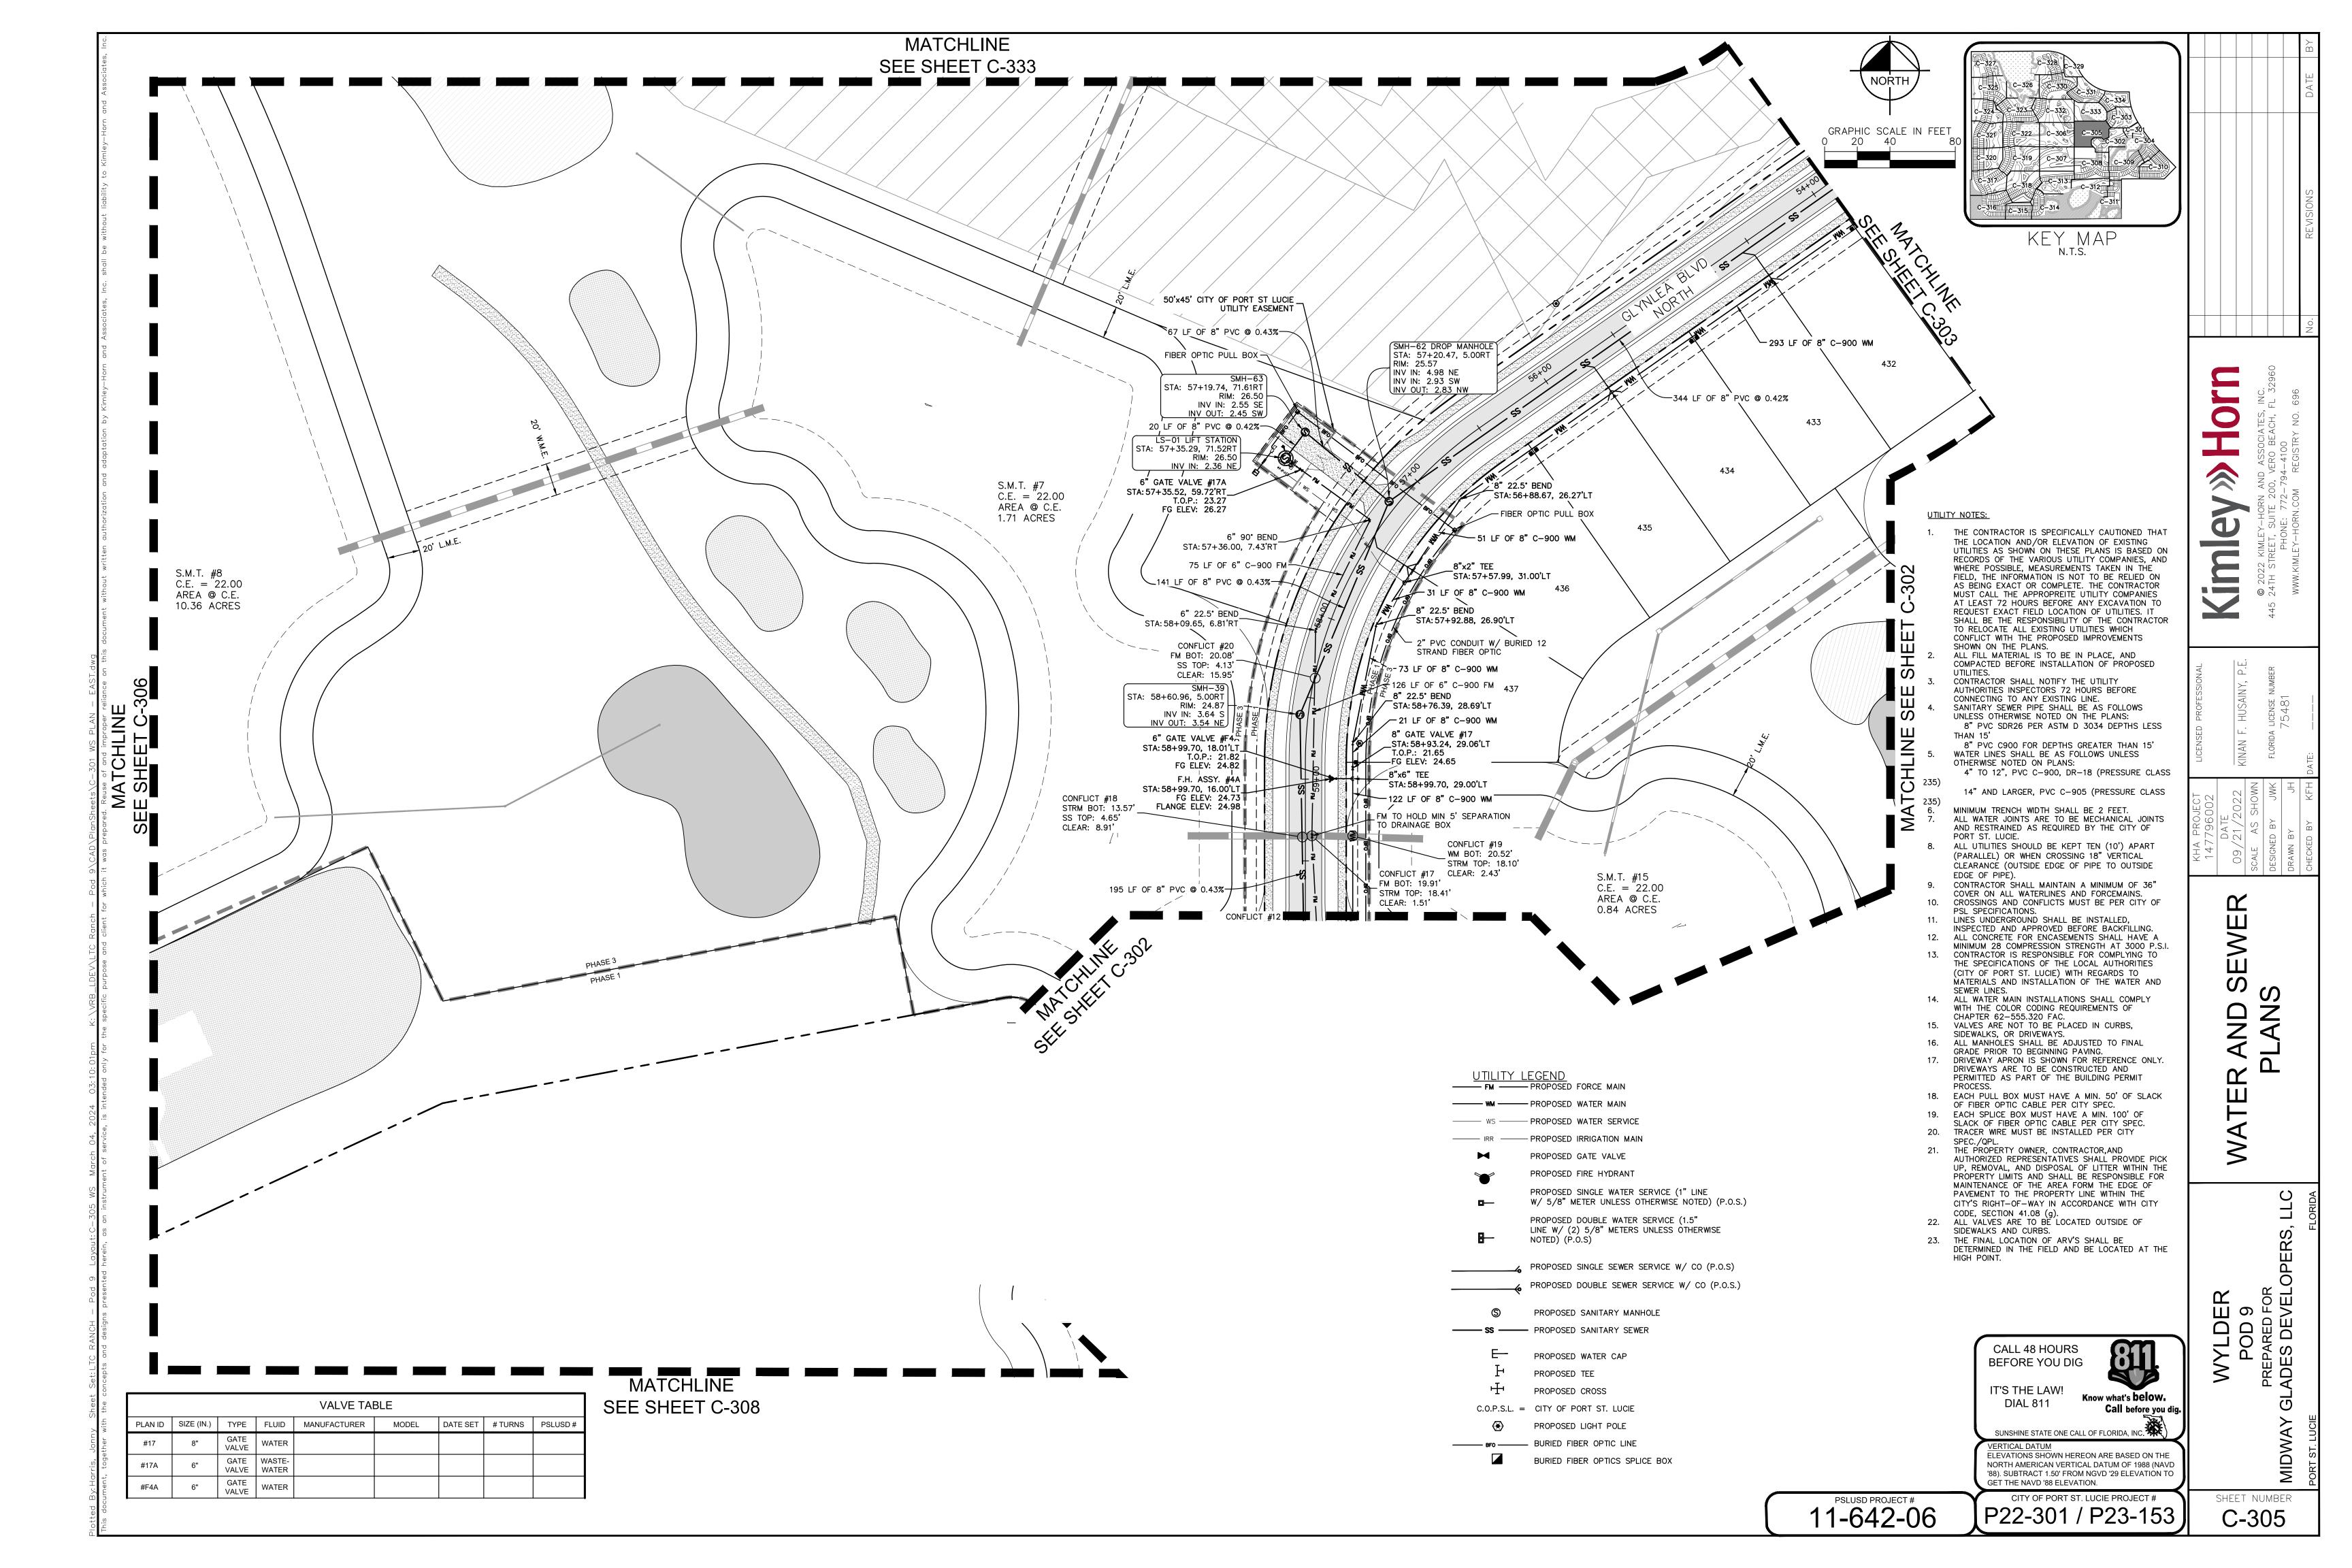


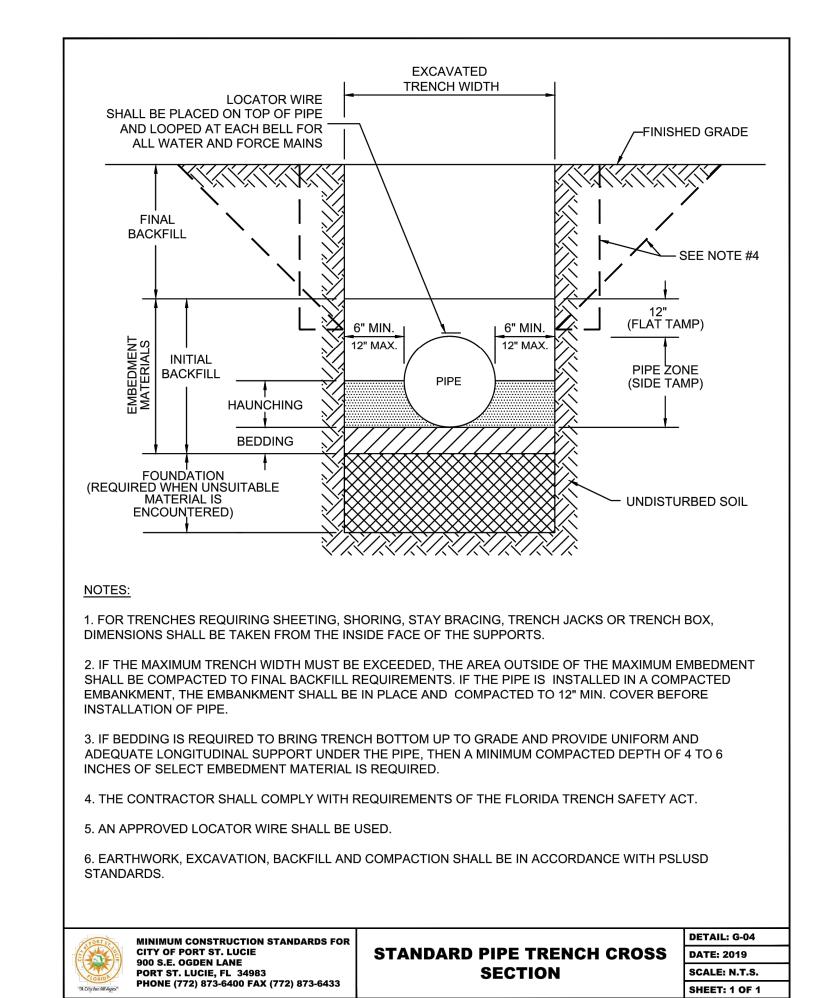

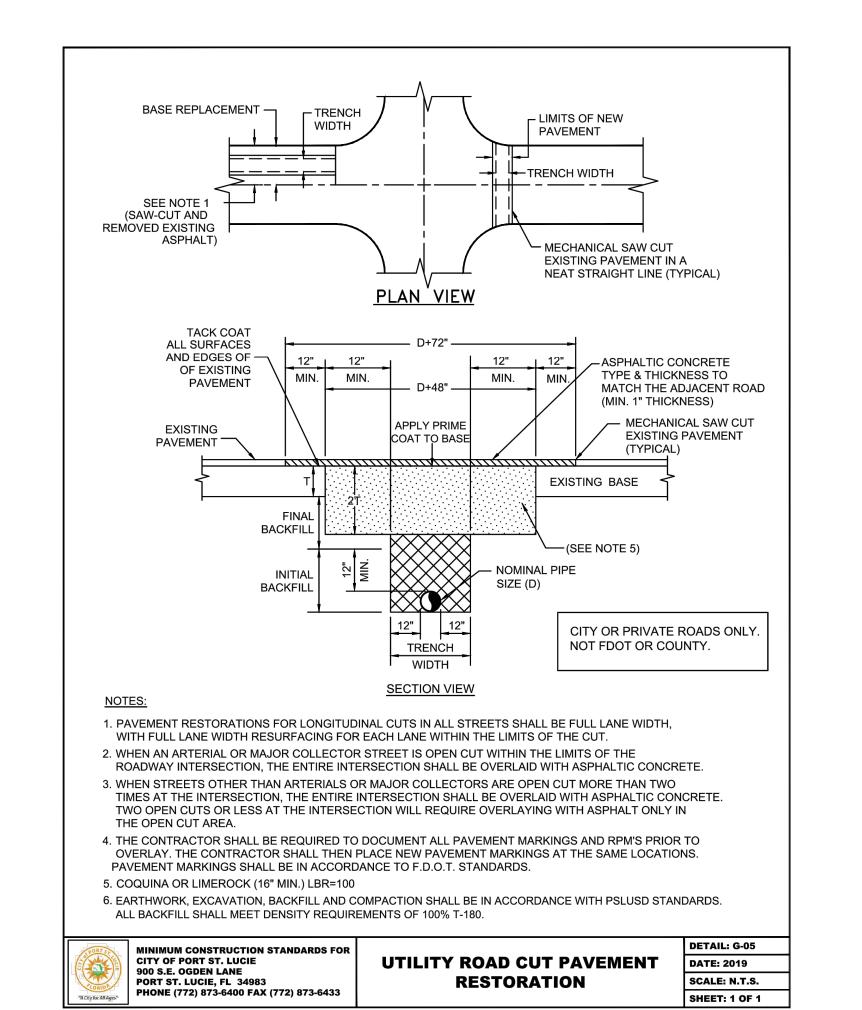

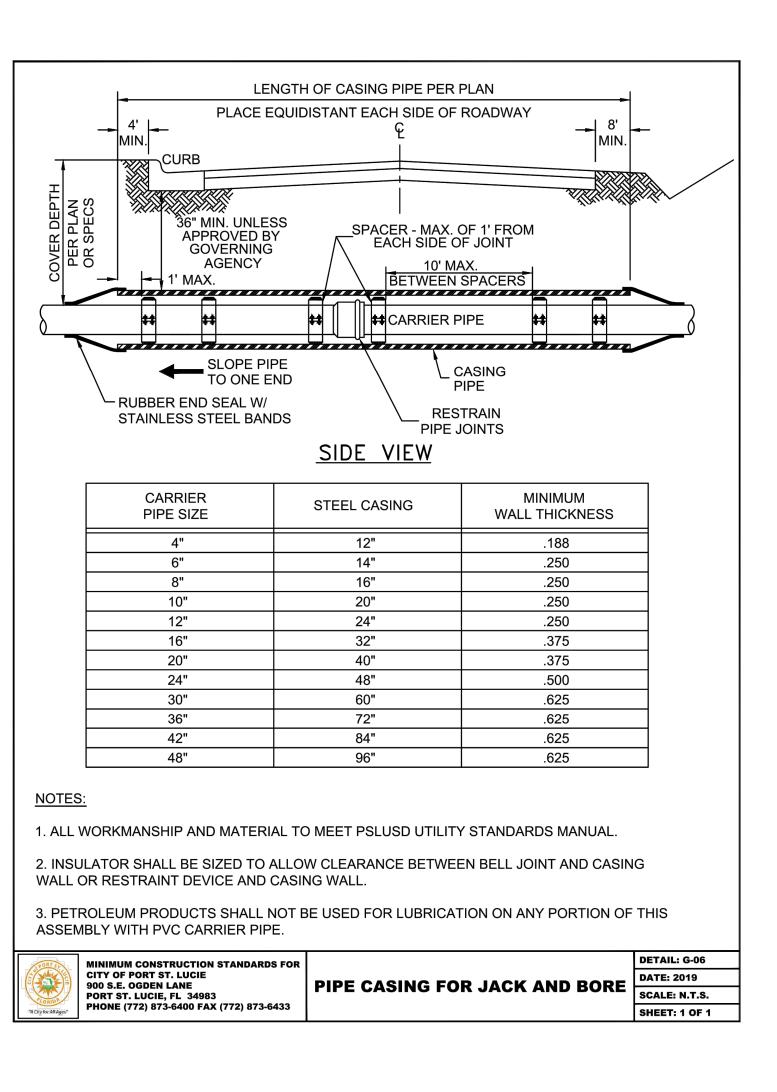

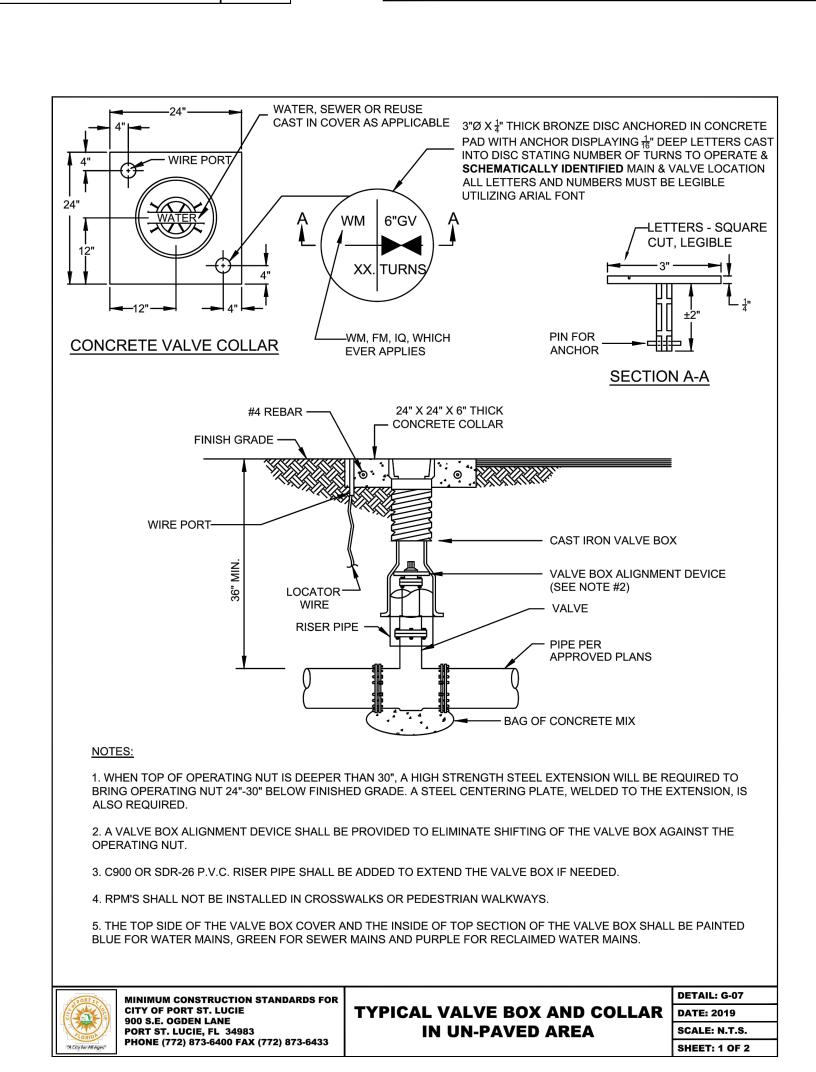

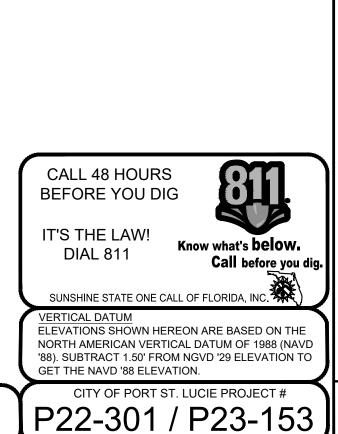



11-642-06

SHEET NUMBER C-350

YLDER POD 9

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- LOWER SIDE MINIMUM COVER: 5 FT
- SAFETY FACTOR: 1.5 - TEST PRESSURE: 150 PSI
- 2. WHEN CONDITIONS DIFFER FROM THE ABOVE, THE ENGINEER-OF-RECORD (EOR) SHALL SUBMIT CALCULATIONS FOR REVIEW AND APPROVAL OF PSLUSD.
- 3. ALL JOINTS BETWEEN UPPER AND LOWER BENDS SHALL BE RESTRAINED.

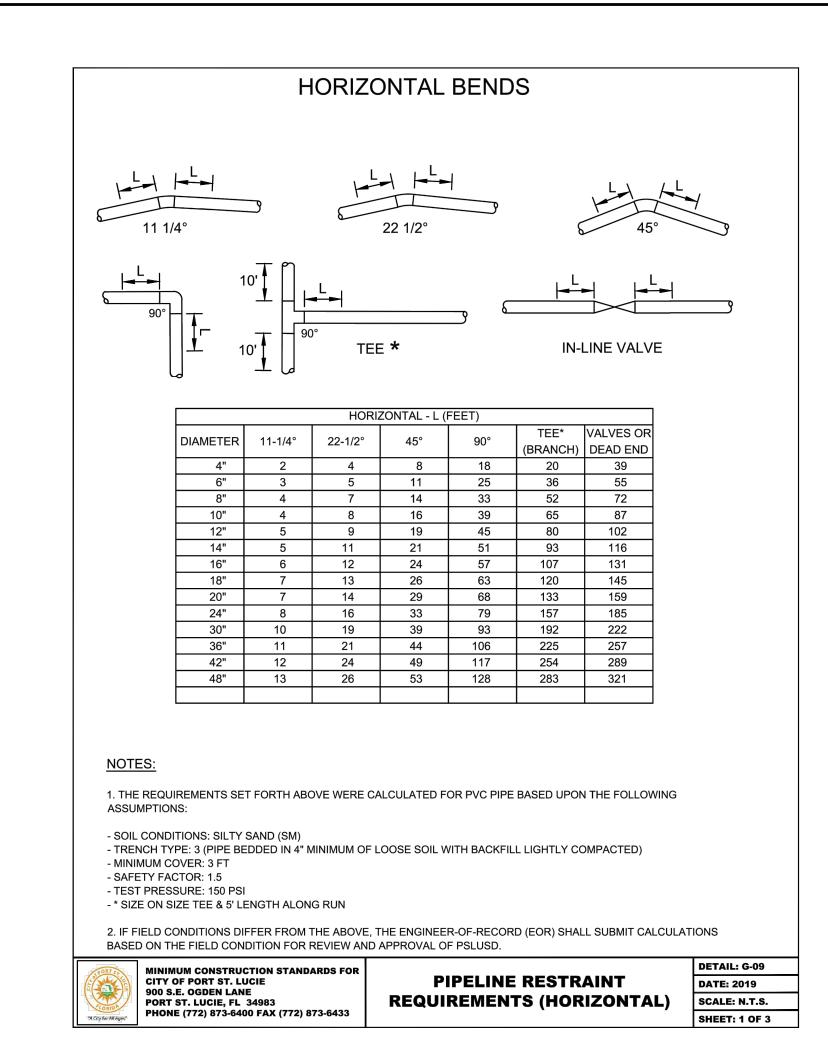
MINIMUM CONSTRUCTION STANDARDS FOR CITY OF PORT ST. LUCIE PORT ST. LUCIE, FL 34983 PHONE (772) 873-6400 FAX (772) 873-6433

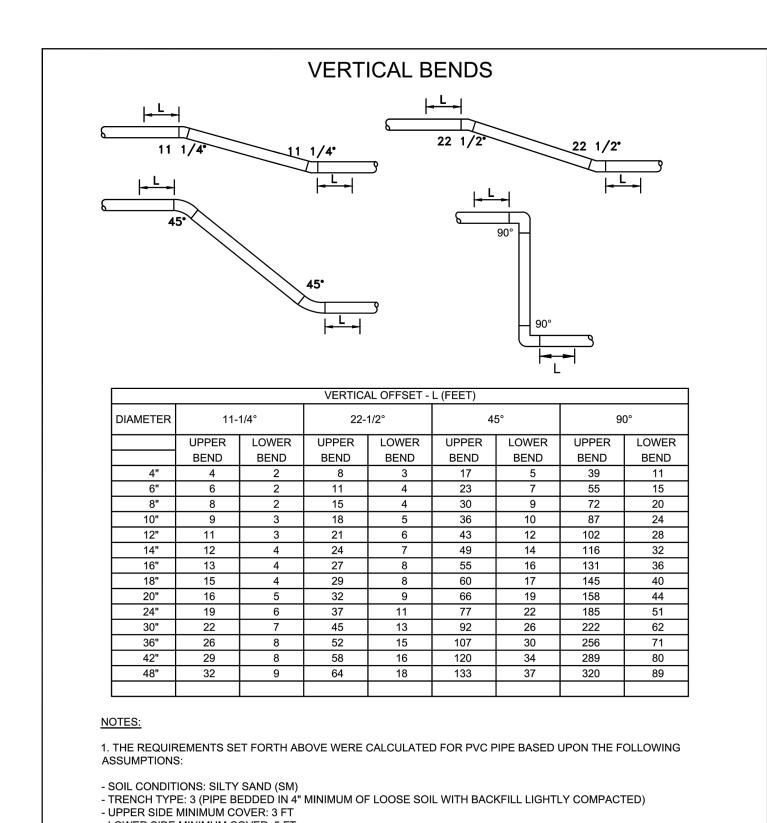PIPELINE RESTRAINT REQUIREMENTS (VERTICAL)

DETAIL: G-09 **DATE: 2019** SCALE: N.T.S. SHEET: 2 OF 3

REDUCER

SHEET: 2 OF 2

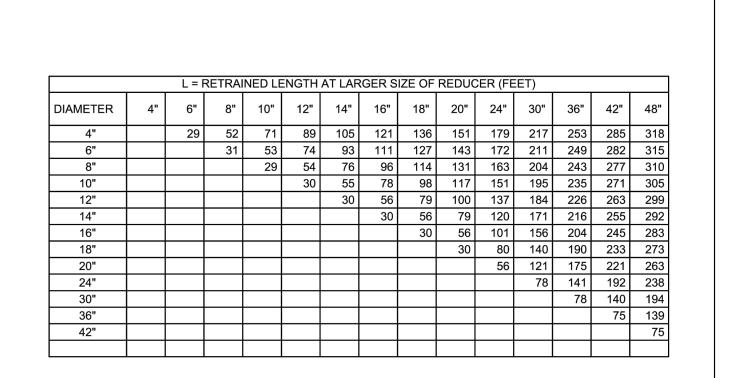

1. THE REQUIREMENTS SET FORTH ABOVE WERE CALCULATED FOR PVC PIPE BASED UPON THE FOLLOWING ASSUMPTIONS:


- SOIL CONDITIONS: SILTY SAND (SM) - TRENCH TYPE: 3 (PIPE BEDDED IN 4" MINIMUM OF LOOSE SOIL WITH BACKFILL LIGHTLY COMPACTED)
- MINIMUM COVER: 3 FT - SAFETY FACTOR: 1.5 - TEST PRESSURE: 150 PSI
- 2. IF FIELD CONDITIONS DIFFER FROM THE ABOVE, THE ENGINEER-OF-RECORD (EOR) SHALL SUBMIT CALCULATIONS

BASED ON THE FIELD CONDITION FOR REVIEW AND APPROVAL OF PSLUSD.

MINIMUM CONSTRUCTION STANDARDS FOR CITY OF PORT ST. LUCIE PORT ST. LUCIE, FL 34983 PHONE (772) 873-6400 FAX (772) 873-6433

PIPELINE RESTRAINT REQUIREMENTS (REDUCER)

DETAIL: G-09 **DATE: 2019** SCALE: N.T.S. SHEET: 3 OF 3

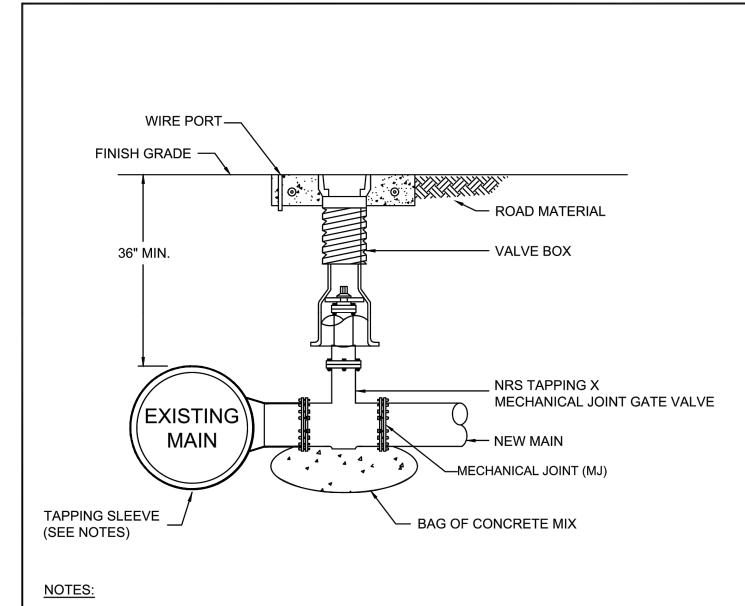


- 1. THE VALVE BOX SHALL BE IN ACCORDANCE WITH STANDARD DETAIL G-07.
- 2. THRUST BLOCKS MAY BE REQUIRED AT THE UTILITY'S DIRECTION. (CASE BY CASE)
- 2. NO TAP WILL BE ALLOWED CLOSER THAN 5 FEET FROM ANY JOINT, FITTING OR EXISTING TAP ALONG THE MAIN.
- 4. ALL COUPONS MUST BE PROVIDED TO PSLUSD WITH DATE, LOCATION AND PIPE SIZE DOCUMENTED.
- 5. SIZE ON SIZE TAPS ARE NOT ALLOWED UNLESS APPROVED IN WRITING BY PSLUSD.
- 6. SEE NOTES ON DETAIL G-07.

MINIMUM CONSTRUCTION STANDARDS FOR CITY OF PORT ST. LUCIE PORT ST. LUCIE, FL 34983 PHONE (772) 873-6400 FAX (772) 873-6433

TAPPING SLEEVE AND VALVE **ASSEMBLY**

DETAIL: G-10 **DATE: 2019** SCALE: N.T.S. SHEET: 1 OF 1

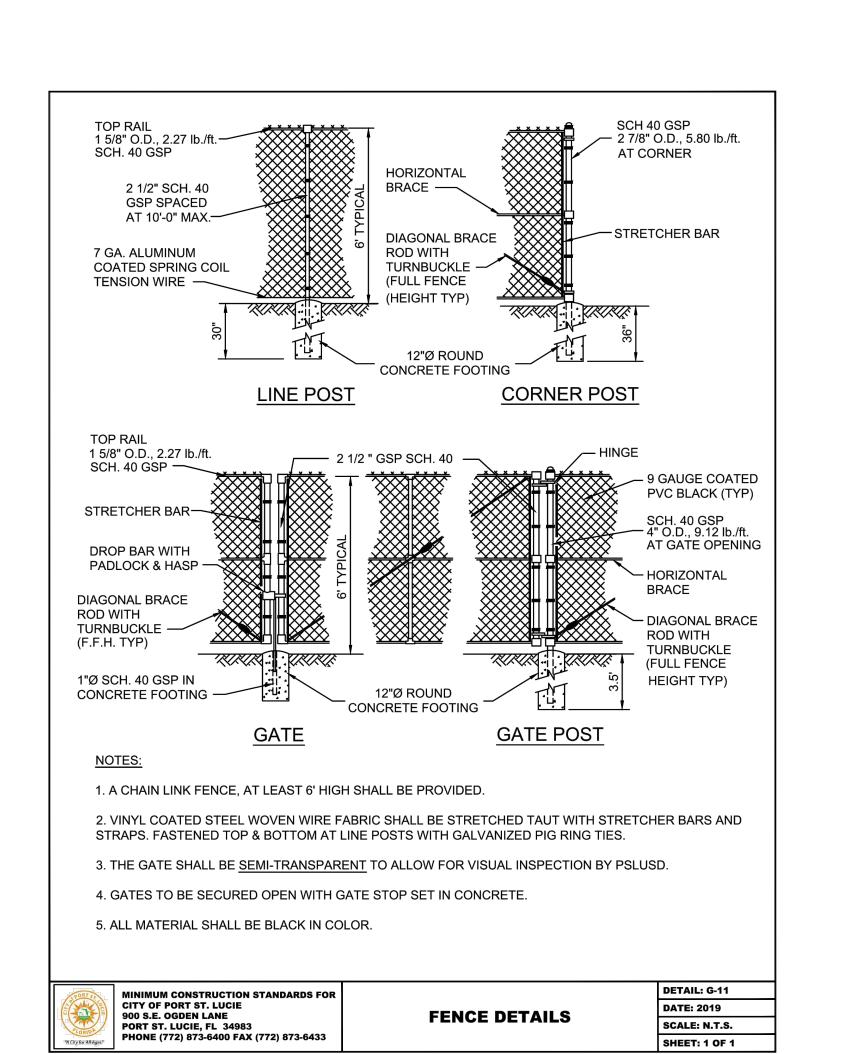

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ELEVATIONS SHOWN HEREON ARE BASED ON THE NORTH AMERICAN VERTICAL DATUM OF 1988 (NAVD '88). SUBTRACT 1.50' FROM NGVD '29 ELEVATION TO GET THE NAVD '88 ELEVATION.

CITY OF PORT ST. LUCIE PROJECT # P22-301 / P23-153 C-351

11-642-06


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PREPARED FOR
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- 2. ALL SERVICES REQUIRE 36" MINIMUM COVER AT ALL POINTS ALONG SERVICE.
- 3. 1" SERVICES REQUIRE A 2" MINIMUM I.D. CASING PIPE. CASING PIPE SHALL BE SCHEDULE 40 PVC OR POLYETHYLENE.
- 4. TRACE WIRE TO BE INSTALLED AS PER THIS DETAIL.
- 5. METERS SHALL BE LOCATED IMMEDIATELY OUTSIDE THE PROPERTY LINE IN THE RIGHT-OF-WAY UNLESS OTHERWISE DIRECTED BY PSLUSD (SEE SHEET 2).

CITY OF PORT ST. LUCIE 900 S.E. OGDEN LANE PORT ST. LUCIE. FL 34983 PHONE (772) 873-6400 FAX (772) 873-6433


RESIDENTIAL WATER SERVICE CONNECTION DETAIL: W-01 DATE: 2019 SCALE: N.T.S. SHEET: 1 OF 2




3. A KEY VALVE BRANCH ASSEMBLY SHALL BE PROVIDED BY CONTRACTOR FOR DOUBLE SERVICES.

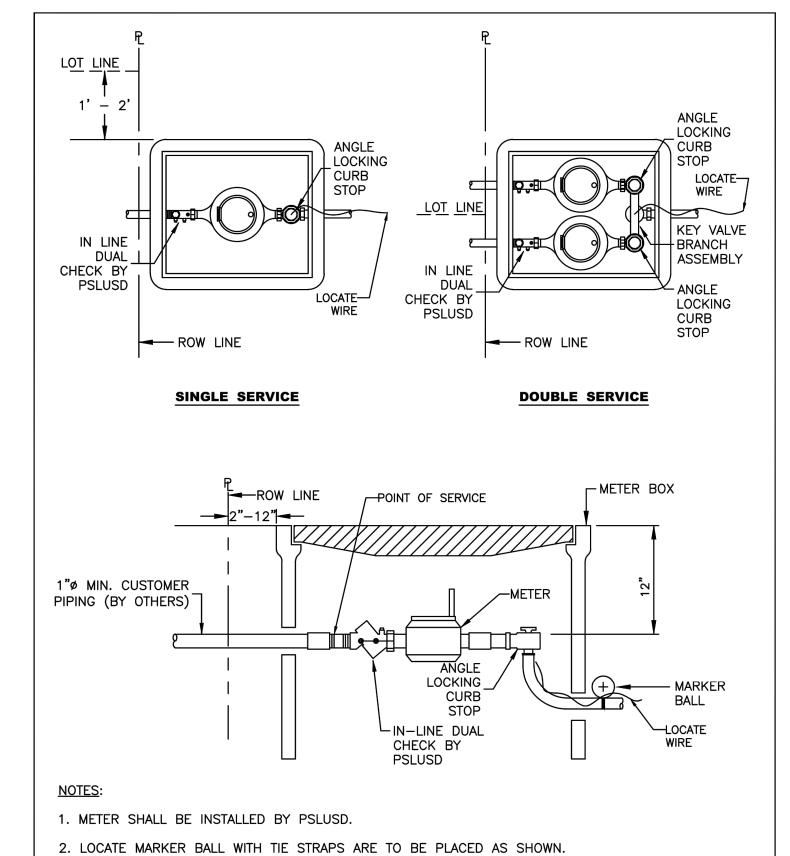MINIMUM CONSTRUCTION STANDARDS FOR CITY OF PORT ST. LUCIE **RESIDENTIAL WATER** 900 S.E. OGDEN LANE **SERVICE CONNECTION** PORT ST. LUCIE. FL 34983 PHONE (772) 873-6400 FAX (772) 873-6433

DETAIL: W-01 **DATE: 2019** SCALE: N.T.S. SHEET: 2 OF 2

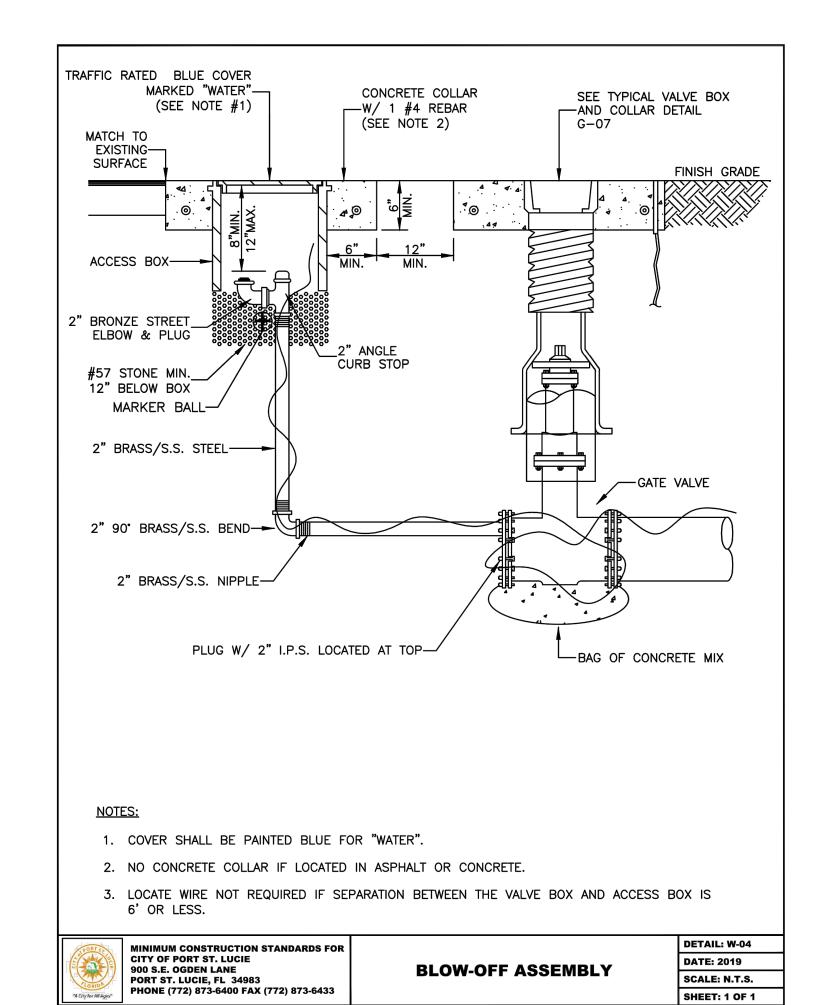

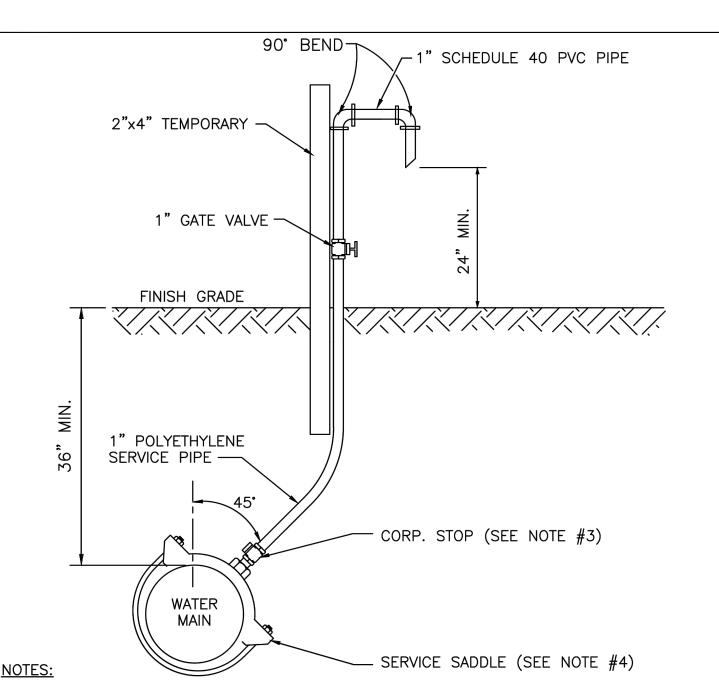


- 1. SAMPLING POINTS SHALL BE LOCATED AS SHOWN ON PLANS APPROVED BY PSLUSD AND AS REQUIRED BY FLORIDA DEPARTMENT OF ENVIRONMENTAL PROTECTION. A SAMPLE POINT MAP (SINGLE SHEET PDF) SHALL BE SUBMITTED TO PSLUSD FOR REVIEW PRIOR TO DISINFECTION.
- 2. THE EXCAVATED HOLE FOR THIS INSTALLATION SHALL BE BACKFILLED TO FINISHED GRADE PRIOR TO DISCHARGING ANY WATER ON THE GROUND.
- 3. AFTER BACTERIOLOGICAL CLEARANCE IS RECEIVED, THE CONTRACTOR SHALL TURN CORPORATION STOP OFF, REMOVE TUBING AND PLUG CORPORATION STOP WITH BRASS PLUG/CAP.
- 4. NO DIRECT TAPS SHALL BE PERMITTED.

CITY OF PORT ST. LUCIE 900 S.E. OGDEN LANE PHONE (772) 873-6400 FAX (772) 873-6433

WATER SAMPLING POINT

DETAIL: W-05 **DATE: 2019** SCALE: N.T.S.

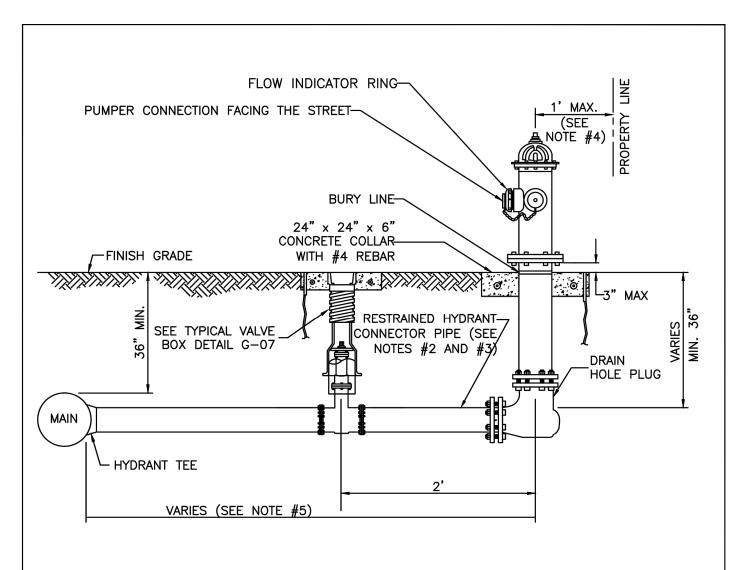

NOTES:


- I. HYDRANTS SHALL BE INSTALLED IN ACCORDANCE WITH ANSI/AWWA C600. THE HYDRANTS SHALL BE PAINTED BY THE MANUFACTURER WITH 2 COATS (MIN.).
- 2. VERTICAL BENDS MAY BE NECESSARY TO OBTAIN COVER UNDER SWALES OR AT HYDRANT LOCATION. VERTICAL BENDS OR OFFSETS ARE INCLUDED IN HYDRANT ASSEMBLY. ALL BENDS MUST BE
- 3. CONNECTOR PIPE AND ANY REQUIRED VERTICAL BENDS SHALL HAVE AN ANCHORING FEATURE ON BOTH ENDS SO THAT WHEN USED WITH M.J. SPLIT GLANDS, A RESTRAINED JOINT IS PROVIDED.
- 4. WHEN INSTALLED WITH SIDEWALK OR CURB, PROVIDE MIN. 2 FOOT CLEARANCE TO ANY PORTION OF THE HYDRANT, UTILIZING THE SIDE LOT EASEMENT IF NECESSARY.
- 5. A GATE VALVE SHALL BE INSTALLED WITHIN 2 FEET OF THE FIRE HYDRANT. IF DISTANCE FROM THE WATER MAIN TO THE FIRE HYDRANT IS GREATER THAN 20 FEET, A SECOND GATE VALVE SHALL BE INSTALLED WITHIN 2 FEET OF THE MAIN.
- 6. ANY DEVIATIONS FROM THE CRITERIA ABOVE REQUIRE A WRITTEN RECOMMENDATION FROM THE ENGINEER-OF-RECORD AND WRITTEN APPROVAL BY PSLUSD.

CITY OF PORT ST. LUCIE 900 S.E. OGDEN LANE PORT ST. LUCIE, FL 34983 PHONE (772) 873-6400 FAX (772) 873-6433

FIRE HYDRANT ASSEMBLY

DATE: 2019 SCALE: N.T.S. SHEET: 1 OF 1

DETAIL: W-06

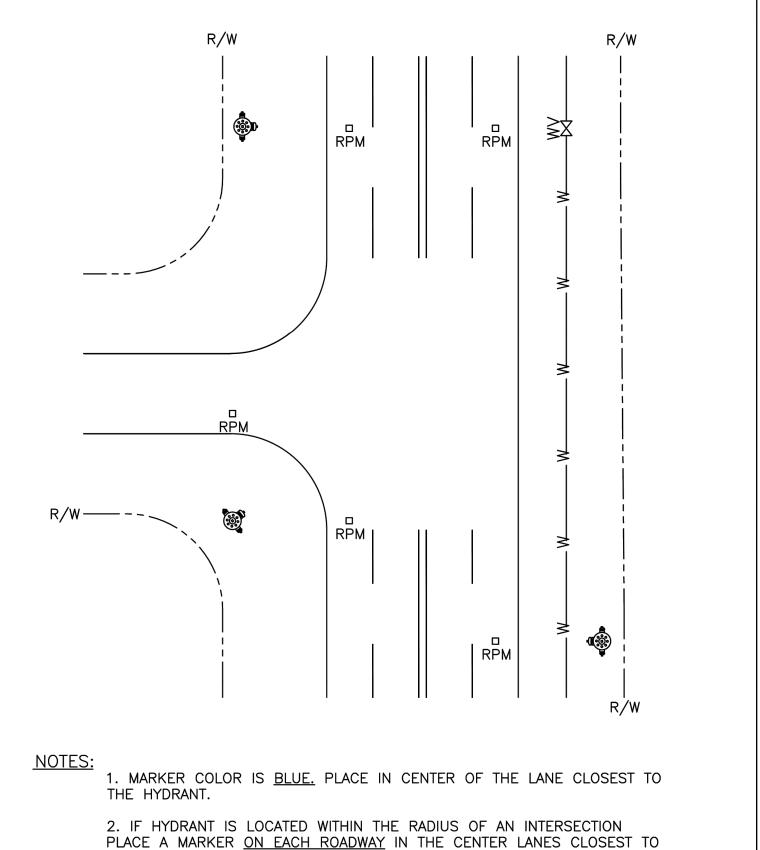

2. IF HYDRANT IS LOCATED WITHIN THE RADIUS OF AN INTERSECTION PLACE A MARKER ON EACH ROADWAY IN THE CENTER LANES CLOSEST TO THE HYDRANT.

3. MARKER IS PLACED PERPENDICULAR (90 DEGREES) TO THE HYDRANT.

MINIMUM CONSTRUCTION STANDARDS FOR CITY OF PORT ST. LUCIE PORT ST. LUCIE. FL 34983 PHONE (772) 873-6400 FAX (772) 873-6433

REFLECTIVE PAVEMENT MARKER PLACEMENT GUIDELINE

FIRE HYDRANT

DETAIL: W-08 **DATE: 2019** SCALE: N.T.S. SHEET: 1 OF 1

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CALL 48 HOURS

ELEVATIONS SHOWN HEREON ARE BASED ON THE NORTH AMERICAN VERTICAL DATUM OF 1988 (NAVD '88). SUBTRACT 1.50' FROM NGVD '29 ELEVATION TO


GET THE NAVD '88 ELEVATION. CITY OF PORT ST. LUCIE PROJECT #

P22-301 / P23-153


SHEET NUMBER C-352


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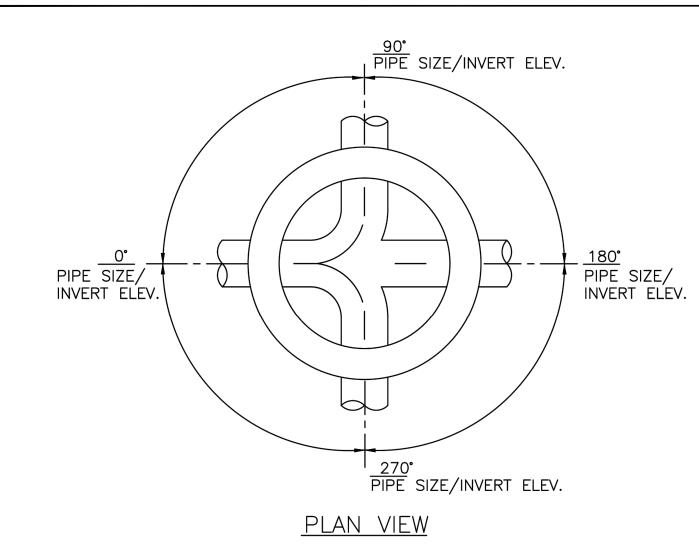


SHEET: 1 OF 2

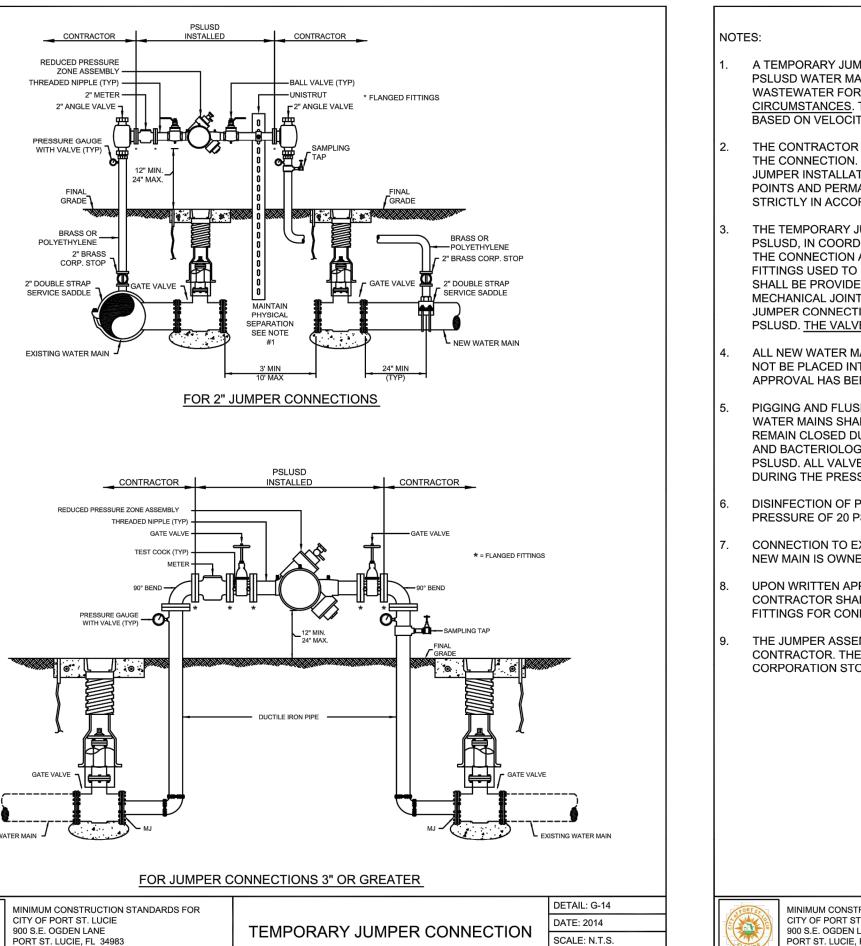



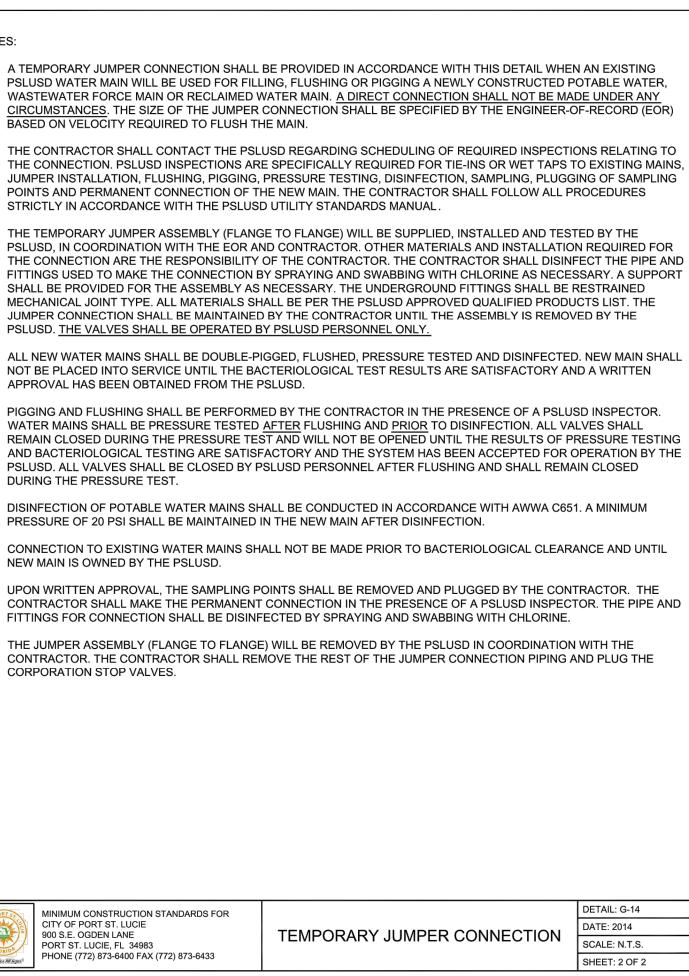

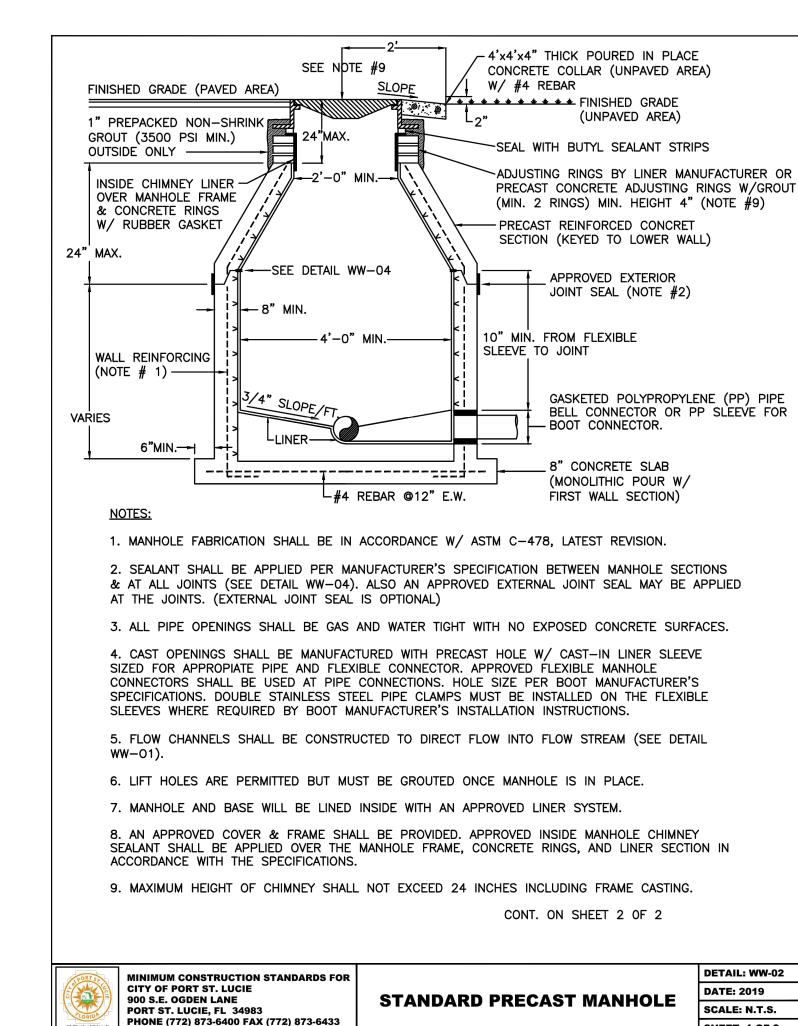


PHONE (772) 873-6400 FAX (772) 873-6433

1. THE ENGINEER-OF-RECORD SHALL SUBMIT TO PSLUSD THE SHOP DRAWINGS FOR EACH STRUCTURE, PROVIDING THE DIAMETER OF EACH PIPE, INVERT ELEVATION OF EACH PIPE, RIM ELEVATION AND THE NUMBER OF DEGREES BETWEEN PIPES. (15 DEGREE INCREMENTS IF POSSIBLE)

2. MANHOLE INTERIOR SHALL BE LINED UTILIZING A CORROSION BARRIER SYSTEM. LISTED ON THE PSLUSD QUALIFIED PRODUCT LIST.

3. MANHOLE EXTERIOR SHALL BE COATED WITH A PRIMER AND TWO COATS OF A WATER BASED EPOXY 3-5 MILS EACH PER THE PSLUSD SPECIFICATIONS. APPLICATION SHALL BE IN ACCORDANCE WITH THE MANUFACTURER'S SPECIFICATION.

	PORTS	MINIMUM CONSTRUCTION STANDARDS FOR	INVERT FLOW CHANNELS	DETAIL: WW-01
		CITY OF PORT ST. LUCIE 900 S.E. OGDEN LANE PORT ST. LUCIE, FL 34983 PHONE (772) 873-6400 FAX (772) 873-6433	FOR MANHOLES	DATE: 2019
	CORIDA			SCALE: N.T.S.
	"A City for All Ages"			SHEET: 1 OF 1

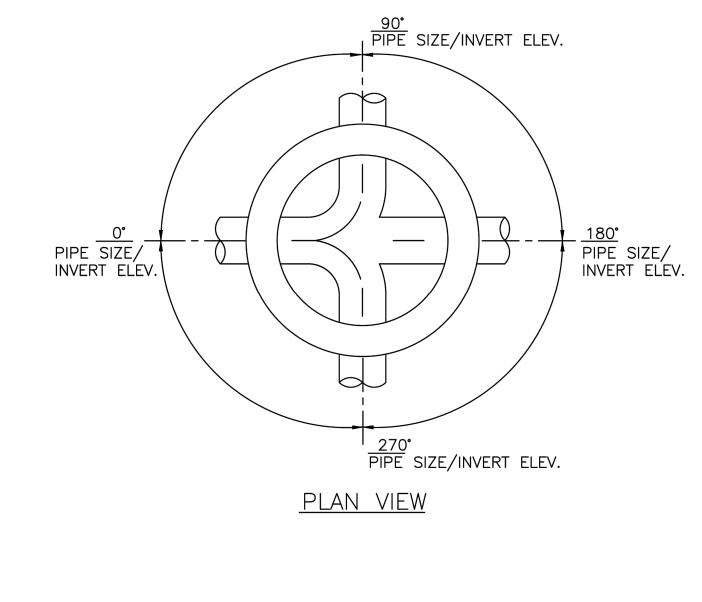

WYLDER POD 9

SHEET NUMBER

C-353

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VERTICAL DATUM ELEVATIONS SHOWN HEREON ARE BASED ON THE NORTH AMERICAN VERTICAL DATUM OF 1988 (NAVD '88). SUBTRACT 1.50' FROM NGVD '29 ELEVATION TO GET THE NAVD '88 ELEVATION.

CITY OF PORT ST. LUCIE PROJECT #

P22-301 / P23-153

11-642-06


CALL 48 HOURS


IT'S THE LAW!


DIAL 811


- 1. A DROP CONNECTION IS REQUIRED WHENEVER AN INFLUENT INVERT IS LOCATED 2' OR HIGHER THAN THE DOWNSTREAM INVERT CHANNEL. MANHOLES WITH A DROP 2.0 FEET OR LESS SHALL BE IN ACCORDANCE WITH DETAIL WW-02.
- 2. MANHOLE CONSTRUCTION SHALL BE IN ACCORDANCE WITH DETAIL WW-02.
- 3. PVC SDR 26 PIPE WITH PVC SDR 26 FITTINGS SHALL BE UTILIZED IN THE DROP ASSEMBLY.


PORTS	MINIMUM CONSTRUCTION STANDARDS FOR CITY OF PORT ST. LUCIE 900 S.E. OGDEN LANE PORT ST. LUCIE, FL 34983 PHONE (772) 873-6400 FAX (772) 873-6433	OUTSIDE DROP MANHOLE	DETAIL: WW-03
			DATE: 2019
CORIDA			SCALE: N.T.S.
"A City for All Ages"			SHEET: 1 OF 1

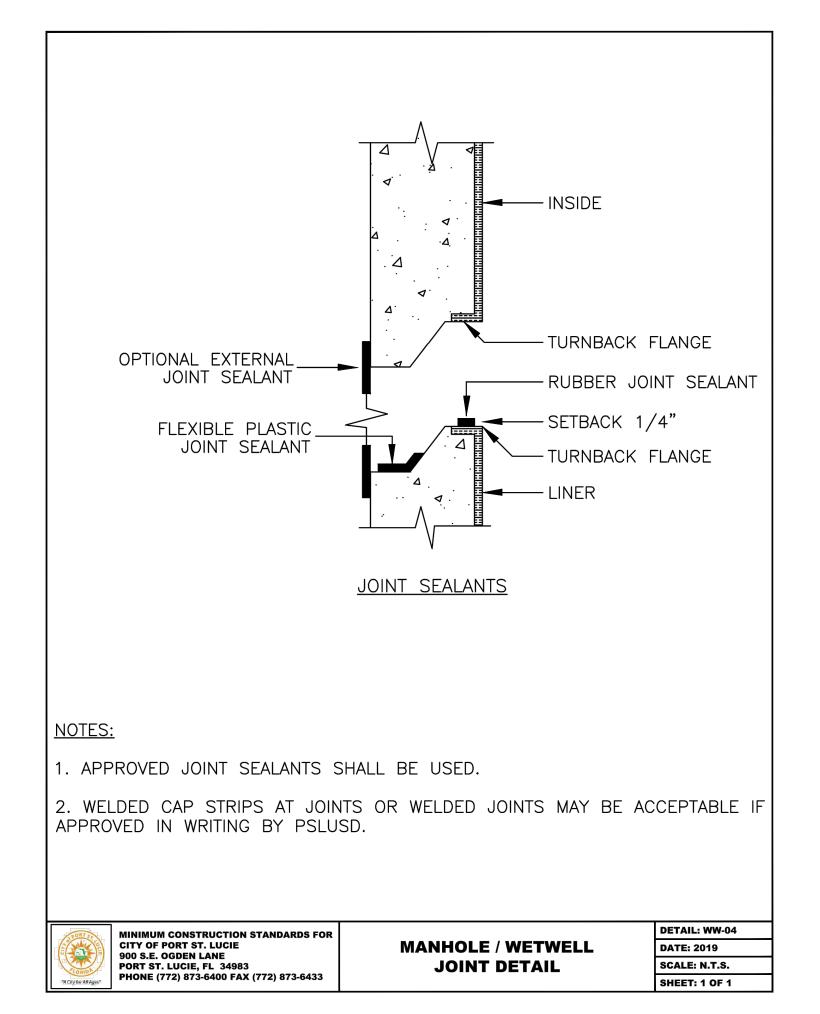


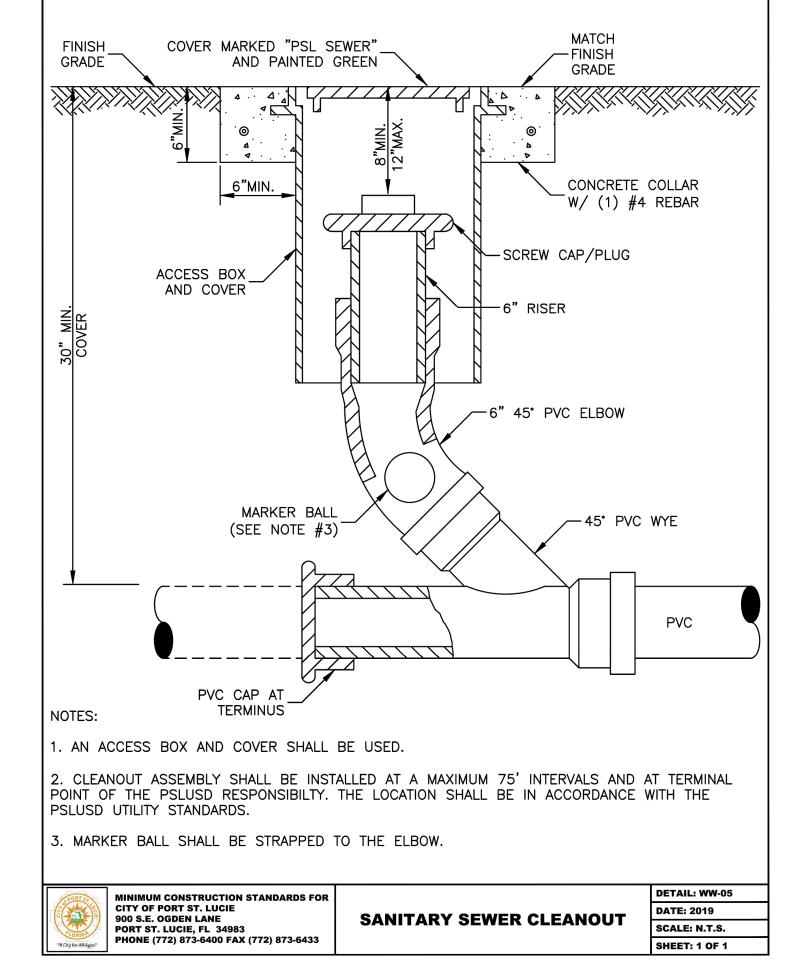

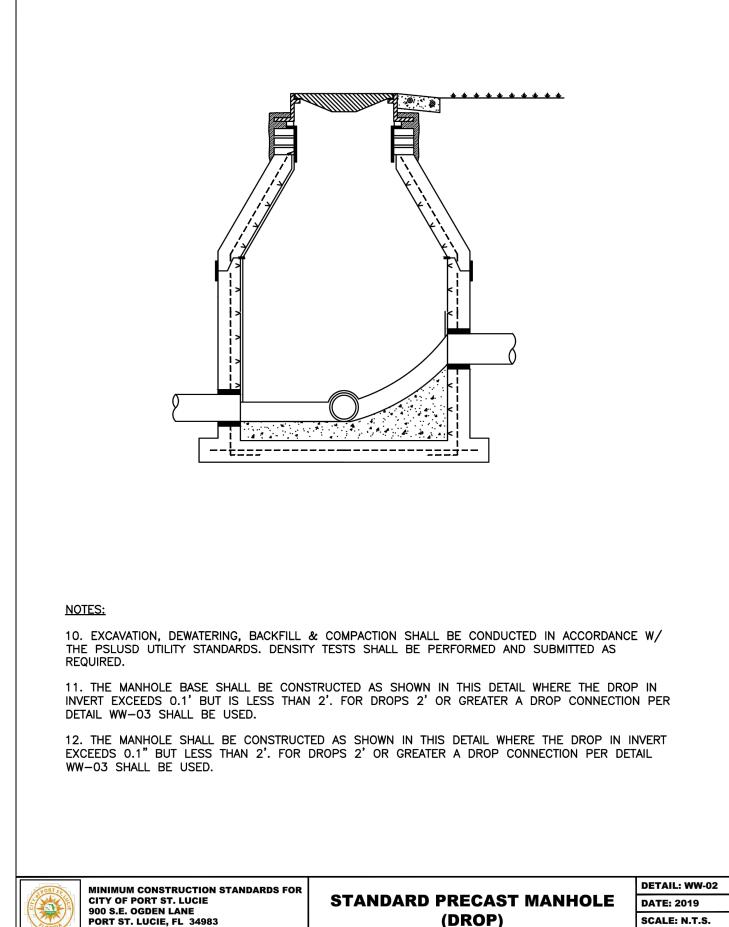

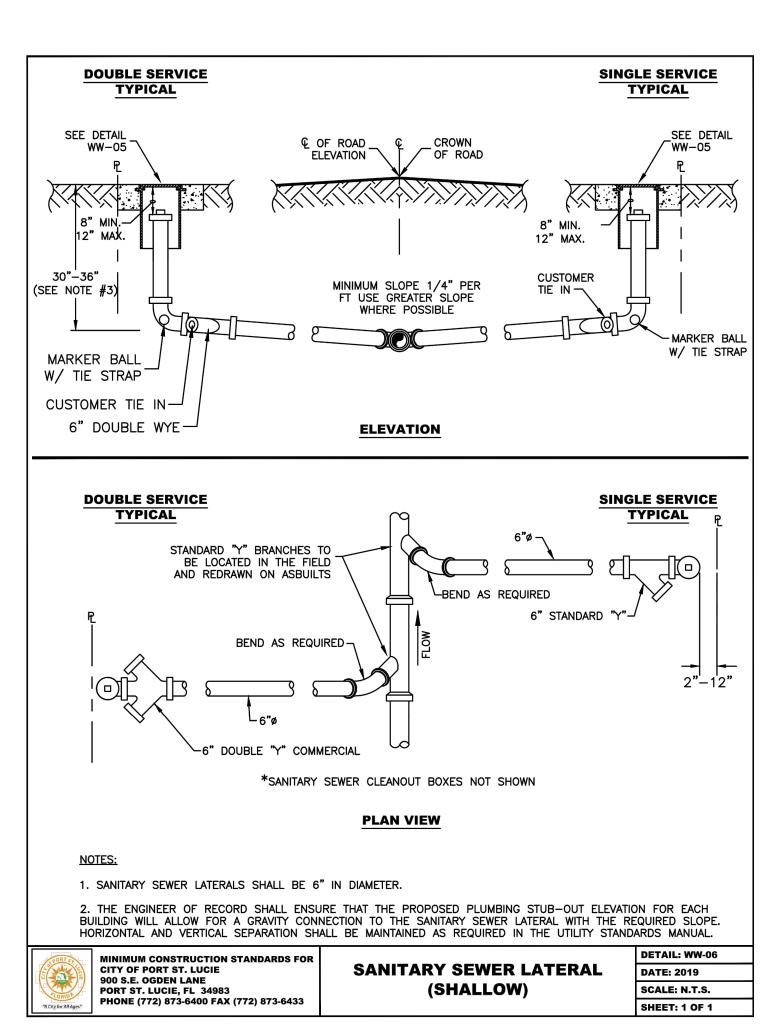

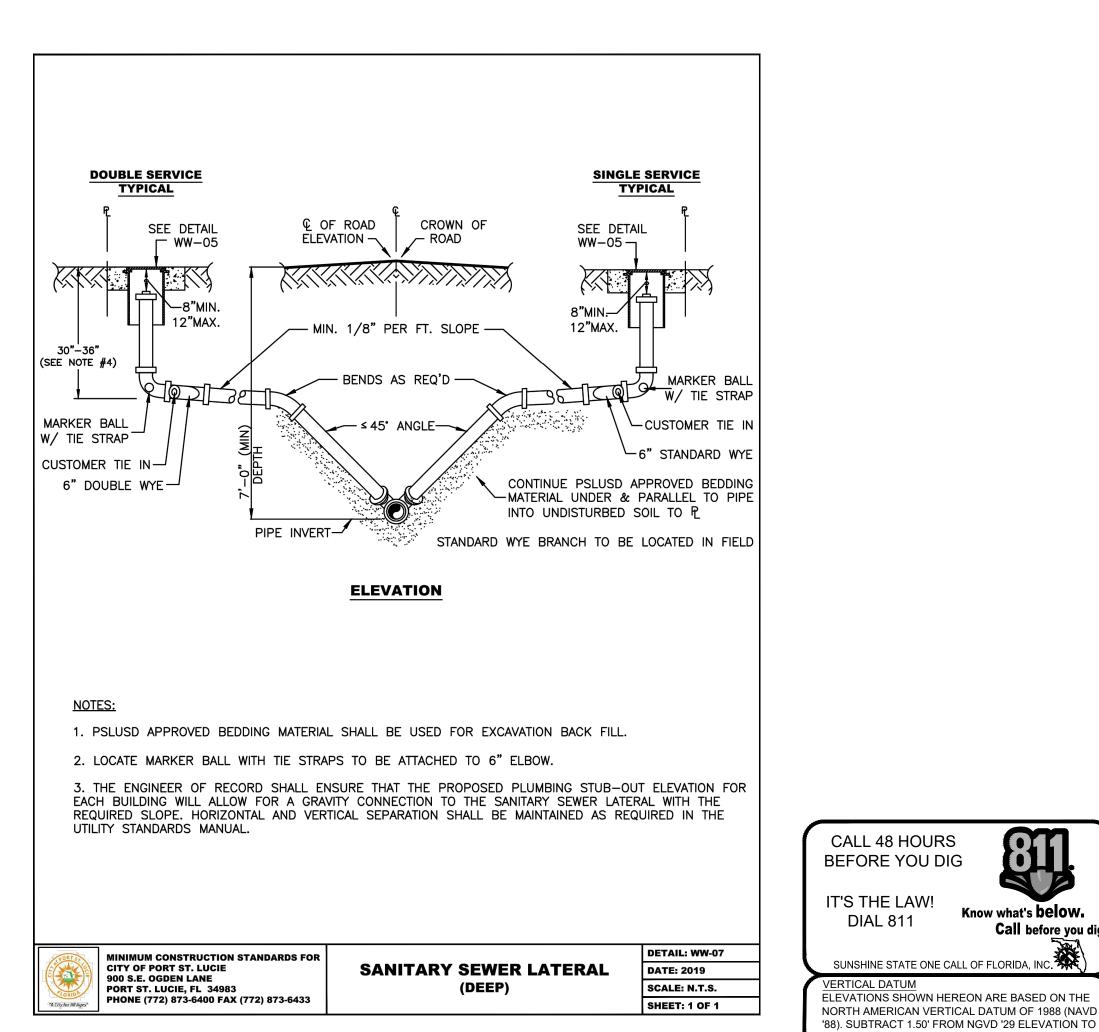

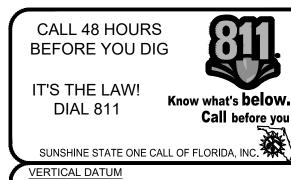

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GET THE NAVD '88 ELEVATION. CITY OF PORT ST. LUCIE PROJECT # P22-301 / P23-153


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SHEET: 2 OF 2




MINIMUM CONSTRUCTION STANDARDS FOR CITY OF PORT ST. LUCIE


900 S.E. OGDEN LANE PORT ST. LUCIE, FL 34983 PHONE (772) 873-6400 FAX (772) 873-6433


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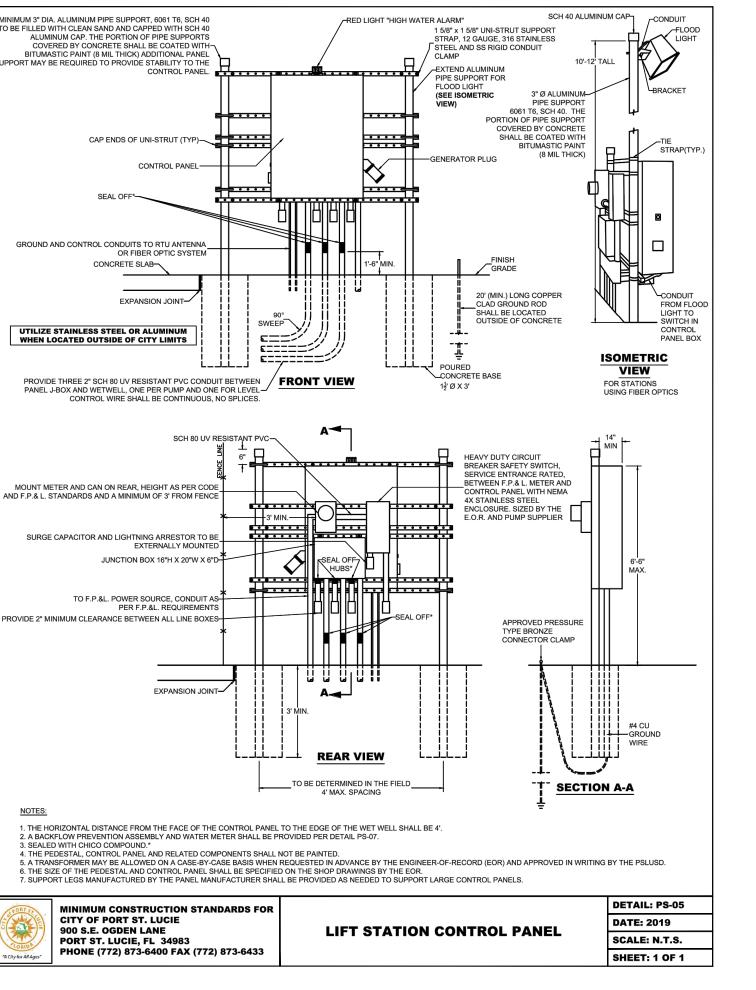
SHEET: 1 OF 3

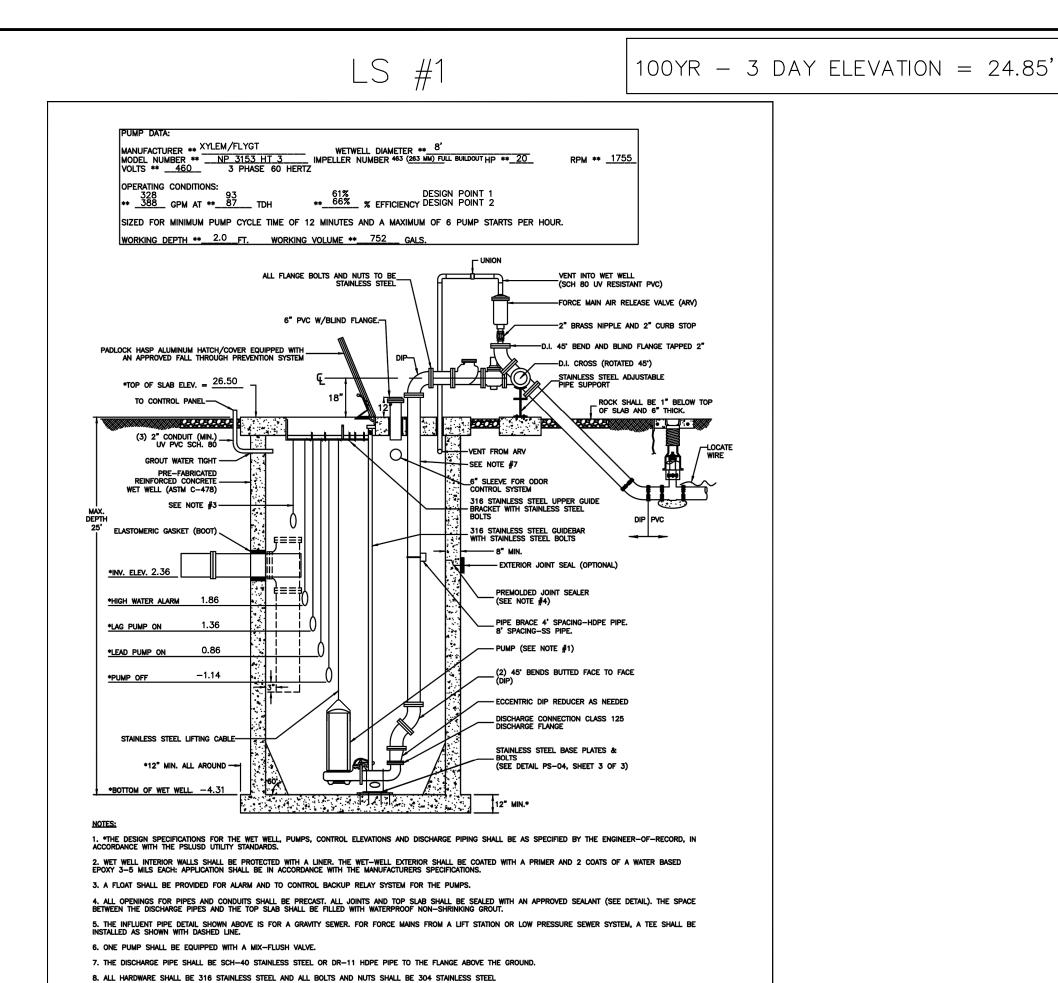LIFT STATION WET WELL SECTION SCALE: N.T.S.



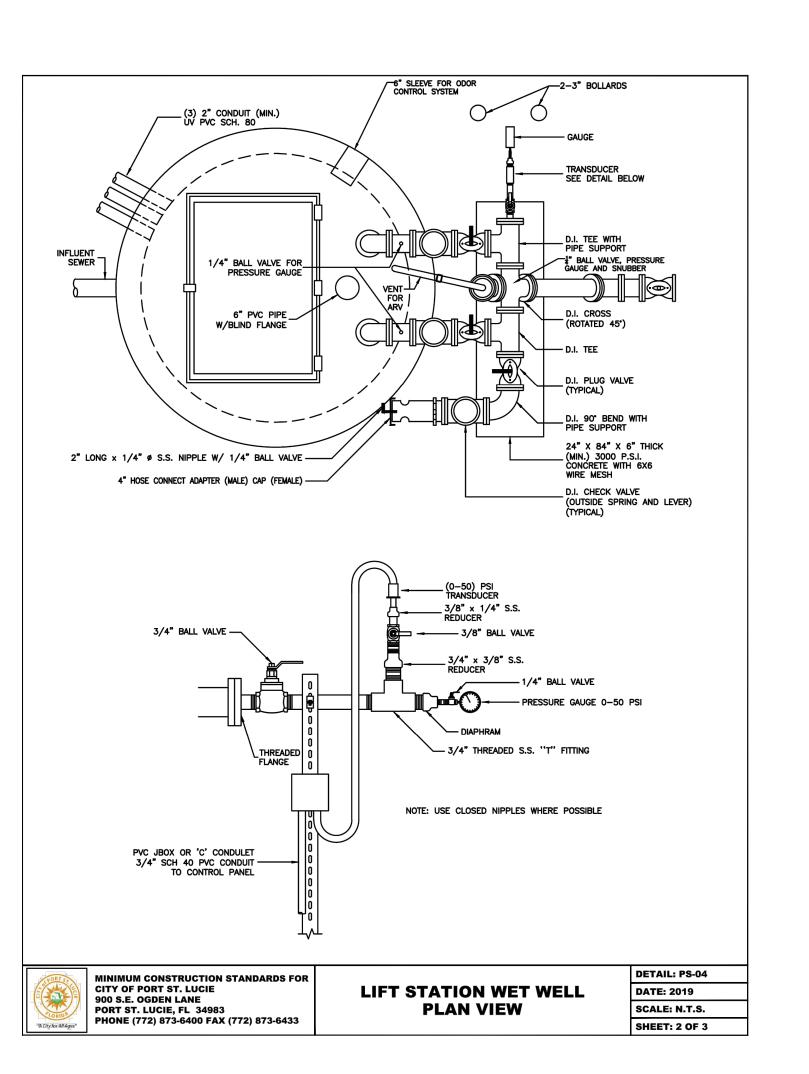

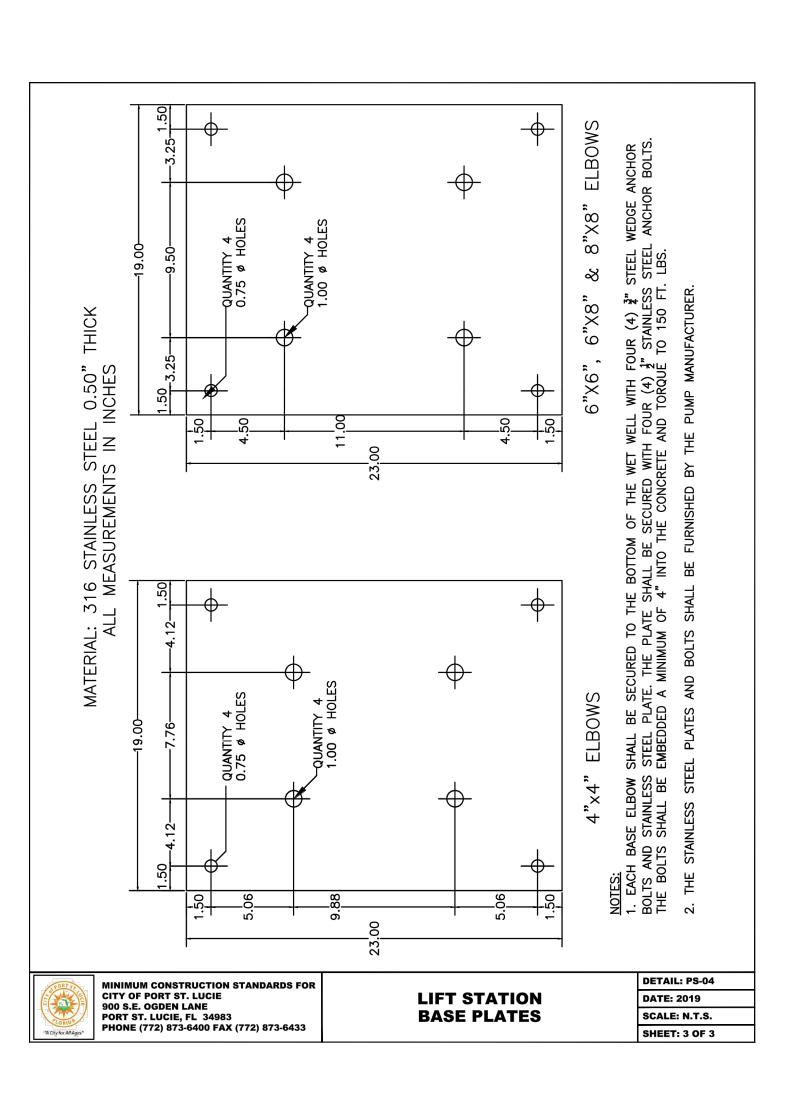

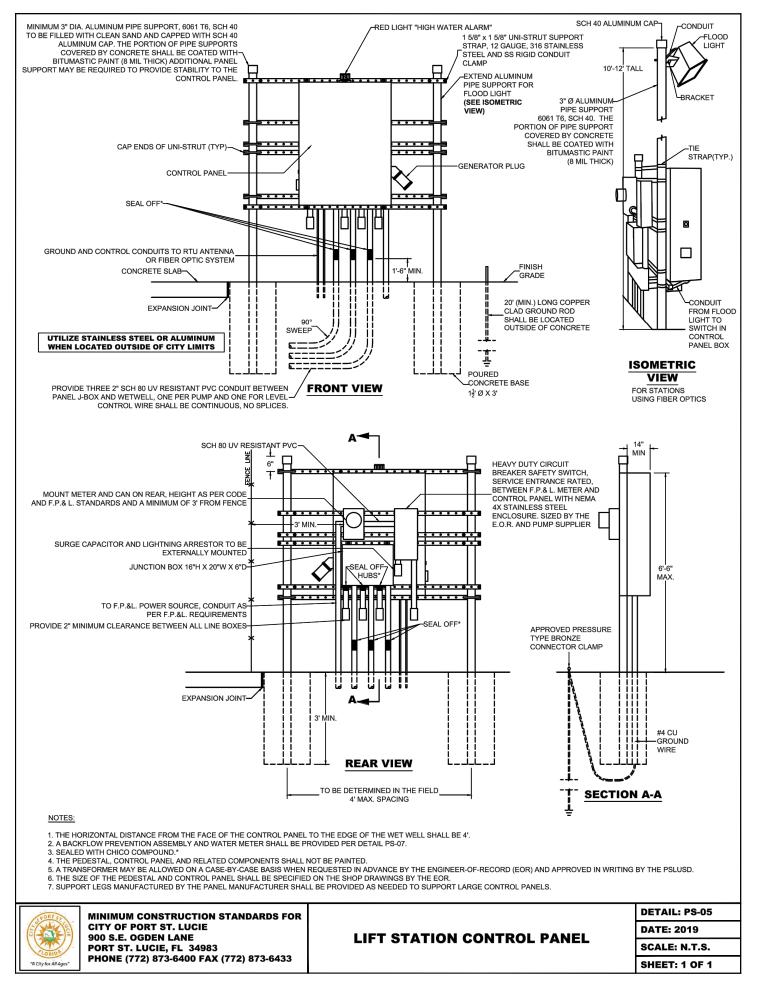



11-642-06


P22-301 / P23-153


SHEET NUMBER C-355


WYLDER
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PREPARED FOR
ADES DEVELOPERS, 1


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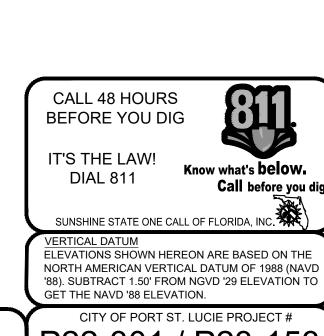
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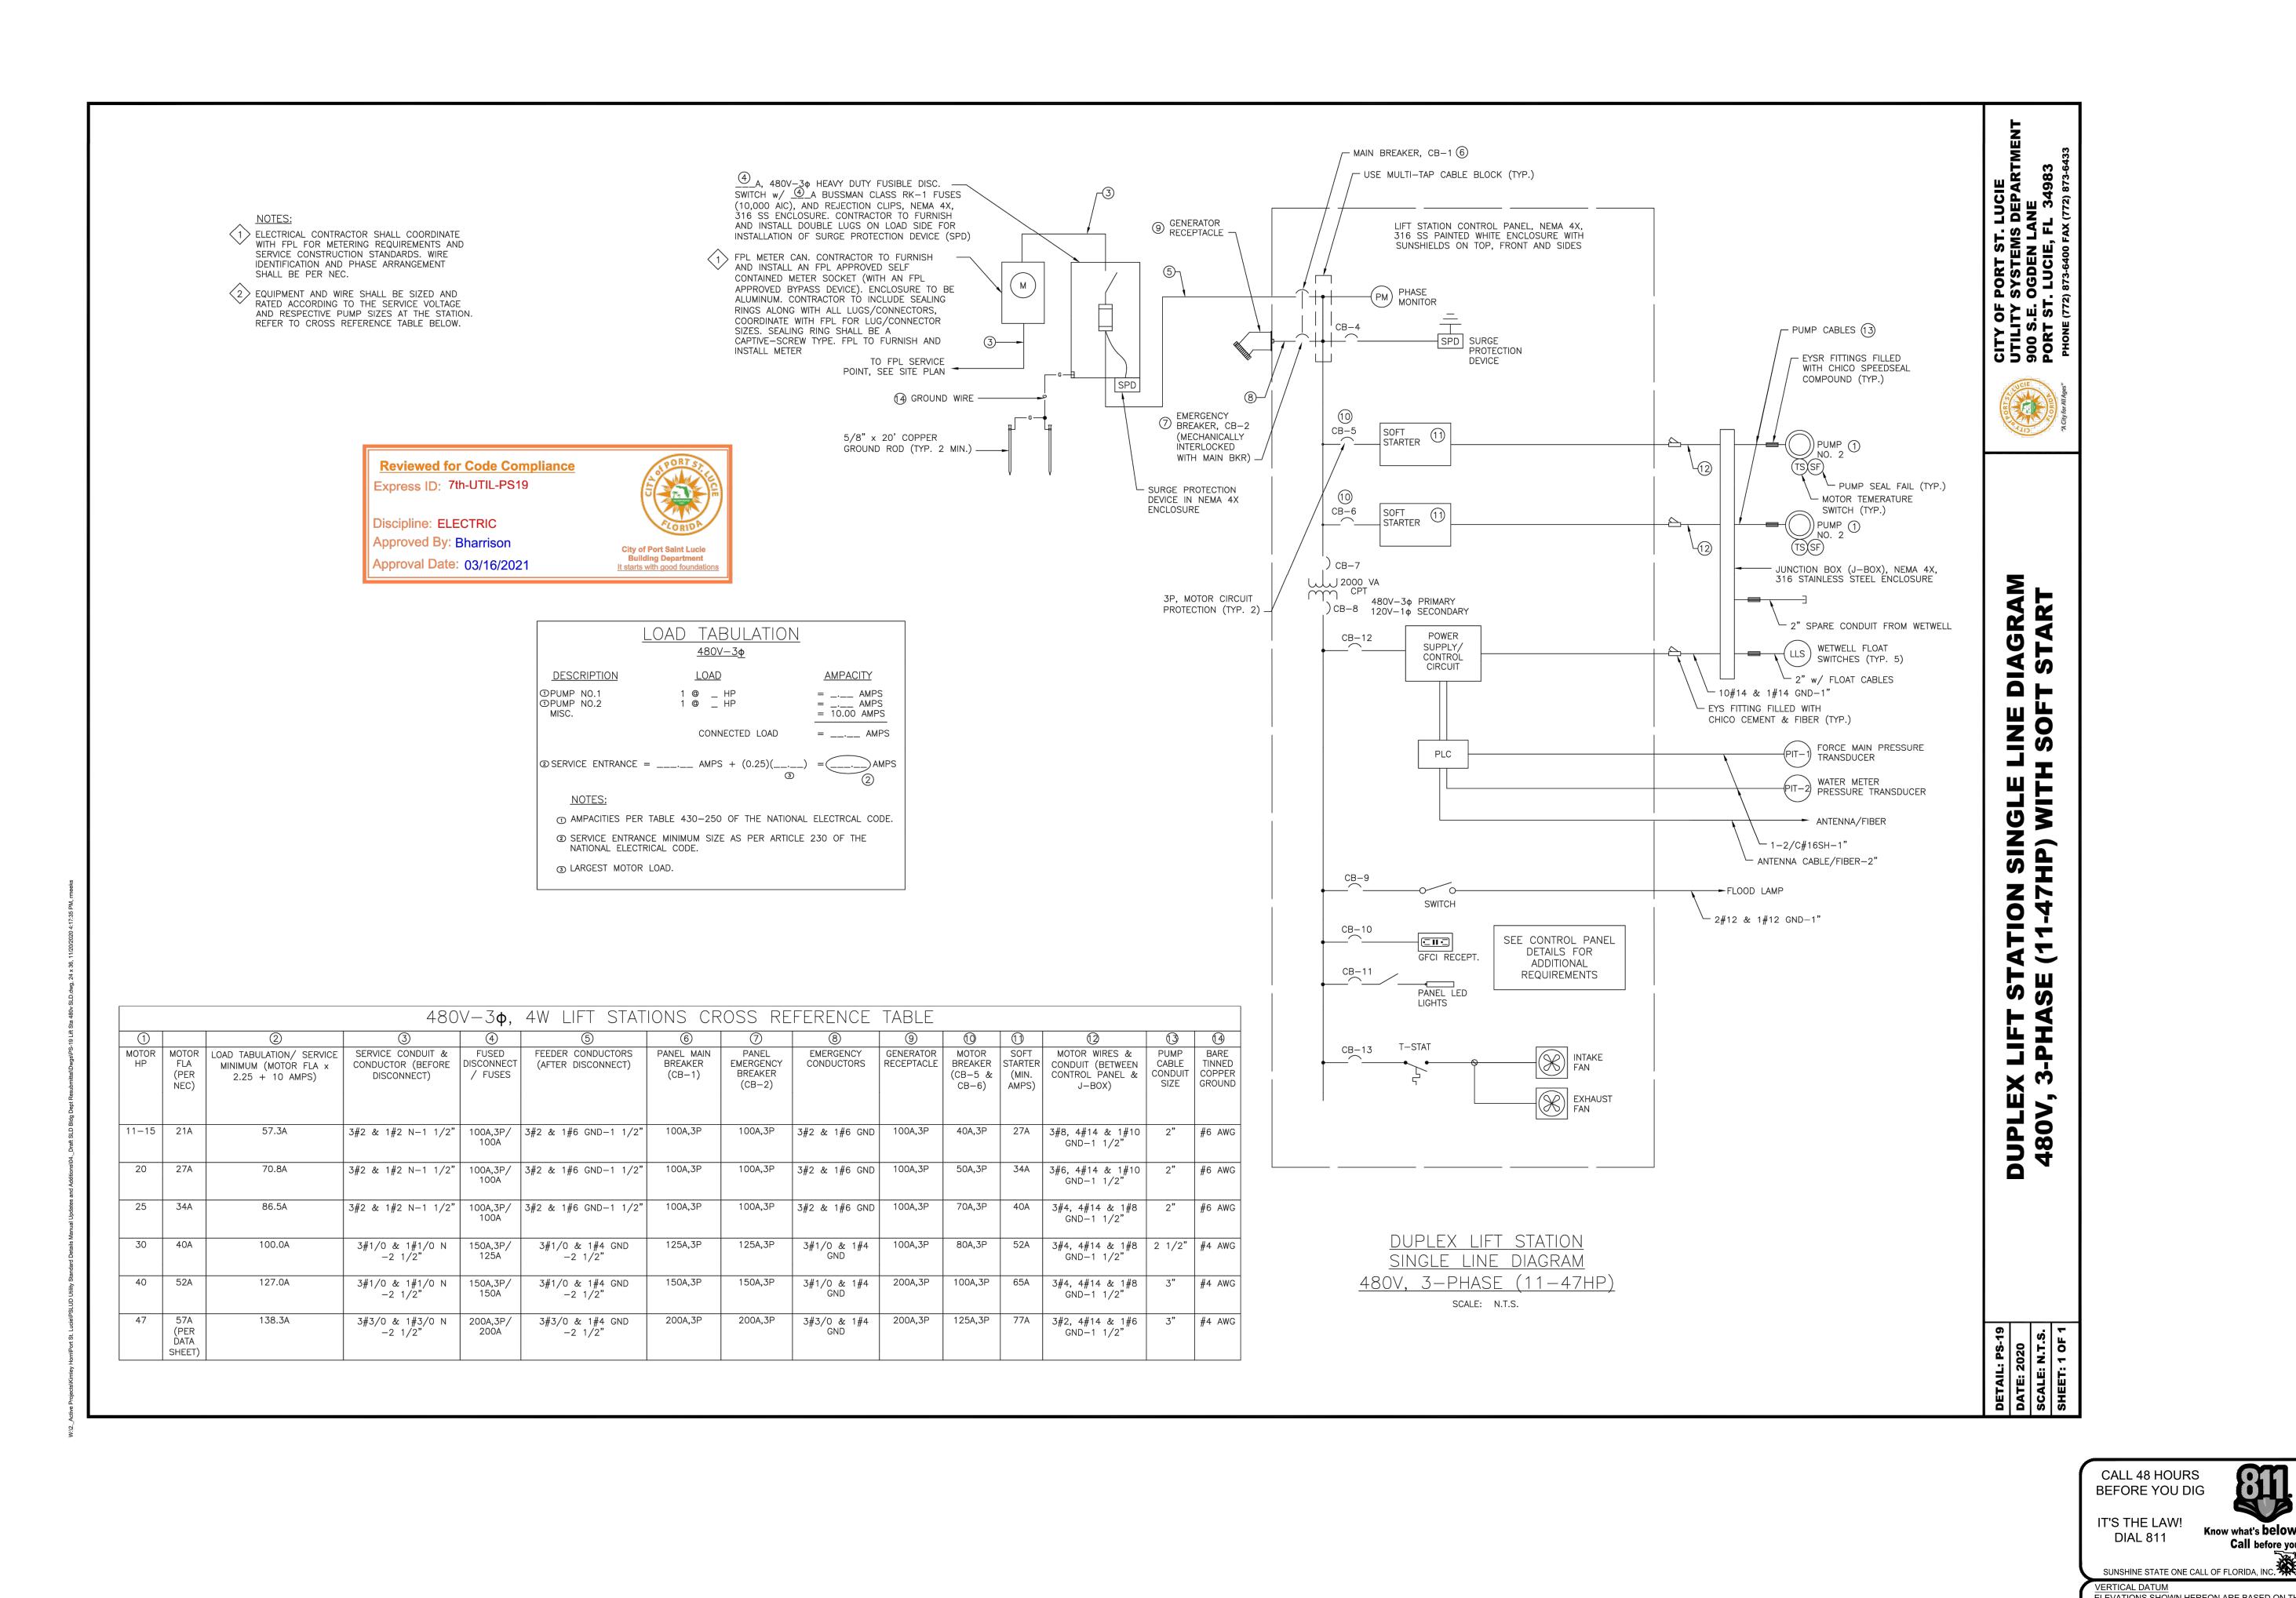
11-642-06 P22-301 / P23-153

C-356

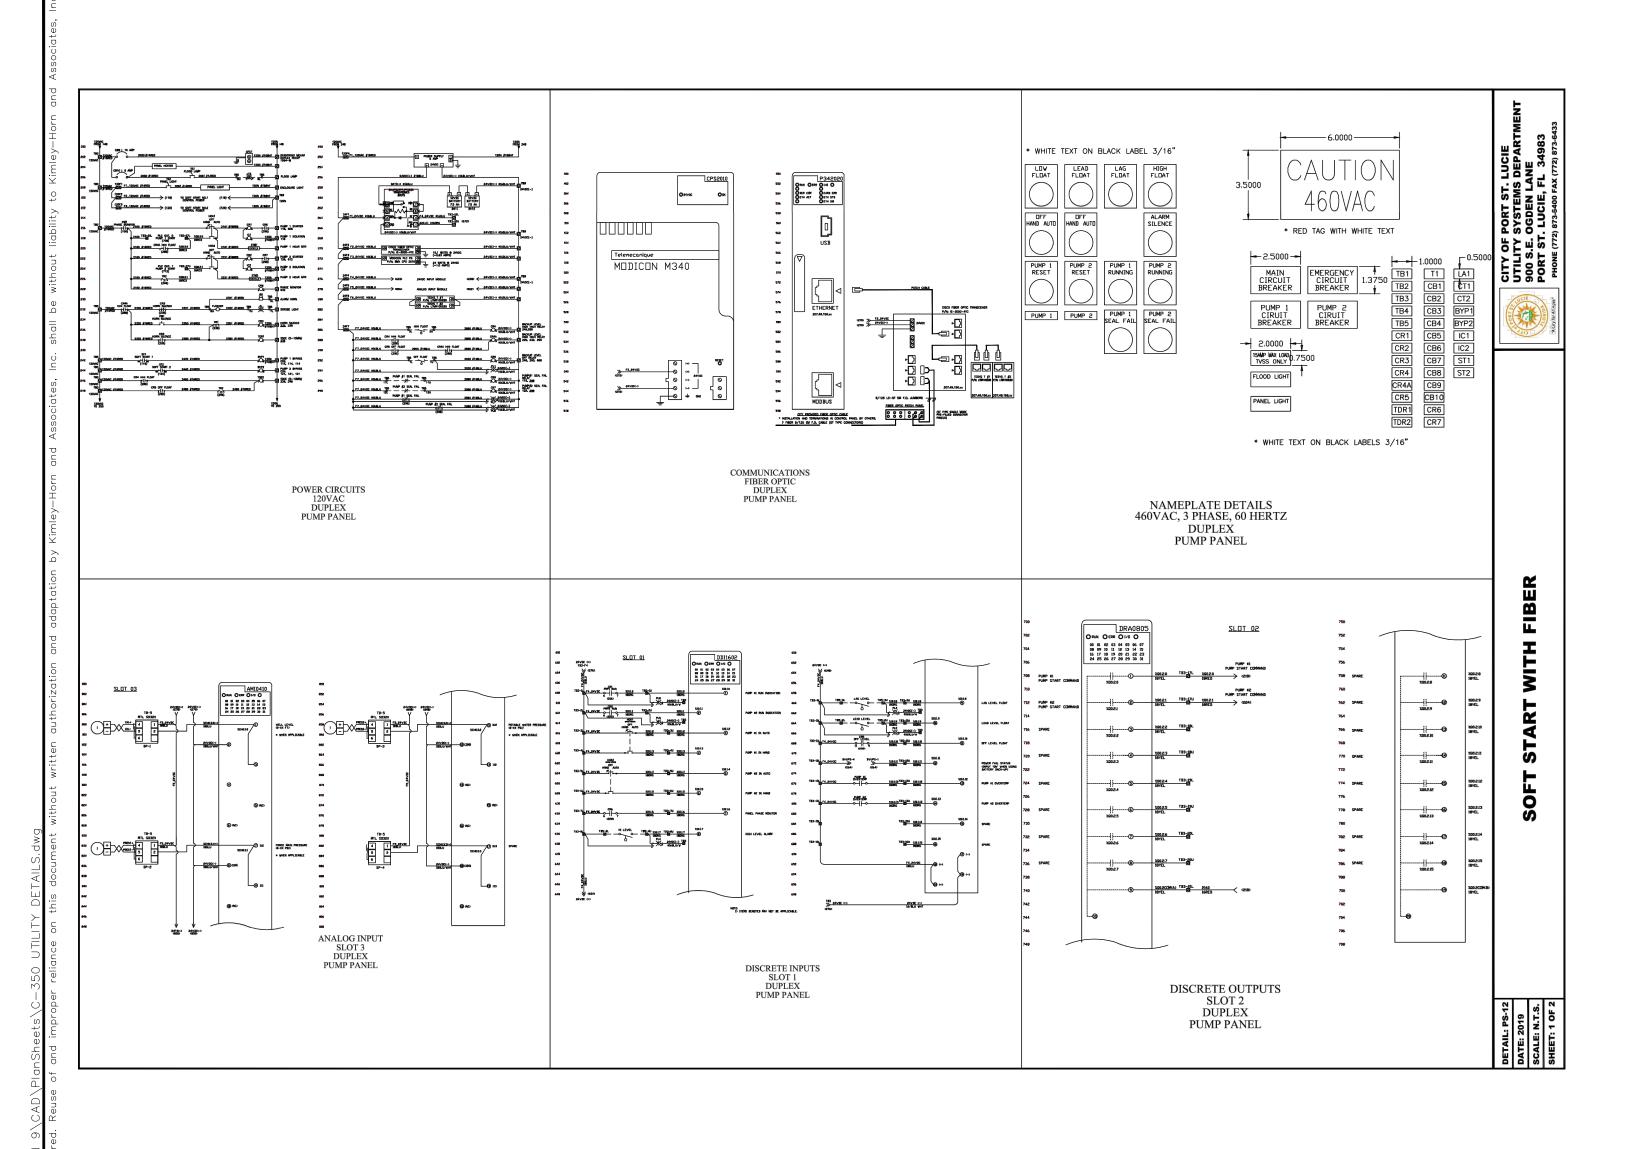4
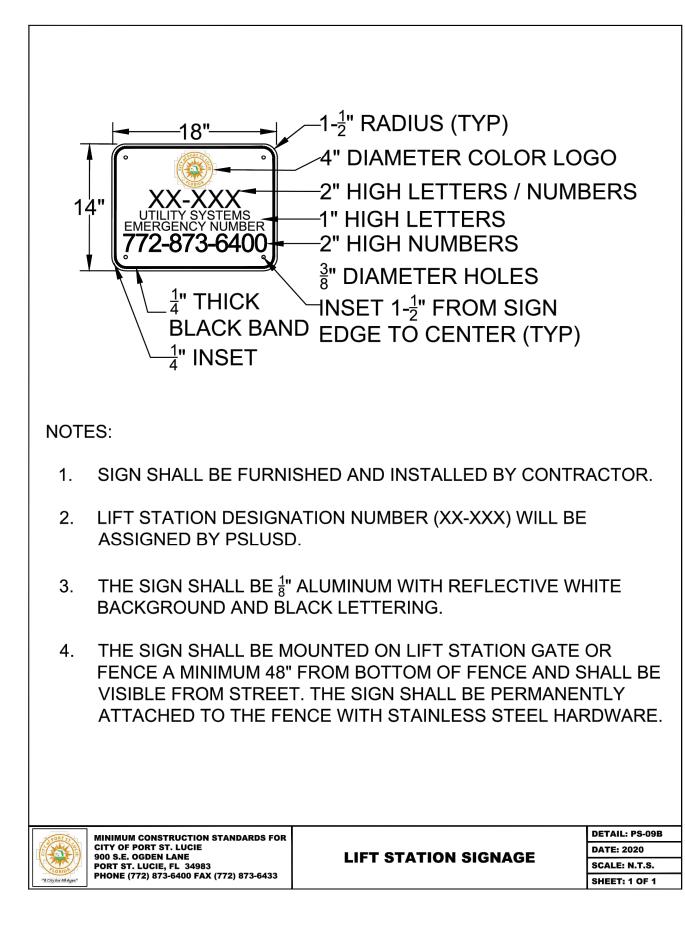
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PREPARED FOR
LADES DEVELOPERS, 1

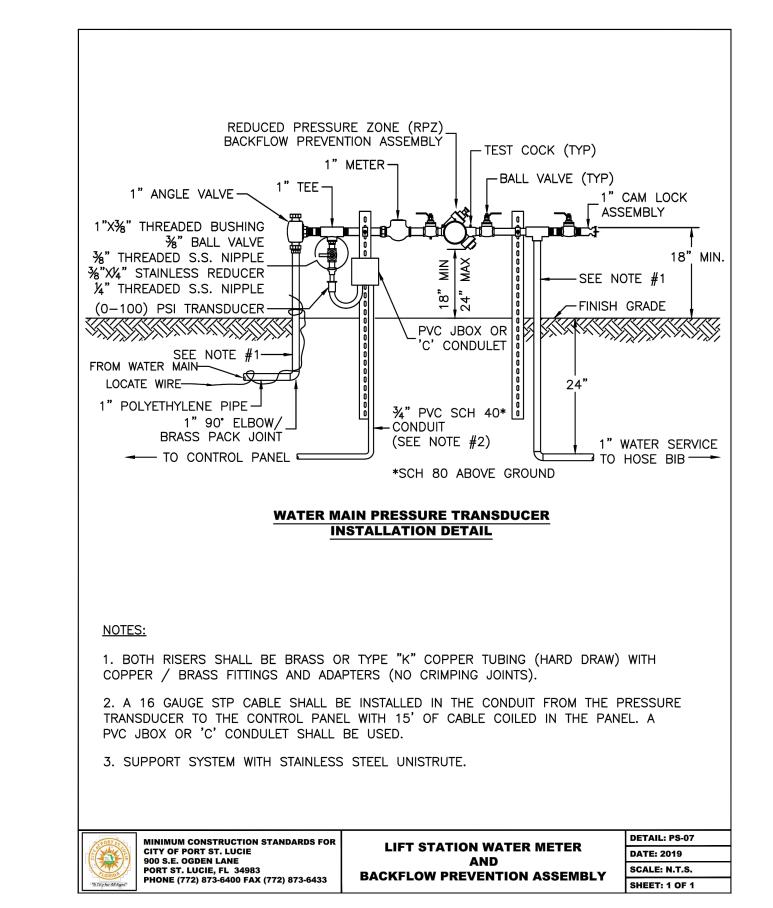SHEET NUMBER

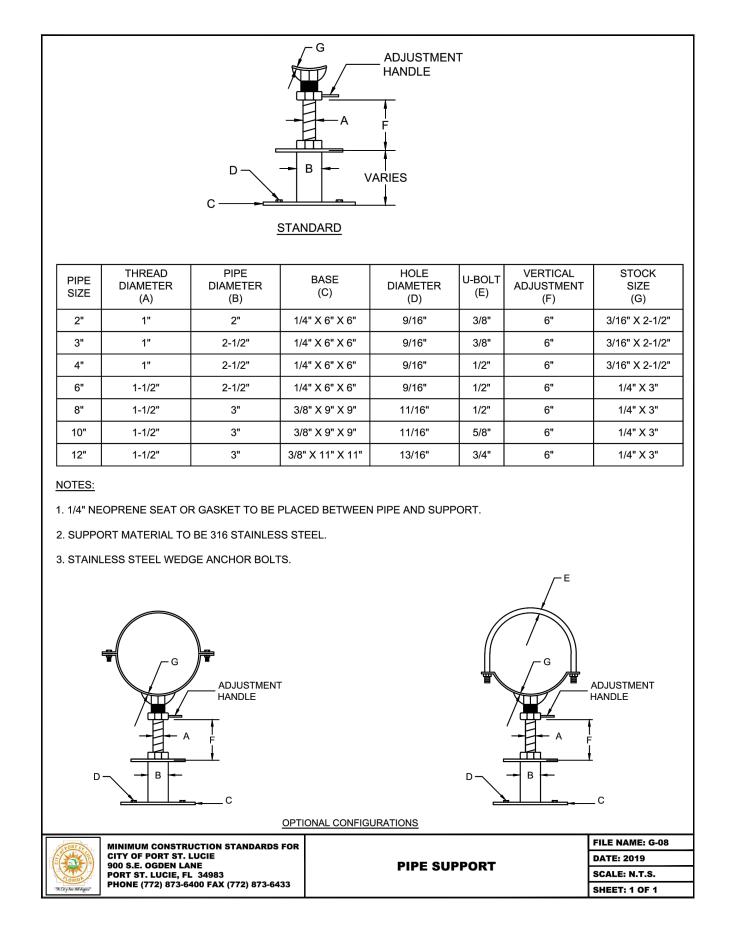C-357


Know what's **below.** Call before you dig.


ELEVATIONS SHOWN HEREON ARE BASED ON THE NORTH AMERICAN VERTICAL DATUM OF 1988 (NAVD '88). SUBTRACT 1.50' FROM NGVD '29 ELEVATION TO GET THE NAVD '88 ELEVATION.

CITY OF PORT ST. LUCIE PROJECT #

P22-301 / P23-153

11-642-06

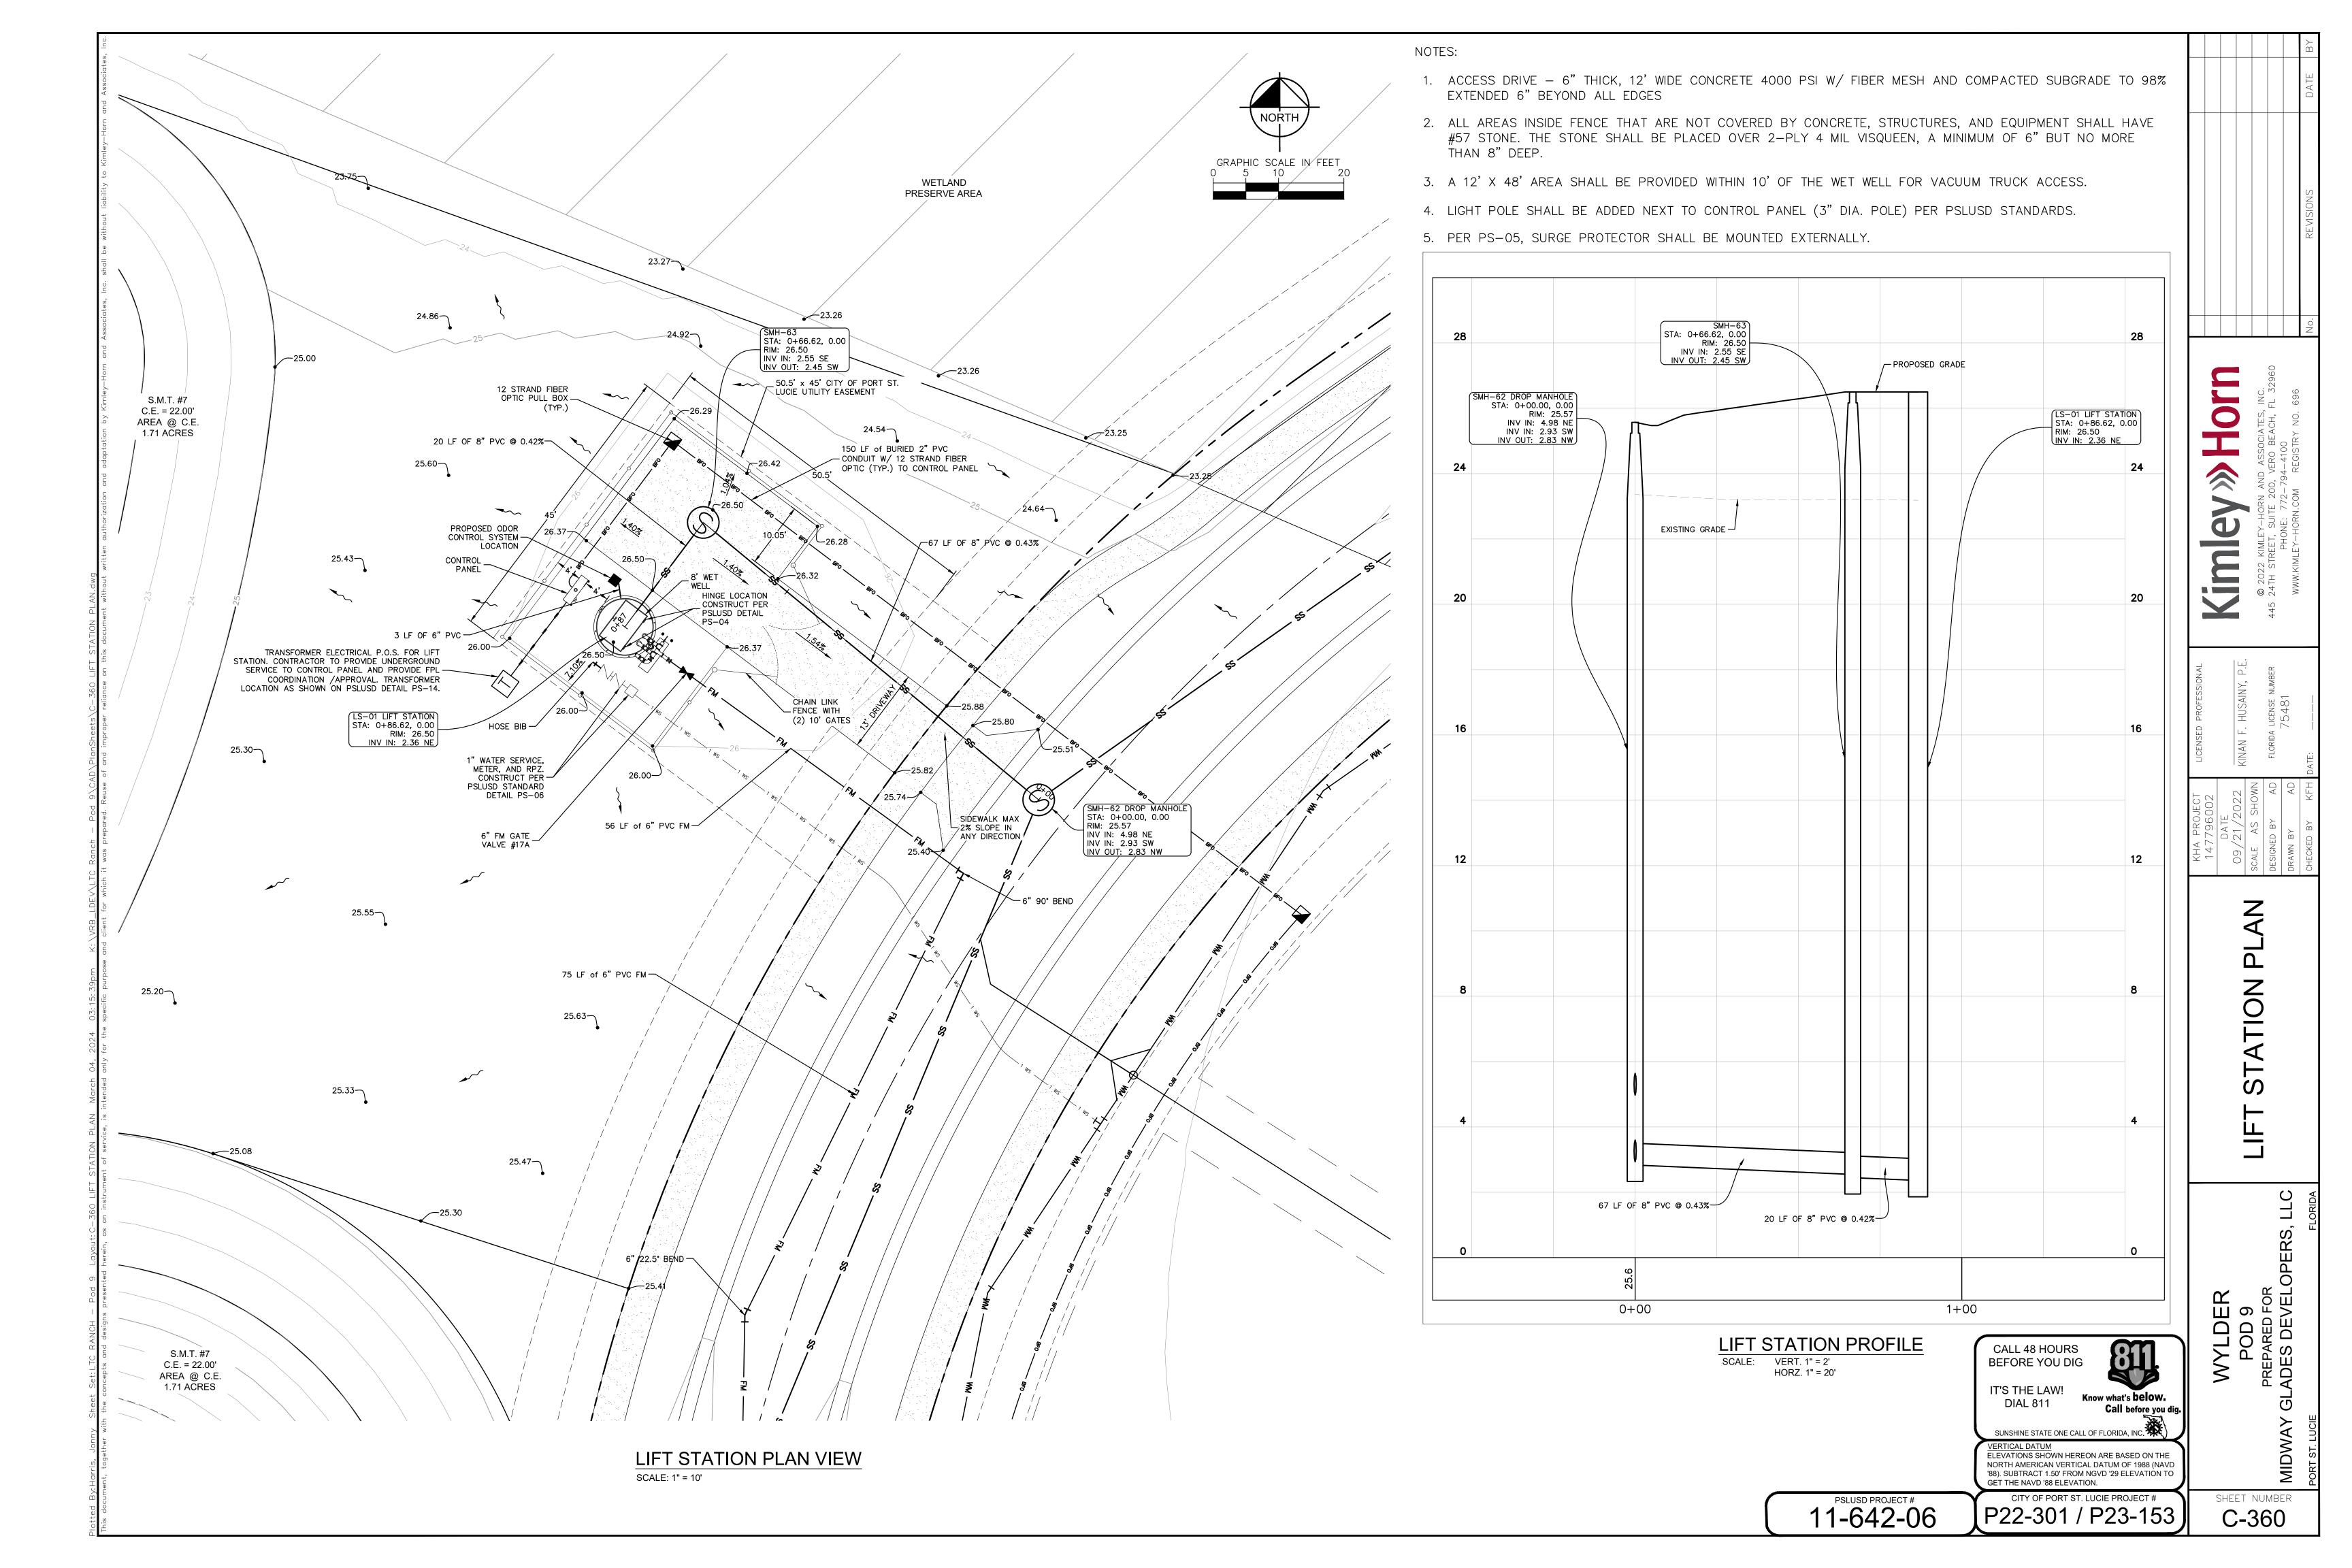

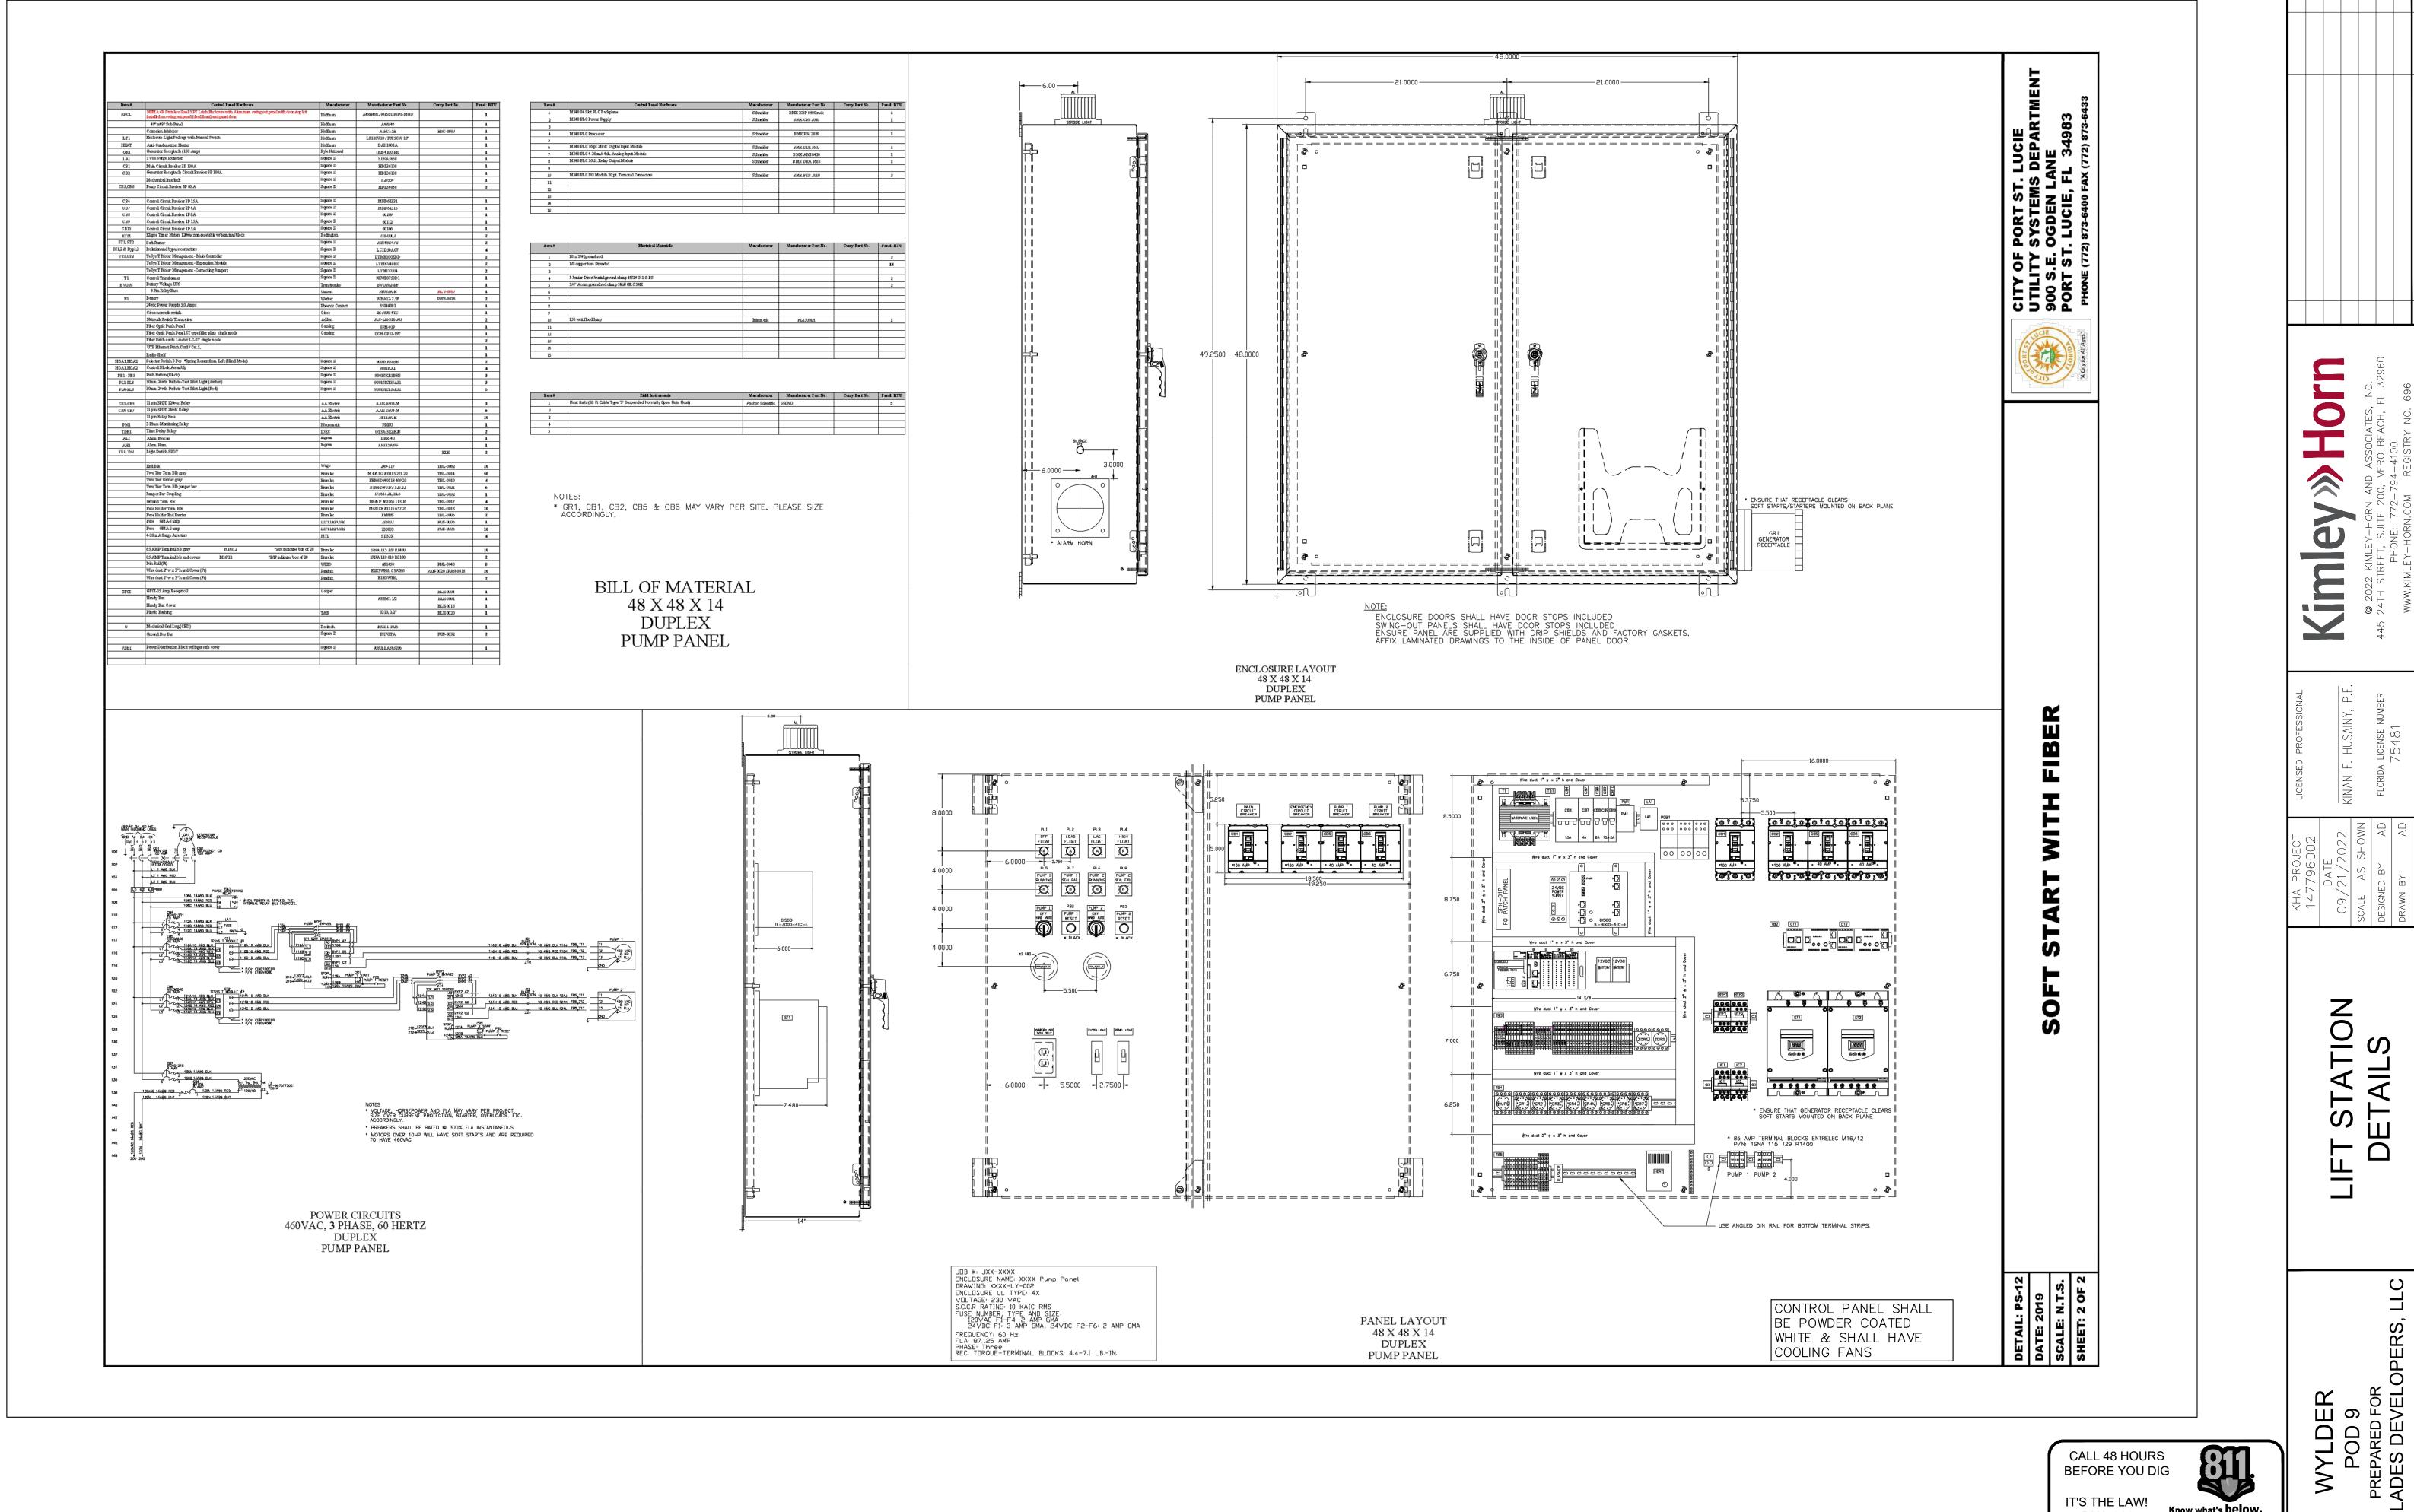

Know what's **below. DIAL 811** Call before you dig. SUNSHINE STATE ONE CALL OF FLORIDA, INC. VERTICAL DATUM ELEVATIONS SHOWN HEREON ARE BASED ON THE NORTH AMERICAN VERTICAL DATUM OF 1988 (NAVD '88). SUBTRACT 1.50' FROM NGVD '29 ELEVATION TO GET THE NAVD '88 ELEVATION.

CITY OF PORT ST. LUCIE PROJECT # 11-642-06 P22-301 / P23-153


SHEET NUMBER C-363


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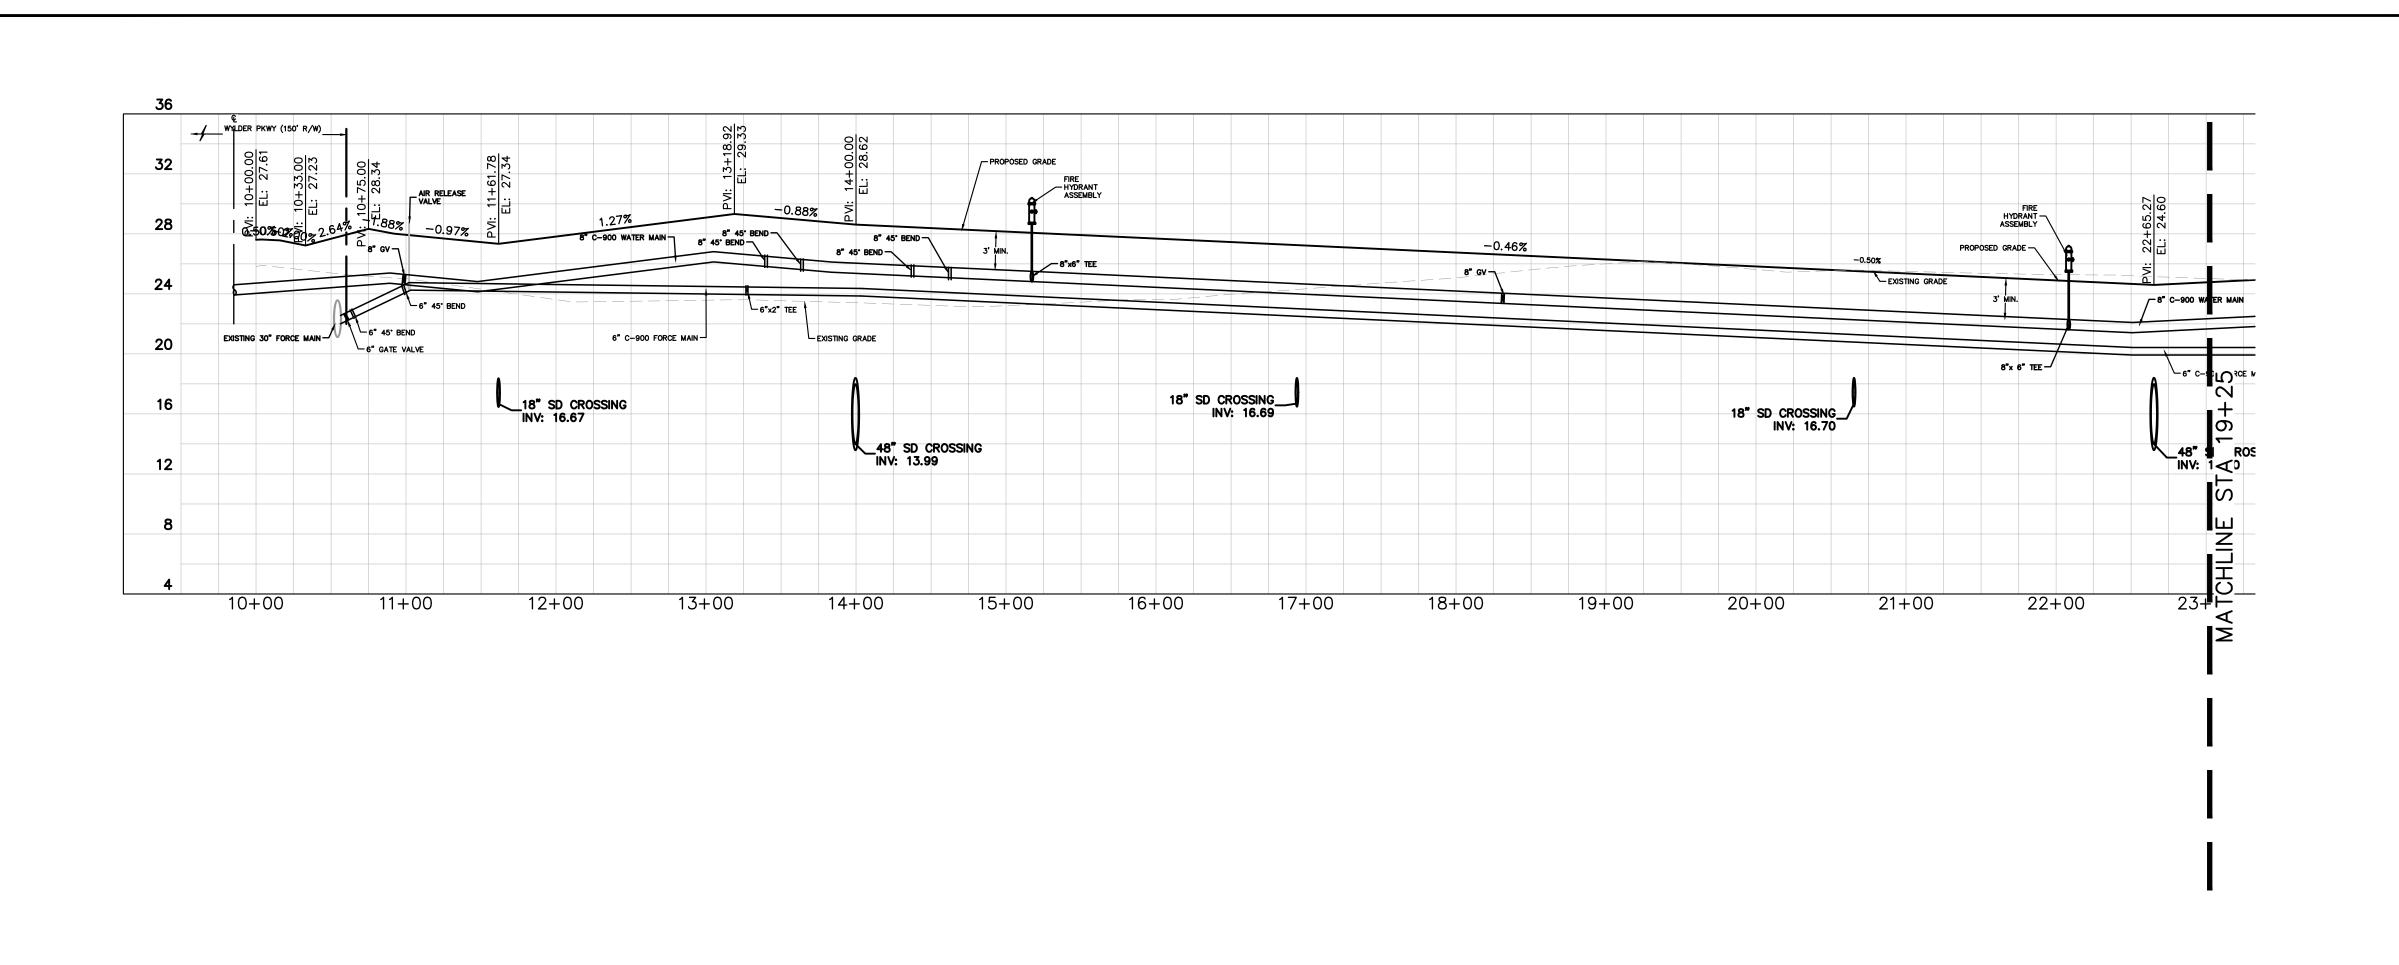
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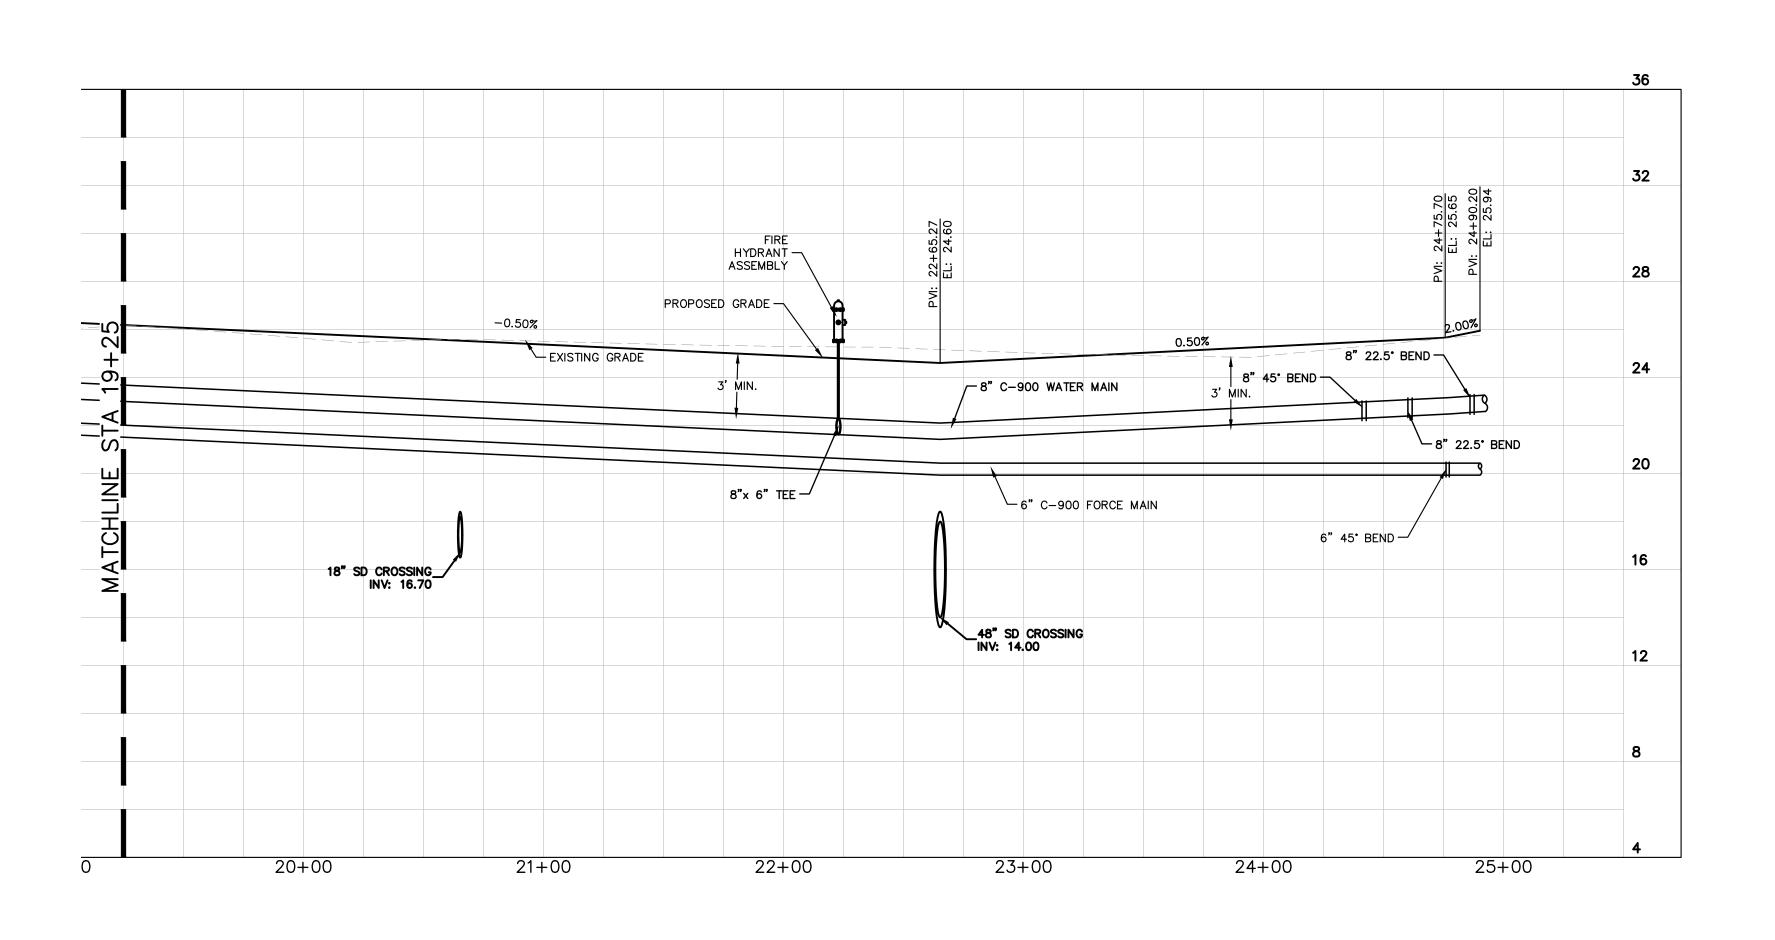
-T.S





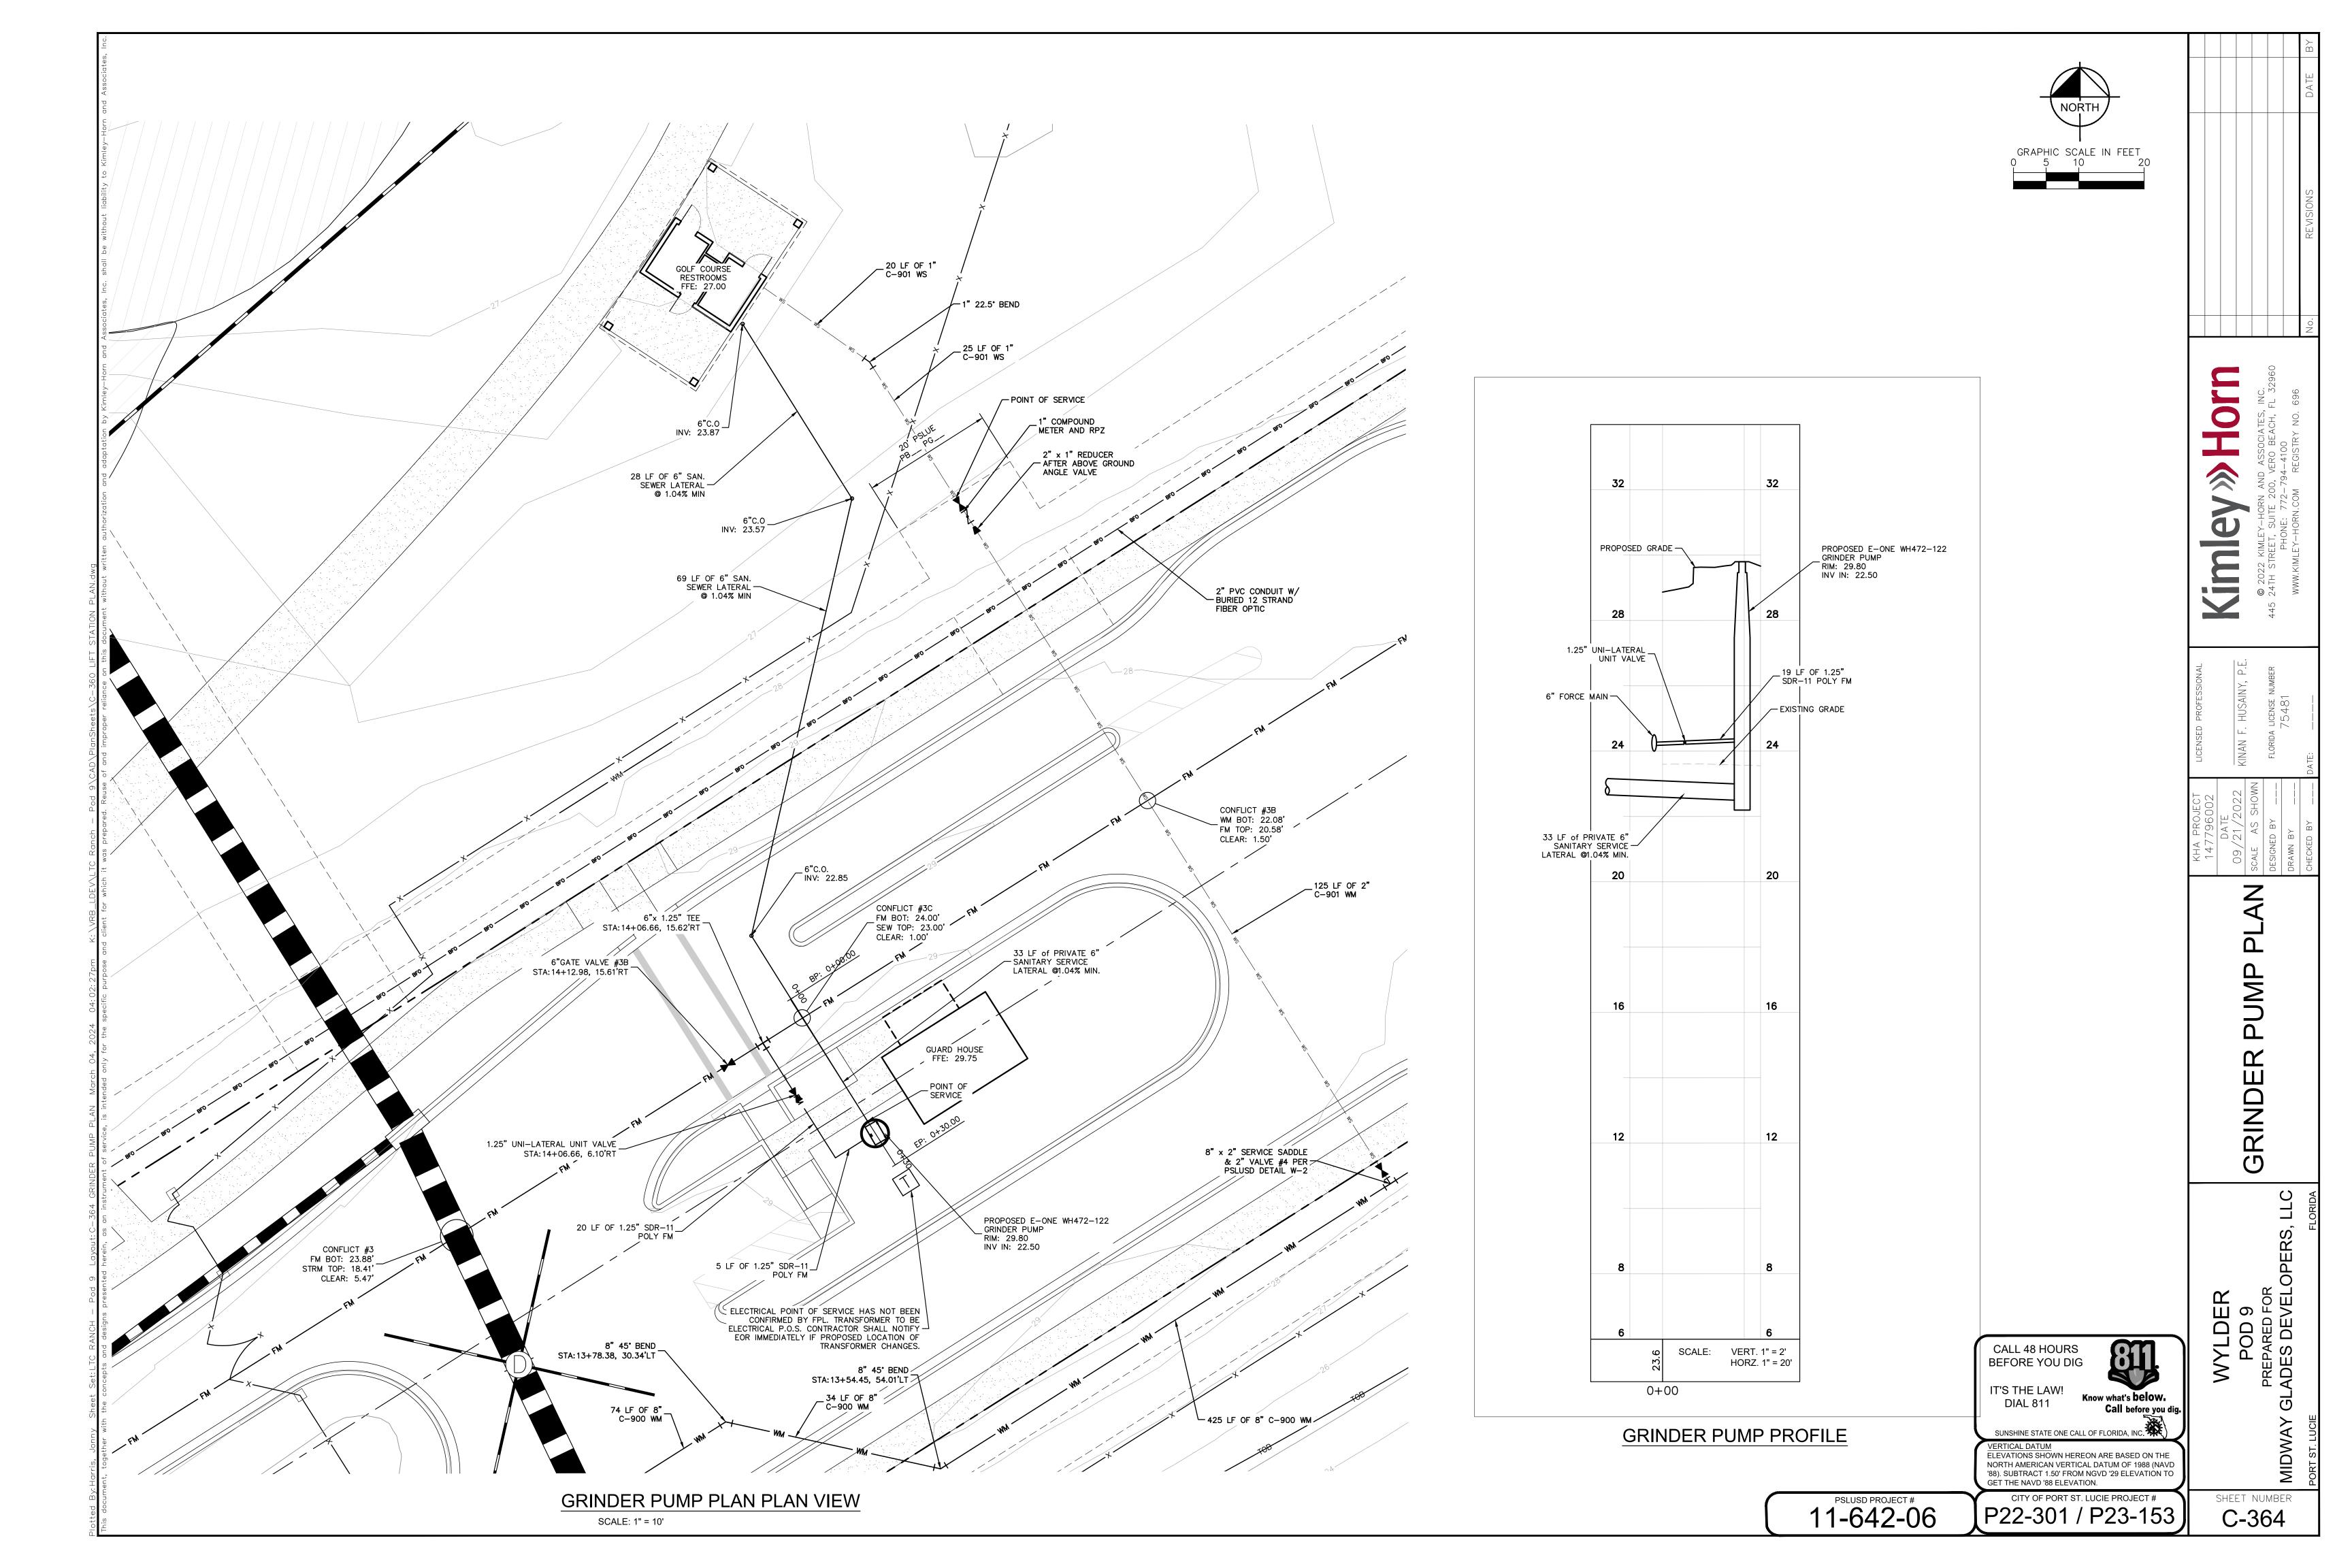

FURYK DRIVE FROM 10+00 to 19+25 H: 1"=40' V: 1"=4'

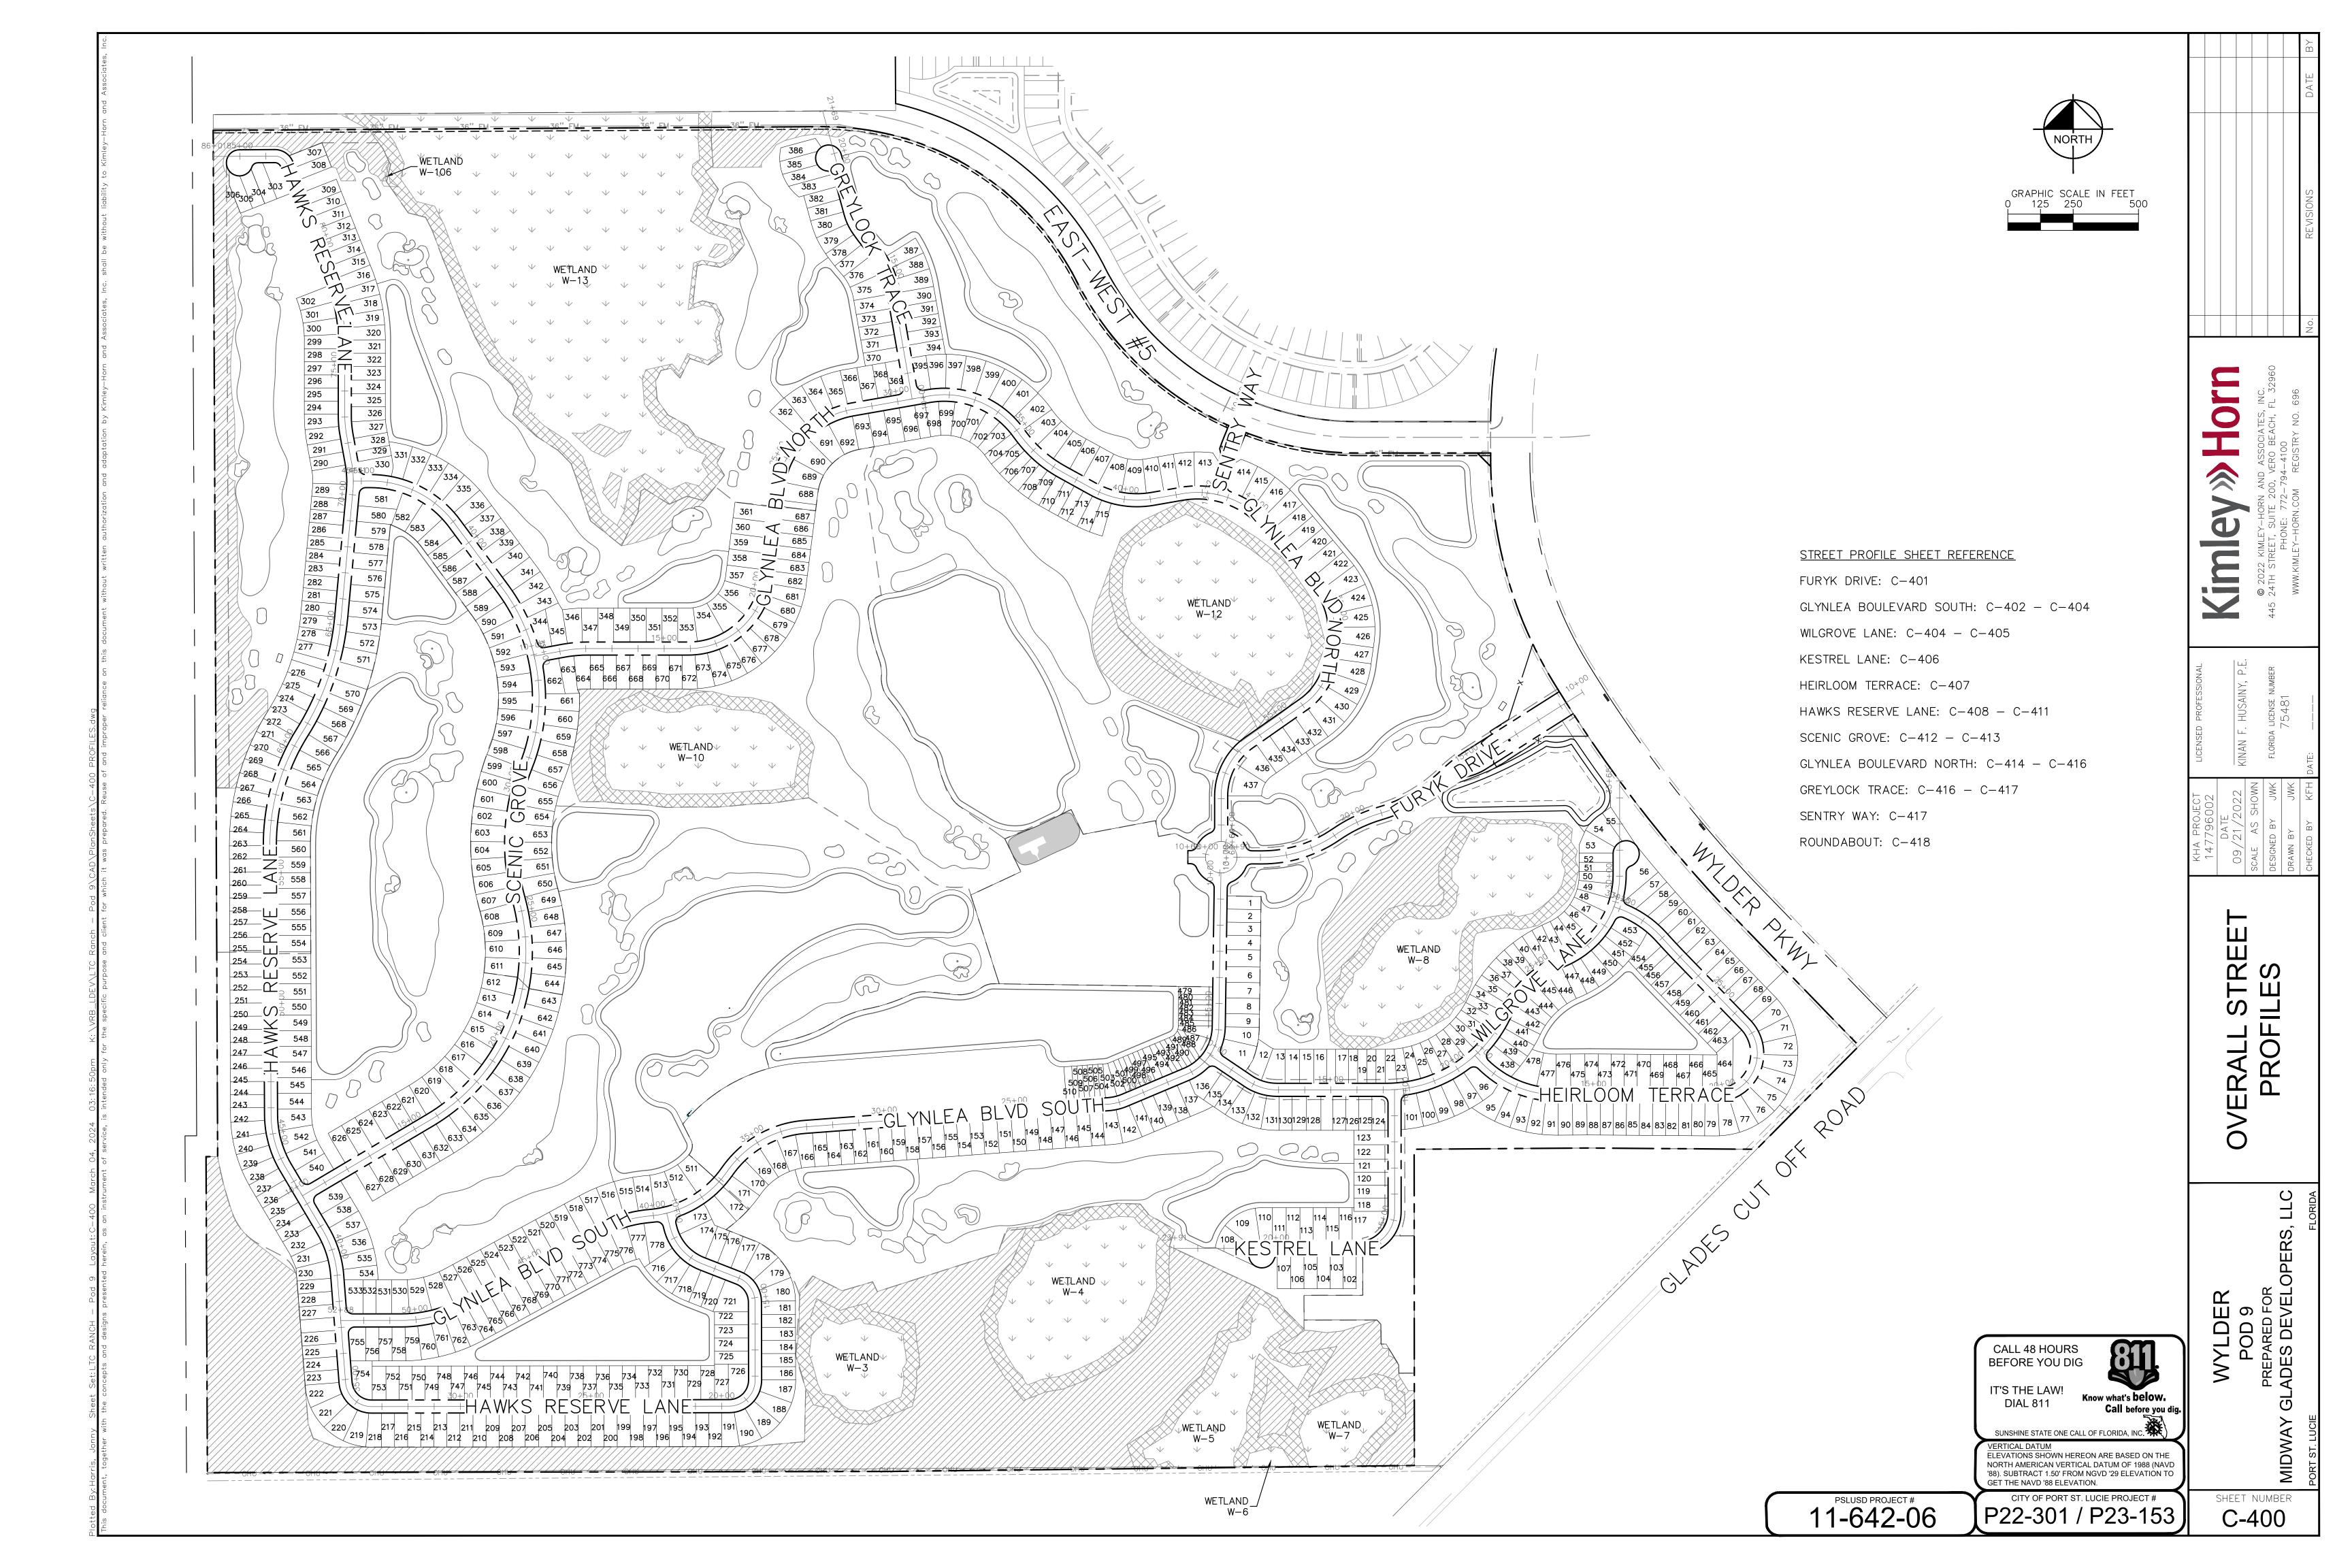

FURYK DRIVE FROM 19+25 to 24+90.20 H: 1"=40' V: 1"=4'


CALL 48 HOURS BEFORE YOU DIG IT'S THE LAW! DIAL 811 SUNSHINE STATE ONE CALL OF FLORIDA, INC. VERTICAL DATUM
ELEVATIONS SHOWN HEREON ARE BASED ON THE
NORTH AMERICAN VERTICAL DATUM OF 1988 (NAVD
'88). SUBTRACT 1.50' FROM NGVD '29 ELEVATION TO
GET THE NAVD '88 ELEVATION.

PSLUSD PROJECT # 11-642-06 P22-301 / P23-153


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PREPARED FOR
ADES DEVELOPERS, L

PROFILES

STREE

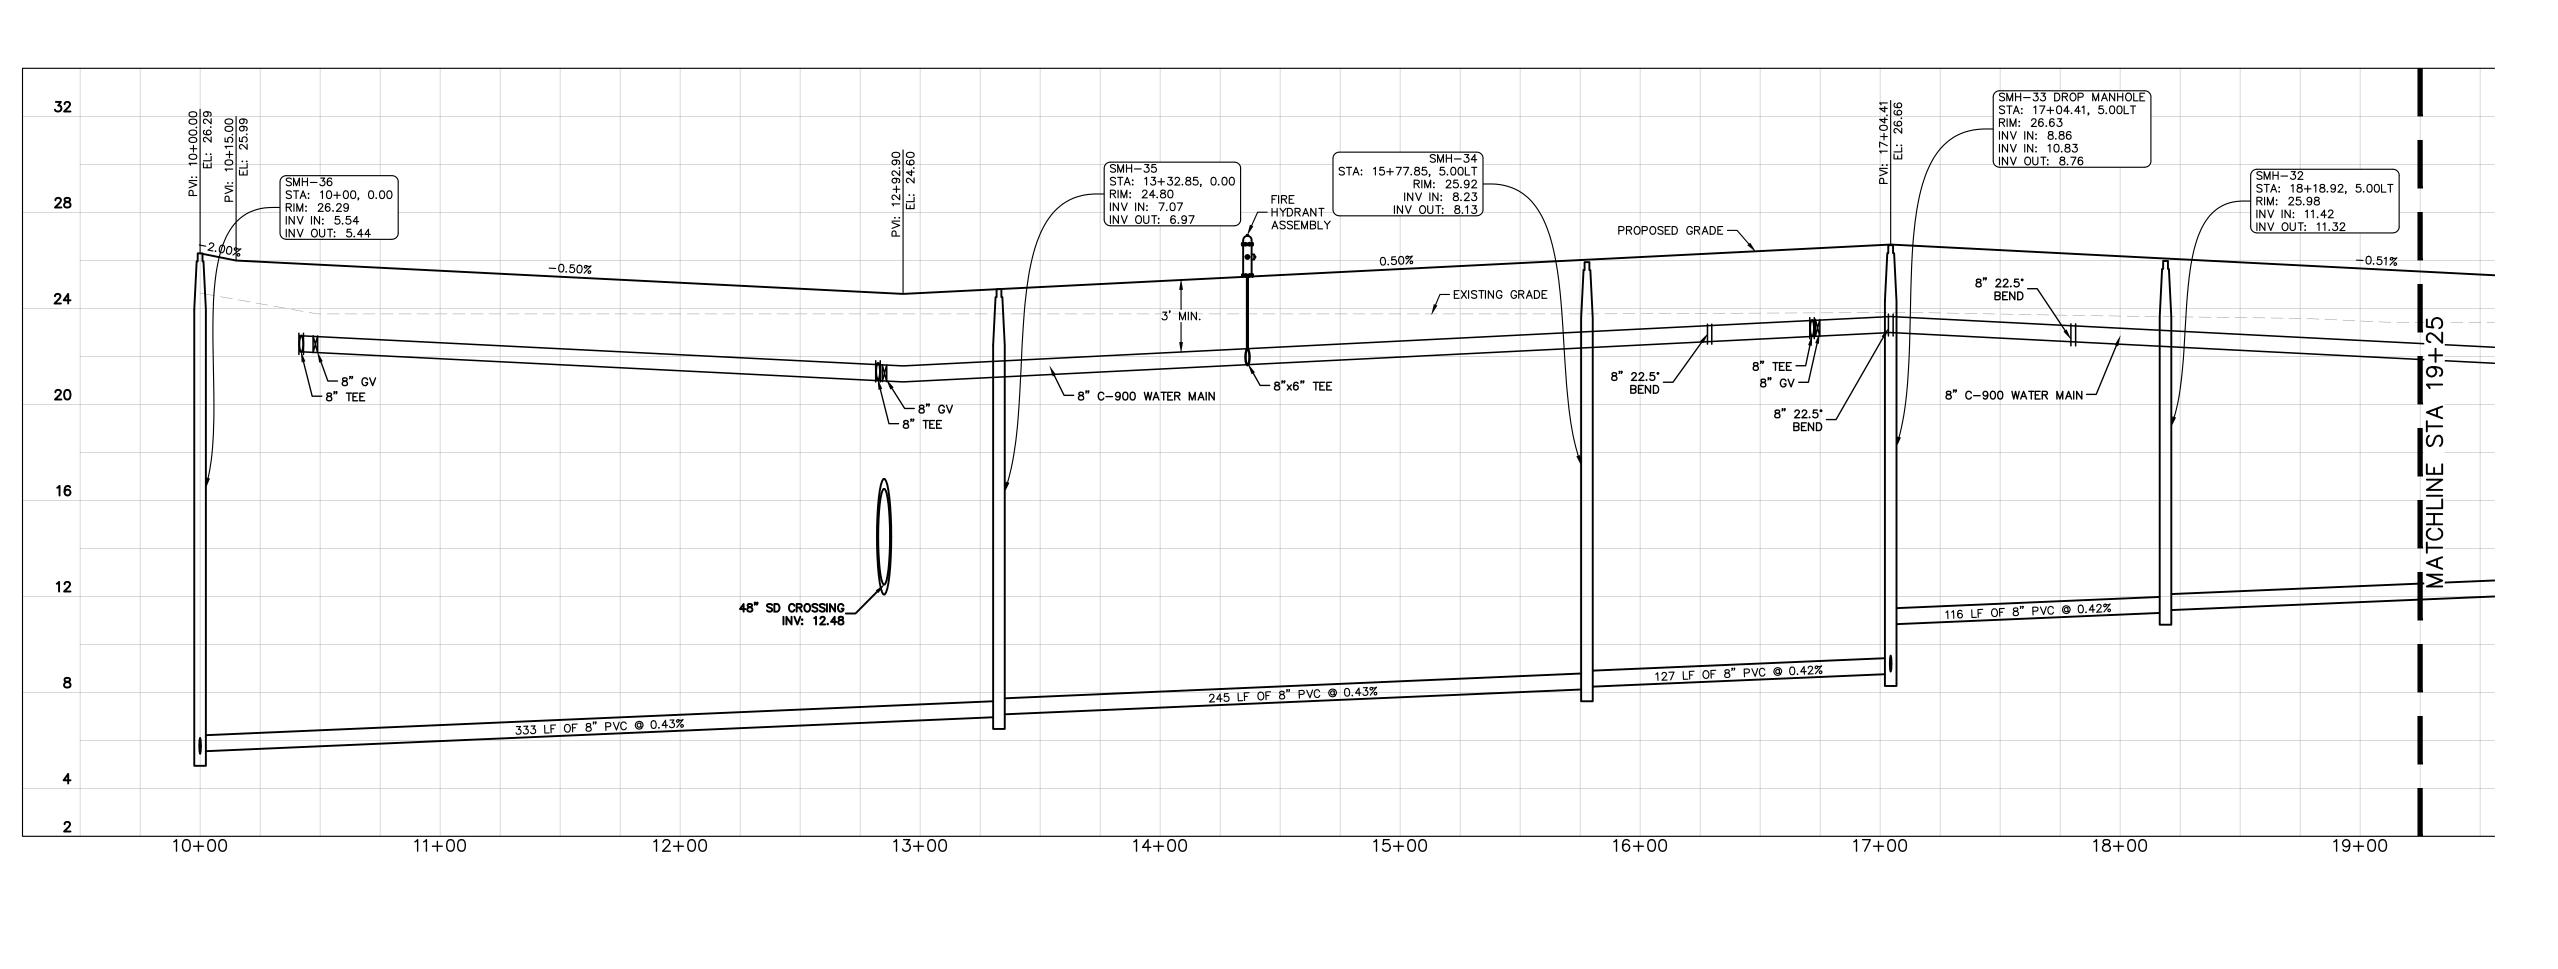

GLYNLEA BOULEVARD SOUTH FROM 10+00 to 19+25
H: 1"=40' V: 1"=4'

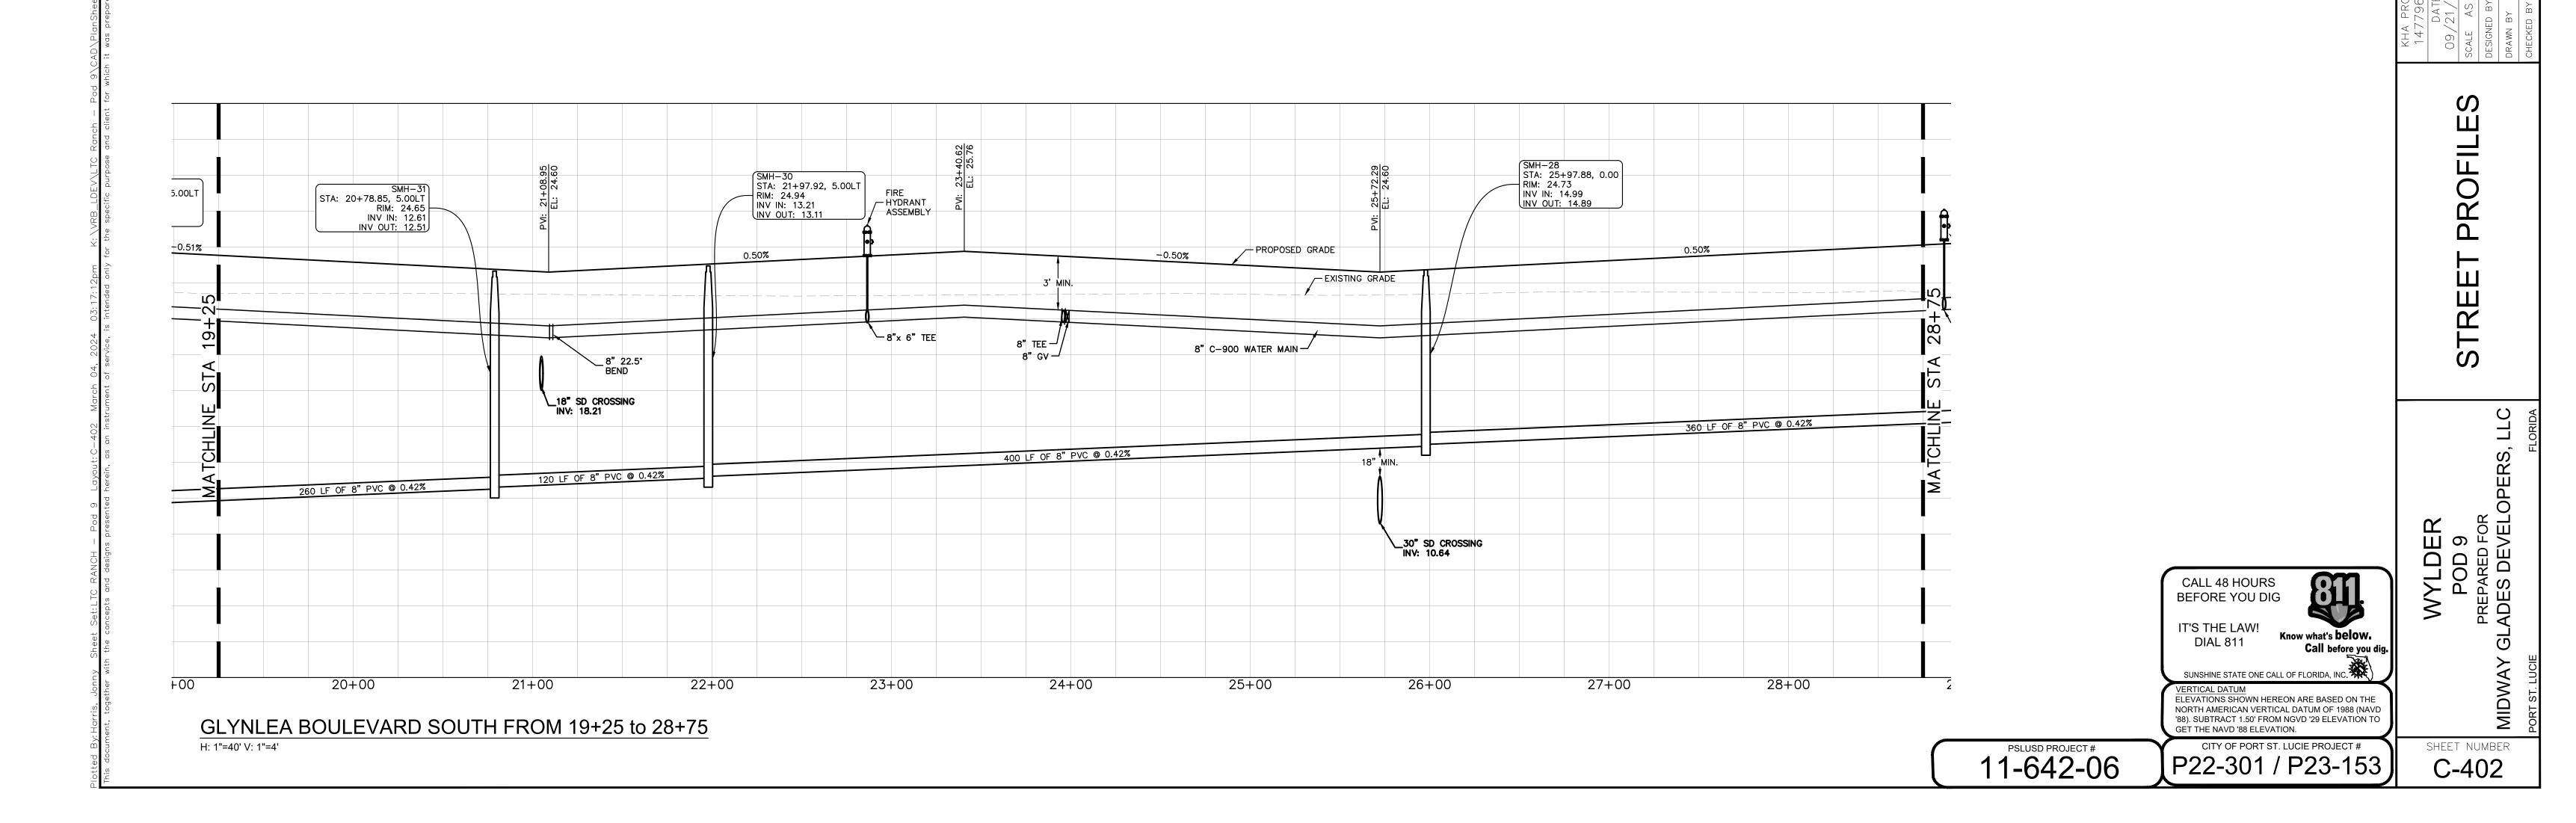

Kim

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