
PROPOSED:

MAIL KIOSK FOR ASTOR CREEK


PORT ST. LUCIE, FLORIDA

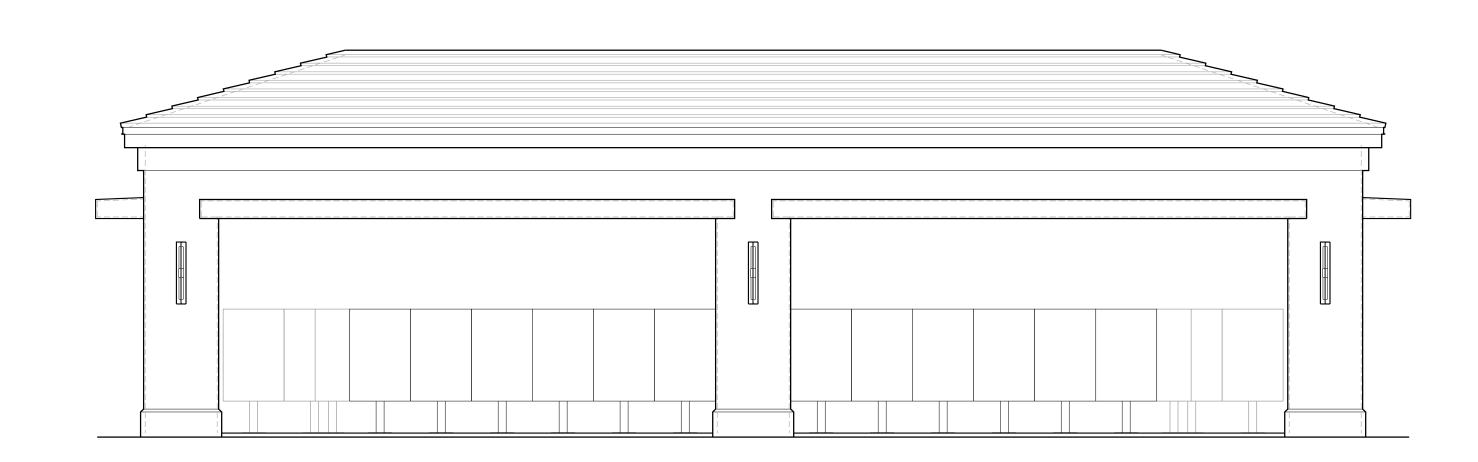


HUMPHREY - ROSAL ARCHITECTS, A.I.A., P.A.

STRUCTURAL ENGINEER: SELECT STRUCTURAL

PLUMBING, MECHANICAL & ELECTRICAL ENGINEER: OCI ASSOCIATES

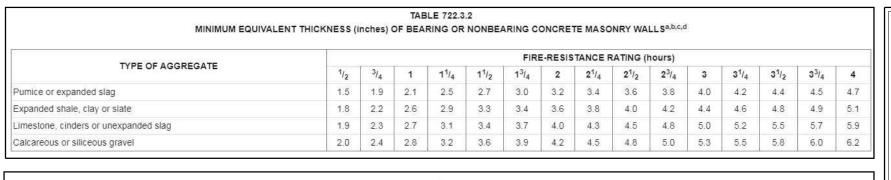

RATED FIRE-RESISTANCE PERIODS FOR VARIOUS WALLS AND PARTITIONS^{8, 0, p} THICKNESS FACE-TO-FACE^b (inches) MATERIAL CONSTRUCTION 4 3 2 1 hours hours hours hour 1-1.1 Solid brick of clay or shale 1-1.2 Hollow brick, not filled. 5.0 4.3 3.4 1-1.3 Hollow brick unit wall, grout or filled with perlite vermiculite or expanded shale aggregate 6.6 5.5 4.4 . Brick of clay 4" nominal thick units not less than 75 percent solid backed with a hat-shaped metal furring channel 3/4" thick formed from 0.021" sheet metal attached to the brick wall on 24" centers with approved fasteners, and 1/2" Type X gypsum wallboard attached to the metal furring strips with 1"-long Type S screws spaced 8" on cente 2-1.1 4" solid brick and 4" tile (not less than 40 percent solid of clay brick and load-bearing hollow 2-1.2 4" solid brick and 8" tile (not less than 40 percent solid) clay tile 5.1 4.4 3.6 5.9 5.0 4.0 6.2 5.3 4.2 Concrete 3-1.3^f Limestone, cinders or air-cooled slag.

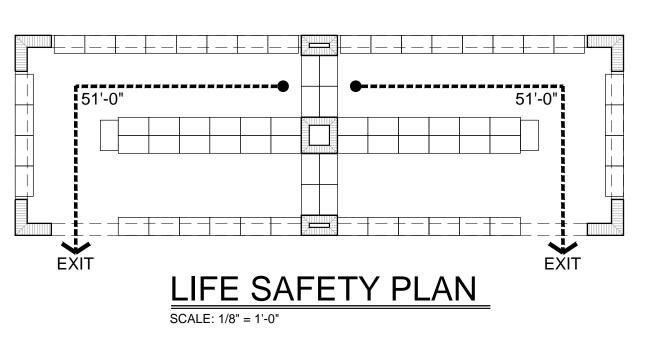

FIRE PROTECTION PER FBC A. BUILDING CLASSIFICATION: B. TYPE OF CONSTRUCTION: C. BUILDING INFORMATION (PER FBC TABLE 503): NON REQUESTED HEIGHT INCREASE PER 504.2 YES 9,500 S.F. 844 S.F. PERMITTED NON REQUESTED -NUMBER OF STORIES D. FIRE PROTECTION (PER FBC TABLE 601) COMPONENT STRUCTURAL FRAME BEARING WALL (EXTERIOR) PER FBC TABLE 721.3.2 BEARING WALL (INTERIOR) NON-BEARING (EXTERIOR) NON-BEARING (INTERIOR) FLOOR CONSTRUCTION ROOF CONSTRUCTION . FIRE PROTECTION (PER FBC TABLE 602) EXTERIOR WALLS PER FBC TABLE 721.3.2

FIRE PROTECTION PER FFPC

A. BUILDING CLASSIFICATION: PER FFPC 101 CHAPTER 6:
A-3 ASSEMBLY


B. TYPE OF CONSTRUCTION: PER FFPC 101 TABLE A.8.2.1.2
TYPE III - 200
UNPROTECTED, UNSPRINKLERED

C. FIRE PROTECTION (PER FFPC A.8.2.1.2)

COMPONENT PERMITTED PROPOSED DESIGN #

BEARING WALL (EXTERIOR) 2 2 PER FBC T 721.3.2

BEARING WALL (INTERIOR) 0 0 NON-BEARING (EXTERIOR) 0 0 NON-BEARING (INTERIOR) 0 0 FLOOR CONSTRUCTION 0 0 ROOF CONSTRUCTION 0 0 -

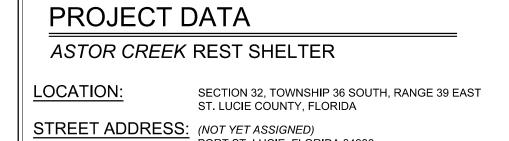


PORT ST. LUCIE, FLORIDA 34986


INDEX OF DRAWINGS **ENGINEERING & PERMITTING BY OTHERS** 1. THE FOLLOWING IS A LIST OF VARIOUS ITEMS THAT , THOUGH SHOWN ON, OR REFERENCED IN, THESE DOCUMENTS, SHALL BE ENGINEERED BY OTHERS AND PERMITTED SEPARATELY AS REQUIRED, PRIOR TO INSTALLATION. A. ENGINEERED WOOD TRUSSES B. SECURITY SYSTEMS ALL DELEGATED ENGINEERING ITEMS SHALL BE SUBMITTED TO ARCHITECT FOR REVIEW AND APPROVAL PRIOR TO PERMIT SUBMITTAL AND PRIOR TO INSTALLATION, FOR COORDINATION ERIFICATION AND COMPLIANCE WITH CONSTRUCTION DOCUMENTS AND APPLICABLE CODES WORK INSTALLED WITHOUT THE ARCHITECTS EXPRESS WRITTEN CONSENT AND WITHOUT PROPER PERMIT APPROVALS IS SUBJECT TO REMOVAL, AT THE COST OF THE CONTRACTOR PERFORMING THE WORK (INCLUDING COST OF REPAIRING ADJACENT SURFACES DAMAGED BY DEMOLITION).

EXTERIOR CLADDING STATE OF FLORIDA PRODUCT APPROVALS										
CATEGOR	Y DESCRIPTION	MANUFACTURER	<u>FL. STATE</u> APPROVAL No,	MODEL No AND NAME	APP STATUS	CODE VERSION	EXP DATE	HVHZ	IMPACT RATED	WIND PRESSURES
ROOF	UNDERLAYMENT CONCRETE TILES	CERTAINTEED BORAL ROOFING	2533.1 7849.19	"FLINTLASTIC" "SAXONY 900 SLATE" FLAT TILE	APPROVED APPROVED		09/15/2023 12/31/2025	, .	N/A N/A	N/A N/A

DRAWING COORDINATION THESE DRAWINGS SHALL BE USED IN COORDINATION WITH ALL CONTRACT DOCUMENTS, INCLUDED BUT NOT LIMITED TO: PROJECT MANUAL STRUCTURAL DRAWINGS MEP DRAWINGS MEP DRAWINGS CIVIL DRAWINGS BY OCI ASSOCIATES CIVIL DRAWINGS BY THOMAS ENGINEERING GROUP LANDSCAPE DRAWINGS THE GENERAL CONTRACTOR IS RESPONSIBLE FOR THE INSTALLATION AND COORDINATION OF OWNER PROVIDED VENDOR EQUIPMENT.

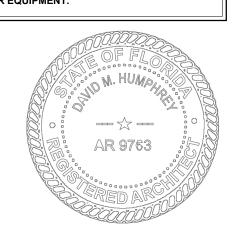

I HEREBY CERTIFY THAT, TO THE BEST OF MY KNOWLEDGE, THE PROPOSED STRUCTURE HAS BEEN DESIGNED IN STRICT ACCORDANCE WITH: Florida Building Code (7TH EDITION) Florida Existing Building Code (7TH EDITION) Florida Building Code (7TH EDITION) Florida Plumbing Code (7TH EDITION) Florida Plumbing Code (7TH EDITION) Florida Mechanical Code (7TH EDITION) Florida Fuel Gas Code (7TH EDITION) Florida Energy Conservation Code 7TH EDITION) 2017 National Electrical Code (NFPA 70) 2002-01 Building Construction Administrative Code Ordinance and Florida Statutes Florida Fire Prevention Code (FFPC 7th EDITION)

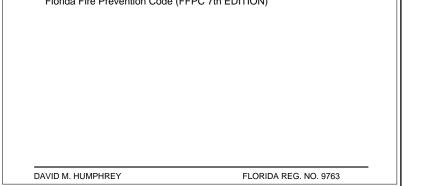


HUMPHREY • ROSAL

A R C H I T E C T S

NAPLES, FLORIDA (239) 263-4201

PD-01

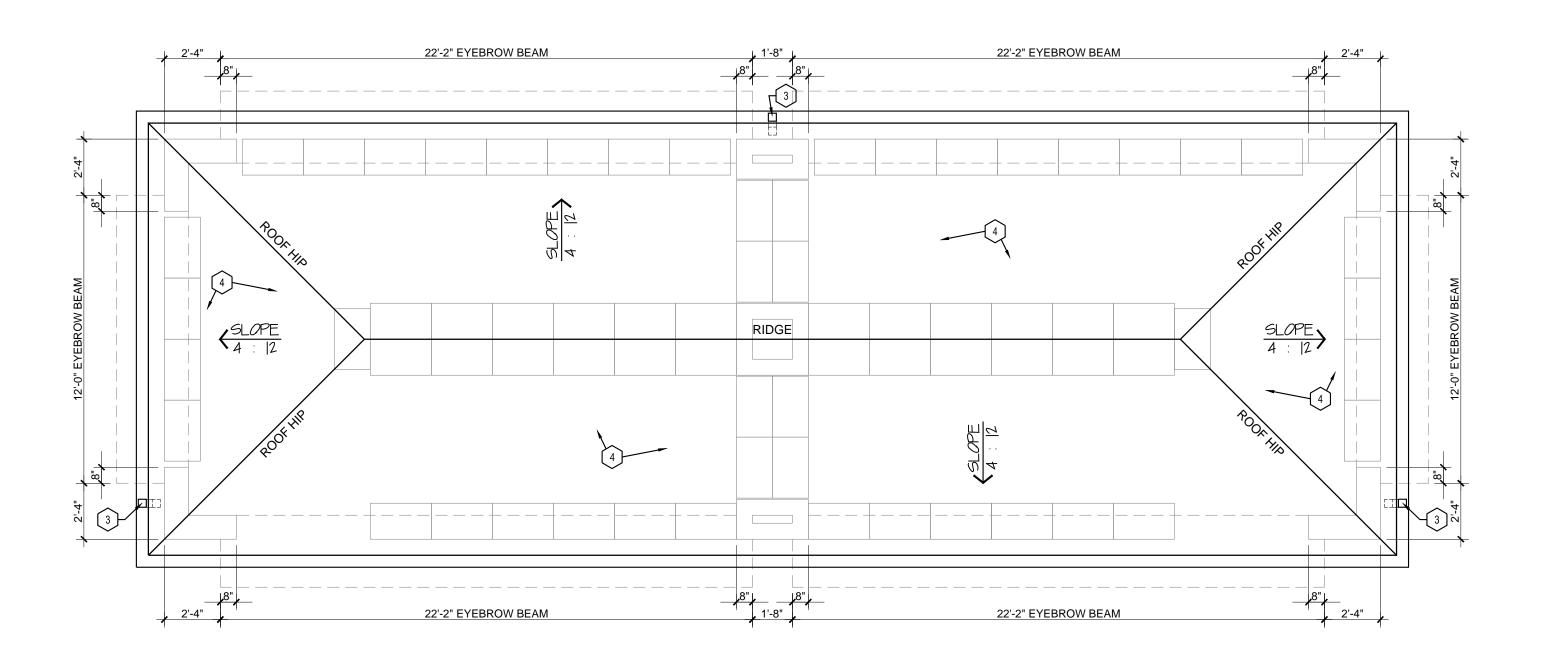

II'−Ø"


II'−Ø'


ROOF PLAN

SCALE: 1/4" = 1'-0"

ROOF NOTES


- 1 DO NOT SCALE DRAWINGS VERIFY DIMENSIONS PRIOR TO LAYOUT OR CONSTRUCTION NOTIFY ARCHITECT OF ANY DISCREPANCIES.
- 2 ALL INTERSECTING CONSTRUCTION SHOWN HEREON SHALL MEET AT 30, 45 OR 90 DEGREE ANGLES (OR MULTIPLES THEREOF) EXCEPT WHERE OTHERWISE NOTED
- 3 6" K-STYLE ALUMINUM GUTTER AND 4"
 SQUARE DOWNSPOUTS EXTENDING TO
 DOWNSPOUT BOOT "1786" SERIES AS
 MANUFACTURED BY JAY R. SMITH MFG.
 CO. OR APPROVED EQAUL AS TRANSITION
 TO UNDERGROUND STORM DRAIN SYSTEM
 SEE DETAIL I SHEET A-OI AND
 COORDINATE WITH CIVIL DRAWINGS
- 4 FLAT CONCRETE TILE ROOF OVER
 "FLINTASTIC" PEEL AND STICK SMOOTH
 MODIFIED BITUMEN SINGLE PLY
 UNDERLAYMENT INSTALL TILE ROOF IN
 ACCORDANCE WITH TESTED ASSEMBLY
 REQUIREMENTS

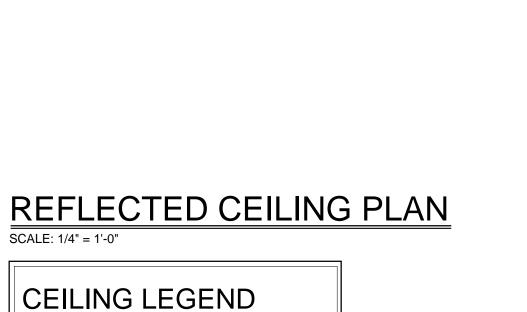

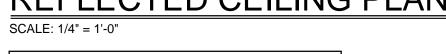

No. DESCRIPTION

SELF FURRING GALVANIZED METAL LATH 1 SCREWED TO METAL FRAMING AT 16" O.C. MAX. SUSPENDED FROM STRUCTURE ABOVE WITH VERTICAL SUPPORTS TO TRUSSES @ 48" O.C. MAX.

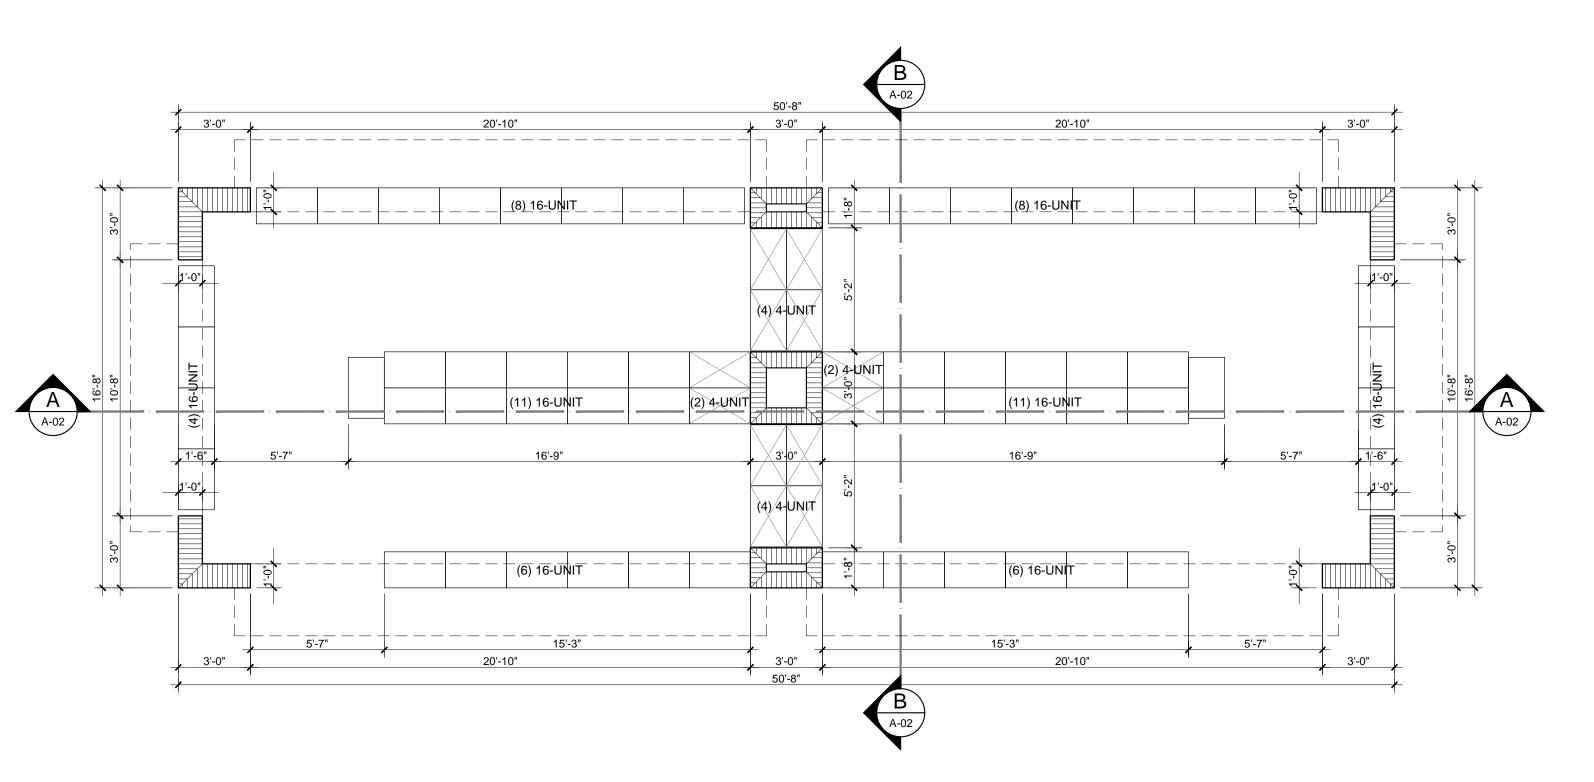

FLOOR PLAN

SCALE: 1/4" = 1'-0"


LEGEND 8" CONCRETE BLOCK CONSTRUCTION (OR 12" WHERE CALLED OUT)


GENERAL NOTES TYPE "CBU" CLUSTER BOX UNITS AS BY "ONSIGHT INDUSTRIES" IS THE BASIS OF DESIGN FOR MAIL KLOSK UNITS

SQUARE FOOTAGES

A/C (per FBC) -GROSS (per FBC) -


*GROSS SQUARE FOOTAGE IS MEASURED FROM OUTSIDE FACE OF EXTERIOR BLOCK WALL THROUGHOUT INCLUDING OUTSIDE FACE OF TIE BEAM AT COVERED AREAS.

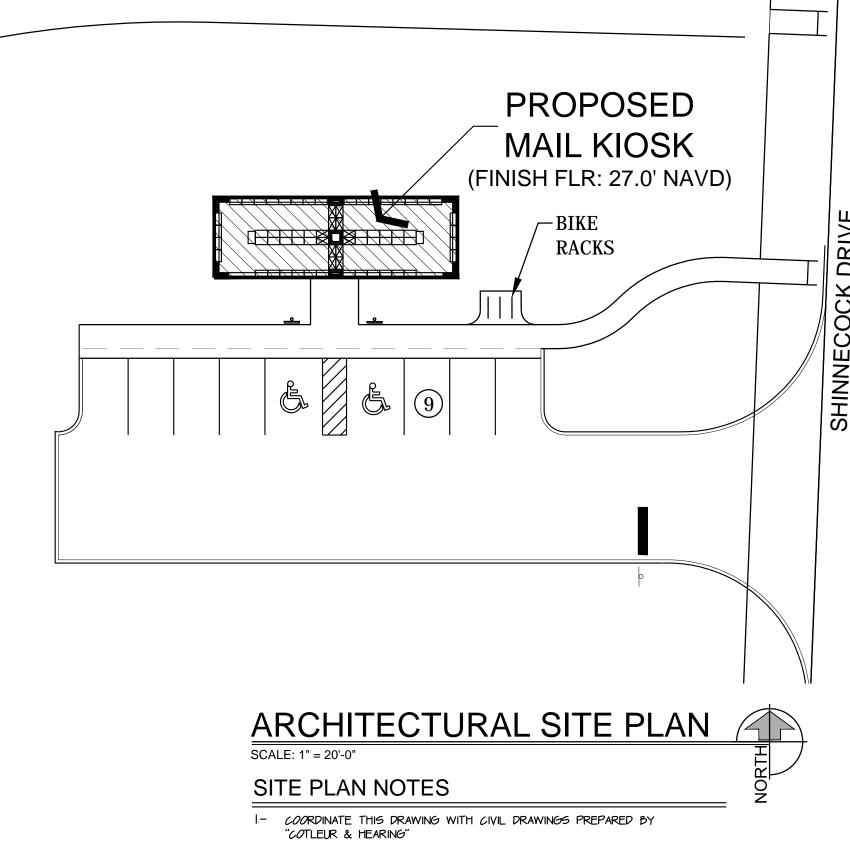

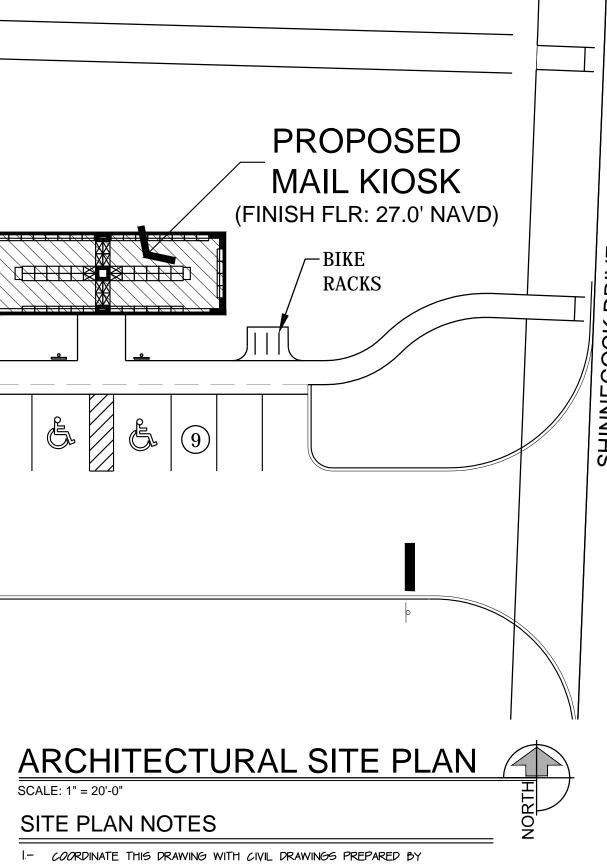

2.- REFER TO CIVIL DRAWINGS FOR ALL ASPECTS OF SITE IMPROVEMENTS INCLUDING PROPOSED SITE INFRASTRUCTURE, SITE GRADING, PAVING, CURBING, DRAINAGE AND OTHER PERTINENT SITE INFORMATION

3.- AREAS FOR STRUCTURE ARE IDENTIFIED: OVERALL BUILDING FOOTPRINT

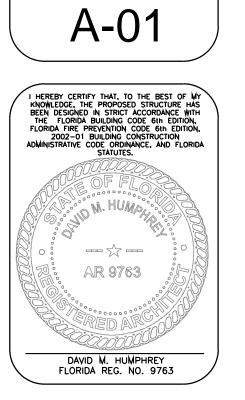

ARCHITECTURA FLOOR F REFLECTED CE ROOF P

SHEET No.


ROSAL = C T S (239) 263-4201 FAX (239) 263-4451


HUMPHRE
A R C H
3200 9TH ST. NORTH
SUITE #300
NAPLES, FLORIDA 34103


E 天

IL KIOSK 70R CRE

SED STRUCTURE:

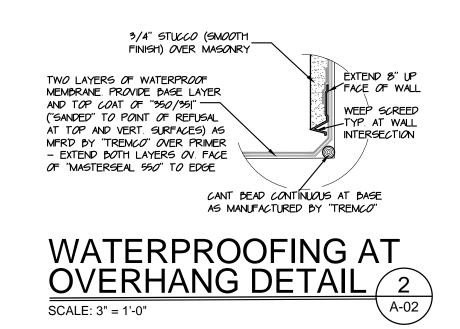

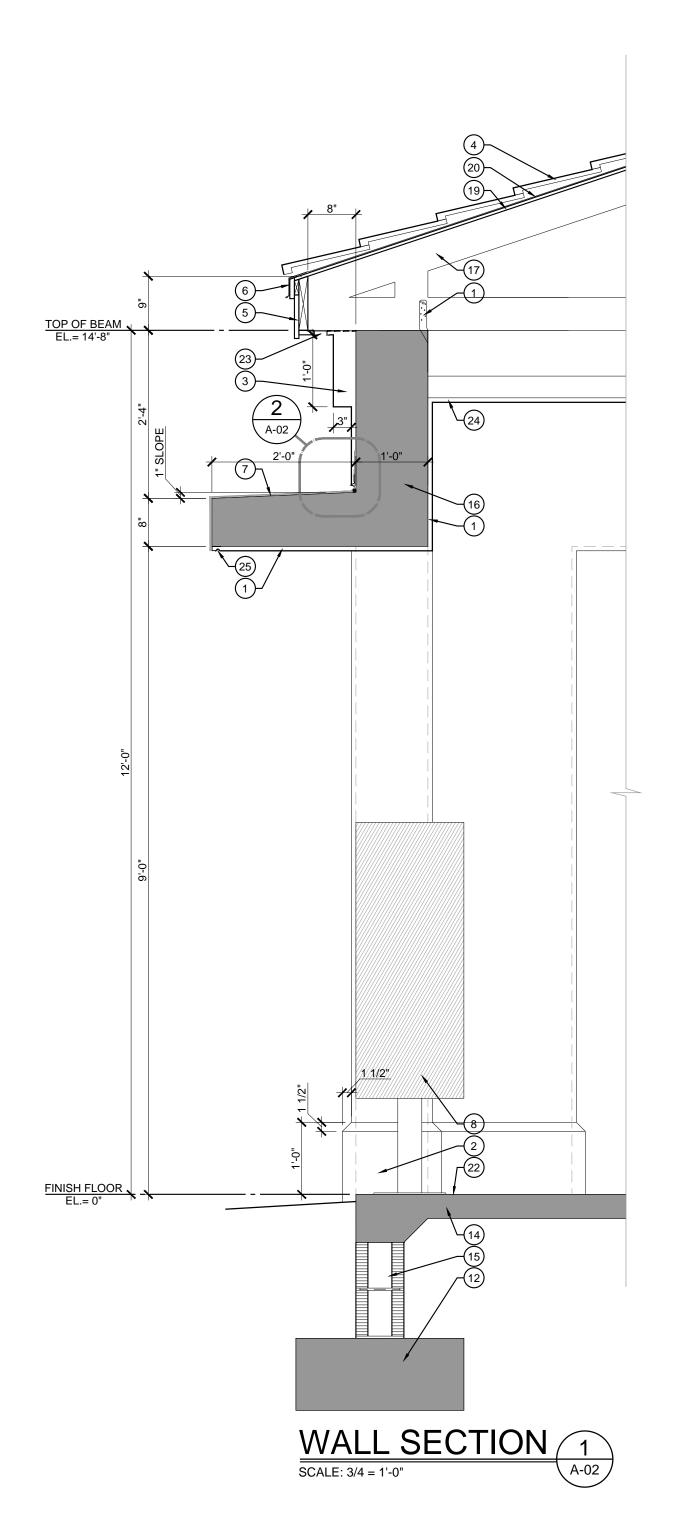

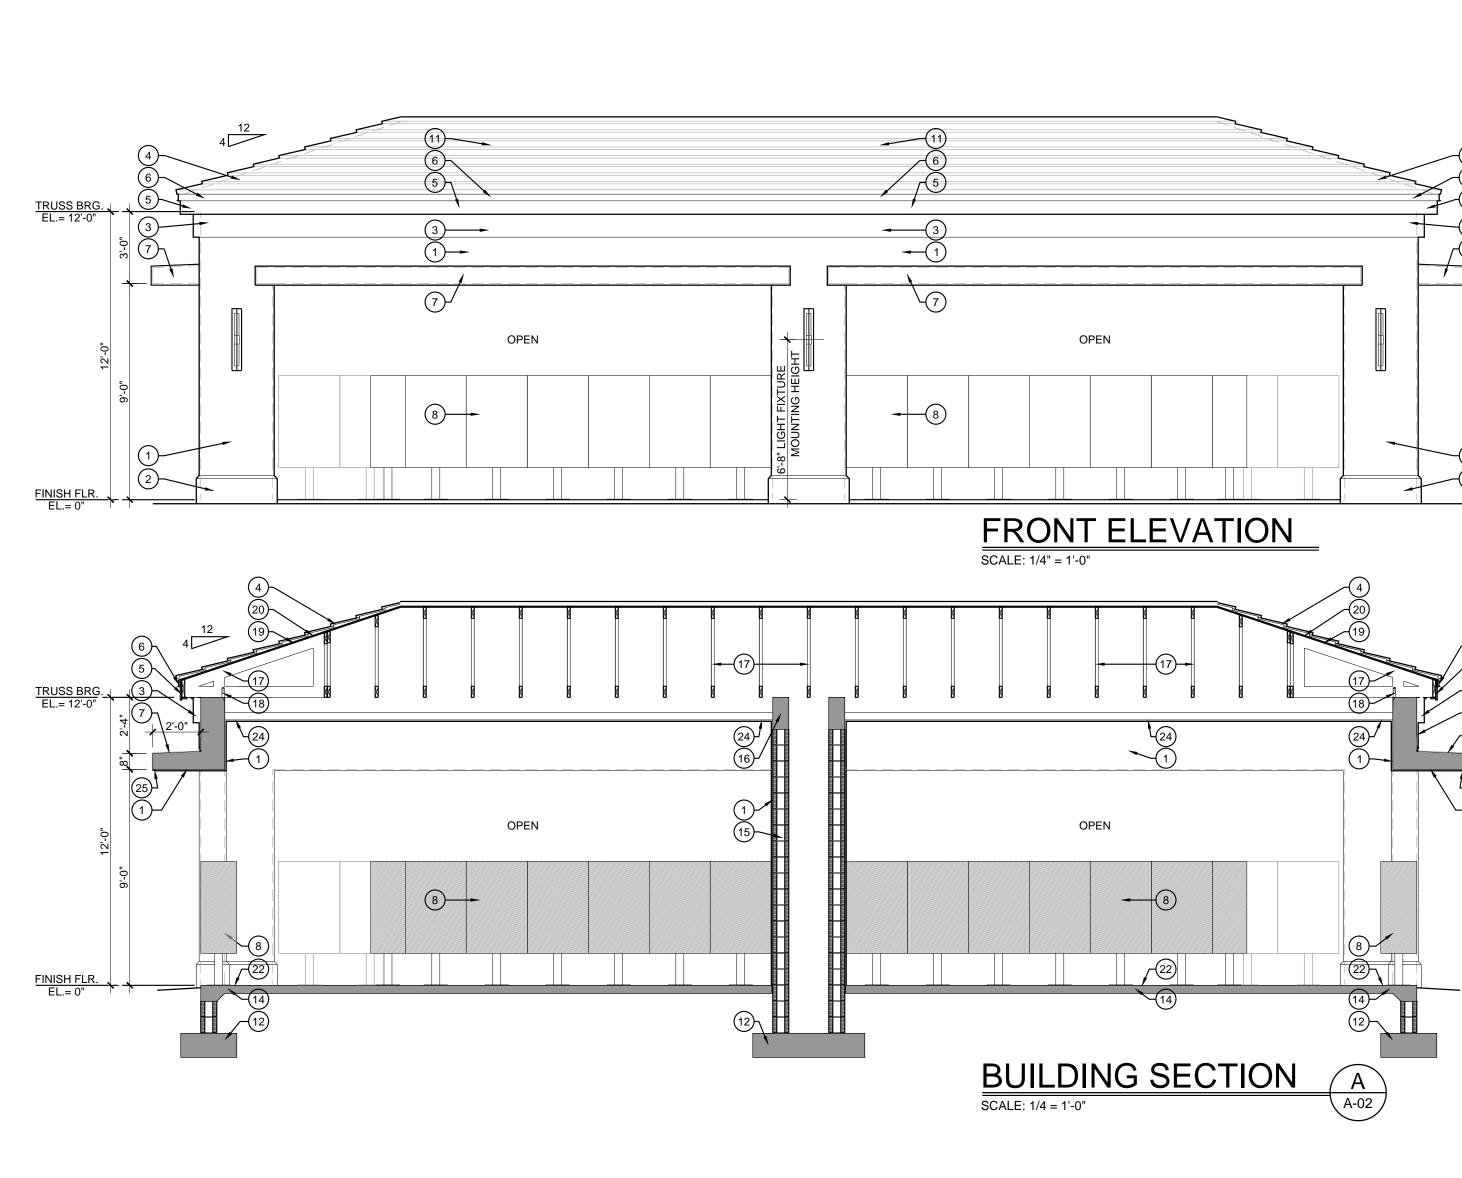

MATERIALS LEGEND

1) <u>STUCCO</u>: 3/4" THICK OVER CONCRETE OR CONCRETE MASONRY CONSTRUCTION, IN SMOOTH (SAND) FINISH, USE "LINK" BONDING AGENT OVER CAST CONCRETE SURFACES, LATH (8" WIDE BAND AT) ALL MASONRY TO CONCRETE TRANSITIONS

3 <u>STUCCO CORNICE</u>: SMOOTH (SAND) FINISH STUCCO IN PROFILES AS SHOWN - SEE WALL SECTION

(4) CONCRETE ROOF TILES: FLAT CONCRETE ROOF TILES OVER "FLINTASTIC" PEEL AND STICK SMOOTH MODIFIED BITUMEN SINGLE PLY UNDERLAYMENT OVER PLYWOOD SHEATHING

5) <u>FASCIA:</u> |x4 (S4S) CEDAR FASCIA WITH 1/2" MIN. LAP OVER |x8 (S4S) CEDAR FASCIA OVER 2x SUBFASCIA - SEE SECTIONS (6) DRIP EDGE FLASHING: METAL SNAP-ON FLASHING AND CLEAT.

(SIDES) OF CAST-IN-PLACE CONCRETE OVERHANGS - TWO LAYERS OF WATERPROOF MEMBRANE - SEE DETAIL 2/A-02 8 MAIL KIOSK UNITS: TYPE "CBU" CLUSTER BOX UNITS BY "ONSIGHT INDUSTRIES"

9 THRU (10) RESERVED - NOT USED 11) <u>ENGINEERED FILL</u>: CLEAN, COMESIONLESS SAND FILL, INSTALLED AND COMPACTED PER GEOTECHNICAL ENGINEER RECOMMENDATIONS.

(12) <u>FOUNDATION</u>: REINFORCED CAST-IN-PLACE FOUNDATION. SEE STRUCTURAL DRAWINGS FOR COMPLETE DETAILS

(13) <u>JOINT FILLER</u>: LIGHTWEIGHT FLEXIBLE/ COMPRESSIBLE EXPANSION JOINT FILLER AS BY POLYFOAM OR APPROVED EQ.

(14) <u>SLAB ON GRADE: 4" CONCRETE SLAB WITH 6×6 W2.|xW2.|</u> WELDED WIRE FABRIC AT MID HEIGHT, OVER 6 MIL VISQUEEN VAPOR BARRIER - SEE STRUCTURAL DRAWINGS (15) MASONRY: 8" TYP. (OR 12" WHERE CALLED OUT) CMU. WALL REINFORCED (PER STRUCTURAL DRAWINGS) WITH #5 BARS IN

GROUT FILLED CELLS AT 32" OC MAX AND WITH DUROWALL HORIZONTAL REINFORCEMENT EACH ALTERNATE COURSE. UNO. (16) <u>BEAM:</u> REINFORCED CONCRETE. SEE STRUCTURAL DRAWINGS FOR SIZE AND REINFORCING.

17) TRUSSES: PRE-ENGINEERED WOOD AT 24" O.C. MAX., PROVIDE WITH ALL CONNECTORS/CLIPS AS NECESSARY TO WITHSTAND WIND PRESSURES PROVIDED BY THE STRUCTURAL ENGINEER FOR 130 MPH WINDS, PER FBC REQUIREMENTS. REFER TO WALL SECTIONS FOR TRUSS OVERHANG/HEEL DIMENSIONS

(18) <u>HURRICANE STRAP</u>: STRAP OR TIE DOWN AT EACH TRUSS -SEE STRUCTURAL AND TRUSS DRAWINGS FOR SIZE AND TYPE (19) <u>ROOF SHEATHING:</u> EXTERIOR GRADE PLYWOOD ROOF SHEATHING. SEE STRUCTURAL DRAWINGS FOR REQUIRED SPAN RATING AND

(20) <u>ROOF UNDERLAYMENT:</u> "FLINTASTIC" PEEL AND STICK GRANULATED MODIFIED BITUMEN SINGLE PLY MEMBRANE

(21) <u>GUTTER:</u> 6" K-STYLE ALUMINUM RAIN GUTTER - COLOR TO BE SELECTED BY ARCHITECT


(22) FLOOR FINISHES: SEE ROOM FINISH SCHEDULE FOR FLOOR FINISHES CONTRACTOR SHALL COORDINATE SLAB RECESS REQUIREMENTS ACCORDING TO FINISH MATERIAL 23) <u>SOFFIT VENT:</u> CONTINUOUS 2" WIDE PVC VENT

(24) STUCCO CELLING: 3/4" STUCCO (SMOOTH FINISH) ON PAPER-BACKED SELF FURRING GALVANIZED METAL LATH SCREWED TO METAL FRAMING AT 16" OC. MAX. SUSPENDED FROM STRUCTURE ABOVE WITH VERTICAL SUPPORTS TO TRUSSES @ 48" OC. MAX. (25) TOOLED DRIP: TOOLED DRIP EDGE IN STUCCO 4 12 SED STRUCTURE: 3

SIDE ELEVATION

SCALE: 1/4" = 1'-0"

8

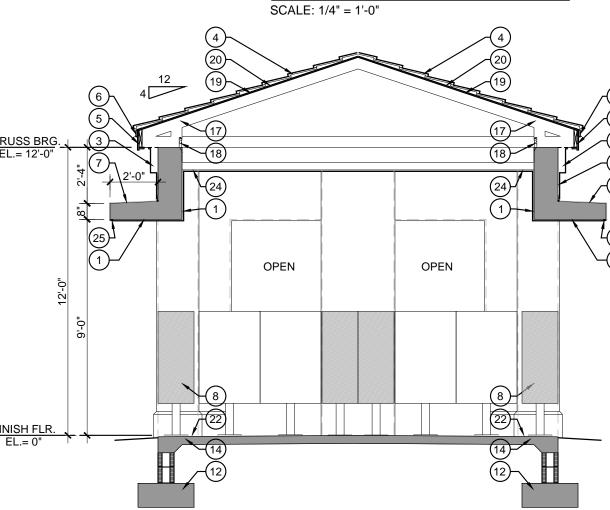


BUILDING SECTION

SCALE: 1/4 = 1'-0"

SAL T S 39) 263-4201 39) 263-4451 Ineyrosal.com **M** 0 Ш

HUMPHRA
A R C H
3200 9TH ST. NORTH
SUITE #300
NAPLES, FLORIDA 34103

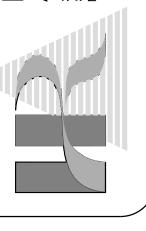

而不 \overline{S}

SHEET No. A-02

