TOWN PLACE at PORT ST LUCIE

PLS Town Place Partners

CODES **GENERAL NOTES** . THE CONTRACTOR SHALL IN THE WORK OF ALL TRADES, PERFORM ANY CODE & 2020 FLORIDA ACCESSIBILTY CODE AND ALL CUTTING AND PATCHING NECESSARY TO COMPLETE THE WORK, AND SHALL PROTECT THE EXISTING BUILDING FROM DAMAGE CAUSED BY THE WORK. THE CONTRACTOR SHALL REPAIR AND RESTORE THE EXISTING CONSTRUCTION TO ITS ORIGINAL CONDITION TO THE SATISFACTION OF THE OWNER AND THE ARCHITECT. 2. THE CONTRACTOR SHALL NOT DISRUPT EXISTING SERVICES, OPERATIONS, OR UTILITIES WITHOUT OBTAINING OWNER'S PRIOR APPROVAL AND INSTRUCTIONS IN EACH CASE. OCCUPANCY GROUP: GROUP B-BUSINESS . COORDINATE DEMOLITION AND CONSTRUCTION TO REMAIN, SO AS TO PROVIDE THE BEST POSSIBLE JOINT OR UNDERLAYING SURFACE FOR 4. ALL CONSTRUCTION AND WORKMANSHIP SHALL CONFORM TO THE REQUIREMENTS OF LOCAL CODES. 5. THE CONTRACTOR SHALL VISIT THE JOB SITE AND BE RESPONSIBLE FOR THE VERIFICATION OF ALL ELEVATIONS, CONDITIONS, AND DIMENSIONS PRIOR TO COMMENCING CONSTRUCTION. ANY CONFLICTS OR OMISSIONS BETWEEN THE VARIOUS ELEMENTS OF THE WORKING DRAWINGS AND/OR GENERAL NOTES SHALL BE BROUGHT TO THE ATTENTION OF THE ARCHITECT IMMEDIATELY AND BEFORE PROCEEDING WITH ANY WORK SO INVOLVED. DO NOT SCALE . THE GENERAL CONTRACTOR SHALL COORDINATE AND VERIFY WITH ALL SUBCONTRACTORS THE SIZE AND LOCATION OF ALL PIPING, DUCTWORK, PRIOR TO BIDDING & INCLUDE ALL REQUIRED ELEMENTS IN BID. TRENCHES, SLEEVES, SPECIAL BOLTING FOR EQUIPMENT CONDUITS, 8. THE GENERAL CONTRACTOR SHALL BE RESPONSIBLE FOR ALL MEANS AND METHODS FOR DEMOLITION. THE CONTRACTOR SHALL INFORM THE ARCHITECT OF ANY CONDITIONS THAT WOULD AFFECT THE STRUCTURAL INTEGRITY OF THE BUILDING PRIOR TO PROCEEDING WITH **SYMBOLS** 9. THE CONTRACTOR SHALL BE RESPONSIBLE FOR LEAVING ALL FINISH SURFACES CLEAN AT COMPLETION OF THE WORK AND SHALL REMOVE ALL EXCESS MATERIAL AND DEBRIS FROM THE JOB REGULARLY. 10. JOB SITE MEASUREMENTS ARE THE FULL RESPONSIBILITY OF THE CONTRACTOR AND/OR SUBCONTRACTOR AND MUST BE TAKEN FOR ALL REFERENCE ITEMS BY ALL SUBCONTRACTORS PRIOR TO FABRICATION. 11. GENERAL CONTRACTOR RESPONSIBLE FOR INSTALLING SOLID BLOCKING BEHIND ALL SHELVING, CABINETS, ETC., OR EQUIPMENT **ELEVATION** 12. GENERAL CONTRACTOR RESPONSIBLE FOR INSTALLING A DUST REFERENCE PROOF BARRICADE & PROTECT THE MALL FLOOR. SECTION REFERENCE



NFPA 101 CLASSIFICATION BUSINESS

2017 NATIONAL ELECTRICAL CODE

ROOM NUMBER

INTERIOR

REFERENC

REFERENCE

REFERENCE

WINDOW

REFERENCE

REFERENCE

REVISION

REFERENCE

DOOR

CITY OF PORT ST LUCIE DEVELOPMENT CODE & FLORIDA STATUES ALL OTHER RULES, REGULATIONS & CODES HAVING JURISDICTION

CONSTRUCTION TYPE: IIIB - UNPROTECTED UNSPRINKLED

LIFE SAFETY

1. THE CONTRACTOR SHALL PROVIDE & INSTALL (1) 5 LB. ABC TYPE UL LISTED FIRE EXTINGUISHER PER 2,500 S.F. LOCATION SHALL BE APPROVED BY THE FIRE MARSHALL PRIOR TO INSTALLATION.

2. EQUIPMENT & CONNECTIONS TO THE BUILDING FIRE ALARM CONTROL PANEL SHALL BE PROVIDED. THE CONTRACTOR SHAL:L VERIFY THE BUILDING SYSTEM

EXIT REQD'S

0 TO 29 PERSONS: 1 EXIT REQUIRED

30 TO 50 PERSONS: 2 EXITS REQUIRED, DOOR **MAY SWING INTO SPACE**

MORE THAN 50 PERSONS: 2 EXITS REQUIRED, DOOR MUST SWING WITH PATH OF EGRESS

EGRESS REQUIREMENTS SHALL COMPLY WITH NFPA 101 CHAPTER 5, SECTION 5-2.1 & 26-2.2.2. ALL HARDWARE SHALL COMPLY WITH SECTION 5-2.1.5.1 FOR LOCKING REQUIREMENTS. OCCUPANT LOAD IS CALCULATED

ABBEVIATIONS

NUMBEACT NOT TO SCALE

OWNER :R CONTRACTOR

PLASTE PLYWOO

QUARRY TILE

SQUAR

STANDAR

STRUCTURA SYMMETRICA

TELEPHON TONGUE AND THICKVE

INDEX OF DRAWINGS

ARCHITECTURE			
Sheet Number Sheet Name			
0.04	TITLE OLICET DETAIL		
A0.1	TITLE SHEET RETAIL		
A0.2	COLORED RENDERING		
A1.1	FLOOR PLAN BLD'G A		
A1.2	FLOOR PLAN BLD'G B		
A1.3	FLOOR PLAN BLD'G C		
A2.1	ELEVATIONS BLD'G A		
A2.2	ELEVATIONS BLD'G B		
A2.3	ELEVATIONS BLD'G C		

10180 Lexington Estates Blvd Boca Raton, FL 33428

C 561.414.6729

02/16/22

AR 008071

Consultant Address **Address**

Address **Address**

e-mail


e-mail

Consultant **Address** Phone

> Consultant Address Fax

No.	Description	Date
-	OLO Tarres Diagram Davida a	
TÖ	PLS Town Place Partner WN PLACE at PC	s RT
	ST LUCIE	

VICINITY MAP

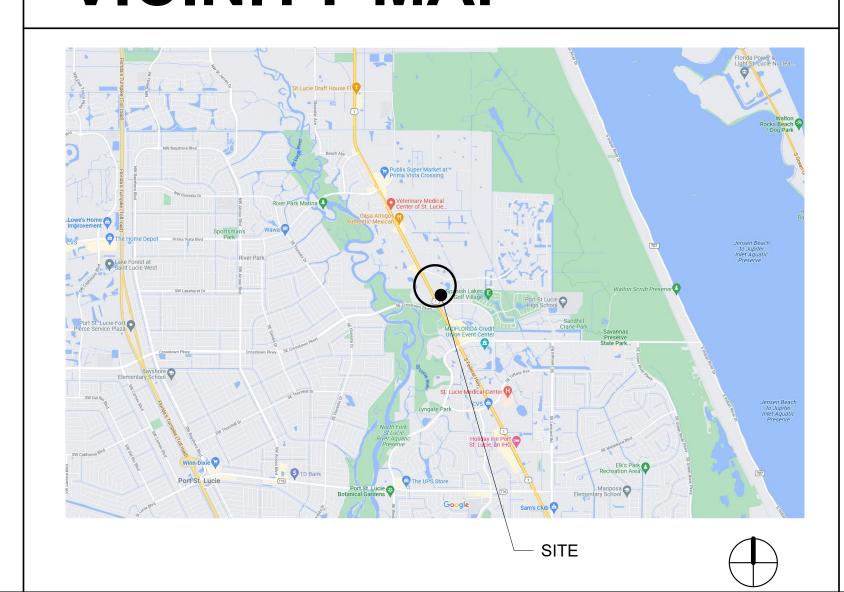

KEYNOTES

A keynote system is used on the drawings for materials references and notes to keynote legend on the drawings for information which relates toach keynote symbol on the respective

Each keynote symbol consists of a 2-digit number followed by a period and a letter suffix. The 2-digit number relates to the specification section whichth generally covers the item that is referenced, and the 2-digit suffix identifies specific reference notation used on the drawing. The digit suffix does not

DRAWINGS.EYNOTE REFERENCE NUMBERS RELATED TO THECIFICATIONS SECTIONS NUMBERING SYSTEM, SHALL NOT CONTROL'RACTOR IN DIVIDING THE WORK AMONG SUBCONTRACTORS3 THE EXTENT OF WORK TO BE PERFORMED

THE ORGANIZATION OF THE KEYNOTE SYSTEM ON THE

ELEVATION WALL INTERIOR SHEET **EXTERIOR NUMBER**

DECOR DET D.F

ROOM NUMBER

DOOR NUMBER

WINDOW

NUMBER

NUMBER

REVISION

NUMBER

REFERENCE

NUMBER

NUMBER

ELEVATION

SHEET R

NUMBER

NUMBER

SHEET

HOSE HOLLOW HARDWOO

INSIDE DIAMETER INCANDESCEN

> MANUFACTURE MISCELLANEOU MOUNTE)

ADJUSTABL

BOAR BUILDING

EXISTING

FORCE AIR FIRE HOSE CABINET FLOOT FLASHING

VERT VEST V.G.D.F

WITHOU WATER

VERTICAL GRAIN DIAMETER OR

PERPENDICULA POUND OR

TOP OF Y
TOP OF 3
TOP OF:
TOP OF
TYPICAL U.O.N UNLESS OTHERWISE VERTICAL

TITLE SHEET RETAIL

RIC 0502 Project number 02/16/22 Drawn by Author Checked by Checker

A0.1

Scale







T 561.923.0745 C 561.414.6729 TOWN PLACE at PORT ST LUCIE

PORT ST LUCIE, FLORIDA

PLS Town Place Partners

Project nu
Date

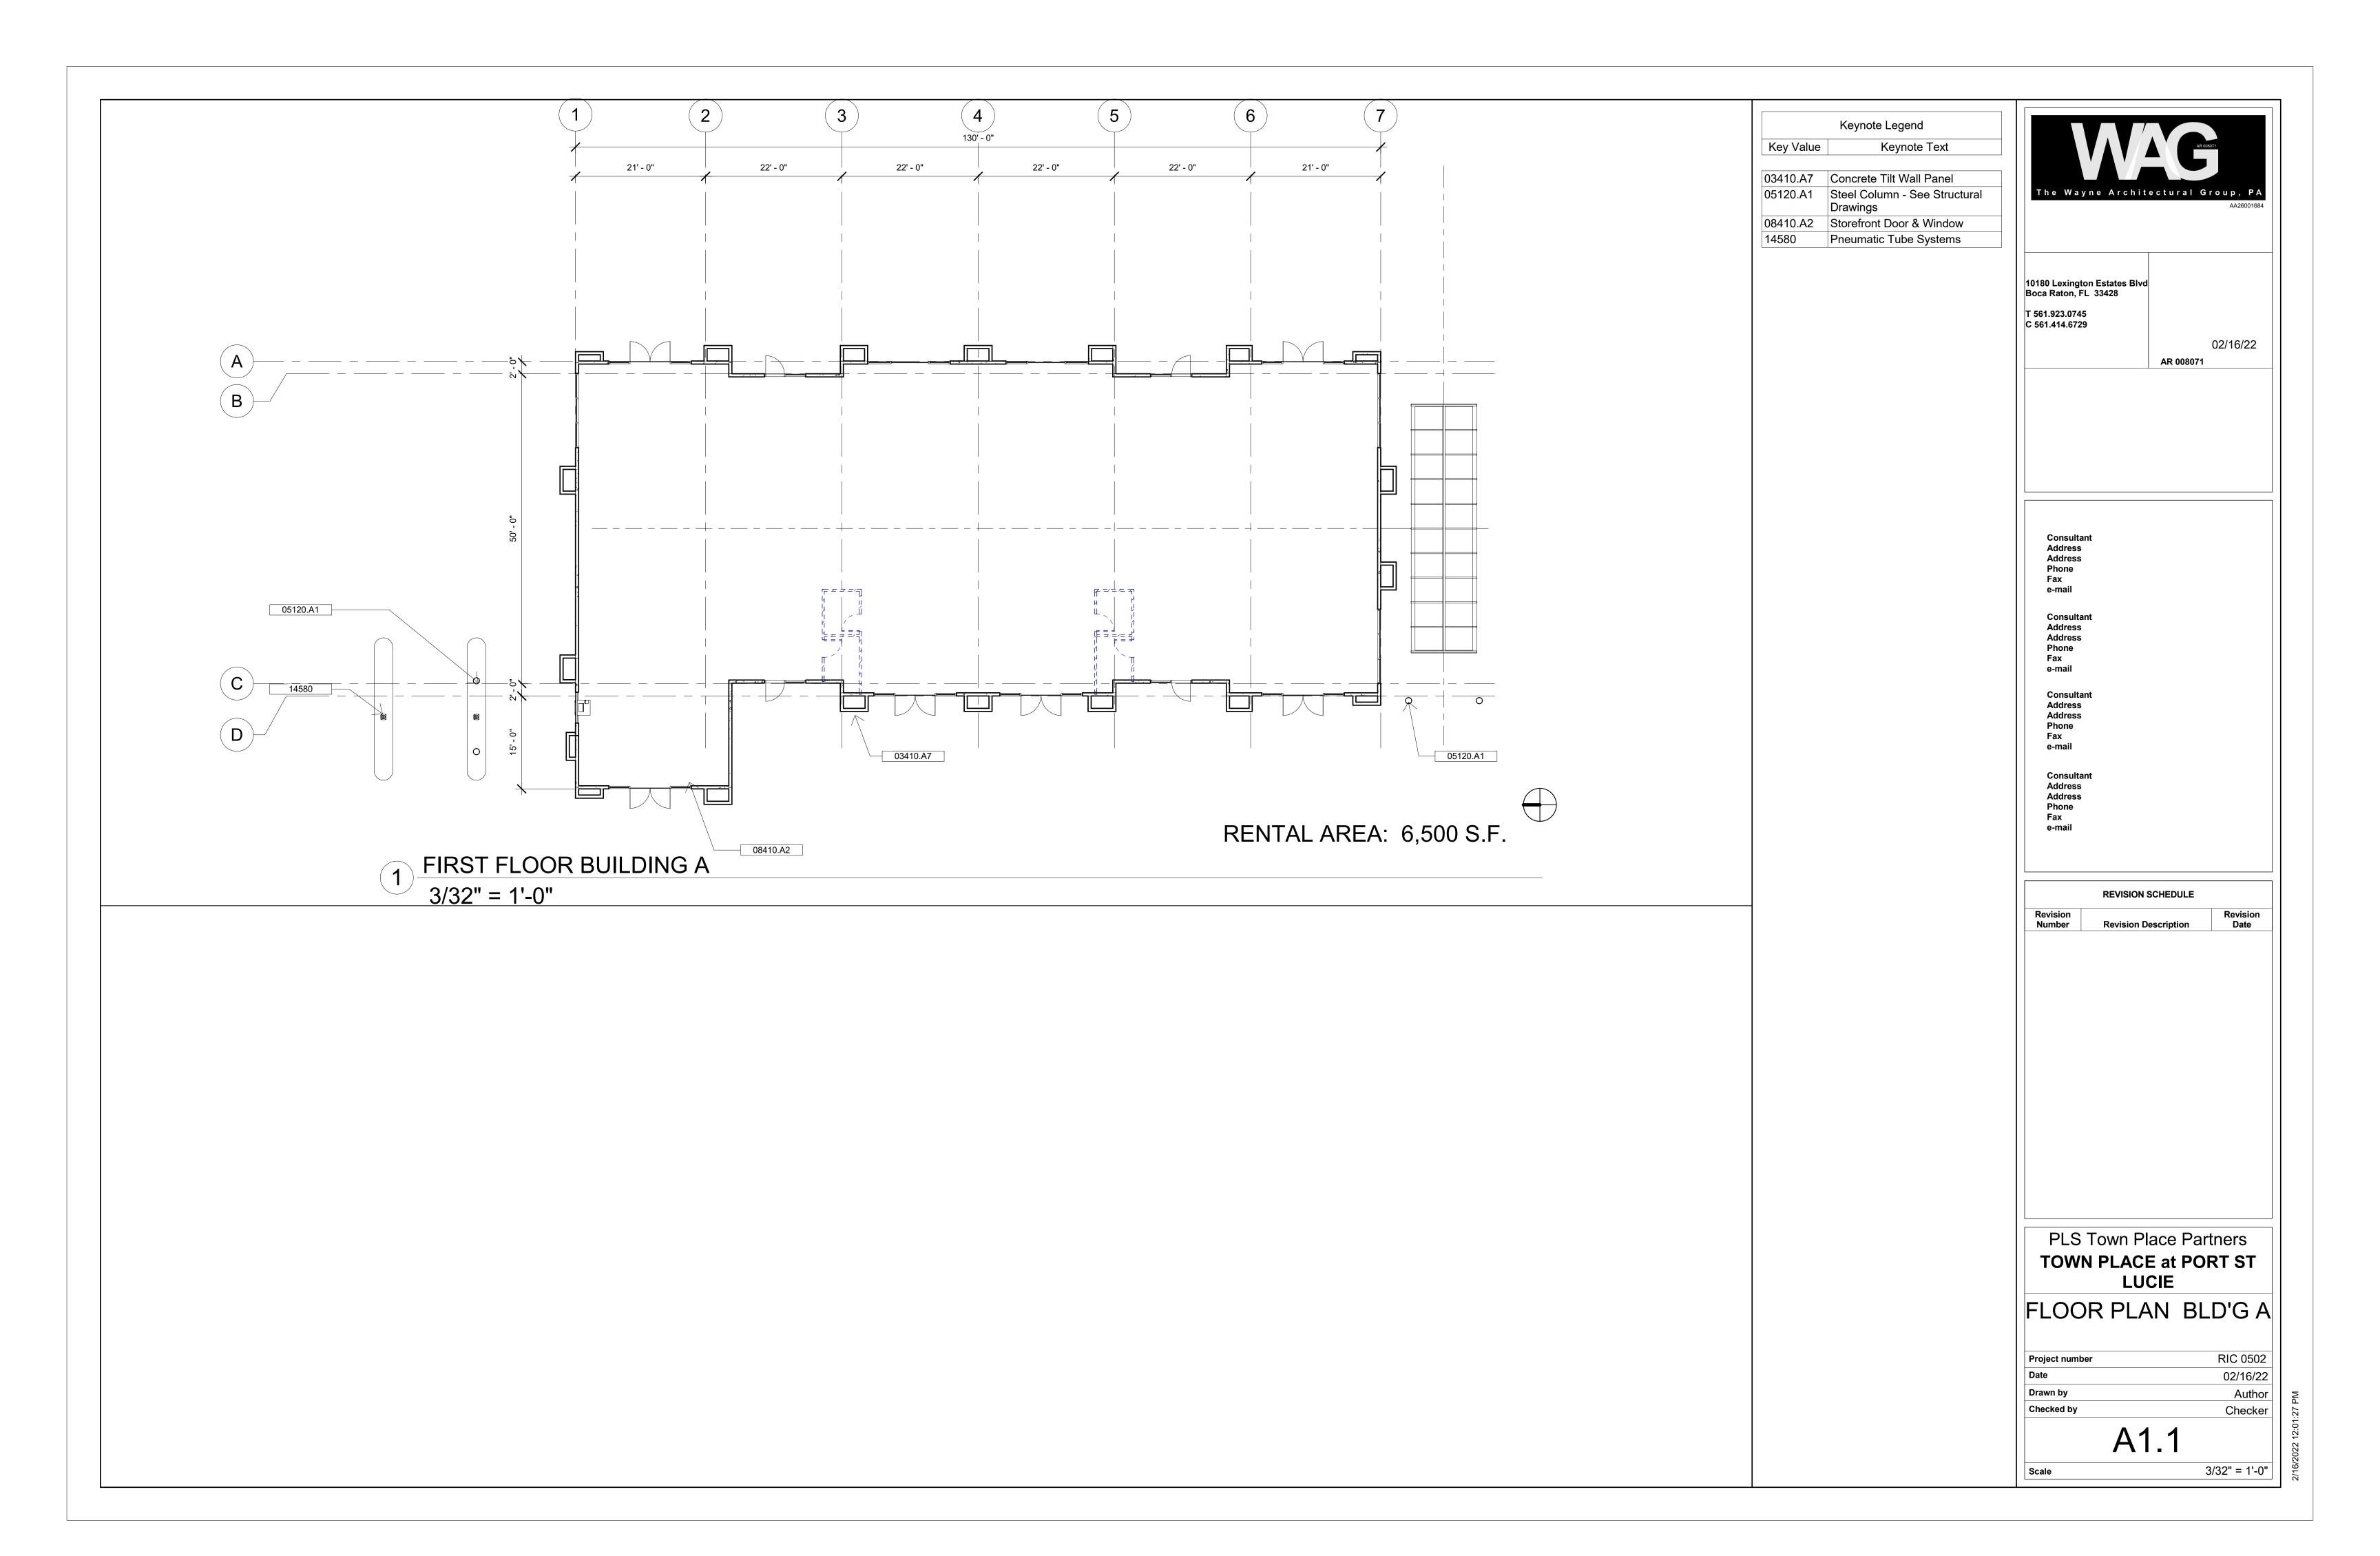

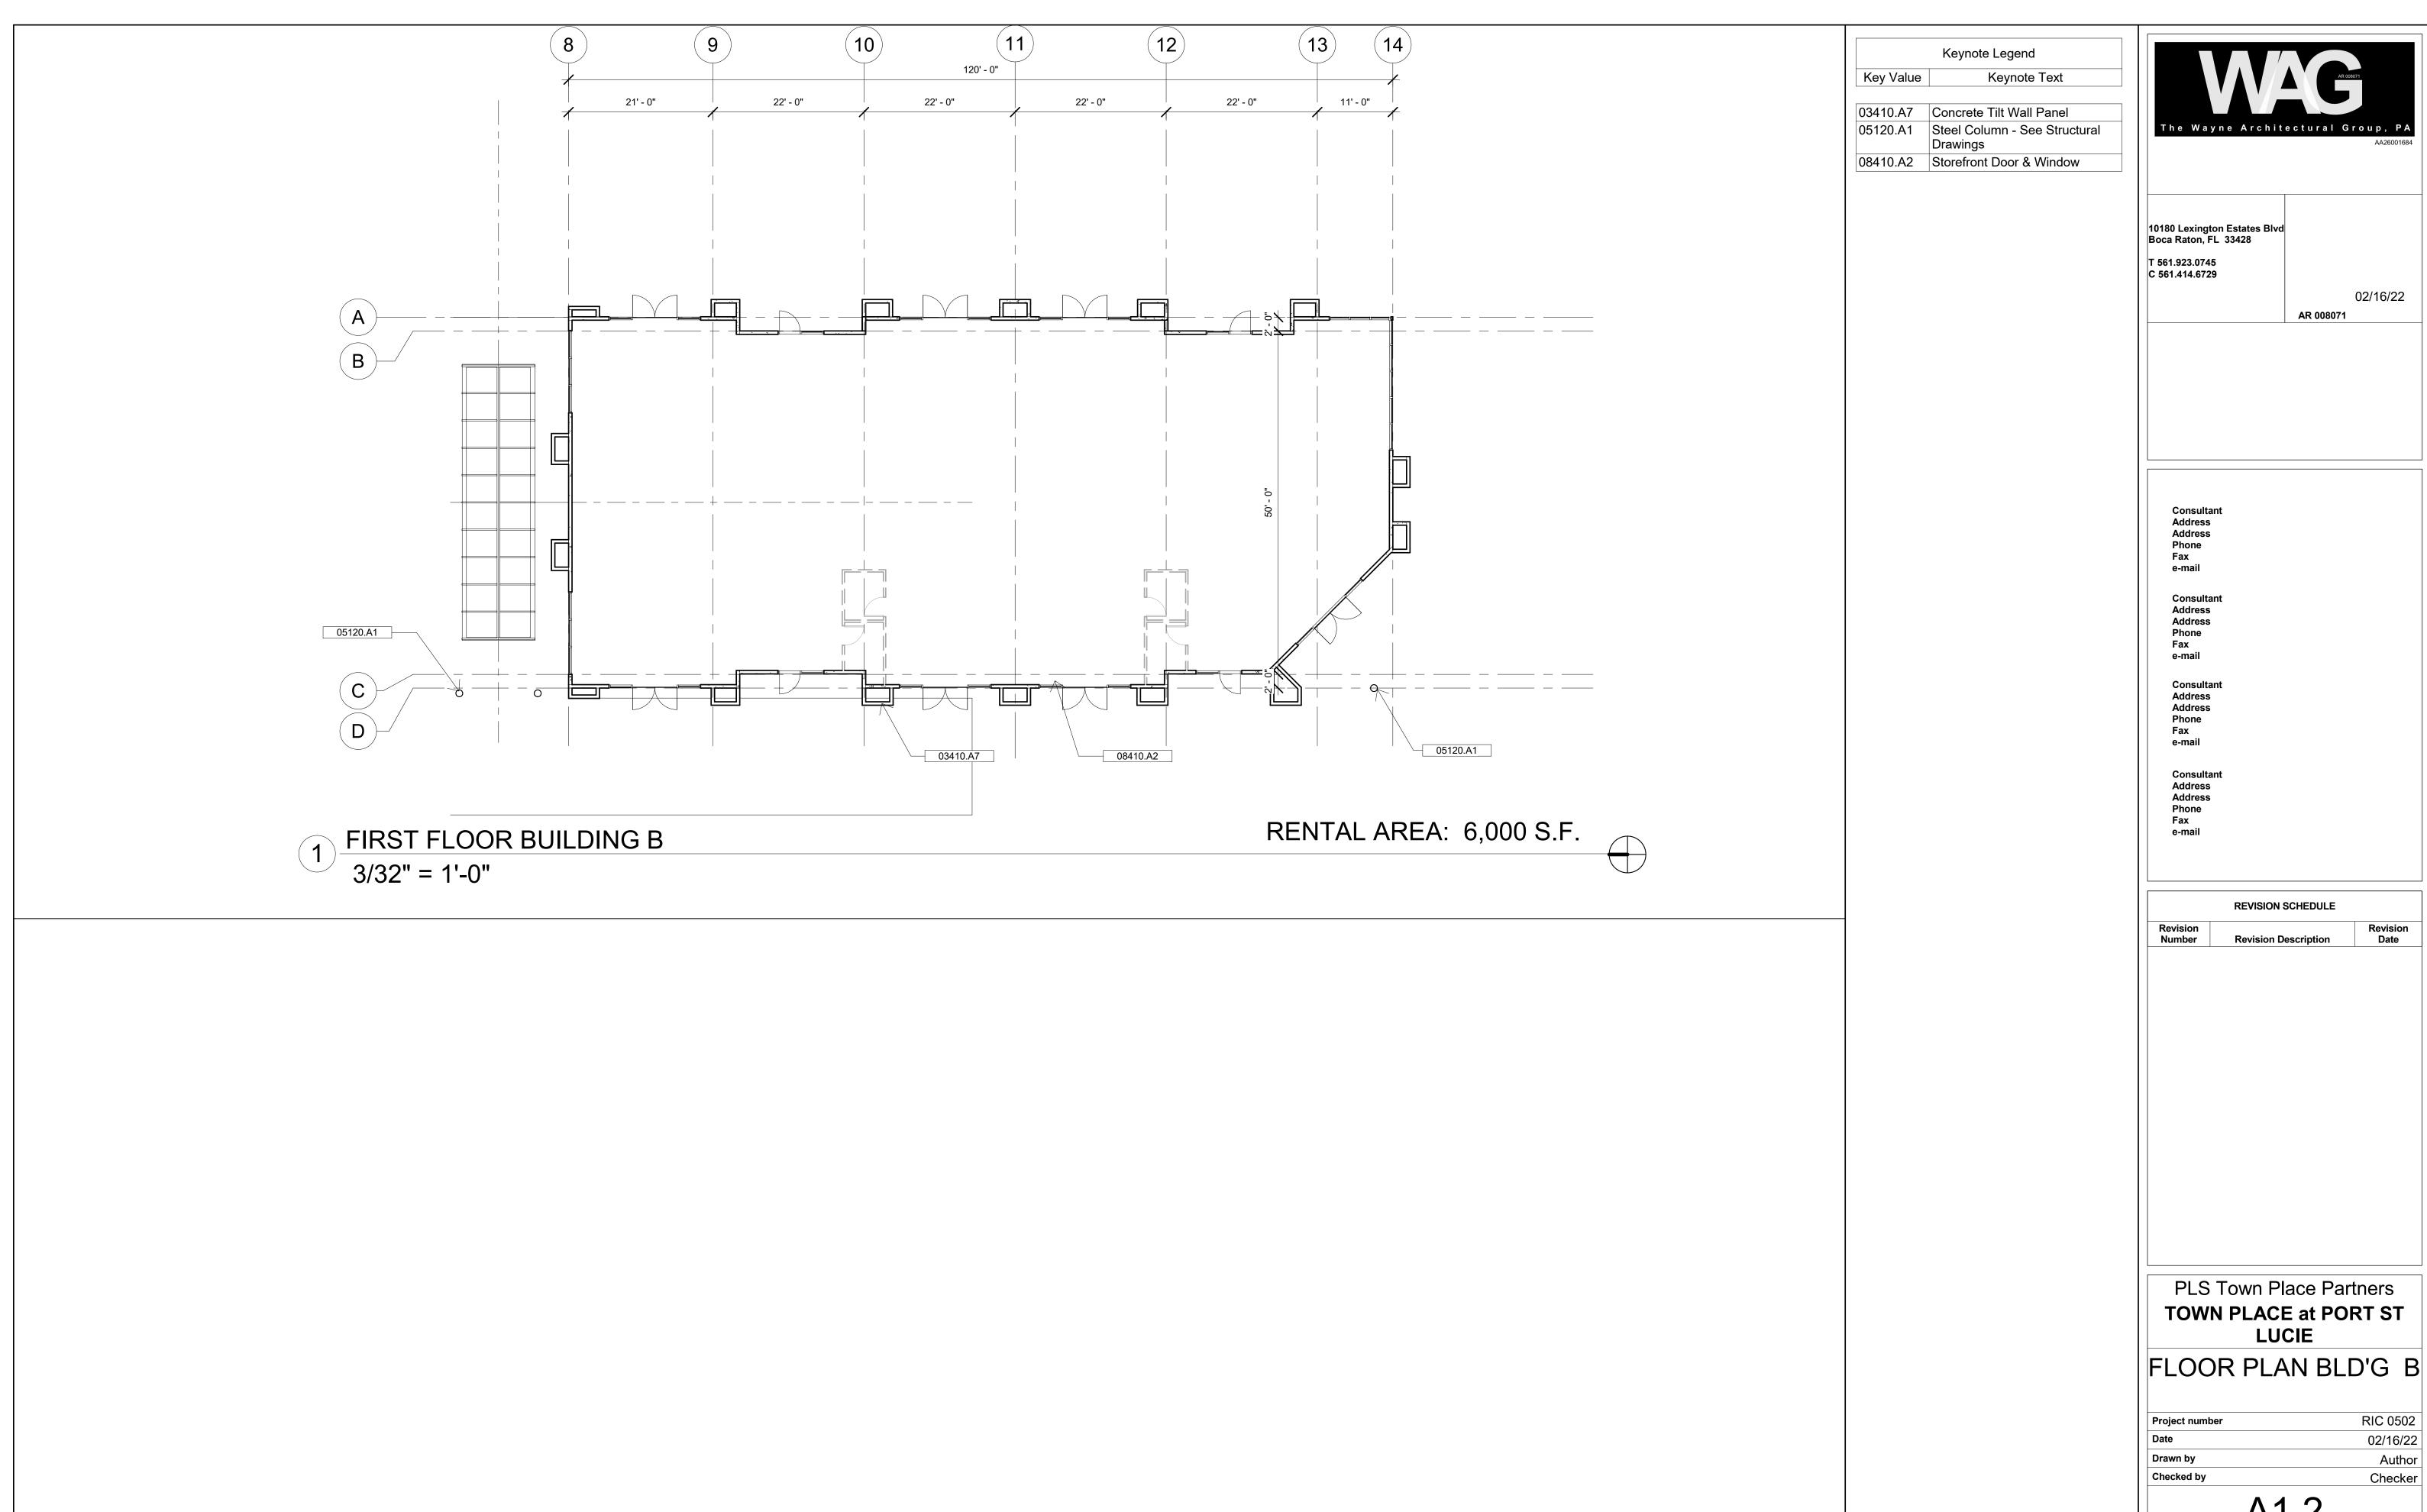

The Wayne Architectural Group, PA

02/16/22


TOWN PLACE at PORT ST


RIC 0502 02/16/22


A1.2

Scale

3/32" = 1'-0"

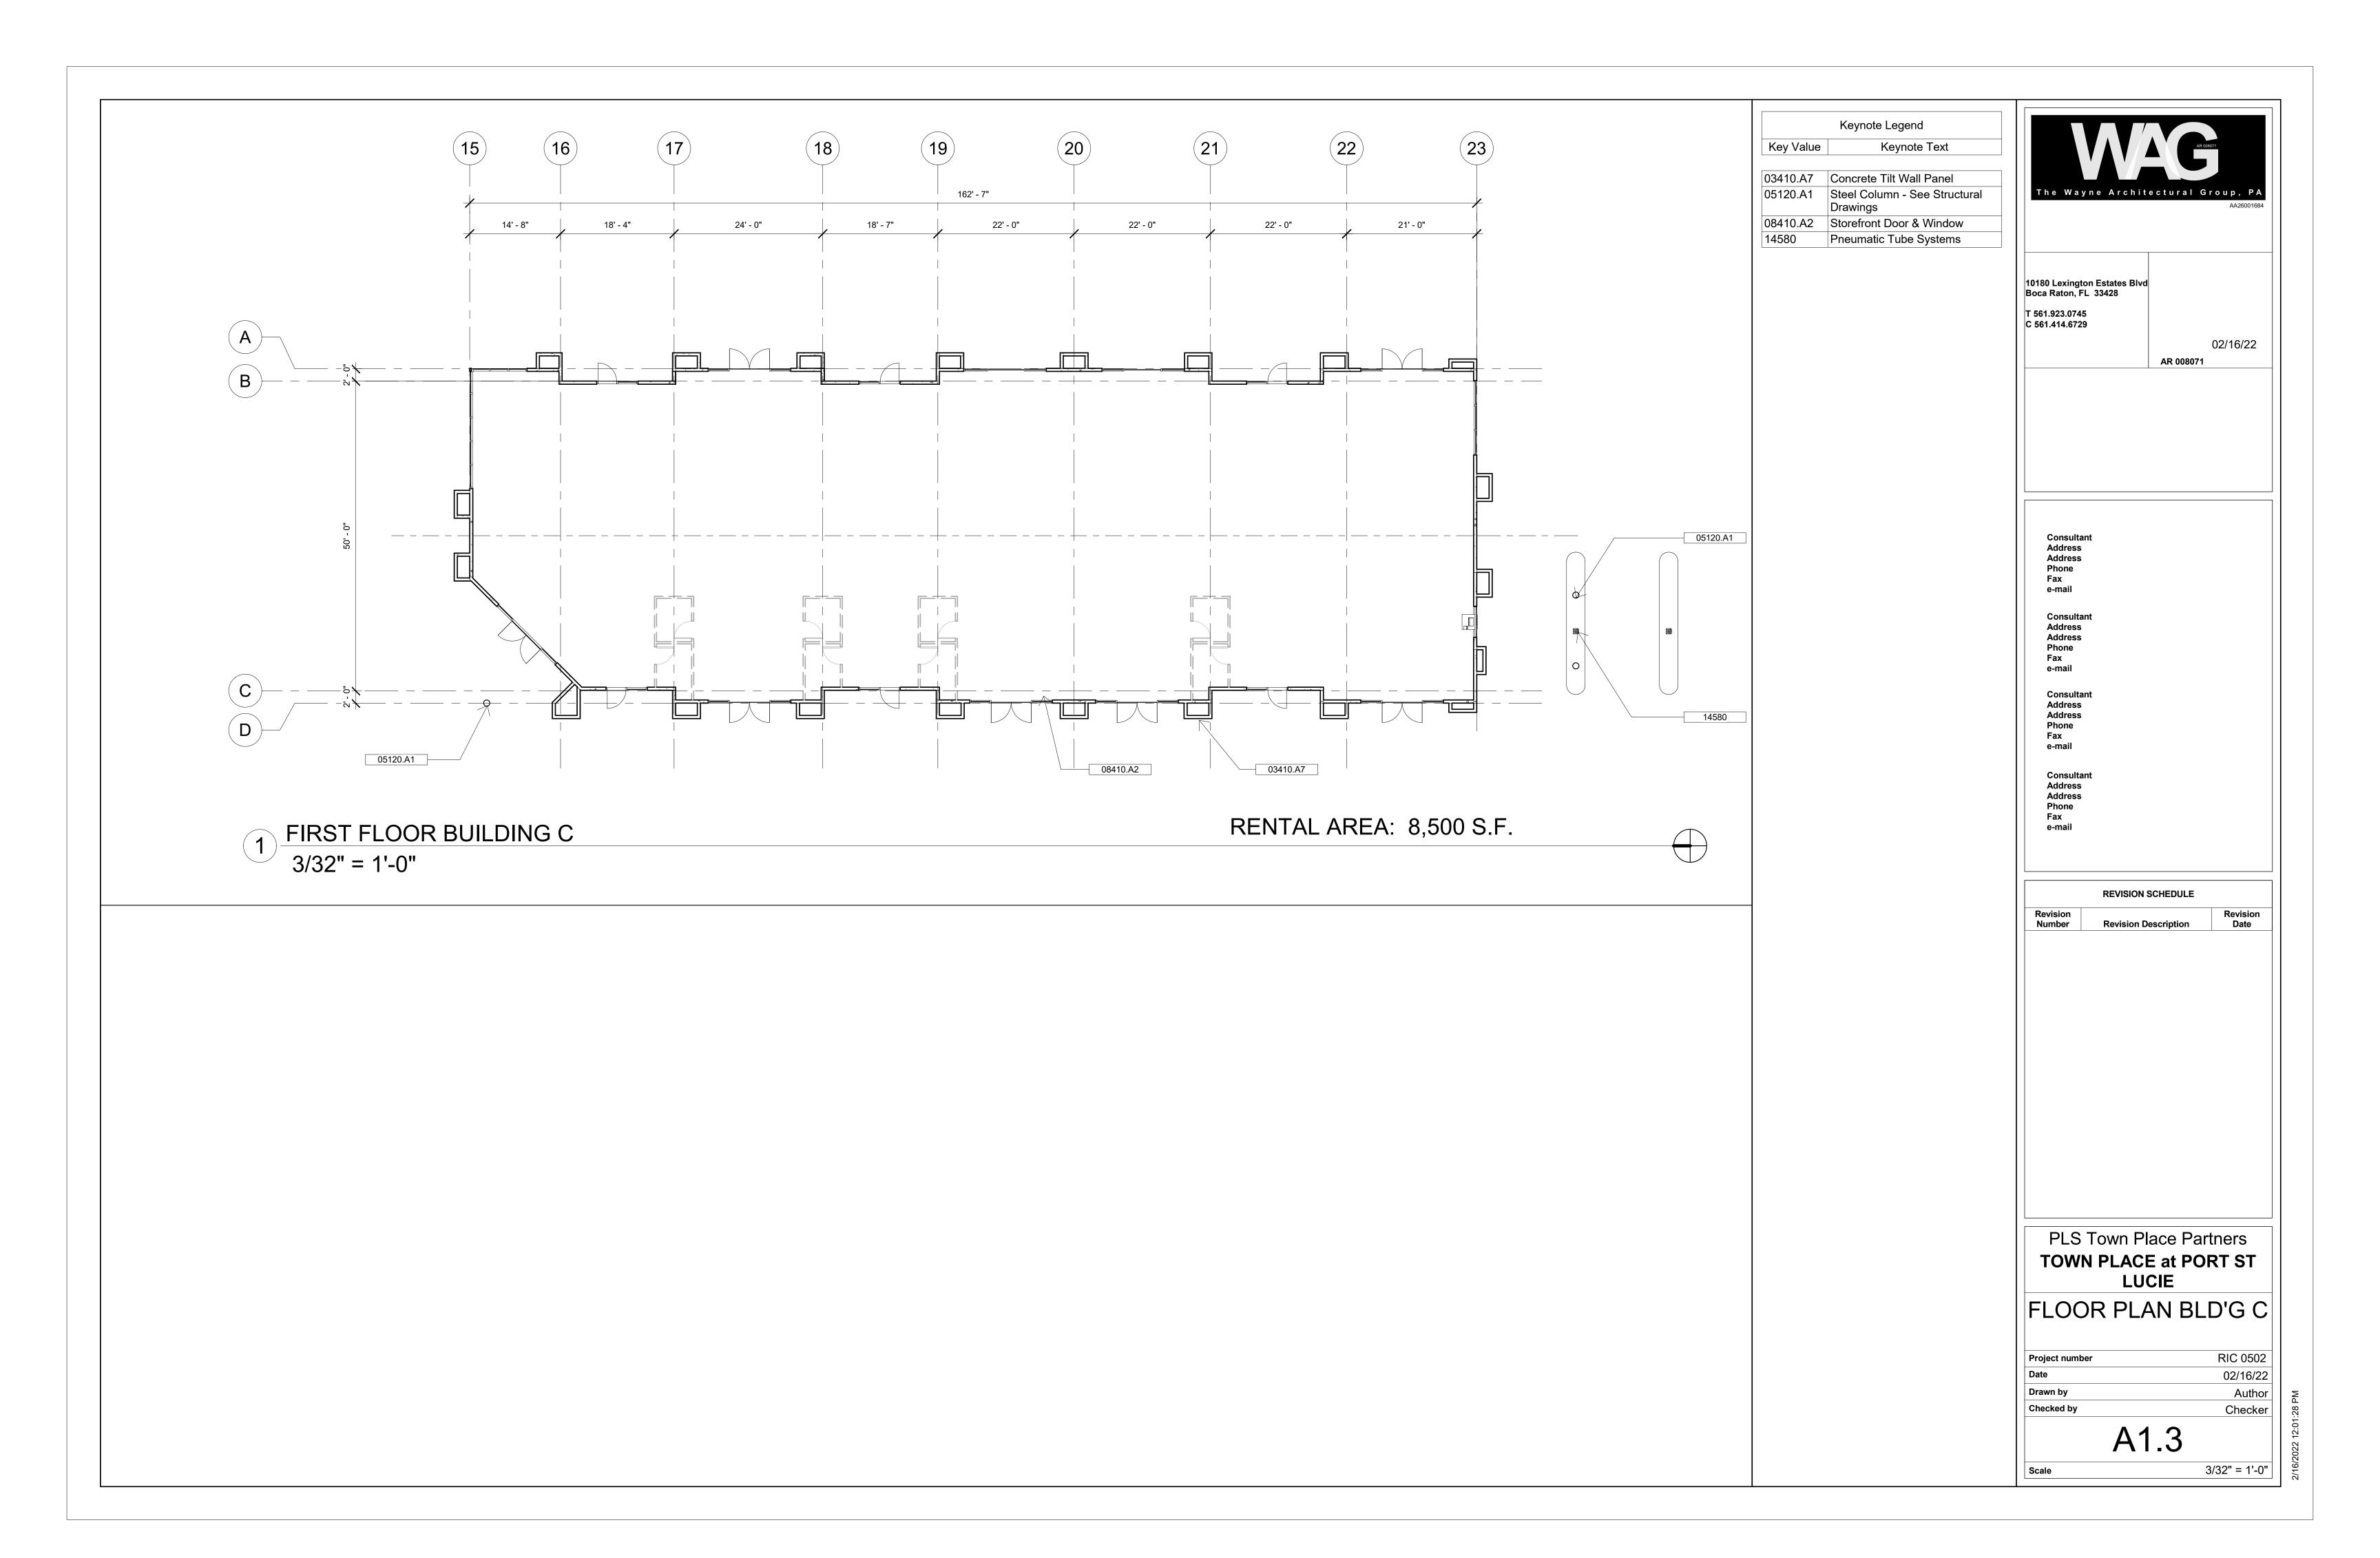

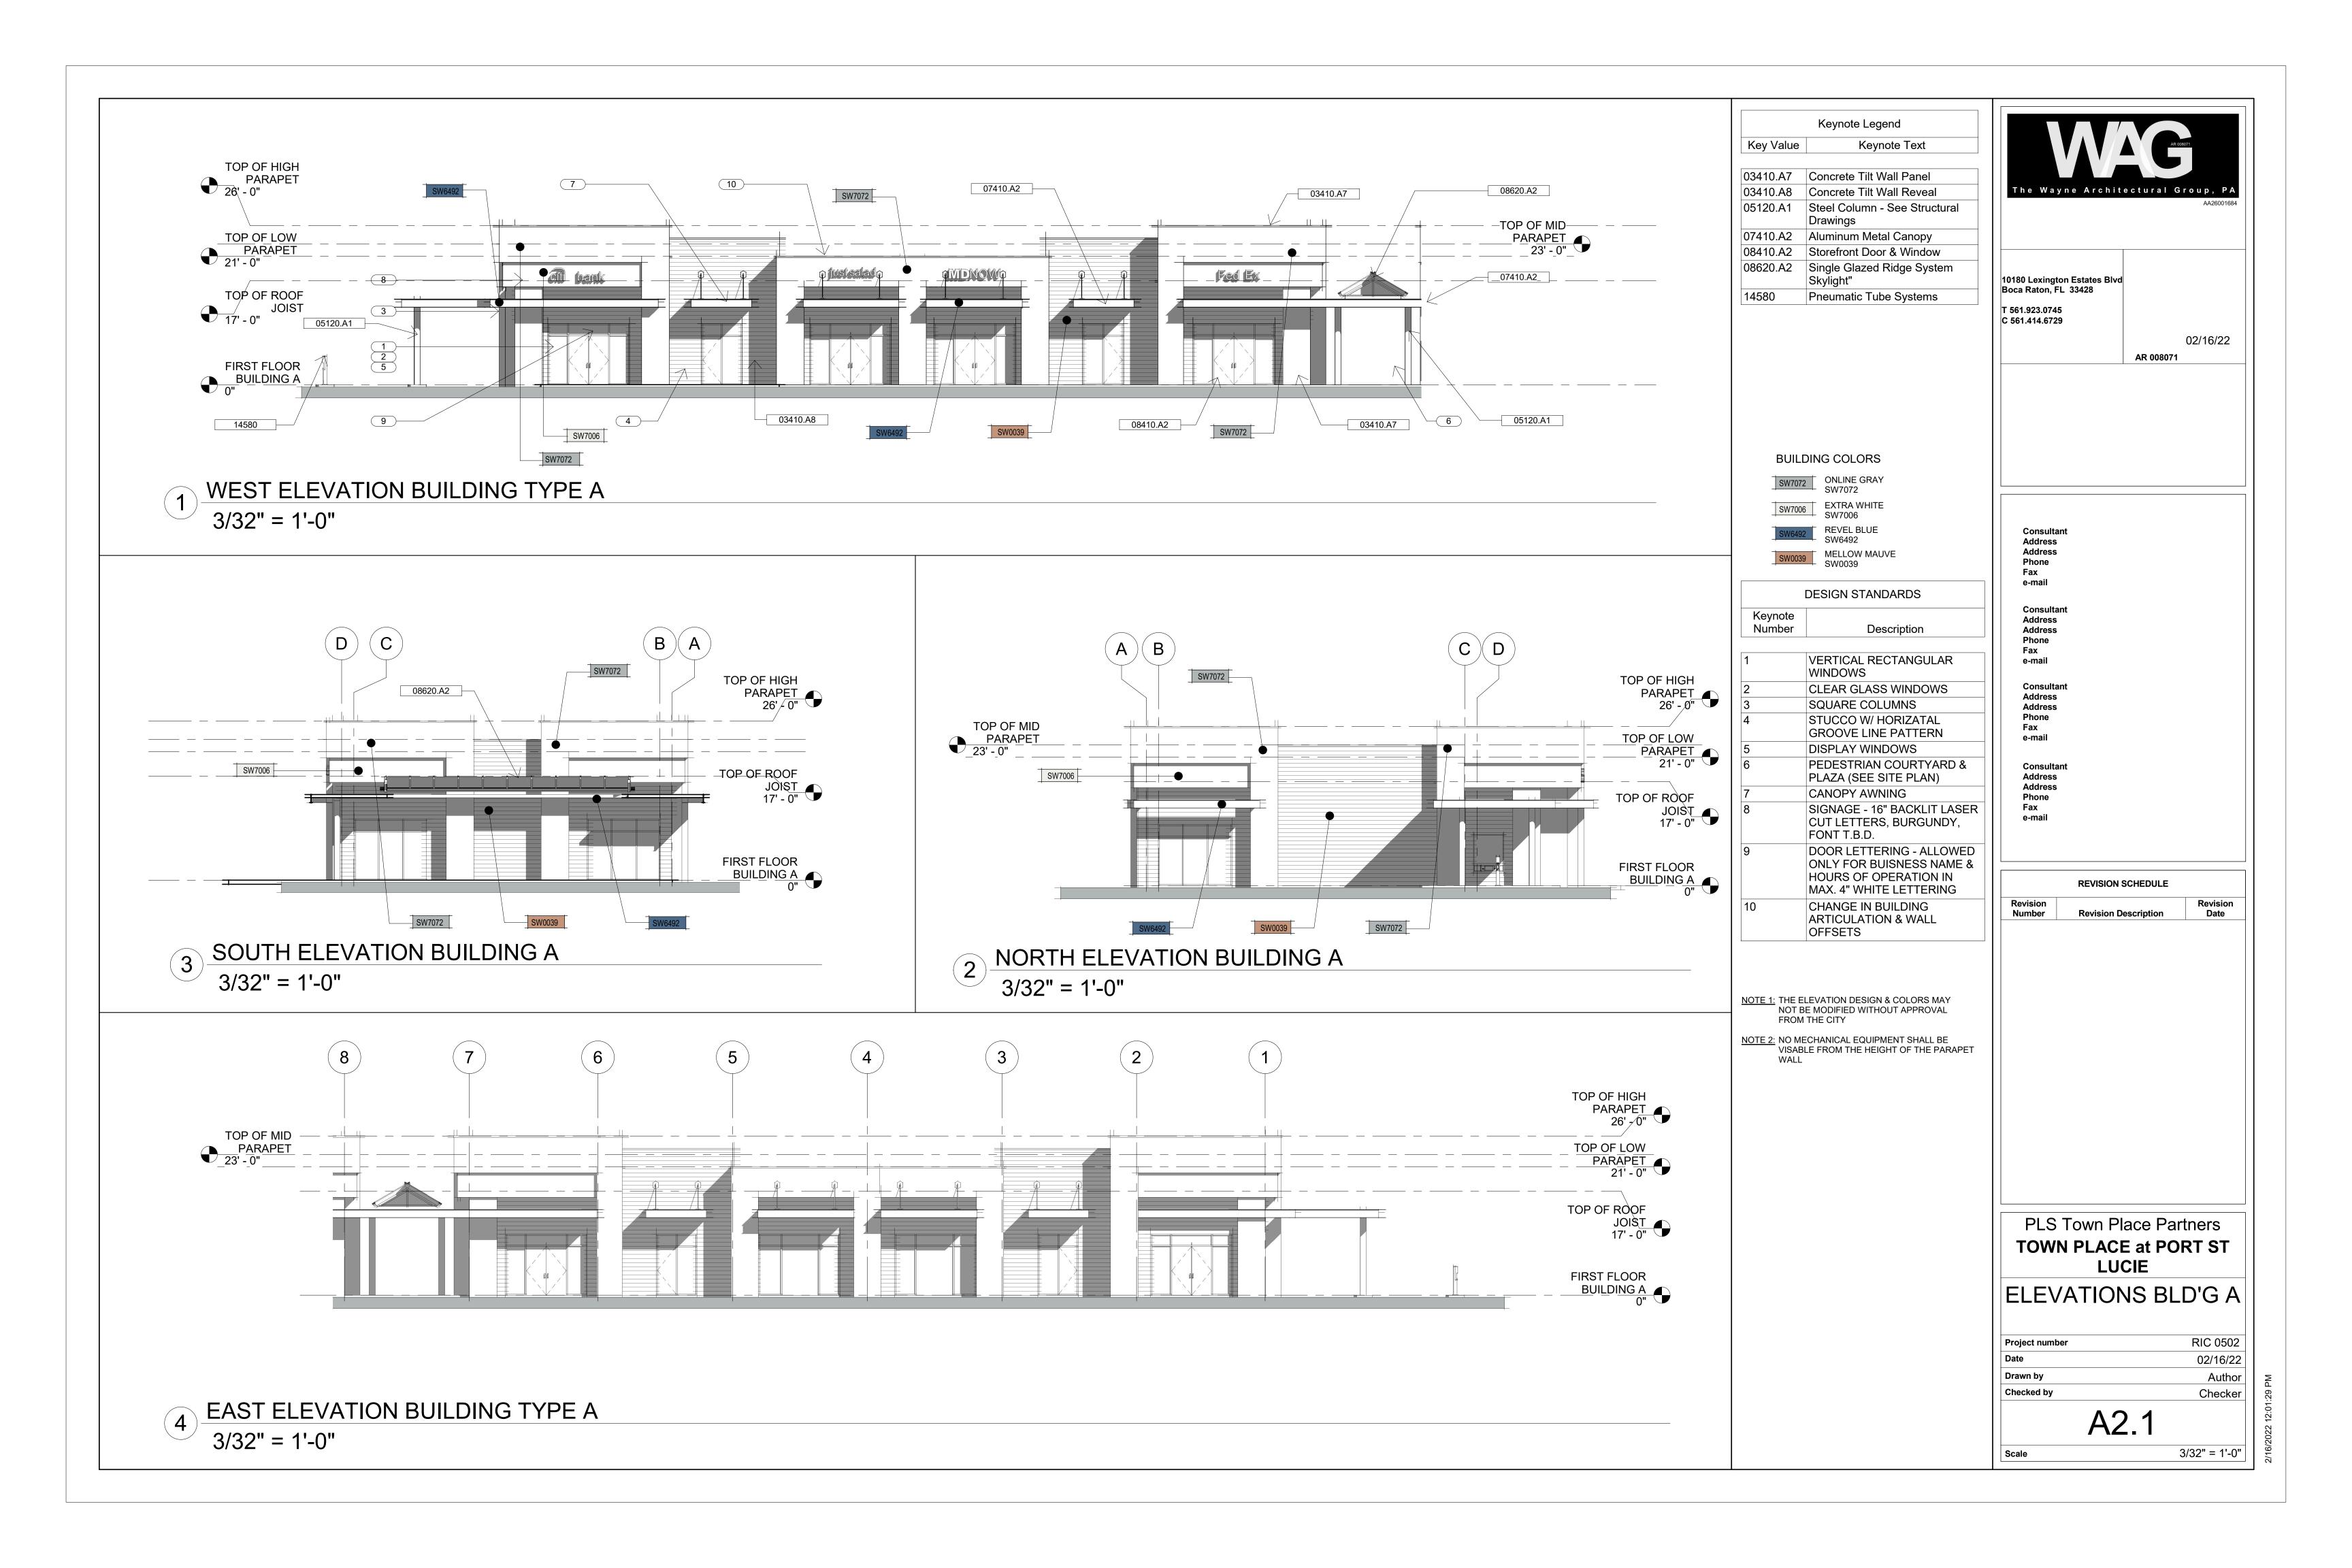

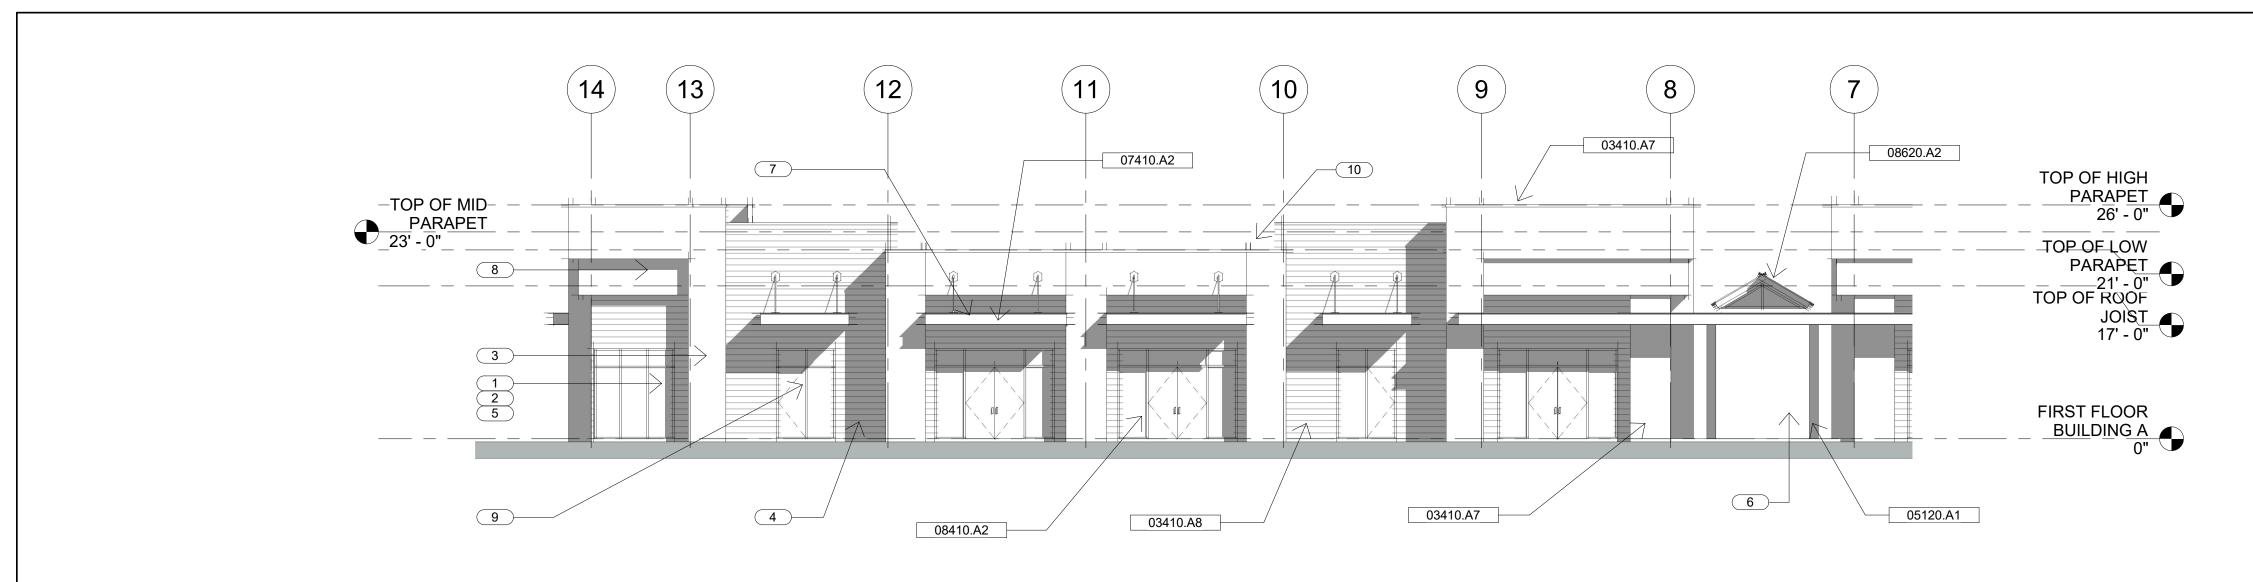

EAST ELEVATION BUILDING TYPE B


3/32" = 1'-0"

TOP OF HIGH
PARAPET
26' - 0"


TOP OF LOW
PARAPET
21' - 0"

TOP OF ROOF JOIST 17' - 0"

FIRST FLOOR

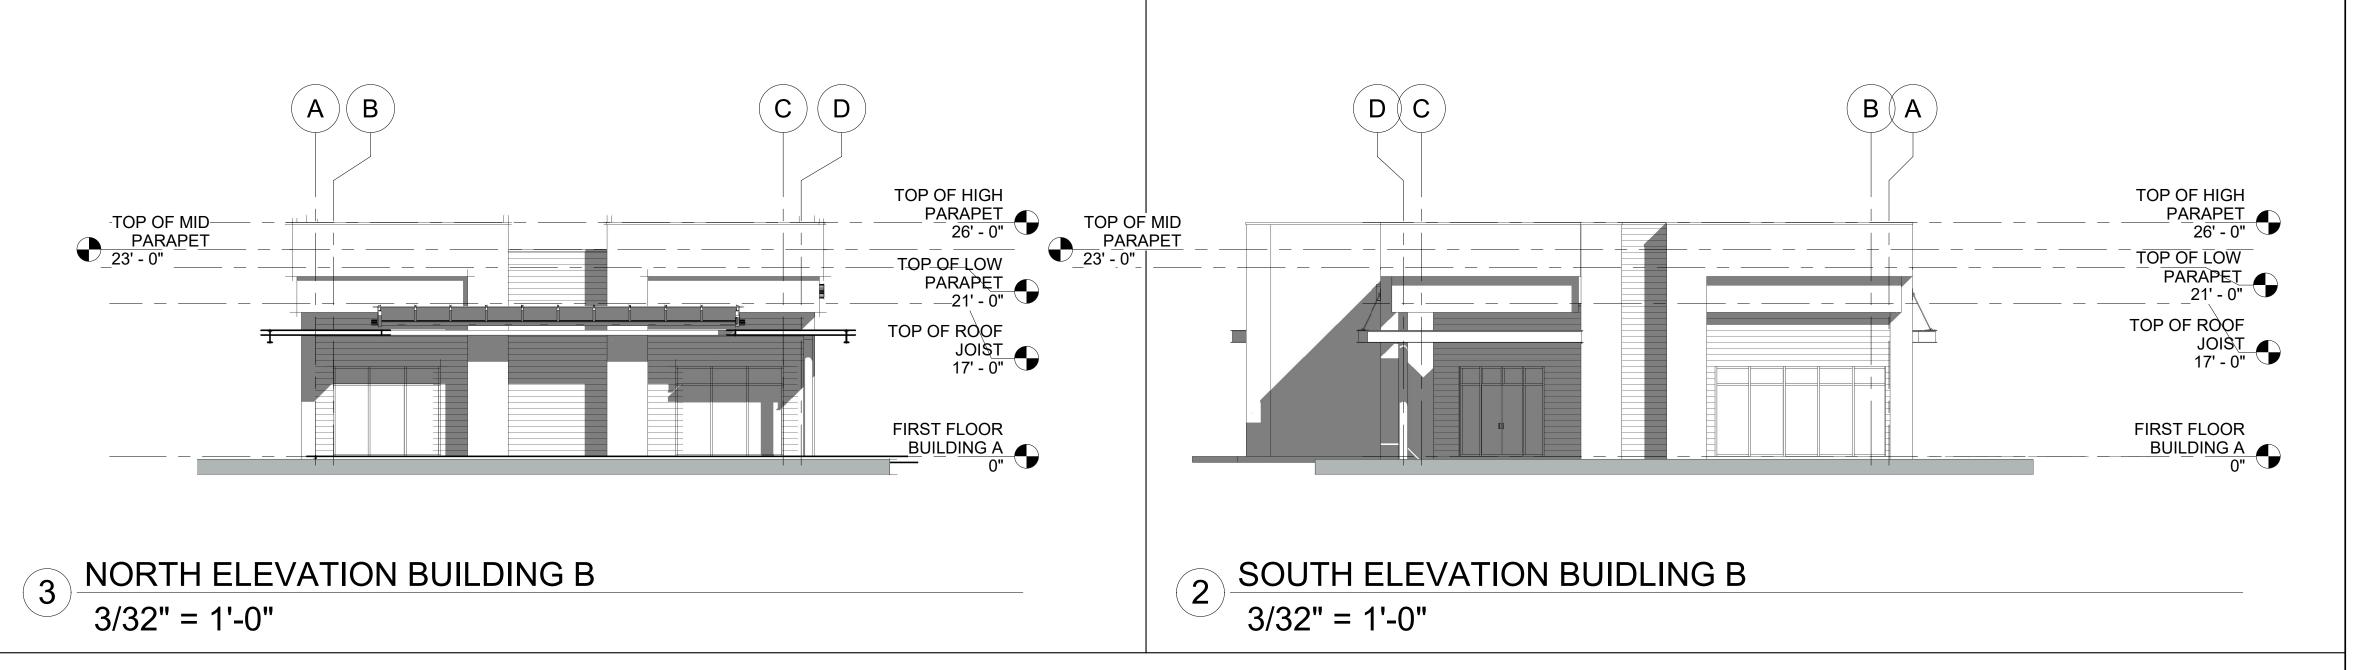

	Keynote Legend
Key Value	Keynote Text
03410.A7	Concrete Tilt Wall Panel
03410.A8	Concrete Tilt Wall Reveal
05120.A1	Steel Column - See Structural Drawings
07410.A2	Aluminum Metal Canopy
08410.A2	Storefront Door & Window
08620.A2	Single Glazed Ridge System Skylight"

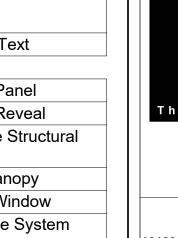



10180 Lexington Estates Blvd Boca Raton, FL 33428 T 561.923.0745

C 561.414.6729

02/16/22

AR 008071

Keynote Number	Description
1	VERTICAL RECTANGULAR WINDOWS
2	CLEAR GLASS WINDOWS
3	SQUARE COLUMNS
4	STUCCO W/ HORIZATAL GROOVE LINE PATTERN
5	DISPLAY WINDOWS
6	PEDESTRIAN COURTYARD & PLAZA (SEE SITE PLAN)
7	CANOPY AWNING
8	SIGNAGE - 16" BACKLIT LASER CUT LETTERS, BURGUNDY, FONT T.B.D.
9	DOOR LETTERING - ALLOWED ONLY FOR BUISNESS NAME & HOURS OF OPERATION IN MAX. 4" WHITE LETTERING
10	CHANGE IN BUILDING ARTICULATION & WALL

DESIGN STANDARDS

NOTE 1: THE ELEVATION DESIGN & COLORS MAY NOT BE MODIFIED WITHOUT APPROVAL FROM THE CITY

PARAPET 23' - 0"

OFFSETS

NOTE 2: NO MECHANICAL EQUIPMENT SHALL BE VISABLE FROM THE HEIGHT OF THE PARAPET

Consultant
Address
Address
Phone
Fax
e-mail

Consultant **Address** Address Phone e-mail

Consultant Address Address Phone Fax

Consultant Address Address Phone Fax

Number

REVISION SCHEDULE

Revision Date

PLS Town Place Partners **TOWN PLACE at PORT ST LUCIE**

ELEVATIONS BLD'G B


RIC 0502 **Project number** 02/16/22 Drawn by Author Checker Checked by

A2.2

Scale

3/32" = 1'-0"

WEST ELEVATION BUILDING TYPE B 3/32" = 1'-0"

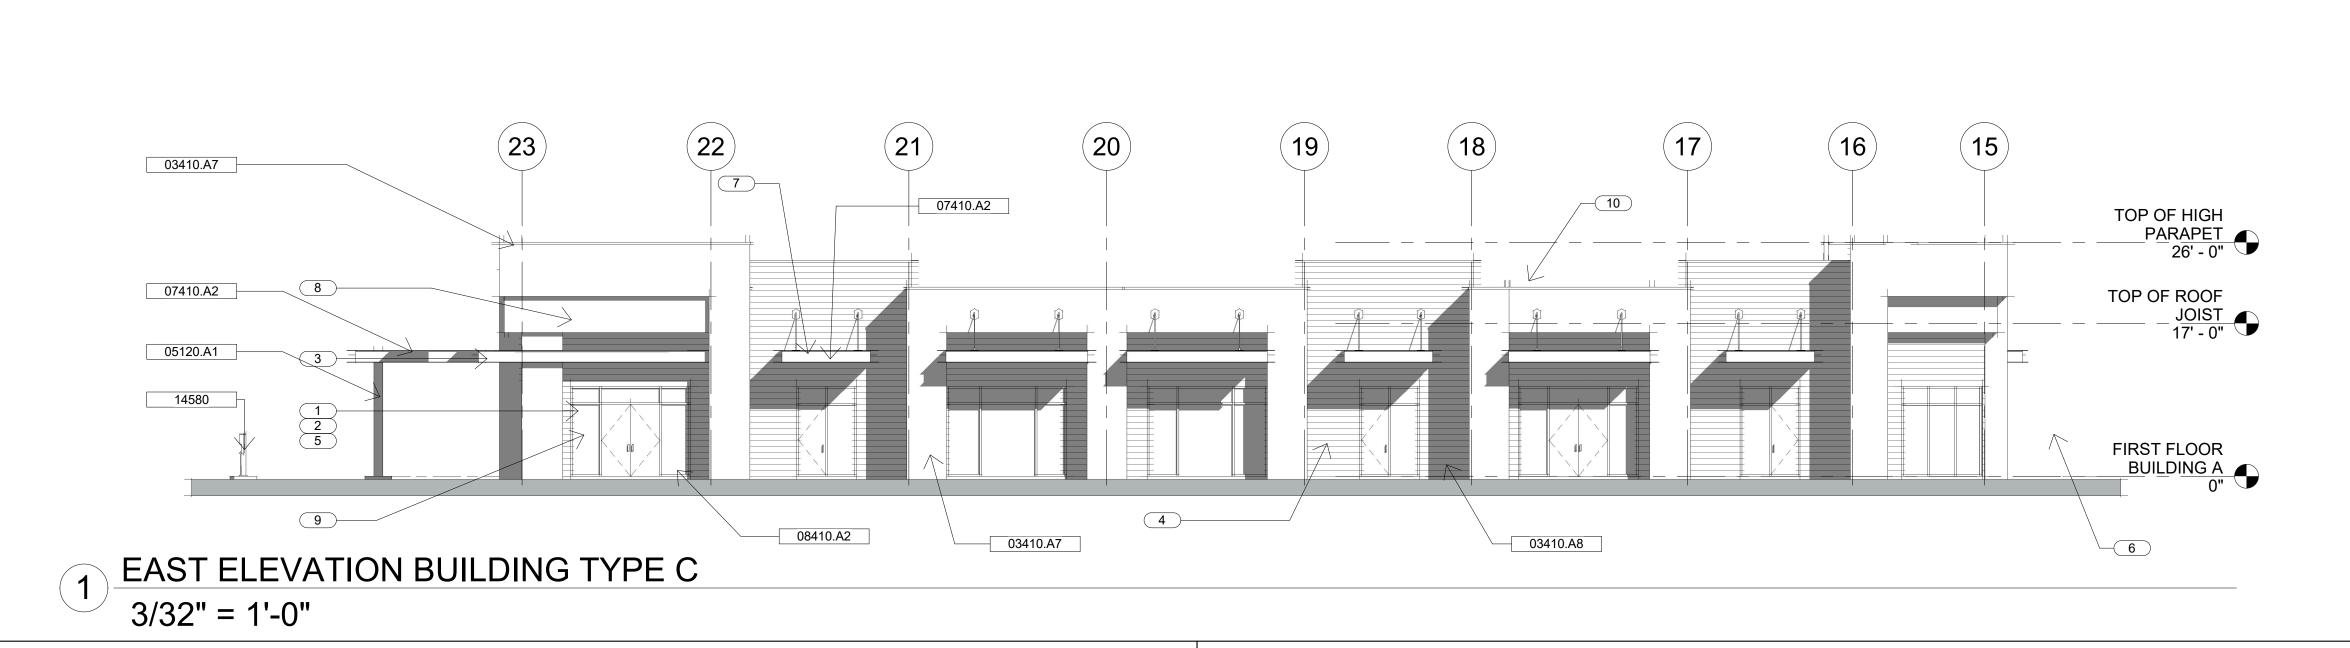

TOP OF HIGH

TOP OF ROOF

FIRST FLOOR

BUILDING A


PARAPET TOP OF MID

PARAPET

SOUTH ELEVATION BUILDING C

(D)

NORTH ELEVATION BUILDING C

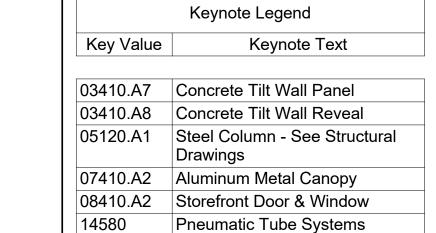



10180 Lexington Estates Blvd Boca Raton, FL 33428 T 561.923.0745

C 561.414.6729

02/16/22 AR 008071

DESIGN STANDARDS Keynote Number Description

VERTICAL RECTANGULAR WINDOWS CLEAR GLASS WINDOWS SQUARE COLUMNS STUCCO W/ HORIZATAL GROOVE LINE PATTERN DISPLAY WINDOWS PEDESTRIAN COURTYARD & PLAZA (SEE SITE PLAN) CANOPY AWNING SIGNAGE - 16" BACKLIT LASER CUT LETTERS, BURGUNDY, FONT T.B.D. DOOR LETTERING - ALLOWED ONLY FOR BUISNESS NAME & HOURS OF OPERATION IN

MAX. 4" WHITE LETTERING

CHANGE IN BUILDING

ARTICULATION & WALL

 $(\mathsf{B}) \mathsf{A}$

TOP_OF_LOW

PARAPET 21' - 0"

NOTE 1: THE ELEVATION DESIGN & COLORS MAY NOT BE MODIFIED WITHOUT APPROVAL FROM THE CITY

OFFSETS

NOTE 2: NO MECHANICAL EQUIPMENT SHALL BE VISABLE FROM THE HEIGHT OF THE PARAPET

Consultant Address Address Phone Fax e-mail
e-mail

Consultant Address Address Phone e-mail

Consultant Address Address Phone Fax e-mail

Consultant Address Address Phone Fax

REVISION SCHEDULE Revision Number

Date

PLS Town Place Partners **TOWN PLACE at PORT ST LUCIE**

ELEVATIONS BLD'G C

RIC 0502 **Project number** 02/16/22 Drawn by Author Checker Checked by

A2.3

Scale

TOP OF HIGH TOP OF ROOF FIRST FLOOR WEST ELEVATION BUILDING TYPE C 3/32" = 1'-0"

3/32" = 1'-0"