

Royal Palm (Type A)

Satakentia Palm


(Type B) Sabal Palm (Type B)

Relocated Sabal Palm (Type B) Triple Alexander Palm

(Type B) Double Alexander (Type B)

> Florida Thatch Palm 'Triple'

Variegated Agave

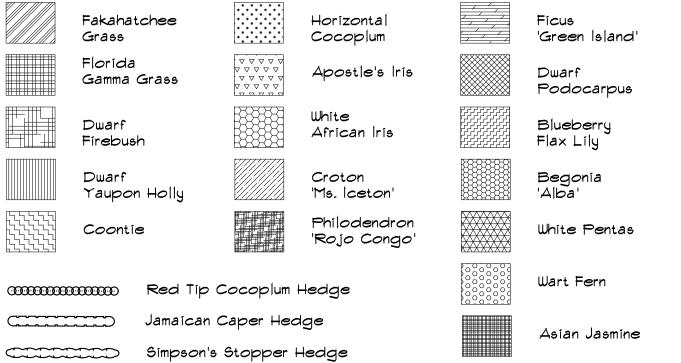

5.8AC. X 0.25 = 1.45AC OF NATIVE UPLAND REQUIRED TO BE PRESERVED

1. Plant descriptions are for minimum acceptable specifications. All criteria listed for container size, caliper, height, spread, etc. must be met for plant material acceptance. For example, if a three gallon shrub does not meet the height or spread specification, it will not

2. If specified plants are unavailable at time of construction, contractor may replace specified plants with plants approved by Landscape Architect and city staff.

3. All open space areas within the property shall be sodded unless paved, seeded and mulched or planted with shrubs and groundcover.

4. All landscaped areas will be 100% irrigated wit ha central automatic irrigation system

5. Contractor to replace any existing sod or other plant materials damaged during construction in areas that are outside proposed landscape as shown on the plan.

I. No landscaping shall be planted in a manner that would adversely affect utility easements. Landscaping shall be in compliance with Chapter 154 of the City of Port St. Lucie Code of

2. All landscaping within City utility easements shall comply with PSLUSD technical


3. All landscaping shall meet the latest PSLUSD Landscape Policy and shall not be placed in a manner that would create conflicts with the intended operation and maintenance of any

4. Trees shall not be planted within ten (10) feet of any PSLUSD underground infrastructure.

5. No landscaping other than sod grasses shall be located within 5' of a PSLUSD appurtenance such as a water meter assembly, back-flow device, fire hydrant or sewer

# CITY OF PORT ST. LUCIE CODE COMPLIANCE STATEMENT

All landscape design, specifications, and installation shall be in conformance with Chapter 154 of the City of Port St. Lucie Code of Ordinances and the Becker Road District Design

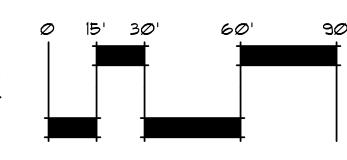

Landscape Architects Environmenta Consultants

Copyright 2021 All Rights Reserved

1907 Commerce Lane Suite 101 Jupiter, Florida 33458 561-575-9557 561-575-5260 FAX

www.2GHO.com 
 The state of the

reliminary

rawn: <u> </u>	ACE ACE GGG/EOM/MTH/DSS
ate: ob no evisions: <sub>-</sub>	23-0106 02.06.2024
	03.18.2024 05.01.2024

LC 0000177

Sheet Title: Landscape Development

Scale: 1"=30'

23-0106

`		
		3-1320 DWG
3	₹	7-7年
)	Y: AN	<u>0</u>
	5/1/24 AT 8:32AM BY: ANNA	OCET-80-1400 ISX DMU JAMO IS-6008

Buffer Type	Required	Proposed		
		Totals	Type A Trees	Type B Trees
Frontage Buffer (North):  430 LF • I TYPE / 2 TYPE B TREES PER 40 LF I SHRUB PER 3 LF, I SF GROUNDCOVER PER 2 LF	II TYPE A TREES 143 SHRUBS 215 GROUNDCOVER	TOTAL TREES: II  * 6 TYPE A  * IO TYPE B  375 SHRUBS  288 GROUNDCOVER	4 QV (LIVE OAK) 2 RE (ROYAL PALM)	6 CS (SILVER BUTTONWOOD) I PT3 (TRIPLE ALEXANDER) 3 SP CLUSTERS (SABALS) * 9 SP TOTAL
East Parking Lot Buffer:  410 LF • I TREE PER 30 LF (A OR B) I SHRUB PER 2 LF	I4 TREES 205 SHRUBS	TOTAL TREES: 14 274 SHRUBS	I2 QV (LIVE OAK) 2 SP CLUSTERS (SABALS) *6 SP TOTAL	
West Parking Lot Buffer: 410 LF • I TREE PER 30 LF (A OR B) I SHRUB PER 2 LF	I4 TREES 215 SHRUBS	TOTAL TREES: 14 278 SHRUBS	I2 QV (LIVE OAK) 2 SP CLUSTERS (SABALS) *6 SP TOTAL	
Detention (South) Buffer:  570 LF • I TYPE / 2 TYPE B TREES PER 40 LF I SHRUB PER 8 LF, I SF GROUNDCOVER PER 8 LF	14 TYPE A TREES 72 SHRUBS 72 GROUNDCOVERS	TOTAL TREES; 14  * 13 TYPE A  * 2 TYPE B  276 SHRUBS  170 GROUNDCOVERS	13 A3 (RED MAPLE)  *ADDITIONAL QV-I PROVIDED FOR ENHANCED SCREENING	2 SP CLUSTERS (SABALS) *6 SP TOTAL
Building Foundation:  880 LF • I TYPE B TREE PER 30 LF OF WALL I SHRUB PER 2 LF OF BLDG, PERIMETER I SF GROUNDCOVER PER 3 LF OF BLDG, PERIMETER	I5 TREES 440 SHRUBS 294 GROUNDCOVER	I8 TREES 575 SHRUBS 692 GROUNCOVER	2 LJ (LIGUSTRUM) 2 ED (JAPANESE BLUEBERR 12 PT2 (DOUBLE ALEXANDER 2 SL (SATAKENTIA PALM)	
Parking Area Landscape:  I TREE PER ISLAND (A OR B)  (*COUNT INCLUDES 12 RSP)	67 TREES	67 TREES  *4 ISLANDS WITH RSP (RELOCATED SABALS)	34 QV (LIVE OAK) 17 BS (GUMBO LIMBO) 4 RE (ROYAL PALM) 8 SP CLUSTERS (SABALS) *24 SP TOTAL 4 RSP CLUSTERS (RELOCAT	ED SABALS)

\* SHADE TREES SHALL HAVE A HEIGHT OF 12', A SPREAD OF 5', AND CALIPER OF 2,5" AT TIME OF PLANTING (154,04(C)(2)

\* PALM TREES SHALL HAVE A MINIMUM CT OF 10' AT TIME OF PLANTING (154,04(C)(2) \* TREE/PALM HEIGHTS MAY BE REDUCED TO 8' AROUND BUILDING FACADE (154,04(C)(2)

\* 2 TYPE B TREES MAY COUNT FOR I TYPE A TREE (BECKER ROAD OVERLAY STANDARDS 5,6) \* ROYAL PALMS MAY COUNT FOR I TYPE A TREE (MIN, 10' CT) (154,04(C)(2), (154 APPENDIX C)

\* A CLUSTER OF 3 SABAL PALMS MAY COUNT AS I TYPE B TREE (MIN, 8-16' CT) \* A CLUSTER OF 3 SABAL PALMS MAY COUNT AS I PARKING LOT ISLAND TREE OR STANDARD BUFFER TREE

# Landscape Material Standards

PER CHAPTER 154 OF THE CITY OF PORT ST, LUCIE CODE OF ORDINANCES

TOTAL REQUIRED SITE-WIDE TREES: 135

PERCENTAGE OF REQUIRED NATIVE TREES/PALMS (154,04(C)(5); 50% (68 TREES)

PERCENTAGE OF PROVIDED NATIVE TREES/PALMS (154,04(C)(5): 88% (119 TREES)

REQUIRED SPECIES MIX (154,04(C)(8); 5 SPECIES MINIMUM

PROVIDED SPECIES MIX (154,04(C)(8): 10 TREE/PALM SPECIES

TOTAL REQUIRED PARKING LOT TREES (154,04(C)(7): 67

PERCENTAGE OF REQUIRED SHADE TREES (154,04(C)(7); 75% (49 TREES)

PERCENTAGE OF PROVIDED SHADE TREES (154,04(C)(7): 76% (51 TREES)

TOTAL REQUIRED TREES (EXCLUDING BUILDING FACADE) (154,04(C)(4): 120 MAX, PERCENTAGE OF REQUIRED TREES THAT MAY CONSIST OF PALMS (154,04(C)(4): 25% (30 PALM EQUIVALENT TREES)

PERCENTAGE OF PROVIDED TREES CONSISTING OF PALMS (154,04(C)(4): 24% (28 PALM EQUIVALENT TREES)

\_\_\_\_\_\_\_

# Plant List

KEY	QTY.	BOTANICAL NAME	COMMON NAME	HEIGHT	SPREAD	CALIPER	SPACING	D.T.	NATIVE	REMARKS
AR1	13	ACER RUBRUM 'FLORIDA FLAME'	FLORIDA FLAME MAPLE	12'	5'	2.5"	A.S.	М	Υ	[TYPE A] FULL & THICK, MATCHED
BS	17	BURSERA SIMARUBA	GUMBO LIMBO	12'	5'	3"	A.S.	V	Υ	[TYPE A] 5' C.T. MIN. FULL SPECIMEN
CS	6	CONOCARPUS ERECTUS 'SERICEUS'	SILVER BUTTONWOOD	8'-10'	5'	2.5"	A.S.	V	Y	[TYPE B] FULL DENSE CANOPY, STANDARD
ED	2	ELAEOCARPUS DECIPIENS	JAPANESE BLUEBERRY	8'	5'	3"	A.S.	М	N.	[TYPE B] CONICAL; MATCHED; STANDARD
HR	4	HIBISCUS 'SEMINOLE PINK'	PINK HIBISCUS STANDARD	6'	3-4'	1.5" MIN.	A.S.	M	N	FULL; MATCHED; STANDARD [ACCENT]
	:			6'						·
JI 	4	JATROPHA INTEGERRIMA	JATROPHA		3-4'	1.5" MIN.	A.S.	L	N	FULL; MATCHED; STANDARD [ACCENT]
LJ	2	LIGUSTRUM JAPONICUM	WAX PRIVET	8'	6-7'	MULTI	A.S.	M	N	[TYPE B] FULL DENSE CANOPY; MATCHED; 3 TRUNK MIN; LIMB UP 3'
QV	62	QUERCUS VIRGINIANA	LIVE OAK	12'	5'	2.5"	A.S.	V	Υ	[TYPE A] FL NO 1 OR BETTER; MINIMUM 5' C.T.
QV-1	10	QUERCUS VIRGINIANA	LIVE OAK	12-14'	5-6'	3"	A.S.	V	Y	[TYPE A] FL NO 1 OR BETTER; MINIMUM 5' CT
PALN	<b>IS</b>									
KEY	QTY.	BOTANICAL NAME	COMMON NAME	HEIGHT		CALIPER	SPACING	D.T.	NATIVE	REMARKS
PT2	12	PTYCHOSPERMA ELEGANS	ALEXANDER PALM 'DOUBLE'	12'	C.T.	DOUBLE	A.S.	М	N	[TYPE B] FULL, DOUBLE TRUNK, MATCHED HEIGHTS SCAR FREE
PT3	1	PTYCHOSPERMA ELEGANS	ALEXANDER PALM 'TRIPLE'	12'	G.W.	TRIPLE	A.S.	L	N	[TYPE B] FULL & THICK, TRIPLE TRUNK, SCAR FREE; ~15' C.T.
RE	8	ROYSTONEA ELATA	ROYAL PALM	14'	G.W.	HEAVY	A.S.	М	Y	[TYPE A] HEAVY DARK GREEN HEAD; SCAR FREE TRUNKS; MATCHE
						TIEAVI				SPECIMENS; ~ 20' CT
SP	70	SABAL PALMETTO	SABAL PALM	8-16'	C.T.	-	A.S.	V	Υ	[TYPE B] STAGGER HEIGHTS IN GROUPS, HURRICANE CUT
RSP	12	SABAL PALMETTO	RELOCATED SABAL PALM	-		-	A.S.	М	Υ	[TYPE B] RELOCATED ON-SITE
SL	2	SATAKENTIA LIUKIUENSIS	SATAKENTIA PALM	10'	C.T.	SINGLE	A.S.	L	N	[TYPE B] FULL & THICK MATCHED SPECIMEN HEIGHTS - SCAR FREE
TR	11	THRINAX RADIATA	FLORIDA THATCH PALM 'SINGLE'	6-7'	O.A.	SINGLE	A.S.	V	Y	FULL & THICK, MATCHED HEIGHTS
ACCE	ENTS									
KEY	QTY.	BOTANICAL NAME	COMMON NAME	HEIGHT	SPREAD	GAL.	SPACING	D.T.	NATIVE	REMARKS
AGM	6	AGAVE AMERICANA 'MARGINATA'	VARIEGATED AGAVE	30"	30"	#15	A.S.	V	N	1 P.P.P.
AGA	6	AGAVE ATTENUATA	SPINELESS AGAVE	30"	30"	#15	A.S.	V	N	SPECIMEN 1 P.P.P.
SHRL	JBS									
KEY		BOTANICAL NAME	COMMON NAME	HEIGHT	SPREAD	GAL.	SPACING	D.T.	NATIVE	REMARKS
CCY		CAPPARIS CYNOPHALLOPHORA	JAMAICA CAPER	48"	24"	-	2' O.C.	V	Y	FULL TO BASE
CHR		CHRYSOBALANUS ICACO 'RED TIP'	RED TIP COCOPLUM	24"	16"	#3 MIN	2' O.C.	V	Y	FULL TO BASE
COD		CODIAEUM 'MS. ICETON'	MS. ICETON CROTON	15"	15"	#5 WIIIV	2' O.C.	M	N	FULL TO BASE
HAC		HAMELIA PATENS 'COMPACTA'	DWARF FIREBUSH	15"	15"		2.5' O.C.	V	Y	FULL TO BASE
						- #2NAINI				
MFR		MYRCIANTHES FRAGRANS	SIMPSON'S STOPPER	24"	16"	#3MIN	2' O.C.	V	N	FULL TO BASE; COMPACT VARIETY
TRD TFL	289 1056	TRIPSACUM DACTYLOIDES TRIPSACUM FLORIDANA	FAKAHATCHEE GRASS FLORIDA GAMMA GRASS	18" 15"	18" 15"	-	3' O.C. 2' O.C.	V V	Y Y	FULL DENSE CLUMP FULL DENSE CLUMP
	• (055	DELOW DETAIL FOR TRELLIO OURDOO	OT 01/07514)							
VINE	- •	BELOW DETAIL FOR TRELLIS SUPPOR BOTANICAL NAME	COMMON NAME	HEIGHT	SPREAD	GAL.	SPACING	пт	NATIVE	E REMARKS
	39	TRACHELOSPERMUM JASMINOIDES	CONFEDERATE JASMINE	5'	18"	-	1.5' O.C.	M	N	5' H ON TRELLIS: MULTIPLE RUNNERS:
TR.IA	00	THE CONTROL OF THE CO	GOIN EBERTITE WOMEN	TRELLIS	10		1.0 0.0.		.,	FULL & THICK
TRJA										
	UNDC	OVER								
GROU KEY	QTY.	BOTANICAL NAME	COMMON NAME	HEIGHT		GAL.	SPACING			E REMARKS
GROU	<b>QTY</b> .	BOTANICAL NAME BEGONIA ODORATA 'ALBA' CHRYSOBALANUS ICACO	COMMON NAME BEGONIA ODORATA HORIZONTAL COCOPLUM	<b>HEIGHT</b> 12" 14"	12" 14"	GAL. - -	1.5' O.C. 2.5' O.C.	<b>D.T.</b>	NATIVE N Y	FULL TO BASE FULL & THICK;
GROU KEY BEG CHH	QTY. 206 331	BEGONIA ODORATA 'ALBA' CHRYSOBALANUS ICACO 'HORIZONTAL'	BEGONIA ODORATA HORIZONTAL COCOPLUM	12" 14"	12" 14"	-	1.5' O.C. 2.5' O.C.	V V	N Y	FULL TO BASE FULL & THICK;
GROUNE BEG CHH	QTY. 206 331 193	BOTANICAL NAME BEGONIA ODORATA 'ALBA' CHRYSOBALANUS ICACO 'HORIZONTAL' DIANELLA TASMANICA	BEGONIA ODORATA HORIZONTAL COCOPLUM BLUEBERRY FLAX LILY	12" 14" 10"	12" 14" 10"	-	1.5' O.C. 2.5' O.C. 1.5' O.C.	V V M	N Y N	FULL TO BASE FULL & THICK; FULL DENSE CLUMP
GROUNE SEGNIC CHH	QTY. 206 331 193 207	BOTANICAL NAME BEGONIA ODORATA 'ALBA' CHRYSOBALANUS ICACO 'HORIZONTAL' DIANELLA TASMANICA DIETES VEGETA	BEGONIA ODORATA HORIZONTAL COCOPLUM BLUEBERRY FLAX LILY AFRICAN IRIS	12" 14" 10" 12"	12" 14" 10" 12"	- - -	1.5' O.C. 2.5' O.C. 1.5' O.C. 2' O.C.	V V M V	N Y N N	FULL TO BASE FULL & THICK;  FULL DENSE CLUMP WHITE; FULL DENSE CLUMP
GROUNE BEG CHH DIT DVE FIM	206 331 193 207 410	BEGONIA ODORATA 'ALBA' CHRYSOBALANUS ICACO 'HORIZONTAL' DIANELLA TASMANICA DIETES VEGETA FICUS MICROCARPA 'GREEN ISLAND'	BEGONIA ODORATA HORIZONTAL COCOPLUM BLUEBERRY FLAX LILY AFRICAN IRIS GREEN ISLAND FICUS	12" 14" 10" 12" 12"	12" 14" 10" 12" 12"	- - - -	1.5' O.C. 2.5' O.C. 1.5' O.C. 2' O.C. 2' O.C.	V V M V	N Y N N	FULL TO BASE FULL & THICK;  FULL DENSE CLUMP WHITE; FULL DENSE CLUMP FULL TO BASE
GROUNDER SERVING SERVI	206 331 193 207 410 268	BOTANICAL NAME BEGONIA ODORATA 'ALBA' CHRYSOBALANUS ICACO 'HORIZONTAL' DIANELLA TASMANICA DIETES VEGETA FICUS MICROCARPA 'GREEN ISLAND' ILEX VOMITORIA 'STOKES DWARF'	BEGONIA ODORATA HORIZONTAL COCOPLUM  BLUEBERRY FLAX LILY AFRICAN IRIS GREEN ISLAND FICUS STOKES DWARF	12" 14" 10" 12" 12" 12"	12" 14" 10" 12" 12" 12"	- - -	1.5' O.C. 2.5' O.C. 1.5' O.C. 2' O.C. 2' O.C. 2' O.C.	V V M V V	N Y N N N Y	FULL TO BASE FULL & THICK;  FULL DENSE CLUMP WHITE; FULL DENSE CLUMP FULL TO BASE FULL TO BASE
GROUNE SEGNIC CHH	206 331 193 207 410 268	BEGONIA ODORATA 'ALBA' CHRYSOBALANUS ICACO 'HORIZONTAL' DIANELLA TASMANICA DIETES VEGETA FICUS MICROCARPA 'GREEN ISLAND'	BEGONIA ODORATA HORIZONTAL COCOPLUM BLUEBERRY FLAX LILY AFRICAN IRIS GREEN ISLAND FICUS	12" 14" 10" 12" 12" 12" 12"	12" 14" 10" 12" 12"	- - - -	1.5' O.C. 2.5' O.C. 1.5' O.C. 2' O.C. 2' O.C.	V V M V	N Y N N	FULL TO BASE FULL & THICK;  FULL DENSE CLUMP WHITE; FULL DENSE CLUMP FULL TO BASE
GROUNE BEG CHH DIT DVE FIM ILV	QTY. 206 331 193 207 410 268 22	BOTANICAL NAME BEGONIA ODORATA 'ALBA' CHRYSOBALANUS ICACO 'HORIZONTAL' DIANELLA TASMANICA DIETES VEGETA FICUS MICROCARPA 'GREEN ISLAND' ILEX VOMITORIA 'STOKES DWARF'	BEGONIA ODORATA HORIZONTAL COCOPLUM  BLUEBERRY FLAX LILY AFRICAN IRIS GREEN ISLAND FICUS STOKES DWARF	12" 14" 10" 12" 12" 12"	12" 14" 10" 12" 12" 12"	- - - -	1.5' O.C. 2.5' O.C. 1.5' O.C. 2' O.C. 2' O.C. 2' O.C.	V V M V V	N Y N N N Y	FULL TO BASE FULL & THICK;  FULL DENSE CLUMP WHITE; FULL DENSE CLUMP FULL TO BASE FULL TO BASE
GROUNE BEG CHH DIT DVE FIM ILV MIS	QTY. 206 331 193 207 410 268 22	BOTANICAL NAME BEGONIA ODORATA 'ALBA' CHRYSOBALANUS ICACO 'HORIZONTAL' DIANELLA TASMANICA DIETES VEGETA FICUS MICROCARPA 'GREEN ISLAND' ILEX VOMITORIA 'STOKES DWARF' MICROSORUM SCOLOPENDRIUM	BEGONIA ODORATA HORIZONTAL COCOPLUM  BLUEBERRY FLAX LILY AFRICAN IRIS GREEN ISLAND FICUS STOKES DWARF WART FERN	12" 14" 10" 12" 12" 12" 12"	12" 14" 10" 12" 12" 12" 12"		1.5' O.C. 2.5' O.C. 1.5' O.C. 2' O.C. 2' O.C. 2' O.C. 1.5' O.C.	V V M V V M	N Y N N N Y	FULL TO BASE FULL & THICK;  FULL DENSE CLUMP WHITE; FULL DENSE CLUMP FULL TO BASE FULL TO BASE FULL DENSE CLUMP
GROUNDER SECONDARY SECONDA	QTY.  206 331  193 207 410 268 22 438 59	BOTANICAL NAME BEGONIA ODORATA 'ALBA' CHRYSOBALANUS ICACO 'HORIZONTAL' DIANELLA TASMANICA DIETES VEGETA FICUS MICROCARPA 'GREEN ISLAND' ILEX VOMITORIA 'STOKES DWARF' MICROSORUM SCOLOPENDRIUM NEOMARICA CAERULEA REGINA	BEGONIA ODORATA HORIZONTAL COCOPLUM  BLUEBERRY FLAX LILY AFRICAN IRIS GREEN ISLAND FICUS STOKES DWARF WART FERN APOSTLE'S IRIS WHITE EGYPTIAN STAR	12" 14" 10" 12" 12" 12" 12" 12" 10"	12" 14"  10" 12" 12" 12" 12" 10" 10"		1.5' O.C. 2.5' O.C. 1.5' O.C. 2' O.C. 2' O.C. 2' O.C. 1.5' O.C. 2' O.C.	V V M V V M M	N Y N N N Y N	FULL TO BASE FULL & THICK;  FULL DENSE CLUMP WHITE; FULL DENSE CLUMP FULL TO BASE FULL TO BASE FULL DENSE CLUMP FULL DENSE CLUMP FULL DENSE CLUMP
GROUNDER STATE OF THE STATE OF	206 331 193 207 410 268 22 438 59	BEGONIA ODORATA 'ALBA' CHRYSOBALANUS ICACO 'HORIZONTAL' DIANELLA TASMANICA DIETES VEGETA FICUS MICROCARPA 'GREEN ISLAND' ILEX VOMITORIA 'STOKES DWARF' MICROSORUM SCOLOPENDRIUM NEOMARICA CAERULEA REGINA PENTAS LANCEOLATA 'ALBA'  PHILODENDRON 'ROJO CONGO' PODOCARPUS MACROPHYLLUS	BEGONIA ODORATA HORIZONTAL COCOPLUM  BLUEBERRY FLAX LILY AFRICAN IRIS GREEN ISLAND FICUS STOKES DWARF WART FERN APOSTLE'S IRIS WHITE EGYPTIAN STAR CLUSTER	12" 14" 10" 12" 12" 12" 12" 12" 12"	12" 14" 10" 12" 12" 12" 12" 10"	-	1.5' O.C. 2.5' O.C. 1.5' O.C. 2' O.C. 2' O.C. 2' O.C. 1.5' O.C. 2' O.C.	V V M V V V M M	N Y N N N N	FULL TO BASE FULL & THICK;  FULL DENSE CLUMP WHITE; FULL DENSE CLUMP FULL TO BASE FULL TO BASE FULL DENSE CLUMP FULL DENSE CLUMP FULL DENSE CLUMP FULL CLUMP
GROUNDER SECTION OF THE SECTION OF T	206 331 193 207 410 268 22 438 59 261 490	BOTANICAL NAME BEGONIA ODORATA 'ALBA' CHRYSOBALANUS ICACO 'HORIZONTAL' DIANELLA TASMANICA DIETES VEGETA FICUS MICROCARPA 'GREEN ISLAND' ILEX VOMITORIA 'STOKES DWARF' MICROSORUM SCOLOPENDRIUM NEOMARICA CAERULEA REGINA PENTAS LANCEOLATA 'ALBA'  PHILODENDRON 'ROJO CONGO'	BEGONIA ODORATA HORIZONTAL COCOPLUM  BLUEBERRY FLAX LILY AFRICAN IRIS GREEN ISLAND FICUS STOKES DWARF WART FERN APOSTLE'S IRIS WHITE EGYPTIAN STAR CLUSTER ROJO CONGO	12" 14" 10" 12" 12" 12" 12" 12" 12" 12" 12"	12" 14"  10" 12" 12" 12" 12" 10" 10" 10"		1.5' O.C. 2.5' O.C. 1.5' O.C. 2' O.C. 2' O.C. 2' O.C. 1.5' O.C. 2' O.C. 1' O.C.	V V M V V M M	N Y N N N N N N	FULL TO BASE FULL & THICK;  FULL DENSE CLUMP WHITE; FULL DENSE CLUMP FULL TO BASE FULL TO BASE FULL DENSE CLUMP FULL DENSE CLUMP FULL DENSE CLUMP FULL DENSE CLUMP FULL CLUMP

SOD: ST. AUGUSTINE 'FLORATAM'

SOD1: BAHIA


ABBREVIATIONS:

D.T.: DROUGHT TOLERANCE - V= VERY, M= MODERATE, L= LOW

NATIVE: Y= YES, N= NO

G.W.=GREY WOOD, C.T.= CLEAR TRUNK, O.A.=OVERALL, A.S.= AS SPECIFIED, O.C.=ON CENTER

# \* Trellis Support System

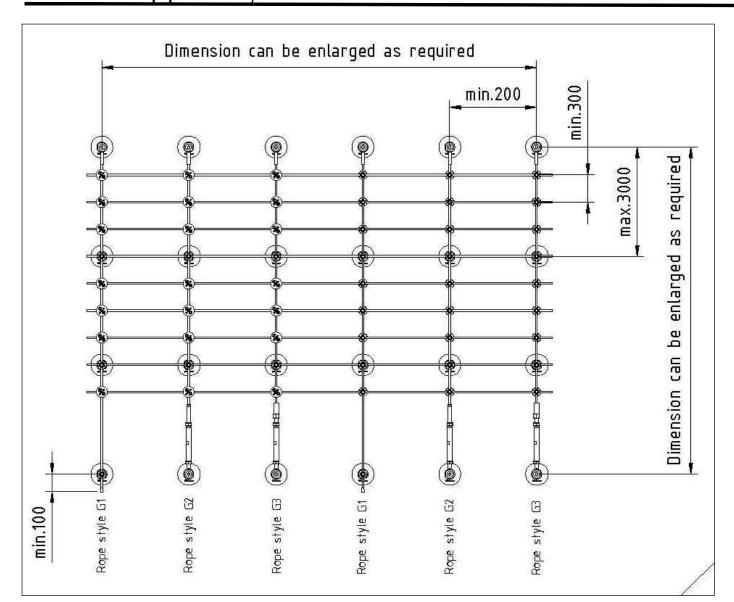


JAKOB GREENGUIDE SYSTEM (OR EQUAL) 2665 NW 1ST AVE. BOCA RATON, FL 33431 561-330-6502

PSL # P23-199

PSLUSD # 11-953-00



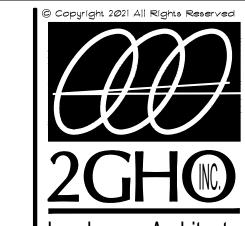

Landscape Architects **Planners** Environmental Consultants

1907 Commerce Lane Suite 101 Jupiter, Florida 33458 561-575-9557 561-575-526Ø FAX www.2GHO.com

> Details cations

andscape Preliminar

Approved: GGG/EOM/MTH/DS Revisions: \_\_ 02.06.2024

LC 0000177

Sheet Title:

Landscape Specification Plan

Scale: N.T.S.

Sheet No.

23-0106


# See Sheet LP-2 For Plant List

POINT AT WHICH SPECIFED

THIN BRANCHES BY 1/3 TOTAL MASS

TREE SPREAD IS MEASURED

Typical Cabbage Palm Layout N.T.S.

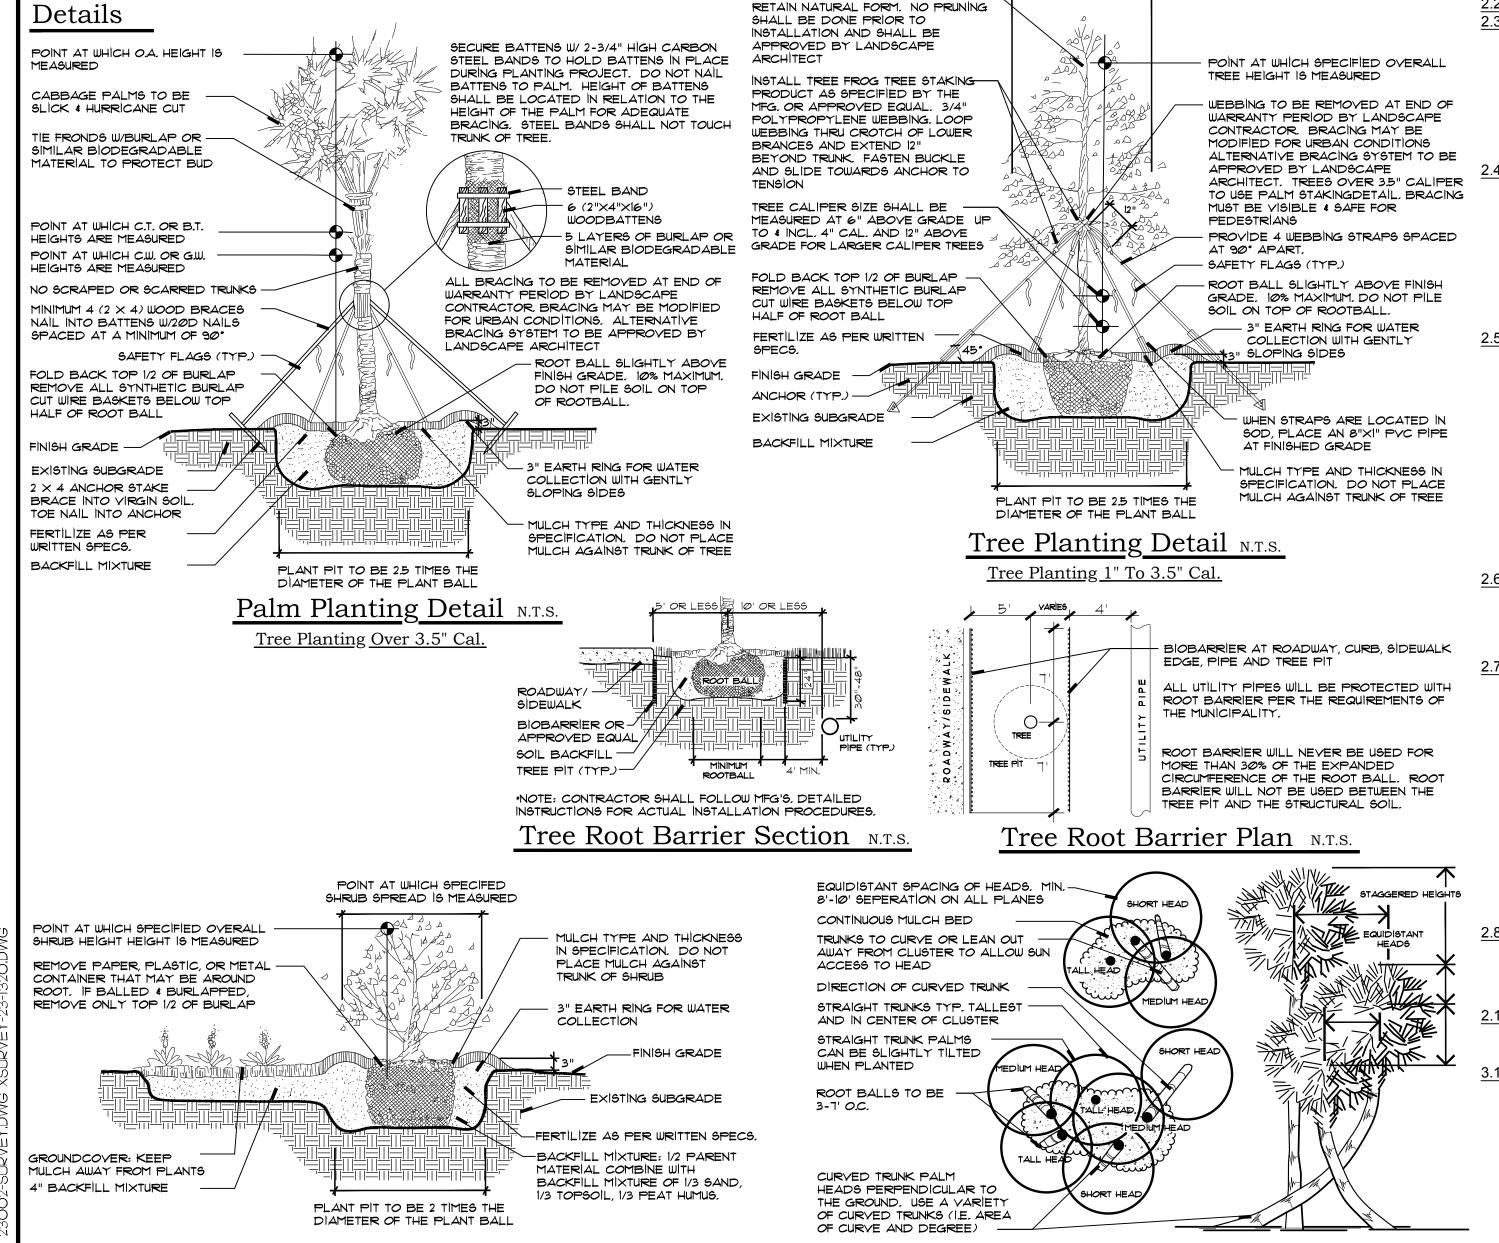

Shrub & Ground Cover Planting Detail N.T.S.

# **Specifications - Exterior Plants**

## 1.4: QUALITY ASSURANCE:

SOIL ANALYSIS SHALL BE CONDUCTED BY THE LANDCAPE CONTACTOR PRIOR TO APPLICATION OF ANY SOIL AMENDMENTS, FERTILIZERS AND BACKFILL MIXTURES. THE LANDSCAPE CONTACTOR SHALL USE A QUALIFIED SOIL TESTING LABORATORY

THE RESULT OF THE SOIL TESTS SHALL BE SUBMITTED TO THE OWNER AND LANDSCAPE ARCHITECT FOR REVIEW PRIOR TO THE APPILCATION OF SAID MATERIALS. ADJUSTMENTS TO THE SOIL AMENDENTS MAY BE MADE UPON CONSULTAION WITH THE OWNER AND THE LANDSCAPE ARCHITECT.

### 1.5: DELIVERY, STORAGE AND HANDLING

PRUNING OF TREES SHALL BE DONE ON SITE AFTER PLANTING FOR DAMAGED LIMBS OR AS DIRECTED TO IMPROVE OVERALL PLANT APPEARANCE. DO NOT REMOVE MORE THAN 15% OF BRANCHES. PRUNING METHODS SHALL FOLLOW STANDARD HORTICULTURAL PRACTICES USING APPROPRIATE TOOLS. LOPPING, SHEARING OR TOPPING OF PLANT MATERIAL WILL BE GROUNDS FOR REJECTION. DAMAGED, SCARRED, FRAYED. SPLIT OR SKINNED BRANCHES, LIMBS OR ROOTS TO BE PRUNED BACK TO LIVE WOOD. THE CENTRAL LEADER OR BUD SHALL BE LEFT INTACT UNLESS SEVERELY DAMAGED.

PRUNE SHRUBS TO REMOVE DAMAGED BRANCHES, IMPROVE NATURAL SHAPE, THIN OUT STRUCTURE AND REMOVE NOT MORE THAN 15% OF BRANCHES.

## 1.6: WARRANTY:

WARRANT ALL PLANT MATERIAL FOR A PERIOD OF ONE (1) YEAR FROM THE DATE OF FINAL ACCEPTANCE AGAINST DEATH AND UNHEALTHY CONDITION, EXCEPT AS MAY RESULT FROM NEGLECT BY OWNER, DAMAGE BY OTHERS AND UNUSUAL PHENOMENA BEYOND CONTRACTOR'S CONTROL. REPLACEMENTS SHALL BE MADE WITH COMPATIBLE SIZE AND QUALITY OF MATERIAL AT A TIME REQUESTED OR ACCEPTABLE BY THE OWNER OR LANDSCAPE ARCHITECT. PLANT MATERIAL REJECTED DURING THE COURSE OF CONSTRUCTION SHALL BE REMOVED WITHIN FIVE (5) WORKING DAYS AND REPLACED BEFORE THE FINAL INSPECTION FOR COMPLETION WILL BE SCHEDULED. WARRANTY ON REPLACEMENT PLANTS SHALL BE 1 YEAR FROM THE DATE OF FINAL ACCEPTANCE OF THE REPLACEMENTS. ANY DAMAGE TOLANDSCAPE, SODDED OR SEEDED AREAS DURING REPLACEMENT OF PLANT MATERIAL SHALL BE CORRECTED BY THE LANDSCAPE CONTRACTOR.

### 1.7: MAINTENANCE SERVICE:

MAINTENANCE AND GENERAL CLEAN UP SHALL BE PERFORMED DAILY. MAINTENANCE SHALL INCLUDE BUT NOT BE LIMITED TO WATERING, WEEDING, CULTIVATING, RESTORATION OF GRADE, REMOVAL OF LITTER, MOWING, PRUNING, RESETTING SETTLED PLANTS, REMOVING, REPAIRING OR REPLACING STAKES AND GUYS, PROTECTION FROM INSECTS AND DISEASES, FERTILIZATION AND SIMILAR OPERATIONS AS NEEDED TO ENSURE NORMAL GROWTH AND HEALTHY PLANT MATERIAL. MAINTENANCE SHALL BEGIN AFTER EACH PLANT IS PLANTED AND SHALL CONTINUE FOR NINETY (90) DAYS FROM THE DATE OF FINAL ACCEPTANCE.

### 1.8: QUANTITIES, LOCATION AND SUBSTITUTIONS:

THE QUANTITIES OF PLANT MATERIALS SHOWN ON PLANS SHALL TAKE PRECEDENCE OVER THE PLANT QUANTITIES ON THE PLANT LIST. THE LANDSCAPE ARCHITECT RESERVES THE RIGHT TO ADJUST THE NUMBER AND LOCATIONS OF THE DESIGNATED TYPES AND SPECIES OF PLANTS TO BE USED AT ANY OF THE LOCATIONS SHOWN. THE OWNER SHALL RECEIVE A CREDIT OR DEBIT FOR THE UNIT PRICE OF THE PLANT MATERIAL. NO SUBSTITUTION OF PLANT MATERIAL TYPES, SPECIFICATIONS OR SIZES WILL BE PERMITTED WITHOUT WRITTEN AUTHORIZATION FROM THE LANDSCAPE ARCHITECT. THE OWNER AND/OR LANDSCAPE ARCHITECT RESERVES THE RIGHT TO NOT ACCEPT PLANT MATERIAL THAT DOES NOT, IN THE OPINION OF THE OWNER AND/OR LANDSCAPE ARCHITECT, MEET THE SPECIFICATIONS HEREIN.

### 2.1: PLANT MATERIAL

PROVIDE SIZES AND SPECIFICATIONS OF PLANTS AS SHOWN ON PLANS OR LISTED ON PLANT LIST. ALL TREES, PALMS, SHRUBS, GROUND COVERS AND OTHER PLANTS SHALL CONFORM TO THE STANDARD OF FLORIDA NO. 1 OR BETTER AS GIVEN IN THE LATEST EDITION OF GRADES AND STANDARDS FOR NURSERY PLANTS BY FLORIDA DEPARTMENT OF AGRICULTURE, PART I AND II. PLANT MATERIAL SHALL ALSO CONFORM TO THE AMERICAN ASSOCIATION OF NURSERYMEN, INC. (ANSI) BULLETIN Z 60.1 - 1990 AND AS

SPECIMEN PLANTS SHALL BE FLORIDA FANCY OR BETTER AND SHALL CONFORM TO THE LITERATURE STANDARDS LISTED ABOVE.

OPSOIL SHALL BE FRIABLE FERTILE SOIL WITH REPRESENTATIVE CHARACTERISTICS OF AREA SOILS. IT SHOULD BE FREE OF HEAVY CLAY, SILT, STONE, EXCESS LIME, SHELL ROCK, PLANT ROOTS, WEEDS, DEBRIS OR OTHER FOREIGN MATTER. IT SHALL NOT CONTAIN NOXIOUS PLANT GROWTH (SUCH AS BERMUDA, TORPEDO OR NUT GRASS). IT SHALL TEST BETWEEN THE PH RANGE OF 5.0 TO 7.0 UNLESS OTHERWISE SPECIFIED AND CONTAIN NO TOXIC RESIDUE OR SUBSTANCES THAT WOULD ENDANGER PLANT 3.2: SODDING GROWTH. IF TOPSOIL IS NOT AVAILABLE ON SITE. IT SHALL BE IMPORTED FROM LOCAL SOURCES WITH SIMILAR SOIL CHARACTERISTICS TO THAT FOUND AT PROJECT SITE. OBTAIN TOPSOIL ONLY FROM NATURALLY, WELL-DRAINED SITES WHERE TOPSOIL OCCURS IN A DEPTH NOT LESS THAN 4".

# 2.5: INORGANIC SOIL AMENDMENTS

SAND SHALL BE CLEAN, SALT-FREE AND CONTAINING NO EXTRANEOUS MATTER.

MYCORRHIZAL AMENDMENT SHALL BE DIEHARD™ TRANSPLANT AS MANUFACTURED BY HORTICULTURAL ALLIANCE OR EQUAL TO WITH THE FOLLOWING INGREDIENTS:

ENDOMYCORRHIZAL FUNGI ECTOMYCORRHIZAL FUNGI BENEFICIAL BACTERIA **HUMIC ACID** SOLUBLE SEA KELP

HORTA-SORB WATER MANAGEMENT GEL **TRICHODERMA** YUCCA PLANT EXTRACTS VITAMIN B COMPLEX

# 2.6: ORGANIC SOIL AMENDMENTS

AMINO ACIDS

PEAT HUMUS SHALL BE DECOMPOSED PEAT WITH NO IDENTIFIABLE FIBERS OR IF AVAILABLE, MUCK MAY BE SUBSTITUTED AND SHALL BE FREE FROM STONES, EXCESSIVE PLANT ROOTS, DEBRIS OR OTHER FOREIGN MATTER. MUCK SHALL NOT BE OVERLY SATURATED WITH WATER.

# 2.7: FERTILIZATION

PROVIDE FERTILIZER UNIFORM IN COMPOSITION, DRY, AND IN A FREE FLOWING CONDITION FOR APPLICATION BY SUITABLE EQUIPMENT, AND DELIVER IN UNOPENED BAGS OR CONTAINERS, EACH FULLY LABELED.

FERTILIZE TREES, SHRUBS AND GROUND COVERS WITH "MILORGANITE" OR AN APPROVED COMPLETE FERTILIZER. APPLY "MILORGANITE" IN A CIRCLE AROUND THE PLANT BEFORE MULCHING. DO NOT TOUCH THE PLANT WITH THE FERTILIZER. WATER IN FERTILIZER AFTER MULCHING. APPLY MILORGANITE" FERTILIZER AT THE FOLLOWING RATE:

5.00 LBS. OR 14.5 CUPS / PALMS 3.00 LBS. OR 8.70 CUPS / 12-16' MATERIAL

2.00 LBS. OR 5.80 CUPS / 8-12- MATERIAI 0.69 LBS OR 2.00 CUPS / 6-8' MATERIAL

0.19 LBS OR 1/2 CUP / 3 GAL. MATERIAL

# 0.10 LBS. OR 1/4 CUP / 1 GAL MATERIAL

# 2.8: MULCHES:

MULCH TO BE APPLIED TO ALL PLANTING BEDS, 3" THICK MIN. PINE STRAW MULCH SHALL BE APPLIED ONLY TO THOSE AREAS AS INDICATED ON THE PLAN. APPLY 6" FLUFFED,

2-3" THICK AFTER COMPACTION.

# .10:PLANTING SOIL MIX

BACKFILL MIXTURE: 1/2 PARENT SOIL, 1/2 MIXTURE (1/3 SAND, 1/3 TOPSOIL, 1/3 PEAT HUMUS).

# 3.1: PLANTING BED ESTABLISHMENT:

PREPARATION: PRIOR TO THE INSTALLATION OF PLANTS, THE SITE SHALL BE FREE OF WEEDS, GRASS, SOD, DEBRIS, ROCKS OR OTHER MATERIAL MAKING THE SITE UNPLANTABLE. FOR FINAL ACCEPTANCE ALL PLANTED AREAS SHALL BE WEED FREE.

FINISH GRADING: THE LANDSCAPE CONTRACTOR SHALL COORDINATE THE INSTALLATION AND GRADING OF TOPSOIL, IF NECESSARY, WITH THE GENERAL CONTRACTOR, TO INSURE THE SITE IS AT FINISH GRADE PRIOR TO INSTALLING PLANTS.

## 3.2: PLANTING TREES:

LAYOUT PLANTS ACCORDING TO LANDSCAPE PLANS. IF A CONFLICT ARISES AS TO THE LOCATION, SPACING OR OTHER CONFLICT, CONTACT THE LANDSCAPE ARCHITECT IMMEDIATELY.

EXCAVATE PIT TO TWO AND ONE-HALF (2 1/2) TIMES THE DIAMETER OF TREE BALL AND NOT LESS THAN 6" DEEPER. COMPACT A LAYER OF BACKFILL MIXTURE IN PIT TO LOCATE COLLAR OF PLANT PROPERLY IN A SLIGHTLY DISHED FINISH GRADE. BACKFILL AROUND BALL WITH BACKFILL MIXTURE, COMPACTED TO ELIMINATE VOIDS AND AIR POCKETS, WATERING THOROUGHLY AS LAYERS ARE PLACED. BUILD 3" HIGH BERM OF SOIL BEYOND EDGE OF EXCAVATION. APPLY FERTILIZER AS SPECIFIED AND THEN MULCH WITH THE TYPE AND THICKNESS SPECIFIED ON PLANT LIST.

GUY AND STAKE TREES, LESS THAN 3.5" IN CALIPER, IN FOUR DIRECTIONS WITH "ARBORBRACE" NYLON TREE GUYING KIT WITH HARDENED NYLON ANCHOR AND 3/4" 800 LB. POLYPROP UV WEBBING. MODEL (ATG-R) OR APPROVED EQUAL. STAKE TREES IMMEDIATELY AFTER PLANTING. FOR MULTI-TRUNK PLANT MATERIAL, ATTACH GUYS TO FOUR (4) LARGEST LIMBS, CARE MUST BE TAKEN NOT TO MAKE GUYS TOO TIGHT. FOR TREES 3.5" IN CALIPER AND OVER, TREES MUST BE STAKED WITH WOOD 2X4 METHOD. FOLLOW PALM STAKING DETAIL FOR REQUIREMENTS. THE LANDSCAPE ARCHITECT RESERVES THE RIGHT TO ELIMINATE GUYING OR STAKING. THE OWNER SHALL RECEIVE A CREDIT OR DEBIT FOR THE UNIT PRICE OF THE GUYING OR STAKING. THE LANDSCAPE CONTRACTOR SHALL REMOVE BRACING IN ONE YEAR.

## 3.2: PLANTING SHRUBS:

EXCAVATE PITS OR TRENCH TWO (2) TIMES DIAMETER OF BALLS OR CONTAINERS, AND 3" DEEPER THAN REQUIRED FOR POSITIONING AT PROPER HEIGHT. COMPACT A LAYER OF BACKFILL MIXTURE IN BOTTOM BEFORE PLACING PLANTS. CONTAINER GROWN MATERIALS SHALL BE PLANTED WITH 48 HOURS AFTER DELIVERY TO SITE. PLACE PLANT IN PIT AND BACKFILL AROUND PLANTS WITH BACKFILL MIXTURE, COMPACTED TO ELIMINATE VOIDS AND AIR POCKETS. WATER THOROUGHLY AS LAYERS ARE PLACED. FORM A 3" HIGH BERM OF SOIL BEYOND THE EDGES OF EXCAVATION. APPLY FERTILIZER AS SPECIFIED AND THEN MULCH WITH THE TYPE AND THICKNESS SPECIFIED ON PLANT LIST.

### 3.4: PLANTING GROUNDCOVERS:

LOOSEN SUBGRADE TO DEPTH OF 4" IN AREAS WHERE TOPSOIL HAS BEEN STRIPPED, AND SPREAD BACKFILL MIXTURE.

SPACE PLANTS AS OTHERWISE INDICATED. DIG HOLES LARGE ENOUGH TO ALLOW FOR SPREADING OF ROOTS. COMPACT BACKFILL TO ELIMINATE VOIDS. AND LEAVE GRADE SLIGHTLY DISHED AT EACH PLANT. WATER THOROUGHLY. APPLY FERTILIZER AS SPECIFIED AND THEN MULCH WITH THE TYPE AND THICKNESS SPECIFIED ON PLANT LIST, LIFTING PLANT FOLIAGE ABOVE MULCH. MULCH SHALL BE SPREAD BEFORE PLANTING PLANTS IN POTS LESS THAN 1 GALLON SIZE (4", LINERS, ETC.).

# Specifications - Lawns and Grasses

SOD SHALL MEET AMERICAN SOD PRODUCES ASSOCIATION STANDARDS FOR NURSERY GROWN SOD FOR THICKNESS OF CUT, PAD SIZE, STRENGTH OF SECTIONS, MOISTURE CONTENT AND THATCH. SOD SHALL BE GUARANTEED TO BE UNIFORM IN COLOR, LEAF TEXTURE, AND SHOOT DENSITY AND FREE OF WEEDS, DISEASE, FUNGUS, INSECTS OR OTHER IMPERFECTIONS AND SUFFICIENTLY KNITTED TO SUSTAIN GROWTH SOD SHALL BE MOWED FOR FINAL ACCEPTANCE.

## 2.3: FERTILIZER:

FERTILIZE TURF AREAS WITH TYPE 1 FERTILIZER, COMPLYING WITH THE STATE FERTILIZER LAWS. THE FERTILIZER SHALL BE CHEMICALLY DESIGNATED WITH 12-8-8. PROVIDE AT LEAST 50% OF THE PHOSPHORIC ACID FROM NORMAL SUPER PHOSPHATE OR AN EQUIVALENT SOURCE PROVIDING A MINIMUM OF TWO UNITS OF SULFUR. THE AMOUNTS OF SULFUR AND ALL OTHER CHEMICAL SHALL BE INDICATED ON THE QUANTITATIVE ANALYSIS CARD ATTACHED TO THE UNOPENED BAG.

## 3.1: LAWN PREPARATION:

LOOSEN SUBGRADE TO DEPTH OF 4" AND GRADE WITH TOPSOIL PROVIDED ON SITE OR IMPORTED TO FINISH DESIGN ELEVATIONS. ROLL PREPARED LAWN SURFACE. WATER THOROUGHLY, BUT DO NOT CREATE MUDDY SOIL CONDITION.

FERTILIZE SOIL AT THE RATE OF APPROXIMATELY 10 LBS. PER 1000 S.F. SPREAD FERTILIZER OVER THE AREA TO RECEIVE GRASS BY USING AN  $\,$  APPROVED DISTRIBUTION DEVICE CALIBRATED TO DISTRIBUTE THE APPROPRIATE QUANTITY. DO NOT FERTILIZE WHEN WIND VELOCITY EXCEEDS 15 M.P.H. THOROUGHLY MIX FERTILIZER INTO THE TOP 2" OF TOPSOIL.

SOD TYPE SPECIFIED ON PLANT LIST SHALL BE MACHINE STRIPPED NOT MORE THAN 24 HOURS PRIOR TO

LAY SOD STRIPS WITH TIGHT JOINTS, DO NOT OVERLAP. STAGGER STRIPS TO OFFSET JOINTS IN ADJACENT COURSES. WORK SIFTED SOIL MIX INTO MINOR CRACKS BETWEEN PIECES OF SOD AND REMOVE EXCESS SOIL DEPOSITS FROM SODDED AREAS. SOD ON SLOPES GREATER THAN 3:1 SHALL BE STAKED IN PLACE. ROLL OR TAMP LIGHTLY AND WATER THOROUGHLY WITH A FINE SPRAY IMMEDIATELY AFTER PLANTING.

# **Landscape Certification**

LANDSCAPE CERTIFICATION: THE LANDSCAPE ARCHITECT SHALL PROVIDE FINAL CERTIFICATION TO THE OWNER AND MUNICIPALITY THAT PLANTS ARE INSTALLED PER THE DESIGN PLAN, DETAILS AND SPECIFICATIONS. ANY CHANGES TO THE PLAN WILL NEED TO HAVE THE LANDSCAPE ARCHITECT APPROVAL PRIOR TO INSTALLATION. CONFORMITY TO FLORIDA GRADE #1 IN THE ROOT BALL REQUIRES THE LANDSCAPE ARCHITECT TO INSPECT TREES PRIOR TO INSTALLATION AT THE SITE. IT IS THE RESPONSIBILITY OF THE OWNER/GENERAL CONTRACTOR/LANDSCAPE CONTRACTOR FOR ORGANIZING INSPECTIONS OF PLANT MATERIAL PRIOR TO INSTALLATION.

# General Notes

SOD TO BE ST. AUGUSTINE 'FLORATAM' UNLESS OTHERWISE NOTED ON PLANS

# SOD 1 TO BE BAHIA UNLESS OTHERWISE NOTED ON PLANS

ALL PLANTING AREAS SHALL RECEIVE 100% COVERAGE FROM A FULLY AUTOMATIC IRRIGATION SYSTEM EQUIPPED WITH A RAIN SENSOR.

ALL CONSTRUCTION DEBRIS & HARDPAN TO BE REMOVED FROM PLANTING BEDS TO A DEPTH OF 30"

ABOVE AND BELOW GROUND UTILITIES SHALL BE VERIFIED AND LOCATED BY THE LANDSCAPE CONTRACTOR PRIOR TO COMMENCING WORK IN THE PROJECT AREA. IF UTILITY PLANS ARE AVAILABLE THE CONTRACTOR SHALL EXAMINE THEM AND BRING ANY AND ALL CONFLICTS TO THE ATTENTION OF THE OWNER AND/OR LANDSCAPE ARCHITECT. WHEN WORKING IN AN AREA WHERE KNOWN UTILITIES EXIST, UTILITY LOCATIONS MAY NEED TO BE STAKED BY A SURVEYOR OR THE UTILITY COMPANIES. THE CONTRACTOR HAS THE OPTION TO CONTACT 811TO SCHEDULE LOCATION OF THE UTILITIES WHICH SUBSCRIBE TO THEIR SERVICE.

PSL # P23-199

PSLUSD # 11-953-00



Know what's **below**.

Call before you dig.

Landscape Architects

Environmental Consultants

1907 Commerce Lane Suite 101 Jupiter, Florida 33458 561-575-9557 561-575-5260 FAX www.2GHO.com

ati d lim

)esigned: Approved: <u>GGG/EOM/MTH/D</u> Job no. <u> </u> 02.02.202 Revisions:

LC 0000177 Sheet Title: Landscape

Specification

Scale: N.T.S.

Sheet No.

23-0106