
DEVELOPMENT PLANS

FOR

PROJECT SENIOR

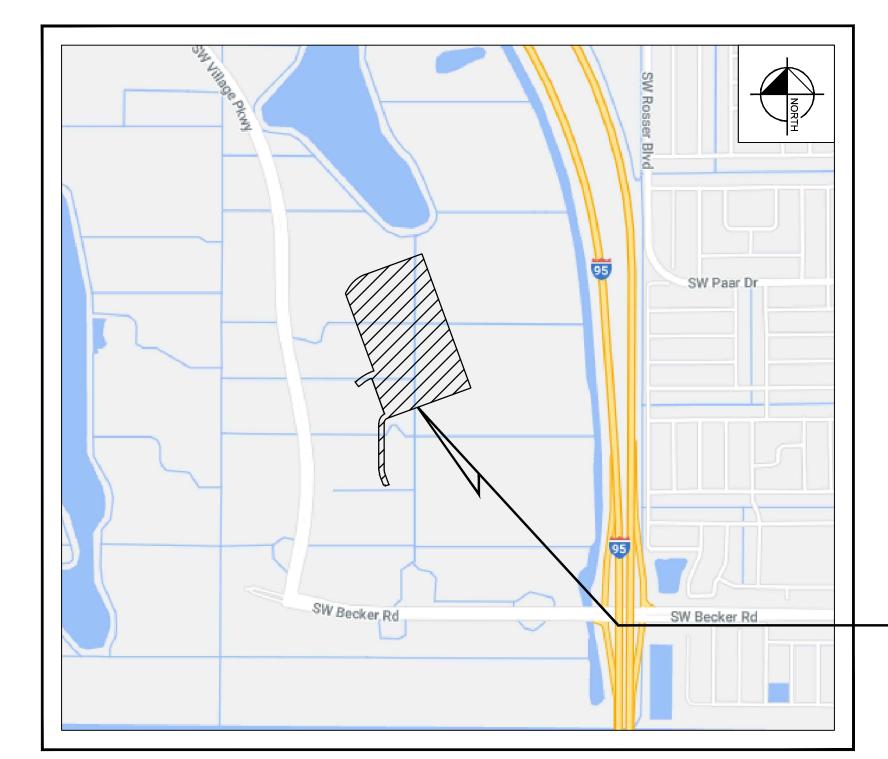


IN SECTIONS 34 & 35, TOWNSHIP 37 SOUTH, RANGE 39 EAST CITY OF PORT SAINT LUCIE, FLORIDA PREPARED FOR SANSONE GROUP

PROJECT LOCATION





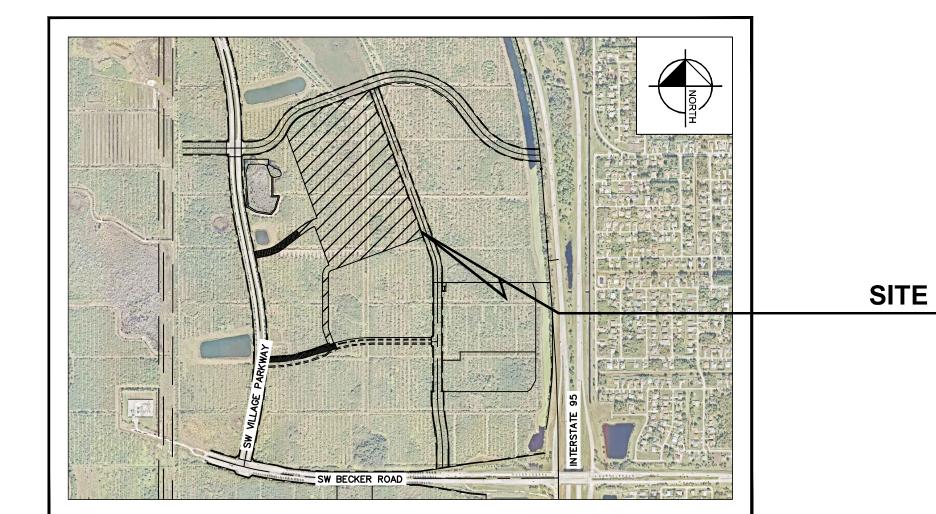

AERIAL PHOTOGRAPH

DEVELOPER SANSONE GROUP 120 SOUTH CENTRAL, SUITE 500 ST. LOUIS, MO 63105 CONTACT: BLAKE ROELL

SITE

PROJECT TEAM

LANDSCAPE ARCHITECT KIMLEY-HORN AND ASSOCIATES, INC. 189 S. ORANGE AVENUE, SUITE 1000 ORLANDO, FL 32801 CONTACT: WES ROGERS, PLA PHONE: (407) 412-9979

CIVIL ENGINEER

EMAIL: wes.rogers@kimley-horn.com

KIMLEY-HORN AND ASSOCIATES, INC. 189 S. ORANGE AVENUE, SUITE 1000 ORLANDO, FL 32801 CONTACT: BROOKS A. STICKLER, P.E. PHONE: (407) 898-1511 EMAIL: brooks.stickler@kimley-horn.com

PREPARED BY

© 2021 KIMLEY-HORN AND ASSOCIATES, INC.

189 S. Orange Avenue, Suite 1000, Orlando, FL 32801 Phone: (407) 898-1511 WWW.KIMLEY-HORN.COM CA 00000696

ARCHITECT

ORLANDO, FL 32801

PHONE: (407) 926-3000

BAKER BARRIOS ARCHITECTS, INC.

189 S. ORANGE AVE, SUITE 1700

PSLUSD PROJECT NO. 5360C


INDEX OF SHEETS

OVERALL SITE PLAN SITE PLAN DETAILS CITY OF PORT ST. LUCIE STANDARD DETAILS

CONCEPT LANDSCAPE PLAN **OVERALL FLOOR PLAN BUILDING ELEVATIONS**


ENLARGED BUILDING ELEVATIONS

LEGAL DESCRIPTION LOT 5, SOUTHERN GROVE PLAT NO. 35

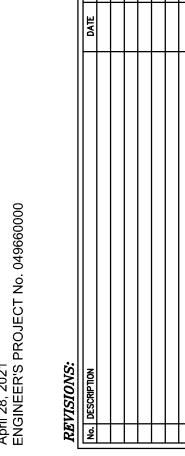


CITY OF PSL PROJECT NO. P21-057


BROOKS A. STICKLER, P.E. FL. P.E. NO. 74031

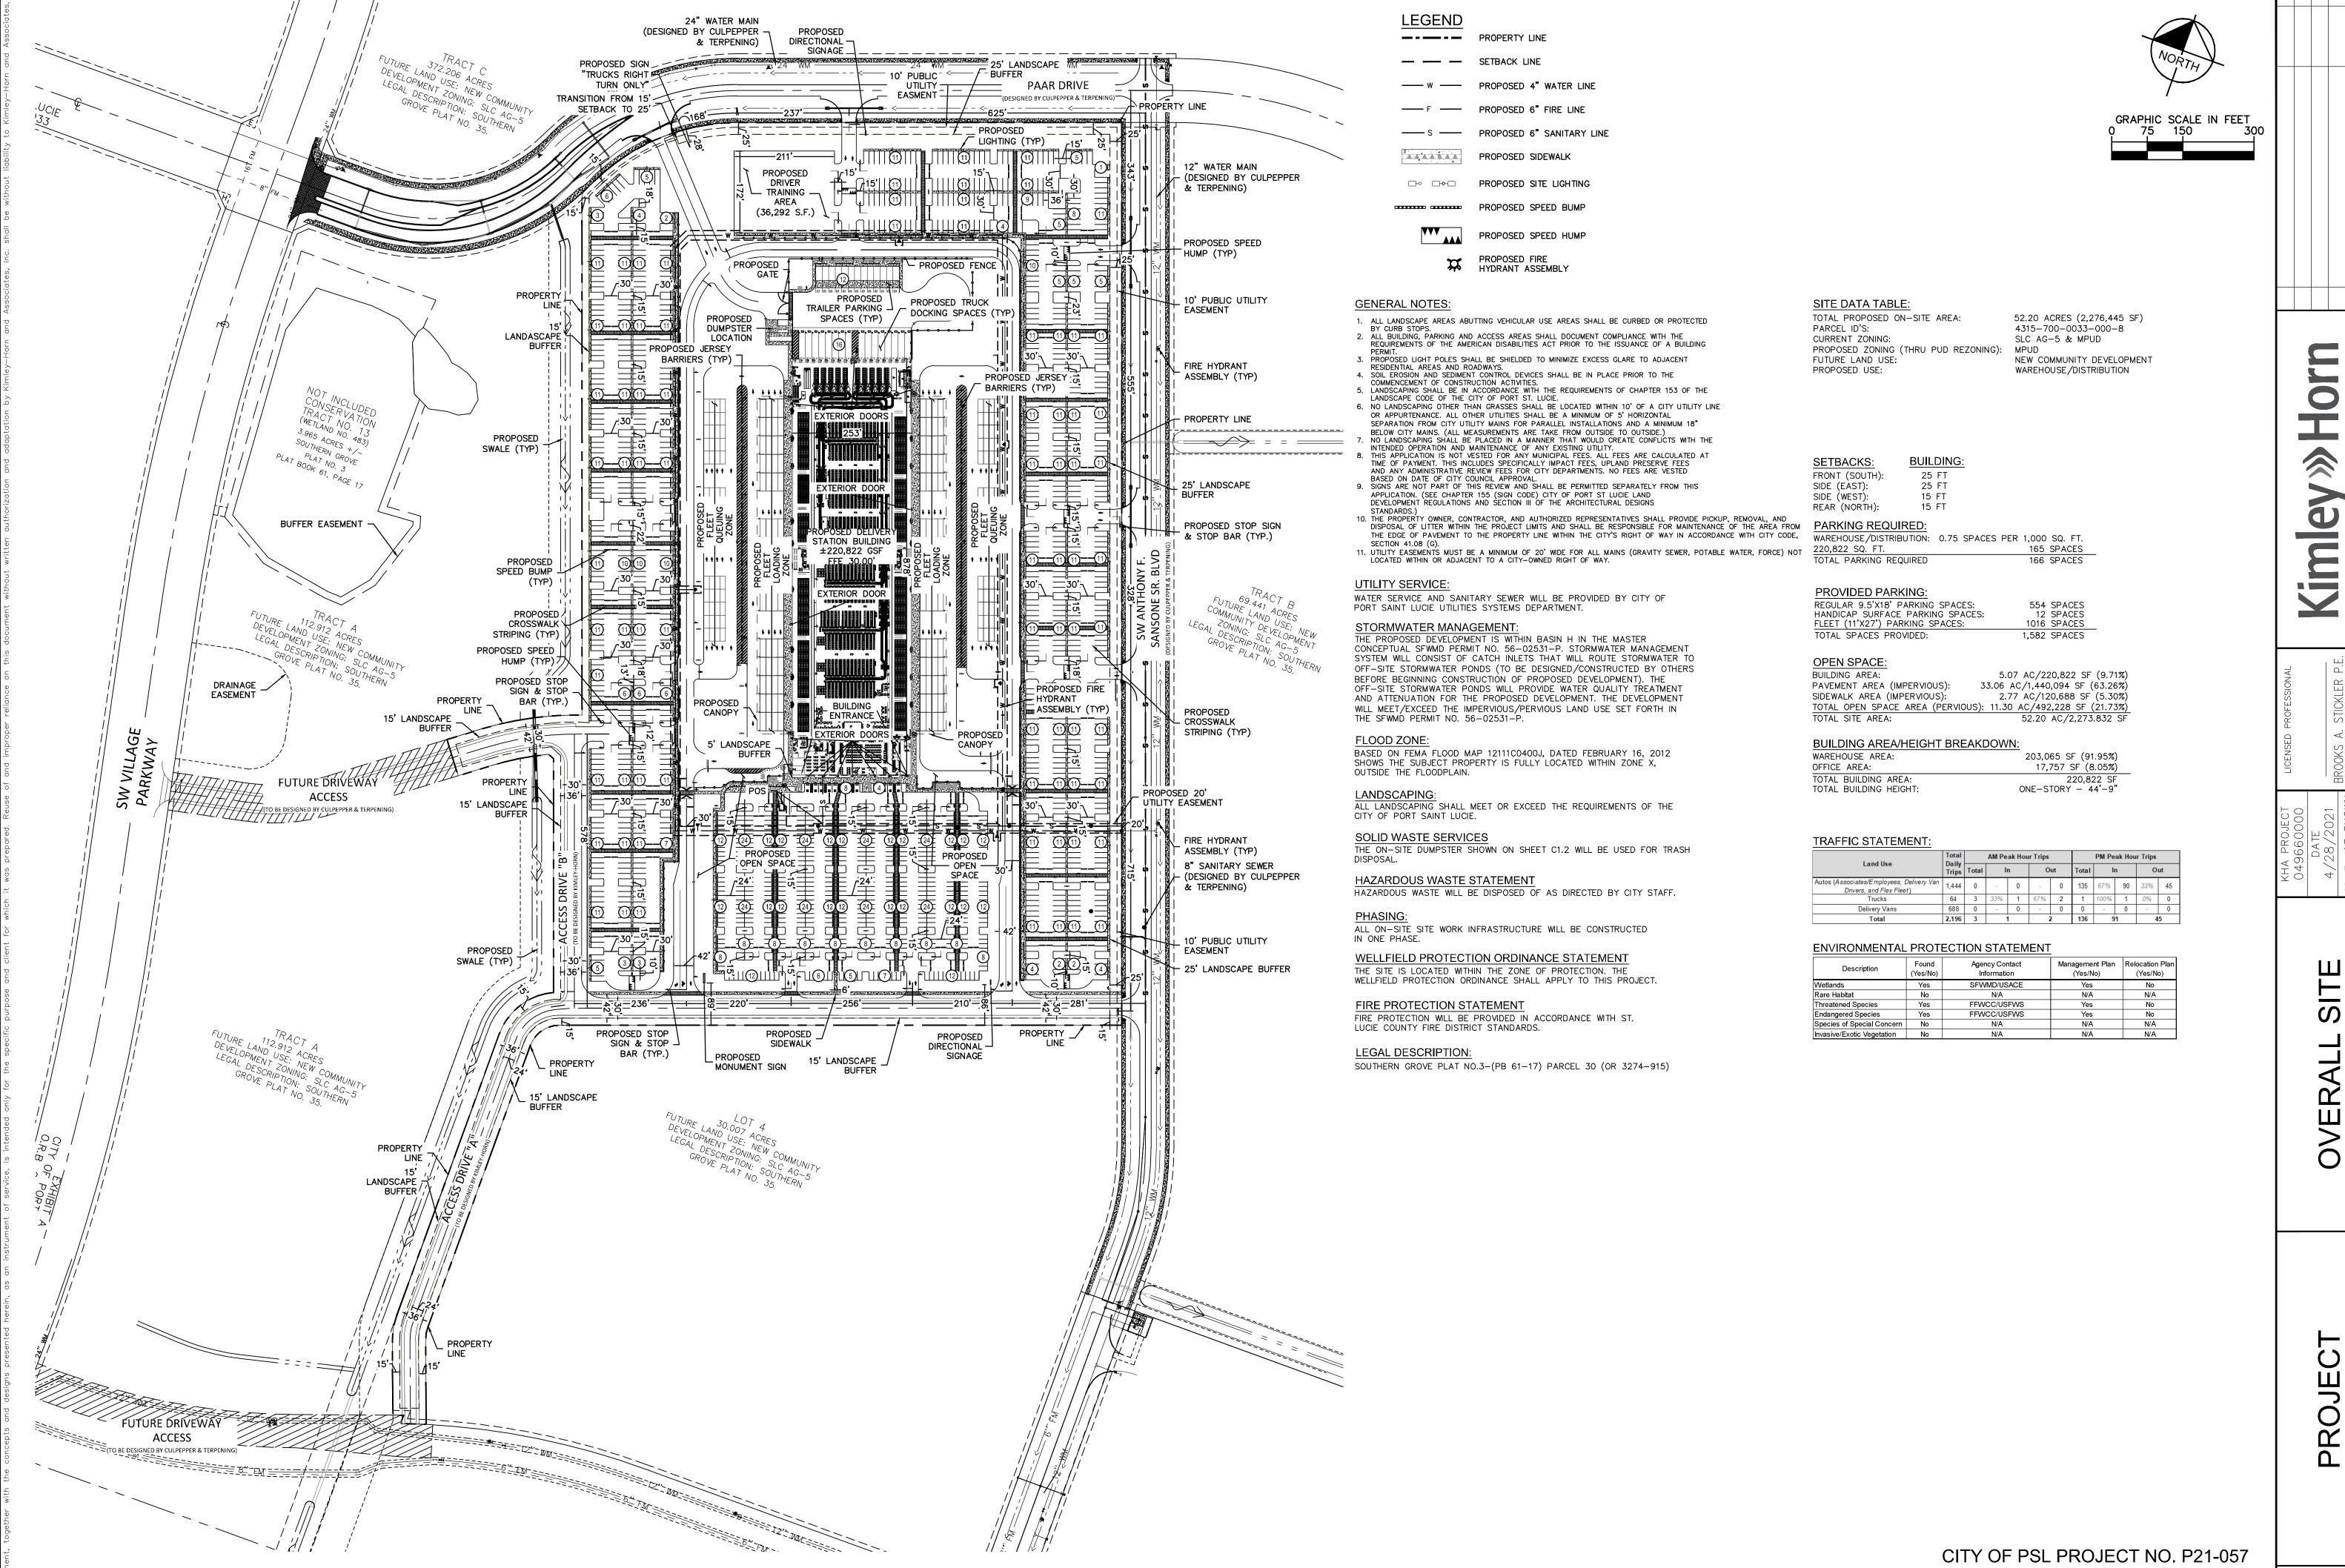

PSLUSD PROJECT NO. 5360C

SHEET NUMBER C1.0

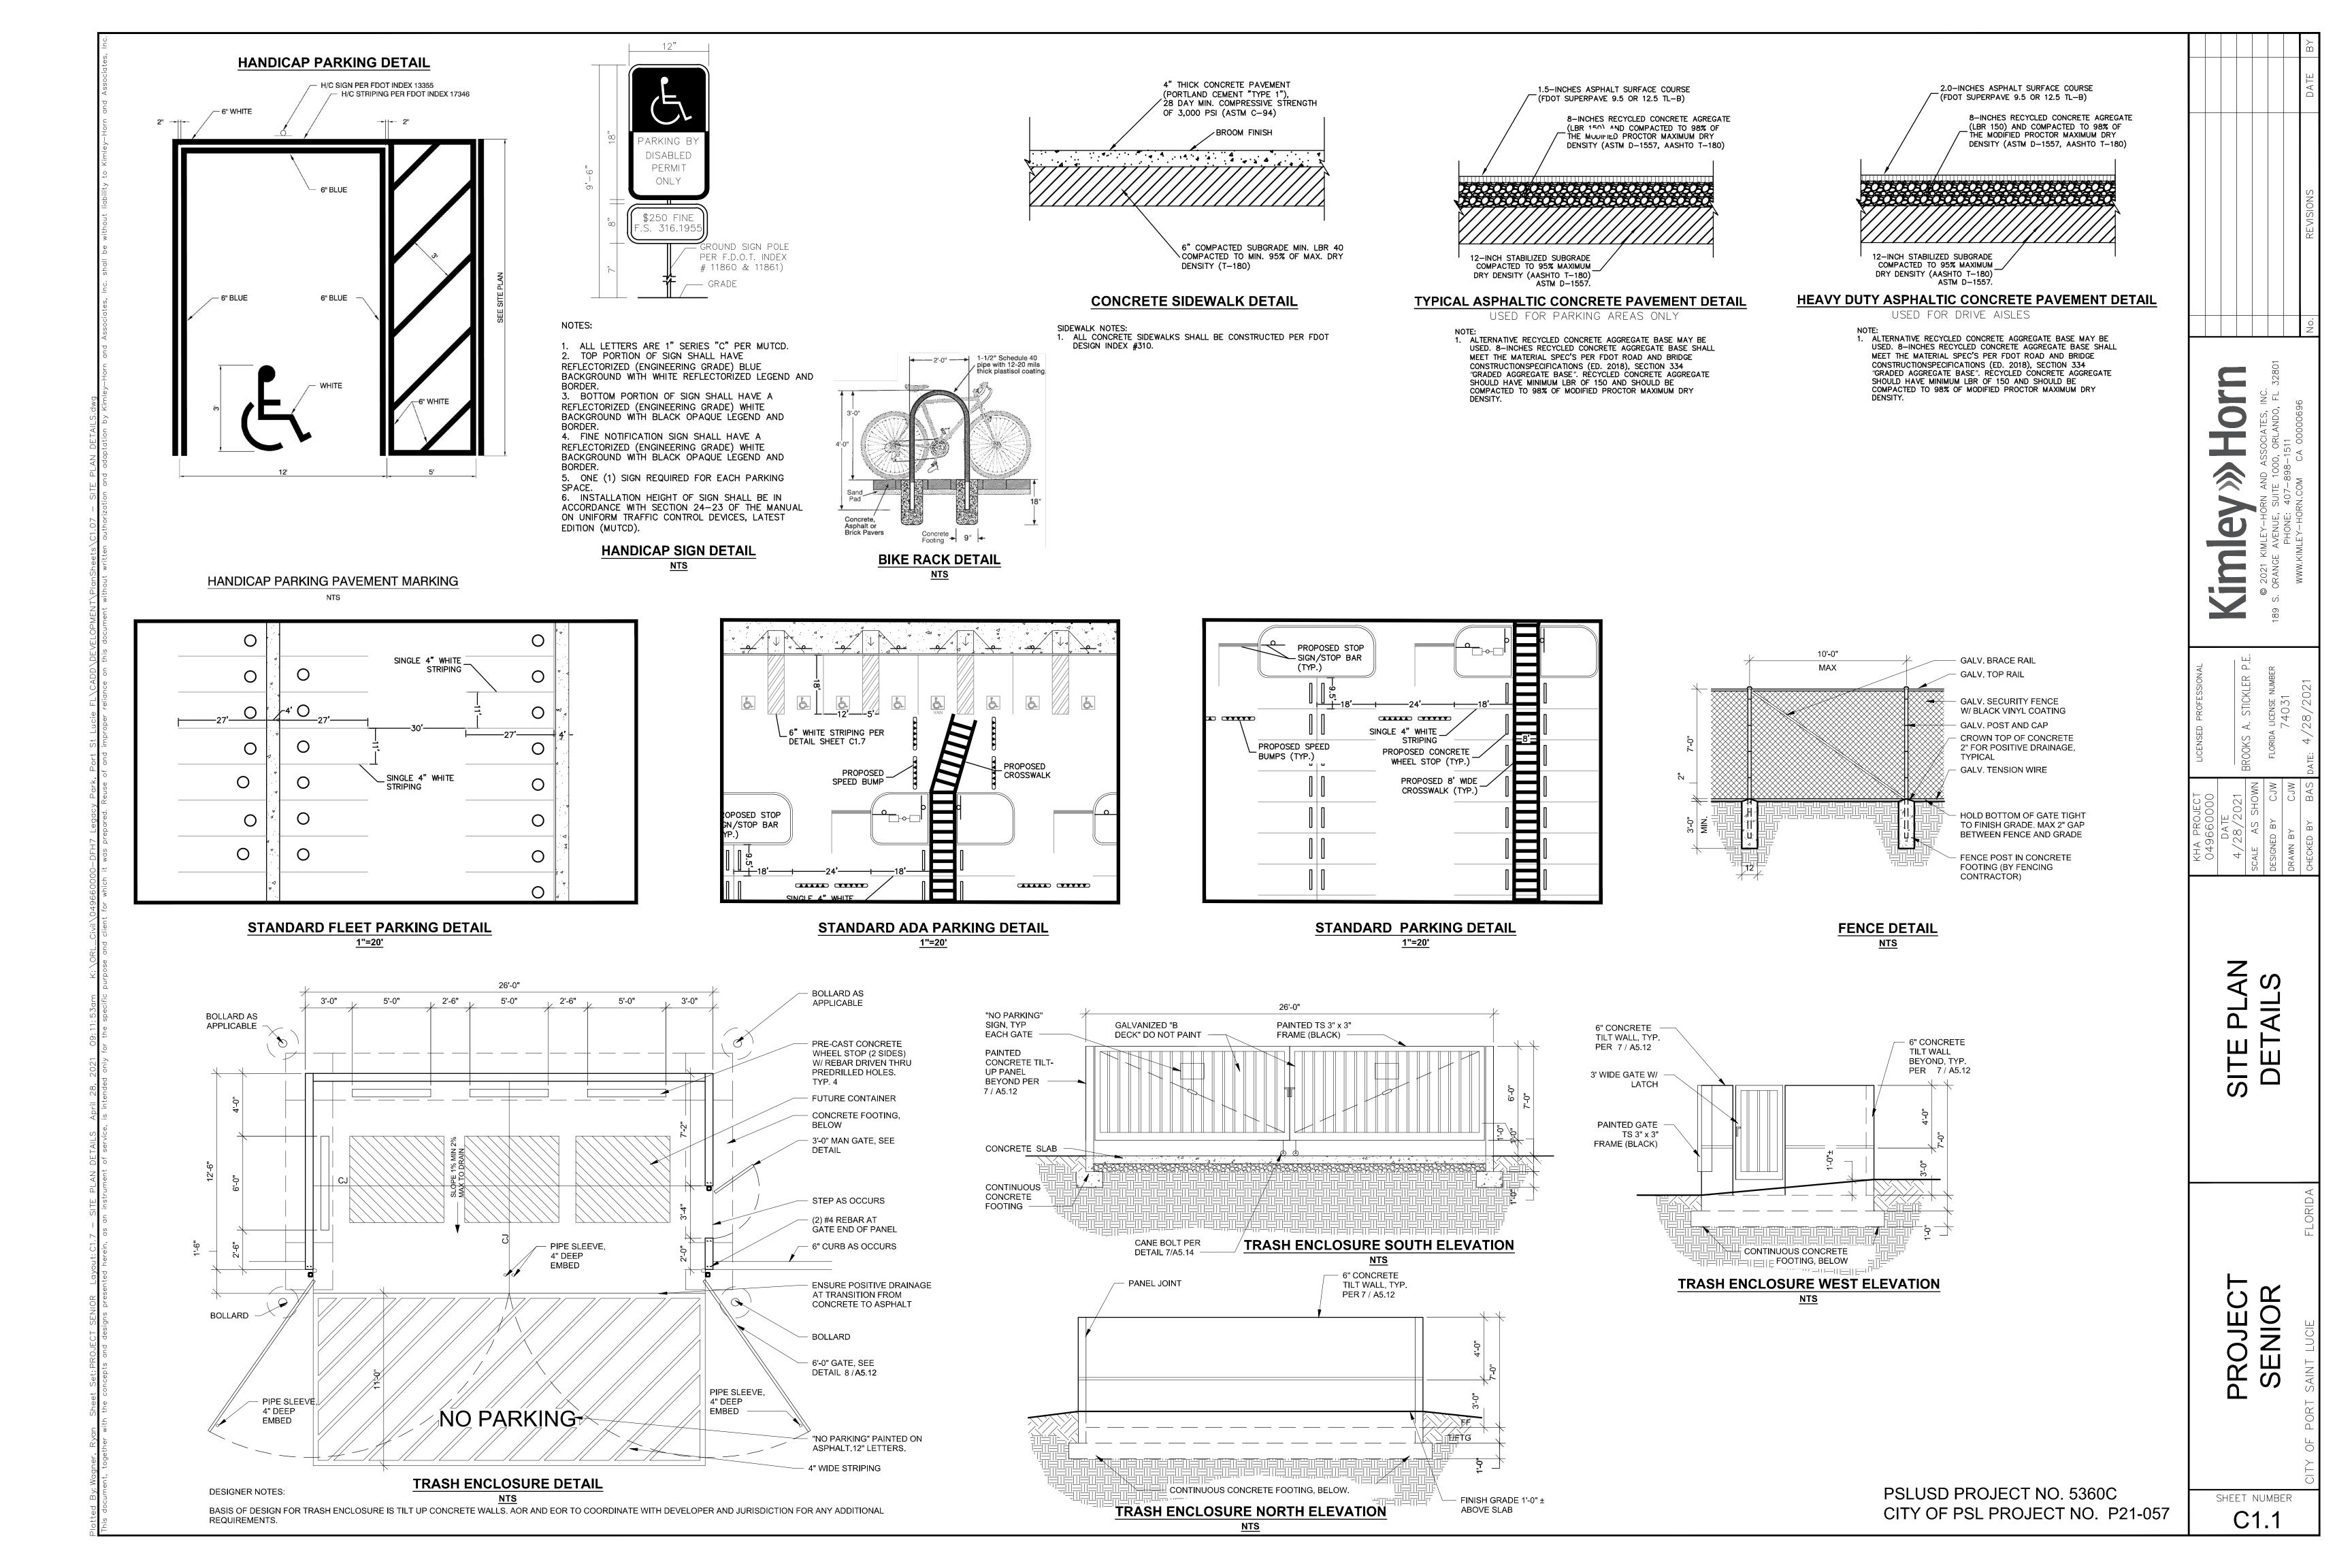

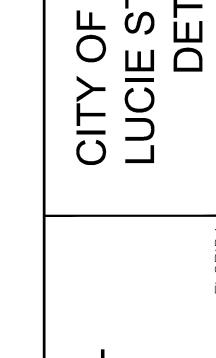

NOR

SHEET NUMBER

2. THE ENGINEER OF RECORD SHALL ENSURE THAT THE PROPOSED PLUMBING STUB-OUT ELEVATION FOR EACH BUILDING WILL ALLOW FOR A GRAVITY CONNECTION TO THE SANITARY SEWER LATERAL WITH THE REQUIRED SLOPE. HORIZONTAL AND VERTICAL SEPARATION SHALL BE MAINTAINED AS REQUIRED IN THE UTILITY STANDARDS MANUAL. SCALE: N.T.S. SHEET: 1 OF 1

SINGLE SERVICE TYPICAL

SINGLE SERVICE

DATE: 2019

DOUBLE SERVICE
TYPICAL

(SEE NOTE #3)

MARKER BALL

W/ TIE STRAP

CUSTOMER TIE IN-

6" DOUBLE WYE —

DOUBLE SERVICE
TYPICAL

STANDARD "Y" BRANCHES TO BE LOCATED IN THE FIELD

1. SANITARY SEWER LATERALS SHALL BE 6" IN DIAMETER.

MINIMUM CONSTRUCTION STANDARDS FO CITY OF PORT ST. LUCIE 900 S.E. OGDEN LANE PORT ST. LUCIE, FL 34983 PHONE (772) 873-6400 FAX (772) 873-6433

BEND AS REQUIRED -

© OF ROAD CROWN OF ROAD

ELEVATION

*SANITARY SEWER CLEANOUT BOXES NOT SHOWN

PLAN VIEW

SANITARY SEWER LATERAL

(SHALLOW)

EXCAVATED TRENCH WIDTH

1. FOR TRENCHES REQUIRING SHEETING, SHORING, STAY BRACING, TRENCH JACKS OR TRENCH BOX,

3. IF BEDDING IS REQUIRED TO BRING TRENCH BOTTOM UP TO GRADE AND PROVIDE UNIFORM AND

4. THE CONTRACTOR SHALL COMPLY WITH REQUIREMENTS OF THE FLORIDA TRENCH SAFETY ACT.

6. EARTHWORK, EXCAVATION, BACKFILL AND COMPACTION SHALL BE IN ACCORDANCE WITH PSLUSD

STANDARD PIPE TRENCH CROSS

SECTION

ADEQUATE LONGITUDINAL SUPPORT UNDER THE PIPE, THEN A MINIMUM COMPACTED DEPTH OF 4 TO 6

2. IF THE MAXIMUM TRENCH WIDTH MUST BE EXCEEDED, THE AREA OUTSIDE OF THE MAXIMUM EMBEDMENT SHALL BE COMPACTED TO FINAL BACKFILL REQUIREMENTS. IF THE PIPE IS INSTALLED IN A COMPACTED EMBANKMENT, THE EMBANKMENT SHALL BE IN PLACE AND COMPACTED TO 12" MIN. COVER BEFORE

DIMENSIONS SHALL BE TAKEN FROM THE INSIDE FACE OF THE SUPPORTS.

FINISHED GRADE

SEE NOTE #4

(FLAT TAMP)

(SIDE TAMP)

- UNDISTURBED SOIL

DETAIL: G-04

DATE: 2019

SCALE: N.T.S.

SHEET: 1 OF 1

LOCATOR WIRE

BEDDING

INCHES OF SELECT EMBEDMENT MATERIAL IS REQUIRED.

5. AN APPROVED LOCATOR WIRE SHALL BE USED.

MINIMUM CONSTRUCTION STA CITY OF PORT ST. LUCIE 900 S.E. OGDEN LANE PORT ST. LUCIE, FL 34983

UTILITY MAINTAINED CUSTOMER MAINTAINED

PHONE (772) 873-6400 FAX (772) 873-643

DETAIL: W-03

SHALL BE PLACED ON TOP OF PIPE

BACKFILL

LINE TYPE (WM, FM, STM, ETC..)

FULL LENGTH OF PIPE TO

BE CENTERED ON

CROSSING

CONFLICT NUMBER_

-SIZE/DIAMETER

LINE TYPE (WM, FM, STM, ETC..

MIN. 6" THICK CONCRETE

STRAINER —

* SEE NOTE #10

METER ASSEMBLY -

1. ALL PIPE AND FITTINGS SHALL BE CLASS 53 DUCTILE IRON.

CONSIDERATION THE TYPICAL HEAD LOSS FOR EACH.

12. A BRASS PLUG SHALL BE INSTALLED IN ALL TEST PORTS.

MINIMUM CONSTRUCTION STANDARDS FOR CITY OF PORT ST. LUCIE

PHONE (772) 873-6400 FAX (772) 873-6433

900 S.E. OGDEN LANE PORT ST. LUCIE, FL 34983

5. METER BY-PASS LINE SHALL BE THE SAME SIZE AS SUPPLY TO METER.

(3,000 PSI) WITH 6X6 WIRE MESH

ELEV.

TOP OF PIPE ELEV.

____ " LINE TYPE (WM, FM, STM, ETC

LINE TYPE (WM, FM, STM, ETC..)

FULL LENGTH OF PIPE TO

BE CENTERED ON

CROSSING

3. CONFLICTS MUST BE IN NUMERICAL SEQUENCE (1, 2, 3, ETC...)

4. MUST MEET PSLUSD STANDARD SEPARATION REQUIREMENTS OF 18" MIN.

DRAIN HOLE PLUG

DATE: 2019

SCALE: N.T.S.

CONFLICT NUMBER_

1. DESIGN PLAN INFORMATION ON THE BLANK LINE.

2. RECORD DRAWING INFORMATION IN THE BOX.

SIZE/DIAMETER

___"

FLOW INDICATOR RING-

BURY LINE-

HYDRANTS SHALL BE INSTALLED IN ACCORDANCE WITH ANSI/AWWA C600. THE HYDRANTS SHALL BE

2. VERTICAL BENDS MAY BE NECESSARY TO OBTAIN COVER UNDER SWALES OR AT HYDRANT LOCATION.

VERTICAL BENDS OR OFFSETS ARE INCLUDED IN HYDRANT ASSEMBLY. ALL BENDS MUST BE

3. CONNECTOR PIPE AND ANY REQUIRED VERTICAL BENDS SHALL HAVE AN ANCHORING FEATURE ON BOTH ENDS SO THAT WHEN USED WITH M.J. SPLIT GLANDS, A RESTRAINED JOINT IS PROVIDED.

4. WHEN INSTALLED WITH SIDEWALK OR CURB, PROVIDE MIN. 2 FOOT CLEARANCE TO ANY PORTION OF

5. A GATE VALVE SHALL BE INSTALLED WITHIN 2 FEET OF THE FIRE HYDRANT. IF DISTANCE FROM

6. ANY DEVIATIONS FROM THE CRITERIA ABOVE REQUIRE A WRITTEN RECOMMENDATION FROM THE

THE WATER MAIN TO THE FIRE HYDRANT IS GREATER THAN 20 FEET, A SECOND GATE VALVE SHALL

FIRE HYDRANT ASSEMBLY

24" x 24" x 6"

WITH #4 REBAR

CONCRETE COLLAR-

SEE TYPICAL VALVE CONNECTOR PIPE (SEE NOTES #2 AND #3)

VARIES (SEE NOTE #5)

PAINTED BY THE MANUFACTURER WITH 2 COATS (MIN.).

BE INSTALLED WITHIN 2 FEET OF THE MAIN.

MINIMUM CONSTRUCTION STANDARDS FOR CITY OF PORT ST. LUCIE 900 S.E. OGDEN LANE PORT ST. LUCIE, FL 34983 PHONE (772) 873-6400 FAX (772) 873-6433

THE HYDRANT, UTILIZING THE SIDE LOT EASEMENT IF NECESSARY.

ENGINEER-OF-RECORD AND WRITTEN APPROVAL BY PSLUSD.

PUMPER CONNECTION FACING THE STREET-

FINISH GRADE

- HYDRANT TEE

NOTES:

INITIAL ⊈ I BACKFILL

FOUNDATION (REQUIRED WHEN UNSUITABLE

MATERIAL IS ENCOUNTERED)

INSTALLATION OF PIPE.

STANDARDS.

BACKFLOW PREVENTION-

<u>PLAN VIEW</u>

2. ALL UNDERGROUND FITTINGS SHALL BE RESTRAINED MECHANICAL JOINT TYPE & ALL ABOVE GROUND FITTINGS SHALL BE FLANGE JOINTS, FULL FACE NEOPRENE GASKETS WITH STAINLESS STEEL BOLTS.

3. STAINLESS STEEL CHAINS (1/4"MIN.) & LOCKS FOR THE VALVES SHALL BE PROVIDED AS REQUIRED BY

4. A BACKFLOW PREVENTION ASSEMBLY MAY NOT BE REQUIRED ON THE BY-PASS LINE IF THE CUSTOMER SUBMITS A WRITTEN REQUEST TO THE PSLUSD FOR APPROVAL; IF APPROVED, AN ELBOW SHALL BE USED INSTEAD OF THE TEE AND A REVISED DETAIL SHALL BE SUBMITTED TO THE PSLUSD.

6. BACKFLOW PREVENTION ASSEMBLY ON THE BY-PASS LINE SHALL BE SAME SIZE AND TYPE AS THE MAIN BACKFLOW PREVENTION ASSEMBLY.

8. 12" MIN. / 24" MAX. CLEARANCE IS REQUIRED FROM THE TOP OF THE CONCRETE PAD TO THE BOTTOM OF THE RELIEF VALVE.

11. AT THE DIRECTION OF THE PSLUSD, BOLLARDS MAY BE REQUIRED TO PREVENT DAMAGE FROM ACCIDENTS. REFER TO DETAIL G-15 FOR BOLLARD INSTALLATION.

7. THE ENGINEER-OF-RECORD SHALL SIZE METER AND BACKFLOW PREVENTION ASSEMBLY, TAKING INTO

9. A 5' MIN. CLEAR ZONE SHALL BE LOCATED ON ALL SIDES OF THE BACKFLOW PREVENTION ASSEMBLIES.

10. STAINLESS STEEL ADJUSTABLE PIPE SUPPORTS SHALL BE PROVIDED FOR SUPPORT UNDER EACH GATE VALVE AND ANCHORED IN THE CONCRETE PAD.

METER AND BACKFLOW

3" AND LARGER SERVICES

PREVENTION ASSEMBLY FOR SCALE: N.T.S.

NIPPLE / LOCKING BALL VALVE AT 90°

MINIMUM SEPARATION BETWEEN PSLUSD FACILITIES AND OTHER UTILITIES

WATER MAIN

PSLUSD FACILITY

(FULL JOINT CENTERED)

WATER MAIN

WATER MAIN

ORIZONTAL SEPARATION

WATER MAIN

> PSLUSD FACILITY

10' MINIMUM

(4) A PSLUSD FACILITY INCLUDES MAINS AND STRUCTURES FOR POTABLE WATER, WASTEWATER AND RECLAIMED WATER.

(1) WATER MAIN SHOULD CROSS OVER OTHER PIPE. WHEN WATER MAIN MUST BE BELOW OTHER PIPE, THE MINIMUM SEPARATION IS 18".

- 4'x4'x4" THICK POURED IN PLACE

* * * * * * * * * FINISHED GRADE

W/ #4 REBAR

CONCRETE COLLAR (UNPAVED AREA)

SEAL WITH BUTYL SEALANT STRIPS

- PRECAST REINFORCED CONCRET

____ APPROVED EXTERIOR

10" MIN. FROM FLEXIBLE SLEEVE TO JOINT

SECTION (KEYED TO LOWER WALL)

JOINT SEAL (NOTE #2)

8" CONCRETE SLAB

CONT. ON SHEET 2 OF 2

STANDARD PRECAST MANHOLE

DETAIL: WW-02

SCALE: N.T.S.

DATE: 2019

(MONOLITHIC POUR W/

(UNPAVED AREA)

PRECAST CONCRETE ADJUSTING RINGS W/GROUT (MIN. 2 RINGS) MIN. HEIGHT 4" (NOTE #9)

> GASKETED POLYPROPYLENE (PP) PIPE BELL CONNECTOR OR PP SLEEVE FOR — BOOT CONNECTOR.

OTHER PIPE

PRESSURE SANITARY SEWER,

VACUUM SANITARY SERVICE

STORM SEWER, STORM SEWER

ALL OTHER FACILITIES, INCLUDING

TELEPHONE, CABLE TV, POWER, ETC

AND DISPOSAL SYSTEM

(2) RECLAIMED WATER REGULATED UNDER PART III OF CHAPTER 62-610, F.A.C

---SEE DETAIL WW-04

L_{LINER}—

AT THE JOINTS. (EXTERNAL JOINT SEAL IS OPTIONAL)

PHONE (772) 873-6400 FAX (772) 873-6433

└#4 REBAR @12" E.W.

2. SEALANT SHALL BE APPLIED PER MANUFACTURER'S SPECIFICATION BETWEEN MANHOLE SECTIONS & AT ALL JOINTS (SEE DETAIL WW-04). ALSO AN APPROVED EXTERNAL JOINT SEAL MAY BE APPLIED

3. ALL PIPE OPENINGS SHALL BE GAS AND WATER TIGHT WITH NO EXPOSED CONCRETE SURFACES.

4. CAST OPENINGS SHALL BE MANUFACTURED WITH PRECAST HOLE W/ CAST-IN LINER SLEEVE SIZED FOR APPROPIATE PIPE AND FLEXIBLE CONNECTOR. APPROVED FLEXIBLE MANHOLE

CONNECTORS SHALL BE USED AT PIPE CONNECTIONS. HOLE SIZE PER BOOT MANUFACTURER'S

SLEEVES WHERE REQUIRED BY BOOT MANUFACTURER'S INSTALLATION INSTRUCTIONS.

6. LIFT HOLES ARE PERMITTED BUT MUST BE GROUTED ONCE MANHOLE IS IN PLACE.

7. MANHOLE AND BASE WILL BE LINED INSIDE WITH AN APPROVED LINER SYSTEM.

SPECIFICATIONS. DOUBLE STAINLESS STEEL PIPE CLAMPS MUST BE INSTALLED ON THE FLEXIBLE

5. FLOW CHANNELS SHALL BE CONSTRUCTED TO DIRECT FLOW INTO FLOW STREAM (SEE DETAIL

8. AN APPROVED COVER & FRAME SHALL BE PROVIDED. APPROVED INSIDE MANHOLE CHIMNEY SEALANT SHALL BE APPLIED OVER THE MANHOLE FRAME, CONCRETE RINGS, AND LINER SECTION IN

9. MAXIMUM HEIGHT OF CHIMNEY SHALL NOT EXCEED 24 INCHES INCLUDING FRAME CASTING.

1. MANHOLE FABRICATION SHALL BE IN ACCORDANCE W/ ASTM C-478, LATEST REVISION.

(3) RECLAIMED WATER NOT REGULATED UNDER PART III OF CHAPTER 62-610, F.A.C.

BUT NOT LIMITED TO:

FINISHED GRADE (PAVED AREA)

1" PREPACKED NON-SHRINK @ GROUT (3500 PSI MIN.)

& CONCRETE RINGS W/ RUBBER GASKET

6"MIN.---|

NOTES:

WW-01).

SANITARY SEWER FORCE MAIN

AND LOOPED AT EACH BELL FOR

ALL WATER AND FORCE MAINS



CONSTRUCTION — Weldable-grade hot-rolled, commercial-quality carbon steel tubing with a minimum yield of 55,000 psi. Uniform wall thickness of 11-gauge (0.1196") or 7-gauge (0.1793"). Shafts are one-piece construction with a full-length longitudinal high-frequency electric resistance weld. Round in cross-section having a uniform taper of approximately .14" per foot.

Anchor base is fabricated from hot-rolled carbon steel plate that conforms to ASTM A36 that meets or exceeds a minimum yield of 36,000 psi. Base plate and shaft are circumferentially welded top and bottom.

Rectangular reinforced handhole having nominal dimensions of 3 x 5" for 5.9" shaft and oval shaped 4 x 6.5" for all other shafts. Cover with attachment screws included. Handhole is located 18" above the base.

Weatherproof, removable top cap provided with all drill-mount poles. Fasteners are high-strength galvanized, zinc-plated or stainless steel.

Finish: Must specify finish.

Grounding: Provision located inside handhole rim. Grounding hardware is not included (provided by others). Anchor Bolts: Top portion of anchor bolt is galvanized per ASTM A-153. Made of steel rod having a minimum yield strength of 55,000 psi.

Each anchor bolt is furnished with two hex nuts and two flat washers. WARRANTY — 1-year limited warranty. Complete warranty terms located at:

www.acuitybrands.com/CustomerResources/Terms and conditions.aspx

NOTE: Actual performance may differ as a result of end-user environment and application.

I I I	
ROUND TAPERED STEEL FLORIDA RATINGS	

Anchor Base Poles

RDERING INFORMATION	Lead times will vary de	pending on options selected. Consult with your sales represen	tative. Exar	nple: RTS 30 6-6B DM19 DD
Nominal fixture mounting height RTS (See technical	Nominal shaft base size/wall thickness (See technical	Mounting ¹ Tenon mounting	Options Shipped installed	Finish ¹¹ Standard colors
information table for complete ordering information.) 20'-50' (for 1/2 ft increments, add -6 to the pole height. Ex: 20-6 equals 20ft 6in.)	information table for complete ordering information.) 5-9B (.120") 6-6B (.120") 7-0F (.179") 7-3B (.120") 7-8B (.120") 8-0B (.120") 8-0F (.188") 8-5B (.120") 9-0B (.120") 9-0F (.179") 9-5B (.120") 10-0B (.120")	PT Open top T20 2-3/8" O.D. (2" NPS)² T25 2-7/8" O.D. (2-1/2" NPS)² T30 3-1/2" O.D. (3" NPS)² T35 4" O.D. (3-1/2" NPS)² Drill mounting³ DM19 1 at 90° DM28 2 at 180° DM28PL 2 at 180° with one side plugged DM29 2 at 90°² DM32 3 at 120°² DM39 3 at 90°² DM49 4 at 90°² CSX/DSX/AERIS™/OMERO™/HLA/KAX Drill mounting³ DM19AS 1 at 90° DM28AS 2 at 180° DM29AS 2 at 180° DM29AS 3 at 120° DM39AS 3 at 90° DM39AS 3 at 90° DM39AS 3 at 90° DM39AS 4 at 90° AERIS™ Suspend drill mounting³,4 DMxxAST_ OMERO™ Suspend drill mounting³,4 DMxxMRT	L/AB Less anchor bolts (Include when anchor bolts are not needed) VD Vibration damper TP Tamper proof H1-18Sxx Horizontal arm bracket (1 fixture) ^{5, 6} FDLxx Festoon outlet less electrical ⁵ CPL12xx 1/2" coupling ⁵ CPL1xx 1" coupling ⁵ NPL12xx 1/2" threaded nipple ⁵ NPL34xx 3/4" threaded nipple ⁵ NPL1xx 1" threaded nipple ⁵ EHHxx Extra handhole ^{5,7} MAEX Match existiing ⁸ USPOM United States point of manufacture ⁹ IC Interior coating ¹⁰ Shipped separately (replacement kit available) (blank) FBC Full base cover (plastic) (blank) TC Top cap (blank) HHC Handhole cover	DDB Dark bronze DWH White DBL Black DMB Medium bronze DNA Natural aluminum GALV Galvanized finish Classic colors DSS Sandstone DGC Charcoal gray DTG Tennis green DBR Bright red DSB Steel blue Architectural colors (powder finish) ¹¹

1. When ordering tenon mounting and drill mounting for the

- same pole, follow this example: DM28/T20. The combination
- 2. N/A with RTS 25 5-9B, RTS 30 6-6B, RTS 35 7-3B, RTS 39 7-8B because pole top is too small. 3. Refer to the fixture spec sheet for the correct drilling template
- pattern and orientation compatibility. 4. Insert "1" or "2" to designate fixture size; e.g. DM19AST2. Specify location and orientation when ordering option.
 For 1st "x": Specify the height in feet above base of pole.
 Example: 5ft = 5 and 20ft = 20

HANDHOLE ORIENTATION

For 2nd "x": Specify orientation from handhole (A,B,C,D) Refer to the Handhole Orientation diagram above. 6. Horizontal arm is 18" x 2-3/8" O.D. tenon standard.

7. Combination of tenon-top and drill mount includes extra


11. Additional colors available; see www.lithonia.com/archcolors

or Architectural Colors brochure (Form No. 794.3).

8. Must add original order number.

Use when mill certifications are required.

Provides enhanced corrosion resistance.

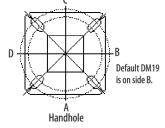

IMPORTANT INSTALLATION NOTES: Do not erect poles without having fixtures Factory-supplied templates must be used

when setting anchor bolts. Lithonia will not accept claim for incorrect anchorage placement due to failure to use factory templates. If poles are stored outside, all protective wrapping must be removed immediately upon delivery to prevent finish damage. Installation requires grout be packed under base to ensure full contact with foundation.


POLE-RTS-FLA

RTS-FLA Round Tapered Steel Poles - Florida Ratings

					TECHNICA	AL INFORM	IAIION					
Catalog	09 AASHTO 100 MPH FL Ultimate 120 mph		09 AASHTO 110 MPH FL Ultimate 130 & 140 mph		09 AASHTO 120 MPH FL Ultimate 150 mph		09 AASHTO 130 MPH FL Ultimate 160 mph		09 AASHTO 140 MPH FL Ultimate 170 & 180 mph		09 AASHTO 150 MPH	
Number	Max. EPA (ft²)*	Max weight (lbs)	Max. EPA (ft²)	Max weight (lbs)	Max. EPA (ft²)	Max weight (lbs)	Max. EPA (ft²)	Max weight (lbs)	Max. EPA (ft²)	Max weight (lbs)	Max. EPA (ft²)	Max weight (lbs)
RTS 20 5-9B	15.8	395	13.0	325	10.7	268	9.0	255	7.7	193	6.6	165
RTS 20 6-6B	19.9	498	16.4	410	13.7	343	11.6	290	10.0	250	8.7	218
RTS 25 5-9B	10.8	270	8.9	223	7.3	183	6.1	153	5.1	128	4.2	105
RTS 25 7-0B	16.9	423	13.9	348	11.5	288	9.7	243	8.3	208	7.2	180
RTS 25 7-0F	18.1	453	14.7	368	12.2	305	10.3	258	8.8	220	7.6	190
RTS 30 6-6B	10.2	255	8.5	210	6.9	173	5.7	143	4.7	118	3.9	98
RTS 30 8-0B	14.8	370	12.0	300	9.9	248	8.3	208	7.1	178	6.0	150
RTS 30 8-0F	26.1	653	21.6	540	18.1	453	15.4	385	13.2	330	11.4	285
RTS 35 7-3B	9.7	243	8.0	200	6.6	165	5.4	135	4.4	110	3.6	90
RTS 35 8-5B	11.7	293	9.3	233	7.6	190	6.2	155	5.2	130	4.3	108
RTS 35 9-5B	14.1	353	11.5	288	9.4	235	7.8	195	6.5	163	5.4	135
RTS 39 7-8B	9.1	228	7.1	178	5.6	140	4.4	110	3.5	88	2.7	68
RTS 39 9-0B	10.6	265	8.3	208	6.7	168	5.4	135	4.4	110	3.6	90
RTS 39 9-0F	20.2	505	16.5	413	13.7	343	11.4	285	9.7	243	8.2	205
RTS 45 10-0B	8.1	203	6.1	155	4.8	120	3.7	93	2.9	73	2.1	53
RTS 45 10-0F	16.9	423	13.7	343	11.2	280	9.2	230	7.7	193	6.4	160
RTS 50 10-0B	5.8	145	4.2	105	2.9	73	2.0	50	1.2	30	0.7	18
RTS 50 10-0F	13.6	340	10.7	268	8.5	213	6.9	173	5.5	138	4.4	110

*For 1/2 ft increments, add -6 to the pole height. Ex: 20-6 equals 20ft 6in.

BASE DETAIL
18"
Î

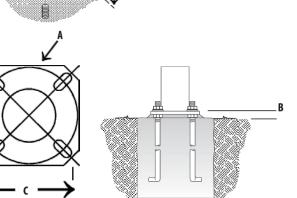

OUTDOOR: One Lithonia Way Conyers, GA 30012 Phone: 770-922-9000 www.lithonia.com

base size	Bolt circle A	Bolt projection B	Base square C	Template description	Anchor bolt description
i.9" B	9"	3-1/2" - 4-1/4"	10"	ABTEMPLATE PJ50075	AB36-0
i.5" B	9-1/2"	3-1/2" - 4-1/4"	10-1/2"	ABTEMPLATE PJ50074	AB36-0
'.0" B	10"	3-1/2" - 4-1/4"	10-7/8"	ABTEMPLATE PJ50077	AB36-0
7.0" F	10"	3-1/2" - 4-1/4"	10-7/8"	ABTEMPLATE PJ50076	AB36-0
i.6" B	9-1/2"	3-1/2" - 4-1/4"	10-1/2"	ABTEMPLATE PJ50078	AB36-0
3.0" B	11"	3-1/2" - 4-1/4"	11-1/2"	ABTEMPLATE PJ50079	AB36-0
3.0" F	11"	4-1/2" - 5-1/4"	11-1/2"	ABTEMPLATE PJ50080	AB42-0
′.3" B	10-1/2"	3-1/2" - 4-1/4"	11-1/4"	ABTEMPLATE PJ50081	AB36-0
3.5" B	11-1/2"	3-1/2" - 4-1/2"	12"	ABTEMPLATE PJ50082	AB36-0
).5" B	13"	3-1/2" - 4-1/2"	13"	ABTEMPLATE PJ50083	AB36-0
′.8" B	11"	3-3/4" - 4-1/2"	11-1/2"	ABTEMPLATE PJ50084	AB36-0
0.0" B	12-1/2"	3-3/4" - 4-1/2"	12-3/8"	ABTEMPLATE PJ50085	AB36-0
).0" F	12-1/2"	4-1/2" - 5-1/4"	12-3/8"	ABTEMPLATE PJ50086	AB42-0
0.0" B	13-1/2"	3-3/4" - 4-1/2"	14"	ABTEMPLATE PJ50087	AB36-0
0.0" F	13-1/2"	4-1/2" - 5-1/4"	14"	ABTEMPLATE PJ50088	AB42-0

Calculated EPA values based on current Florida building codes.


Maximum EPA (Effective Projected Area) and weight values are based on top mounted luminaires and/or brackets having a

4. Variations from sizes above are available upon inquiry at the factory. Satisfactory performance of poles is dependent upon the pole being properly attached to a supporting foundation of adequate design

A LITHONIA LIGHTING®

© 2010-2017 Acuity Brands Lighting, Inc. All rights reserved. Rev. 11/16/17

POLE-RTS-FLA

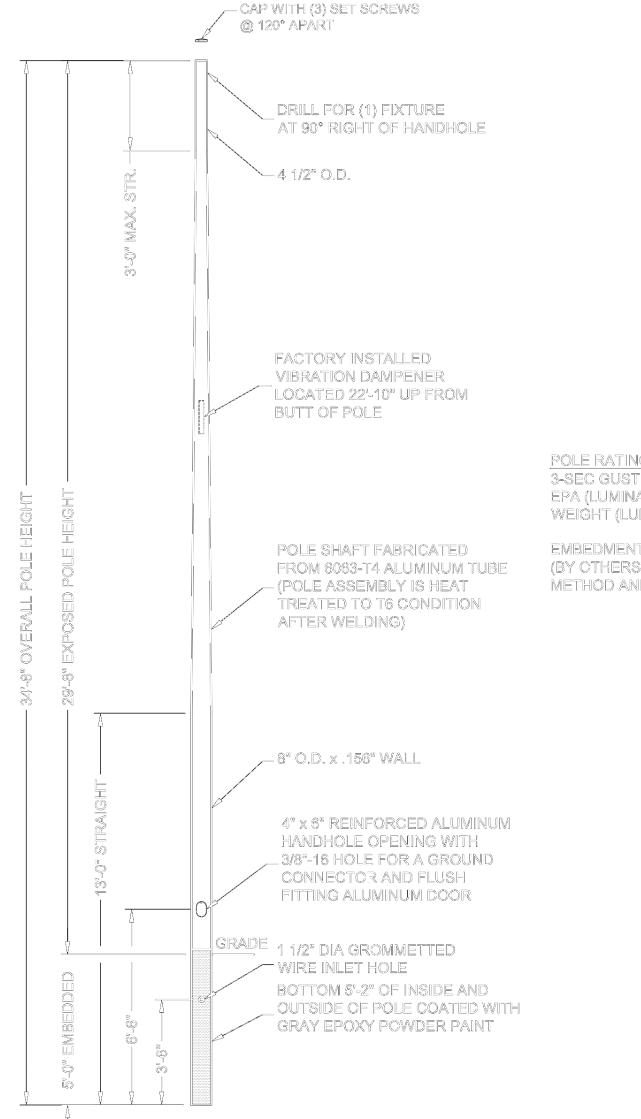

4 1/2" ALUMINUM POLE TOP

POLE RATING (PER FBC 2017): 3-SEC GUST ULTIMATE WIND SPEED: 170 MPH MAX EPA (LUMINAIRE): 0.95 SQ. FT. MAX WEIGHT (LUMINAIRE): 16 LBS MAX

EMBEDMENT DEPTH SHALL BE VERIFIED (BY OTHERS) BASED ON EMBEDMENT METHOD AND SITE SOIL CONDITIONS.

SHEET NUMBER C1.3