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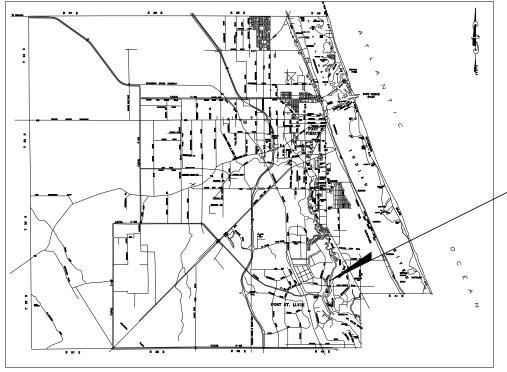
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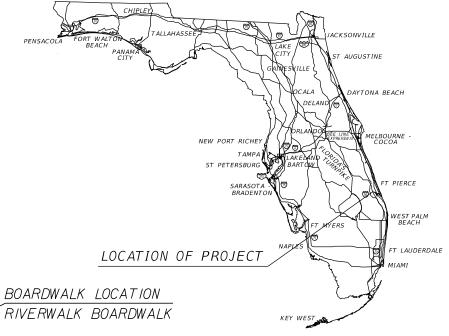
# CITY OF PORT ST. LUCIE CITY COUNCIL RIVERWALK BOARDWALK REHABILITATION

### CONTRACT PLANS

CITY CONTRACT NO. 20230084

ST. LUCIE COUNTY





#### CITY COUNCIL

Mayor - Shannon M. Martin Vice Mayor - Jolien Caraballo District 1 - Stephanie Morgan District 2 - David Pickett District 3 - Anthony Bonna, Sr.

PREPARED FOR



STRUCTURE PLANS ENGINEER OF RECORD:



JERRY MARCUS PICCOLO, P.E. NO.: 80484 KIMLEY-HORN AND ASSOCIATES, INC. 1920 WEKIVA WAY, SUITE 200 WEST PALM BEACH, FLORIDA 33411 (561) 840 0277 REGISTYRY NO. 35106

> 100% PLANS AUGUST 2024

> > SHEET

CITY OF PORT ST. LUCIE PROJECT MANAGER: MIKE KENDRICK

#### STRUCTURAL NOTES

- In case of conflict between the requirements of the specifications/construction drawings and these notes, the more stringent requirement shall apply.
- The governing codes for this project are the Florida Building Code (FBC) Eighth Edition (2023).
- The governing specifications for this project are the 2024 Standard Specification for Road and Bridge Construction as
- The contract documents have made no intent to give specific instructions concerning the means, methods, techniques, sequences, procedures and assignment of work.
- The Contractor shall be solely responsible for supervising and directing the work.
- Construction shall comply with requirements of the governing building code and all other applicable federal, state, and local codes, standards, regulations and laws.
- Contractor shall visit project site and be familiar with the proposed work. The Contractor shall take field measurements and verify all field conditions, and report any discrepancies to the Engineer prior to construction.
- Contractor shall review all contract documents, dimensions, and site conditions. Prior to construction, the Contractor shall coordinate field dimensions and project shop drawings. The Contractor shall verify all dimensions given on structural drawings relating to grid lines, column locations, structural and finished floor elevations, member sizes, etc, before starting any work. Report any discrepancies verbally and in writing immediately to the Engineer prior to proceeding with work. Work shall not commence until the discrepancies are resolved. Do not change size or dimensions of structural members without written instructions from the project Engineer of Record.
- Discrepancies, omissions or variations noted on the drawings or in the specifications discovered during and after the bidding period shall be immediately communicated in writing to the Engineer.
- Contractor shall protect existing facilities, structures and utility lines from damage and shall protect his work, adjacent property and the public. Contractor is solely responsible for job site safety, construction procedures and damage or injury due to his act or neglect.
- Scaling of drawings shall not be used to obtain or verify any dimension shown on the drawings. The Contractor shall refer to the Engineer for instruction for any dimension not given on drawings.
- Contractor shall provide 48 hours minimum advance notice to Engineer for all required field reviews.
- Contractor shall assemble and install materials and products in strict accordance with the Manufacturer's instructions and with industry/association standards.
- Prior to construction activites, the Contractor shall have the plan view limits of the boardwalk surveyed by a Professional Surveyor licensed in the State of Florida. At the completion of the project, the Contractor shall have the plan view limits surveyed by a Professional Surveyor licensed in the State of Florida. Surveys shall be provided to the City and Engineer.

#### DOCUMENTS AND LIMITATIONS

- The drawings, calculations, and reproductions relating to the structural part of the project are instruments of service to be used for this project only.
- It is understood that the Engineer makes no warranty, either expressed or implied, as to the findings, designs, recommendations, specifications, or professional advice except that these instruments of service have been prepared in accordance with current generally accepted professional engineering practices.

#### DESIGN LOADING

- Dead Loads: Superimposed dead load 10 psf (Boardwalk)
- Live Loads: 90 psf (Boardwalk)
- Wind Loads:

Governing Code: ASCE 7-22

Basic Wind Speed: Vult=170 mph St. Lucie County, Florida

- Directionality Factor: 0.85 - Exposure Category: C - Risk Category: I

#### UTILITIES

- Prior to commencement of any excavation, the Contractor shall comply with Florida Statute 556, underground facility damage prevention and safety.
- The Contractor shall call Sunshine (1-800-432-4770) for field locations two (2) business days prior to commencement of any excavation. The Contractor shall also be responsible to contact any utility owner(s) that may not be a "sunshine" member.
- The location of some existing utilities are shown in their approximate location; the exact location shall be determined by the Contractor during construction. Relocation of utilities shall be coordinated with the utility companies after identification of conflict by the Contractor. Contractor shall notify Engineer in advance before any relocation.
- Existing utilities are to remain in place unless otherwise noted.
- The Contractor is responsible for the protection of all utilities to remain in place.
- The utility companies shall be notified by the Contractor two (2) business days in advance of any excavation involving their utilities so that company representative can be present.

#### EROSION CONTROL

1. Comply with Florida Department of Transportation Standard Specification Section 104 for all erosion control measures.

#### SHOP DRAWINGS AND OTHER SUBMITTALS

Review of submittals by the Engineer is for general conformance with the design concept as presented by the Contract Documents. No detailed check of quantities or dimensions will be made. Only those submittals required to be submitted will be reviewed. All others will be returned without review.

REVISIONS DESCRIPTION DATE BY 1920 WEKIVA WAY, SUITE 200 WEST PALM BEACH, FL 33411 (561) 845-0665

- 2. All submittals shall be accompanied by a letter of transmittal. Contractor's submittal number shall be indicated on transmittal. Do not combine different submittals on the same transmittal. Submit shop drawings in a timely manner, consistent with the above, and prior to fabrication, installation or commencement of the work. Allow up to 10 working days for Engineer to review and return shop drawings. Number of copies of each submitted shop drawing shall be sufficient for Engineer to retain 2 copies.
  - All submittals must bear evidence of Contractor's review (including company stamp and dated signature of reviewer) and must be approved or approved as noted by him prior to submitting to the Engineer.
  - All changes and additions made on resubmittals must be clearly flagged and noted. The purpose of the resubmittals must be clearly noted on the letter of transmittal. Engineer review will be limited to those items causing the resubmittal.
- Do not reproduce the structural drawings for use as erection, placing or fabrication drawings.
- Submittals not meeting the above criteria or submitted after fabrication will not be reviewed.
- Submittals: at a minimum, the following shall be submitted, as applicable, to the Engineer for review and compliance with the intent of the Contract Documents prior to fabrication, installation, or commencement of the work.
  - a. Material certifications or data sheets for all timber and decking materials.
  - b. Product data sheets for all bolts, nuts, washers, and other hardware.
  - c. Aluminuum Railing layout and materials.

#### TIMBER

- Timber sizes shown in the plans are nominal sizes.
- Timber piling shall meet catagory UC5C and be pressure treated with Chromated Copper Arsenate (CCA) 2.5 CCA
- All 4 x X timber members shall meet catagory UC5C and be pressure treated with Chromated Copper Arsenate (CCA) 2.5 CCA
- All 3 x X timber members shall meet catagory UC5C and be pressure treated with Chromated Copper Arsenate (CCA) 2.5 CCA
- All 2 x X timber members shall meet catagory UC4C and be pressure treated with Chromated Copper Arsenate (CCA) 0.6 CCA
- Timber P.T. Southern Yellow Pine 6.
  - -No. 1 P.T. S.Y.P.
  - -FB=1,250 psi
  - -FV=175 psi
  - -E= 580.000 psi
- Timber piles shall follow FDOT Spcification Section 953 and treated in accordance with FDOT Standard Specification Section 955.
- All Decking and top runners shall be 2x6 WEARDECK Decking boards installed in accordance with the Plans and Manufacturer Specifications. Color to be selected by the Owner.
- 9. All railing side mounted runners shall be timber 2x6 members.

#### **FASTENERS**

- 1. All bolts, nuts, washers, screws, threaded rod, and fasteners used in conjunction with timber elements shall be Type 316 Stainless Steel.
  - Stainless Steel Bolts / Threaded Rod: ASTM A 193 Grade 8BM, Class 1.
  - Stainless Steel Nuts: ASTM A194 Grade 8M
  - Plates: Stainless Steel Type 316
- 2. All bolts on the inside face (walkway side) of the guardrail system shall be recessed flush with the guardrail.
- All screw heads shall be counter sunk flush with the decking and timber railing system.
- Washers shall be placed at both ends (bolt and nut) of all bolted connections.
- 5. All bolts shall utilize a jam nut.

#### ALUMINUM RAILING

- 1. Pipe material: Aluminum Alloy 6061-T6
- Pipe Size: 11/2" NPS (Sch. 40)
- Handrail shall follow FBC 8th Edition
- End Rails (bends) Aluminum Alloy 6063-T5 is permitted

#### CLEAN UP:

- The contractor shall at all times keep the site free from accumulation of waste materials or rubbish caused by his employees.
- At no time is any debris resulting from the project permitted within the waterway or associated areas. Contractor shall collect all debris and properly dispose off site.

#### BID ITEMS:

1. Payment for all incidentals is to be included in the price bid for contract items.

#### AS-BUILT DRAWINGS:

- 1. Contractor shall prepare and maintain current a set of redlined as-built drawings showing all deviations and changes made to the construction drawings.
- As-built drawings shall be made available to the owner for review upon request at any time during the course of the project.
- Contractor shall submit the original as-built drawings to the owner within one week from the date of final completion, and prior to owner's acceptance of contractor's final invoice.
- 4. Submitted as-built drawings will remain the property of the owner.

CITY OF PORT ST. LUCIE	GENERAL NOTES (1 OF 2)	SHEET NO.
PARKS AND RECREATION	RIVERWALK BOARDWALK REHABILITATION	5-2

#### DOCUMENTS AND LIMITATIONS:

- 1. The drawings, calculations, and reproductions relating to this project are instruments of service to be used for this project only.
- 2. It is understood that the engineer makes no warranty, either expressed or implied, as to the findings, designs, recommendations, specifications, or professional advice except that these instruments of service have been prepared in accordance with current generally accepted professional engineering practices.

#### MAINTENANCE OF PEDESTRIAN TRAFFIC

1. Contractor to close off area to pedestrian traffic for the duration of construction.

#### EXISTING BOARDWALK REMOVAL

1. The Contractor shall fully remove all elements of the existing boardwalk as shown in the plans and properly dispose of offsite.

#### TIMBER PILE NOTES

- 1. All timber piles shall be installed in accordance with "Supplemental Geotech Report Riverwalk Boardwalks Rehabilitation Project" Aradaman File No. 24-66-5451.
- 2. All new timber piles along the boardwalk shall be embedded minimum of 30 feet below the existing mudline.
- 3. No jetting is permitted.
- 4. Timber piles shall follow FDOT Specification Section 455-6.

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DATE	BY	DESCRIPTION	DATE	BY	DESCRIPTION	
						JERRY MARCUS PICCOLO, P.E. P.E. LICENSE NUMBER 80484 1920 WEKIYA WAY, SUITE 200 WEST PALM BEACH, FL 33411 (561) 845-0665 BEGISTRY NO. 35106

PARKS AND RECREATION

GENERAL NOTES (2 OF 2)

RIVERWALK BOARDWALK

SHEET

NO.

S-3

	RIVERWALK BOARDWALK		
PAY ITEM NO.	PAY ITEM DESCRIPTION	UNIT	QUANTITY
1	Mobilization, Demobilization & General Conditions	LS	
2	Staging Area & Marine Transport of Materials	LS	
3	Prevention, Control, and Abatement of Erosion and Water Pollution	LS	
4	Demo & Dispose - Existing Timber Piles	EA	19
5	Demo & Dispose - Existing Framing	SF	879
6	Demo & Dispose - Existing Decking	SF	13,69
7	Demo & Dispose - Existing Timber Handrailing	LF	13
8	Demo & Dispose - Concrete Sidewalk Approaches	LO	
9	Demo & Dispose - Abandoned Light Pole Supports	EA	
10	Removal and Storage of to be Re-used Existing Aluminum Handrailing	LF	1,28
11	Removal and Storage of to be Re-used Existing Lights/Poles/CCTV	EA	,
12	Other Unclassified Demolition	LS	
13	New 12" Min Butt x 55' long Timber Piling (North/South Boardwalk)	EA	18
14	New 12" Min Butt x 65' Long Timber Piling (Hexagon Outlook)	EA	31
15	New SYP Boardwalk Framing and SS Hardware	SF	879
16	New 2X Weardeck and SS Hardware	SF	13,69
17	Cross Bracing	LO	4
18	New Timber Handrail with Weardeck Top Cap	LF	13
19	New 2x6 Weardeck Top Cap Installed on Entirety of East/West Boardwalk	LF	96
20	New North Boardwalk Extension with Railing and Concrete Footer	LS	
21	New Aluminum Handrailing	LF	75.
22	Re-installation of Aluminum Handrailing	LF	75.
23	New Sidewalk Approaches	EA	
24	Level Settled Boardwalk	LO	
25	Remove and re-install Benches and Trash Recepticals	LS	
26	New Electical and Fiberoptic Service, Re-use Lights and CCTV, New Mounts	LS	
27	New and Reused Waterline, New Hose Bibs, and New Mounts	LS	

#### PAY ITEM NOTES

- Pay Item 1 Mobilization, Demobilization, & General Conditions This Pay item shall also include all costs associated with the pre and post construction survey of the boardwalk. This pay item shall also include all costs associated with development of as-built plans.
- Pay Item 3 Prevention, Control, and Abatement of Erosion and Water Pollution This pay item shall also include all costs associated with all measures required to meet FDOT Specification Section 104.
- Pay Items 4 thru 9 Demo & Dispose These Pay Items shall also include all costs associated with properly disposing of all removed materials of site.
- Pay Item 15 New SYP Boardwalk Framing and SS Hardware This pay item shall also include all costs associated with furnishing and installing the SS tie down straps, SS hardware, and all timber framing members as shown in the plans.
- Pay Item 17 Cross Bracing This pay item shall also include all costs to furnish and install cross bracing at the locations shown on the plans.
- Pay Item 19 New 2x6 Weardeck Top Cap Installed on Entirety of East/West Boardwalk This pay item shall also include all associated with removing and properly disposing of the existing top cap.

- Pay Item 20 New North Boardwalk Extension with Railing and Concrete Footer This pay item shall also include all costs associated with furnishing and installing the northern boardwalk extension including but not limited to, excavations, compaction, footing material and installation, handrailing extension, boardwalk framing and decking, bearing pads, and sodding all areas damaged in construction.
- Pay Item 26 New Electrical and Fiberoptic Service, Re-use Lights and CCTV, new Mounts This pay item shall also include all costs associated with the furnishing and installing the strengthening of the existing light pole mounts at the seven locations shown in the plans on the northern section of boardwalk.

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DATE	BY	DESCRIPTION	DATE	BY	DESCRIPTION	<b>∃Kımley≫Horn</b>
						JERRY MARCUS PICCOLO, P.E. P.E. LICENSE NUMBER 80484 1920 WEKIVA WAY, SUITE 200 WEST PALM BEACH, FL 33411 (561) 845-0665 BEGISTRY NO. 35106

CITY OF PORT ST. LUCIE	
PARKS AND RECREATION	

#### 1. Site Description

- A. Construction Activity: Riverwalk Boardwalk Rehabilitation
- B. Sequence of soil disturbing activites: Soil disturbig activites will take place during much of the anticipated construction period of this project. The following soil disturbing activites are listed in the approximate order in which they anticipated to occur.
  - 1. Removal of designated exiting timber piles 2. Installation of new timber piles
- C. Total project area: 8790 SF
- D. Runoff data: N/A
- E. Site map: See General Site Plan
- F. Recieving waters: N/A

#### 2. Controls

Sediment and turbidity controls: The sediment and turbidity controls shall be maintained by the Contractor to minimize and contain the amount of turbidity.

All items represented in the following discussion are treated in detail in the "Florida Department of Transportation Standard Specification for Road and Bridge Construction" or will be implemented by the Engineer in a manner appropriate to environmentally sensitive construction practices. The Contractor will generate site specific erosion control plan including an implementation schedule for each phase of construction operations or activities. The Contractor will also be required to modify the plan or materials to adapt to seasonal variations and supply contract time schedules for the implementation of each subunit.

- A. Boardwalk Removal and Installation Practices: During construction the Contractor will provide temporary floating turbidity curtains to encapsulate the areas in which Boardwalk pile removal and installation practices will occur.
- B. Phasing of Controls;

  - Phase I Installation of Environmental Control Features
    A. Environmental Control features as provided in the plans are to be installed throughout mobilization to the site and be in place prior to the start of any Boardwalk work.
    - B. The Contractor will be required to prepare a site specific erosion control plan along with a specific construction schedule for implementation. The Contractor will also be required to modify the plan or materials to adapt to
    - C. The Contractor will be responsible for monitoring any activities for violation of water quality standards as they relate to turbidity (29 NTU's above background). Testing will take place to substantiate the intent of the project permits throughout the duration of the project. If the water quality standard is violated, sediment and erosion control measures will be reevaluated and re-installed as directed by the Engineer.
- Phase II Removal of Environmental Control Features
  - A. Temporary Environmental Controls will be removed after all boardwalk related work is completed.
- C. Other Controls
  - A. Waste Disposal: The Contractor will provide litter control and collection within the project boundaries during construction activities. All fertilizer, hydrocarbon, or other chemical containers shall be disposed of by the Contractor according to EPA's standard.
  - B. Sanitary Waste: Any field offices will have portable toilet facilities or the Contractor will obtain permits for sewage treatment in accordance with IOD-6 F.A.C. "Standards for On-site Sewage Disposal Systems".

The sequence of construction shown above is a general overview and is not intended to convey the general concepts of the erosion control design and should not be relied upon for construction purposes. The Contractor is solely responsible for detailed phasing and construction sequencing necessary to construct the proposed improvements included in these plans. The Contractor shall notify Engineer in writing immediately, prior to and/or during construction if any additional information on the construction sequence is necessary. Contractor is solely responsible for complying with the requirements of the Authority Having Jurisdiction and all other applicable laws.

F Permits

The following permits have been obtain for the project:
US Army Corps of Engineers Nationwide 3 Permit (SAJ-2002-00085)

The Contractor is responsible for obtaining the following permits:
FDEP - NPDES permit (if needed)
SFWMD - Temporary Dewatering Permit (if needed)

Additional permit fees are to be included in the cost of Mobilization.

#### 3. Maintenance

The Contractor shall be responsible for daily inspection and maintenance of all erosion control devices throughout the construction phase of the project. Maintenance shall be conducted in accordance with "FDOT Standard Specifications for Road and Bridge Construction" Section 104 or as directed by the Engineer.

The Contractor will be responsible for maintenance and repairs of erosion and sediment control devices, and removal of erosion and sediment control devices until acceptance of the completed project by City.

Maintenance and repair required for the control and abatement of erosion and water pollution shall be included in the cost of pay item 104-2A.

#### 3. Maintenance (continued)

The following practices will be used to maintain erosion and sediment controls:

General:

All measures will be maintained in good working order. If a repair is necessary, it will be initiated within

Floating turbidity barrier will be maintained with respect to depth of sediment and ensure that the fabric is attached securely to the floats and anchored properly at the bottom for proper sediment control.

#### 4. Inspection

All erosion and water pollution abatement and control measures will be inspected daily by the contractor.

Inspections are to be performed by qualified personnel who have completed the Florida Storm Water, Erosion and Sediment Control Training and Certification Program for inspectors and Contractors who have passed

Inspection Areas: Locations or areas to be inspected include but are not limited to:

- Materials storage/stockpilesFloating turbidity barriers

The Contractor shall use the Construction Inspection Report form 650-040-03 for daily inspections.

The Contractor's Daily Inspections required for the control and abatement of erosion and water pollution shall be included in the cost of Pay Item 104-2A.

Tracking and Reporting

The Contractor is responsible for completing the Inspection Report form 650-040-03 every 7 days and after any 0.50 inch (or more) rainfall event. A copy of the inspection report shall be submitted to the Engineer weekly

The City shall maintain all records submitted by the Contractor.

Preparation of the Contractor's Weekly reports of inspections, Maintenance and Repairs required for the control and abatement of erosion and water pollution shall be included in the cost of Pay Item 104-2A.

#### 5. Non-Storm Water Discharge and Hazardous Waste

The contractor will provide City of Port St. Lucie with an erosion control plan that incorporates the construction schedule and will include spill reporting and response.


When the Contractor encounters a spill, Contractor will stopwork and work will not resume until directed by the Engineer. Disposition of hazardous waste will be made in accordance with any requirements and regulations of any local, state or federal agency having jurisdiction.

#### 6. References

The Construction Plans and Specifications for Riverwalk Boardwalk Rehabilitation project are hereby referenced and made part of this stormwater pollution prevention plan.

#### 7. Quantities


See construction plans Summary of Quantities sheets for erosion control quantity tabulation.

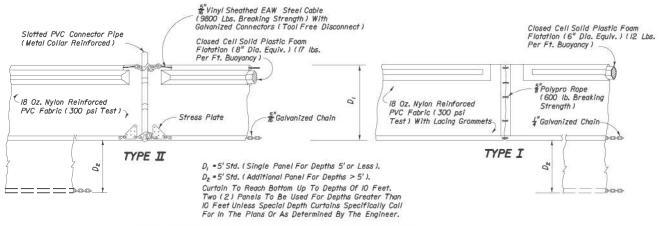

NOTICE: COMPONENTS OF TYPES I AND II MAY BE SIMILAR OR IDENTICAL TO PROPRIETARY DESIGNS. ANY INFRINCEMENT ON THE PROPRIETARY RIGHTS OF THE DESIGNER SHALL BE THE SOLE RESPONSIBILITY OF THE USER. SUBSTITUTIONS FOR TYPES I AND II SHALL BE AS APPROVED BY THE ENGINEER.


FLOATING TURBIDITY BARRIERS

DATE	ВҮ	R E V I S I O N S  DESCRIPTION DATE	BY	DESCRIPTION	Kimley»Horn	CITY OF PORT ST. LUCIE	EROSION CONTROL GENERAL NOTES	SHEET NO.
					P.E. LICENSE NUMBER 80484 1920 WEKIVA WAY, SUITE 200 WEST PALM BEACH, FL 33411 (561) 845-0665 REGISTRY, 03-35106	PARKS AND RECREATION	RIVERWALK BOARDWALK REHABILITATION	S-5

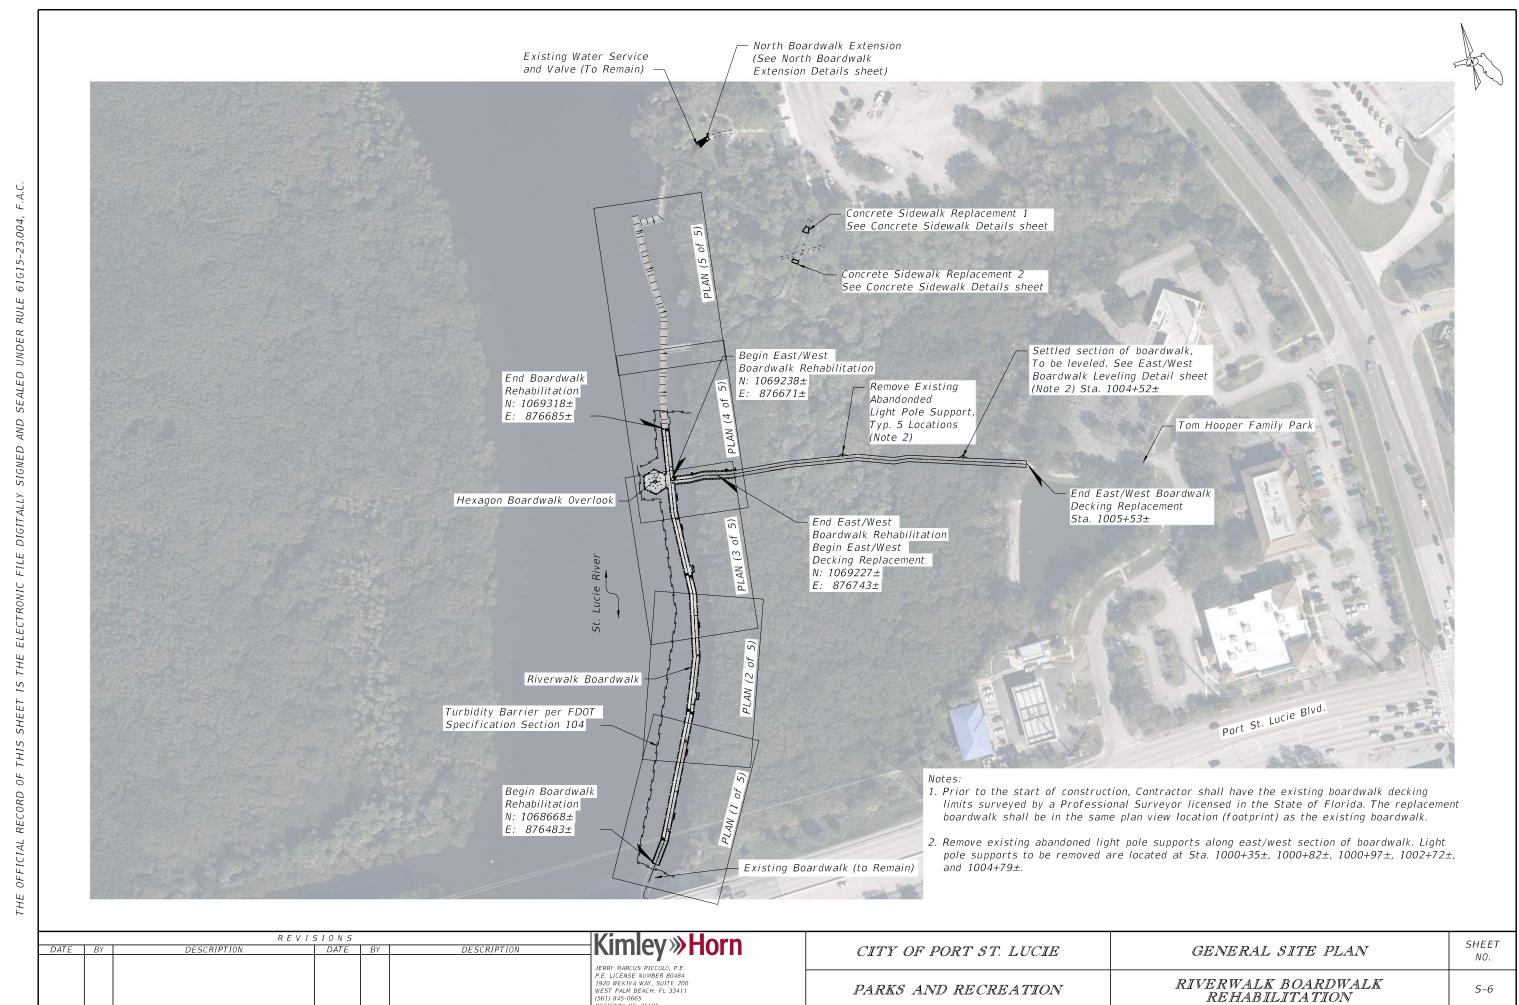





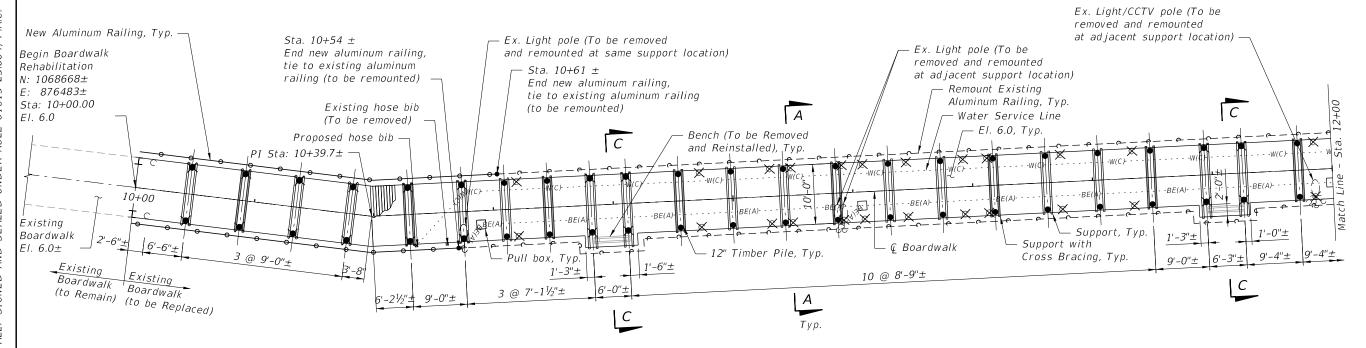

#### PLAN

#### NOTES:

- 1. Prior to the start of construction, the Contractor shall survey the plan view limits of the existing boardwalk. The replacement boardwalk shall be installed within the plan view limits of the existing boardwalk and shall tie into existing boardwalk sections that are to remain.
- 2. Top of boardwalk elevation shall be El. 6.0.
- 3. At locations where boardwalk replacement ties into an existing boardwalk, adjust top of boardwalk elevation to meet existing elevation within adjoining span.
- 4. For Section A-A and C-C see "Boardwalk Sections (X of 3) sheets.
- 5. For light/CCTV pole and Hose Bib mounting details, see "Boardwalk Utility Details (X of 2)" sheets.

#### LEGEND:

Indicates Proposed Timber Piles

Indicates Proposed Timber Piles Installed at location of existing timber pile (to be removed)

Indicates Existing Light / CCTV Pole


← - Indicates Existing Aluminum Railing (To be remounted)

Indicates Support Location with Cross Bracing

[	DATE	R E V           BY         DESCRIPTION	ISIONS DATE BY	DESCRIPTION	—Kimley≫Horn	CITY OF PORT ST. LUCIE	BOARDWALK PLAN (1 OF 5)	SHEET
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					P.E. LICENSE NUMBER 80484 1920 WEKIVA WAY, SUITE 200 WEST PALM BEACH, FL 33411 (561) 845-0665 BEGISTEY NO 38166	PARKS AND RECREATION	RIVERWALK BOARDWALK REHABILITATION	S-7



St Lucie River

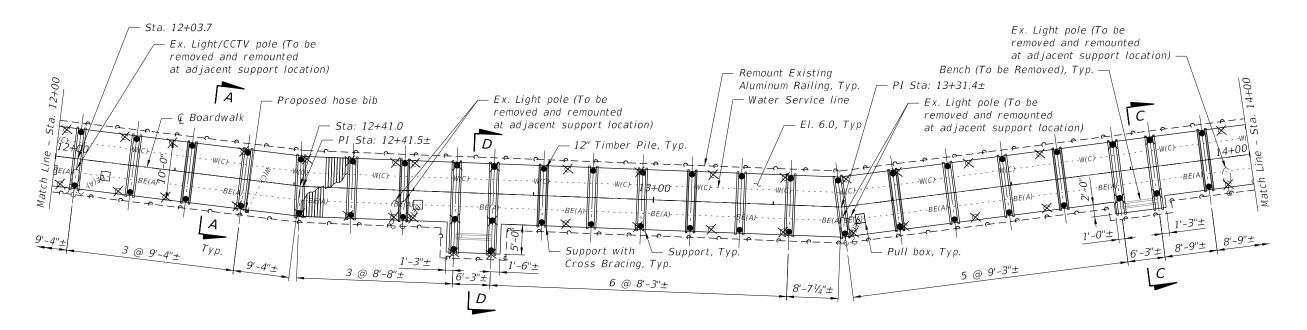

#### <u>PLAN</u>

#### NOTES:

- 1. Prior to the start of construction, the Contractor shall survey the plan view limits of the existing boardwalk. The replacement boardwalk shall be installed within the plan view limits of the existing boardwalk and shall tie into existing boardwalk sections that are to remain.
- 2. Top of boardwalk elevation shall be El. 6.0.
- 3. For Section A-A, C-C, and D-D see "Boardwalk Sections (X of 3)" sheets.
- 4. For light/CCTV pole and Hose Bib mounting details, see "Boardwalk Utility Details (X of 2" sheets

1	FG	FN	ID	

- Indicates Proposed Timber Piles

Indicates Proposed Timber Piles Installed at location of existing timber pile (to be removed)

▼ - Indicates Existing Timber Pile (to be Removed)

Indicates Existing Timber Piles (To Remain)

- Indicates Existing Light / CCTV Pole

- Indicated Existing Light Pole

- ← · - Indicates Existing Aluminum Railing (To be remounted)


→ → - Indicates new Aluminum Railing

Indicates Support Location

- Indicates Support Location with Cross Bracing

DATE	BY	R DESCRIPTION	EVISIONS DATE BY	DESCRIPTION	Kimley»Horn	CITY OF PORT ST. LUCIE	BOARDWALK PLAN (2 OF 5)	SHEET NO.
					JERRY MARCUS PICCOLO, P.E. P.E. LICENSE NUMBER 80484 1920 WEKIYA WAY, SUITE 200 WEST PALM BEACH, FL 33411 (551) 845-0665 BEGISTRY NO. 35106	PARKS AND RECREATION	RIVERWALK BOARDWALK REHABILITATION	5-8



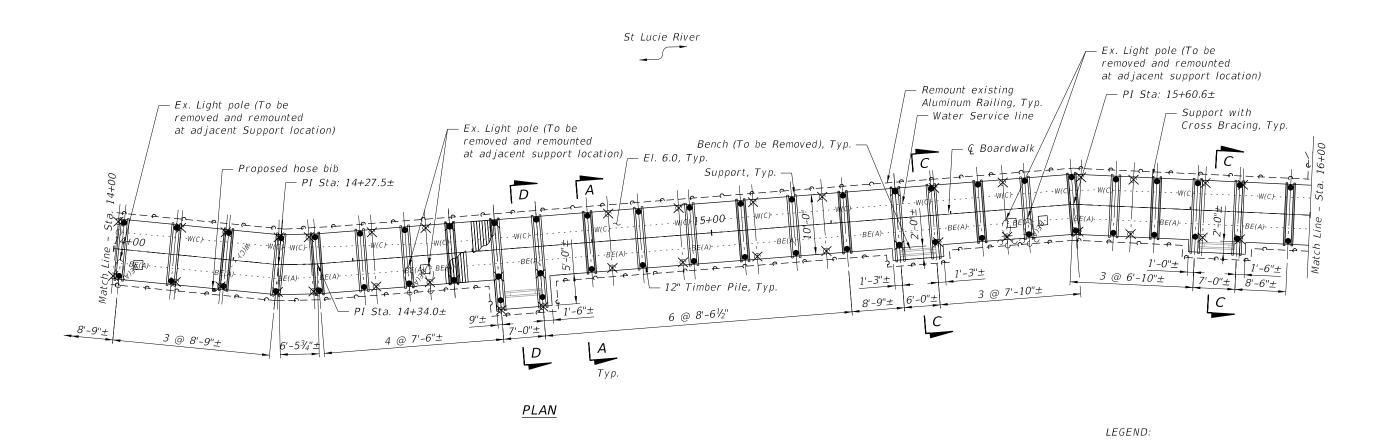

- 1. Prior to the start of construction, the Contractor shall survey the plan view limits of the existing boardwalk. The replacement boardwalk shall be installed within the plan view limits of the existing boardwalk and shall tie into existing boardwalk sections that are to remain.
- 2. Top of boardwalk elevation shall be El. 6.0.
- 3. For Section A-A, C-C, and D-D see "Boardwalk Sections (X of 3)" sheets.
- 4. For light/CCTV pole and Hose Bib mounting details, see "Boardwalk Utility Details (X of 2)" sheets.

		REVI	SIONS			Vim ov W Horn
DATE	BY	DESCRIPTION	DATE	BY	DESCRIPTION	
						JERRY MARCUS PICCOLO, P.E. P.E. LICENSE NUMBER 80484 1920 WEKIVA WAY, SUITE 200 WEST PALM BEACH, FL 33411 (561) 845-0665

CITY OF PORT ST. LUCIE

PARKS AND RECREATION

BOARDWALK PLAN (3 OF 5)

(To be remounted)

RIVERWALK BOARDWALK REHABILITATION

Indicates Proposed Timber Piles

Indicates Existing Light / CCTV Pole

Indicates Existing Aluminum Railing


Indicated Existing Light Pole

Indicates Support Location

Indicates Proposed Timber Piles Installed at location of existing timber pile (to be removed) Indicates Existing Timber Pile (to be Removed)


Indicates Support Location with Cross Bracing

SHEET

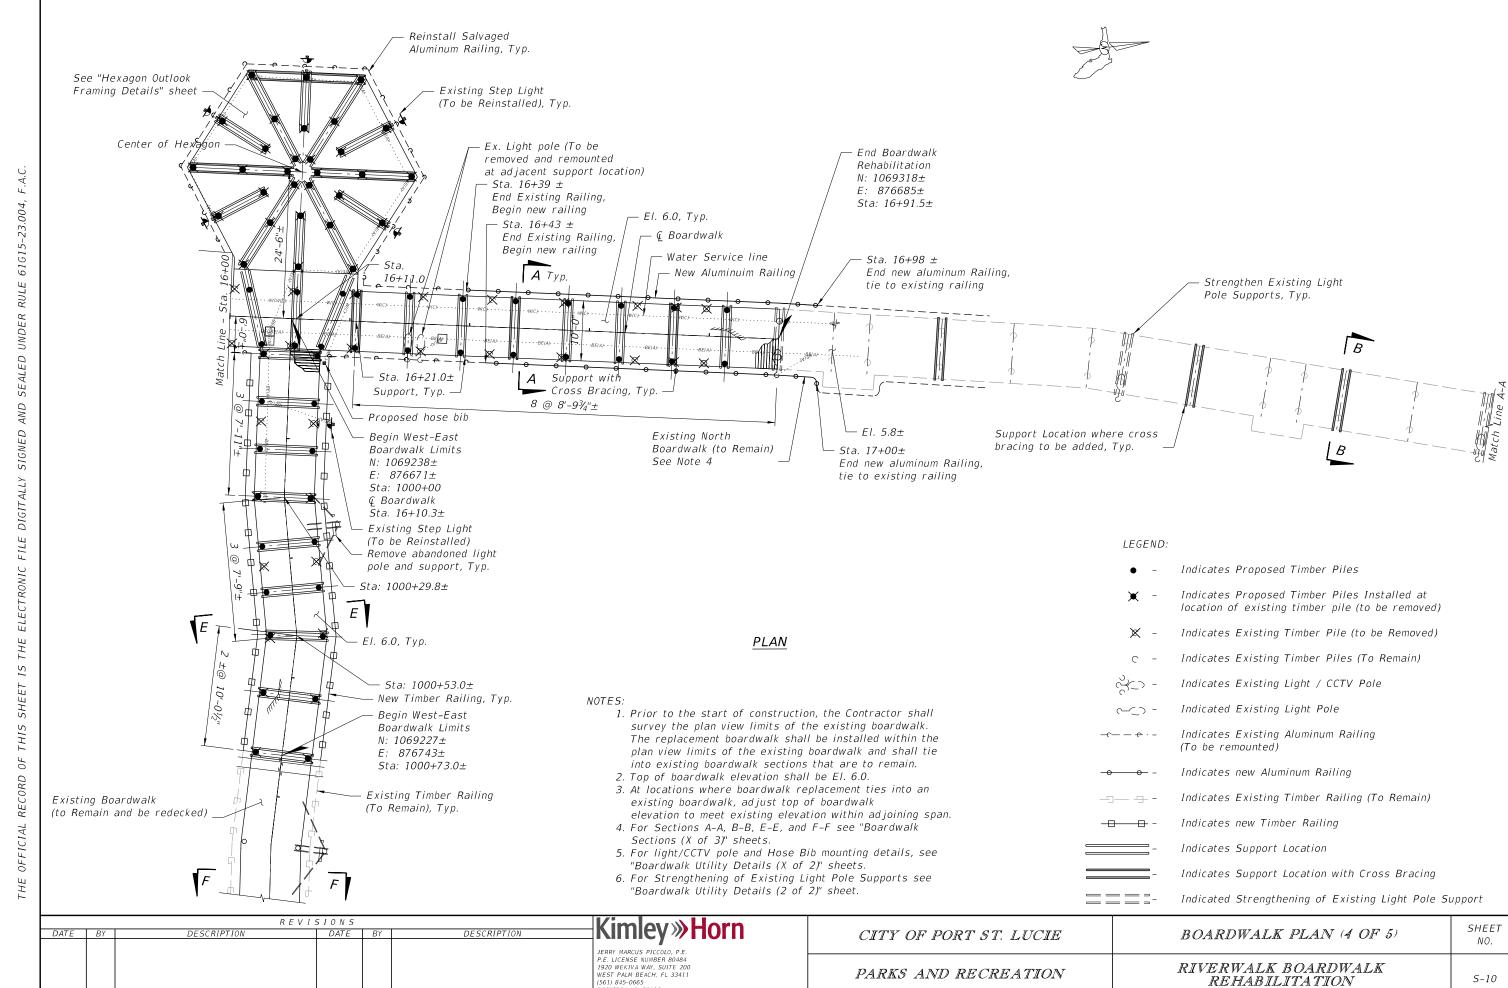

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#### <u>PLAN</u>

NOTES

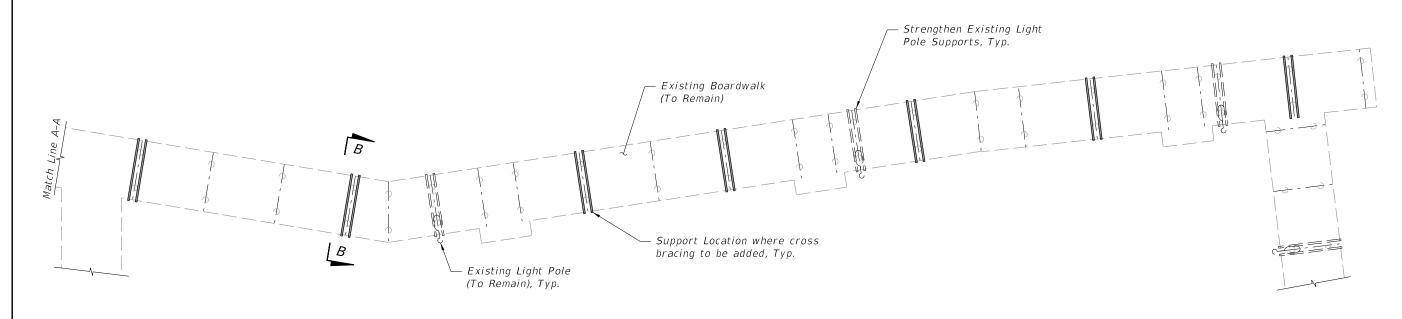1. For Section B-B see "Boardwalk Sections (X of 3)" sheets.

2. For Strengthening of Existing Light Pole Supports see "Boardwalk Utility Details (2 of 2).

LEGEND:


C - Indicates Existing Timber Piles (To Remain)

- Indicated Existing Light Pole (To Remain)

Indicates Existing Support Location to add Cross Bracing

Indicated Strengthening of Existing Light Pole Support

		REVISION	5		Kimlov W Horn			SHEET
DATE	BY	DESCRIPTION DAT	BY	DESCRIPTION	JERRY MARCUS PICCOLO, P.E.	CITY OF PORT ST. LUCIE	BOARDWALK PLAN (5 OF 5)	NO.
					P.E. LICENSE NUMBER 80484 1920 WEKIVA WAY, SUITE 200 WEST PALM BEACH, FL 33411 (561) 845-0665	PARKS AND RECREATION	RIVERWALK BOARDWALK REHABILITATION	S-11

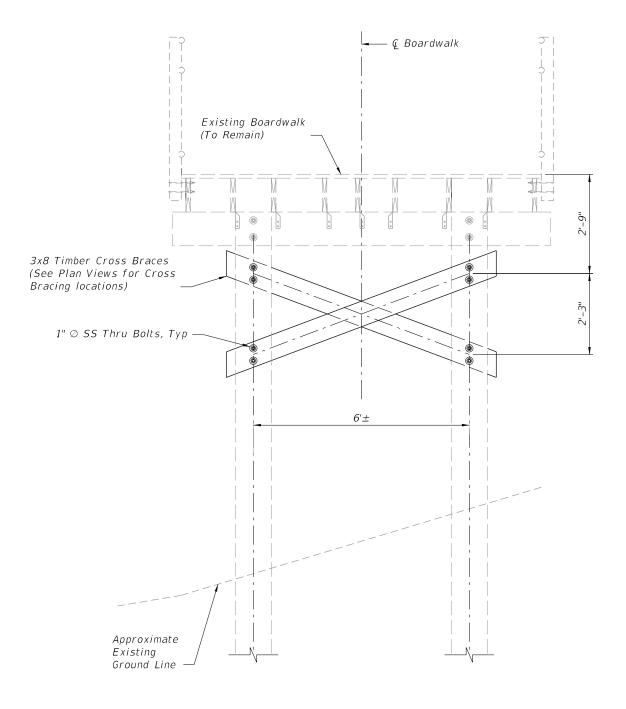

#### SECTION B-B - NORTH BOARDWALK CROSS BRACING

(From Sta. 16+91 to North End)

DATE	BY DESCRIPTION	R E V I S I O N S DATE	BY	DESCRIPTION	<b>⊣Kimley≫Horn</b>	CITY OF PORT ST. LUCIE	BOARDWALK SECTIONS (1 OF 3)	SHEET NO.
					JERRY MARCUS PICCOLO, P.E. P.E. LICENSE NUMBER 80484 1990 WEKIVA WAY, SUITE 200 WEST PALM BEACH, FL 33411 (561) 845-0665	PARKS AND RECREATION	RIVERWALK BOARDWALK REHABILITATION	S-12


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REVISIONS

| DATE | BY | DESCRIPTION | BOARDWALK SECTIONS (2 OF 3) | NO. |

| PARKS AND RECREATION | RIVERWALK BOARDWALK | SECTIONS (2 OF 3) | NO. |
| PARKS AND RECREATION | REHABILITATION | S-13



#### SECTION F-F - E/W BOARDWALK REDECKING SECTION

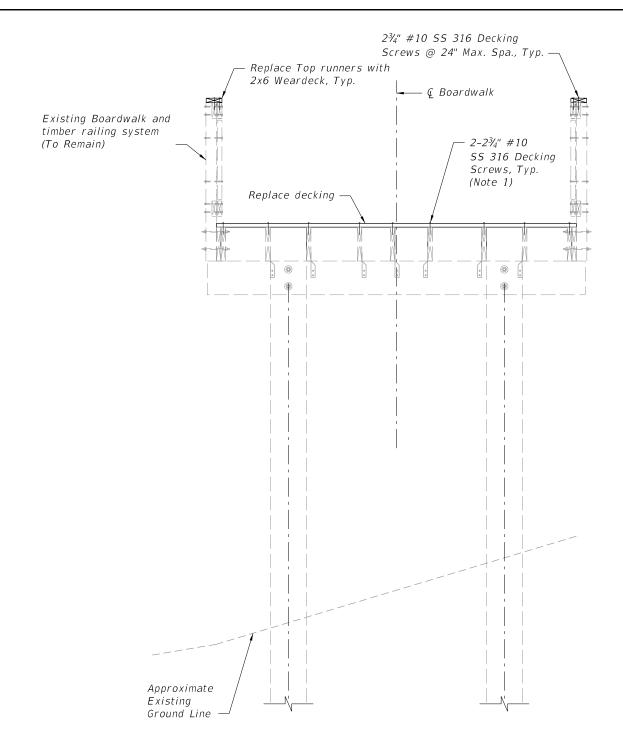(From Sta. 1000+73± to 1005+53±)

#### SECTION E-E - E/W BOARDWALK REPLACEMENT SECTION

5'-0"

Decking -

2x8 Timber

Stringers


4'-3"

10'-0"


5'-0"


(From Sta. 1000+00 to Sta. 1000+73±)

		VISIONS		Kimley WHorn			SHEET
DATE BY	DESCRIPTION	DATE BY	DESCRIPTION	Killiley " HOLLI	CITY OF PORT ST. LUCIE	BOARDWALK SECTIONS (3 OF 3)	NO.
				JERRY MARCUS PICCOLO, P.E.			
				P.E. LICENSE NUMBER 80484 1920 WEKIVA WAY, SUITE 200 WEST PALM BEACH, FL 33411 (561) 845-9665 DECEMBER 90 85166	PARKS AND RECREATION	RIVERWALK BOARDWALK REHABILITATION	S-14

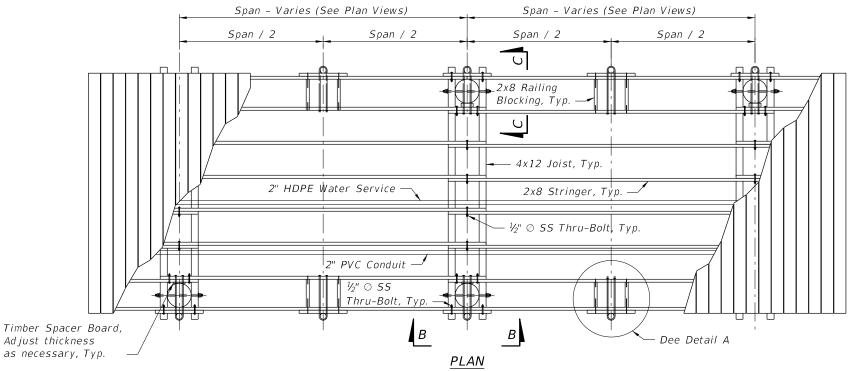

(New Aluminum Railing Mounting Shown, Horizontal railing elements not shown for clarity)

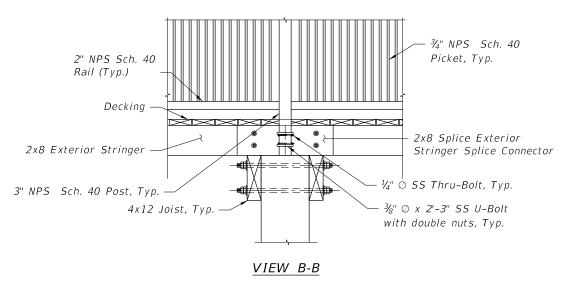


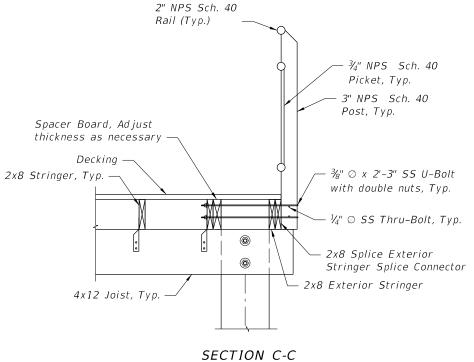

#### Notes:

- 1. For locations of new Aluminum Railing System, see plan views.
- 2. Prior to fabrication Contractor shall submit shop drawings showings of the new sections
  Aluminum railing system that tie to the nearest joint of the existing aluminum railing system.
- 3. Install the  $\frac{3}{8}$ " U-Bolts so that the U-Bolt bears on the  $\frac{1}{4}$ " keeper bolts. Both the U-Bolts and the  $\frac{1}{4}$ " keeper bolts shall have a jam nut to ensure nut does not work free.
- 4. For Additional Aluminum Pedestrian/Bicycle Picket railing details, see FDOT 2010 Interim Design Standard Index No. 860.
- 5. For mounting details for the existing aluminum railing system (to be salvaged) see "Existing Aluminum Railing Details" sheet as mounting locations will vary to maintain existing aluminum railing post locations.

DATE BY	R I DESCRIPTION	EVISIONS  DATE BY	DESCRIPTION	Kimley » Horn	CITY OF PORT ST. LUCIE	BOARDWALK FRAMING AND NEW ALUMINUM RAILING DETAILS	SHEET NO.
				JERNT MARCUS PICCOLO, P.E. P.E. LICENSE NUMBER 80484 1920 WEKIVA WAY, SUITE 200 WEST PALM BEACH, FL 33411 (561) 845-0665 BEGISTER NO. 35106	PARKS AND RECREATION	RIVERWALK BOARDWALK REHABILITATION	S-15

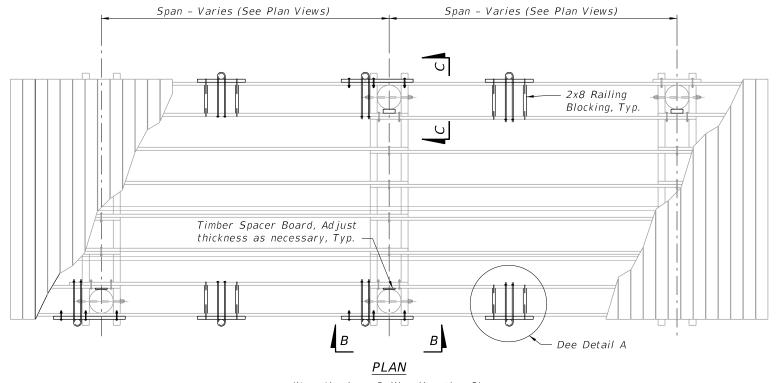

2x8 Railing Blocking, Typ. #10 x 3" SS Screw, Typ.


#12 x 4½" SS Screw, Typ.


2x8 Railing Spacer #12 x 4½" SS U-Bolt with double nuts, Typ.

½" © SS Thru-Bolt, Typ.

DETAIL A

(New Aluminum Railing Mounting Shown, Horizontal railing elements not shown for clarity)

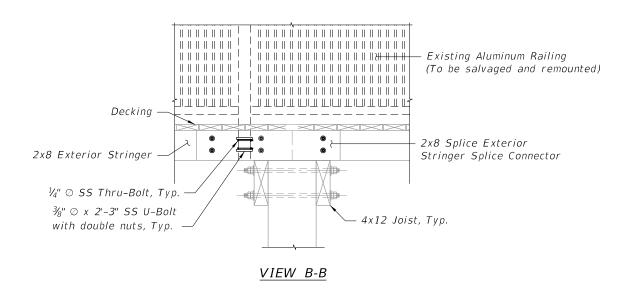


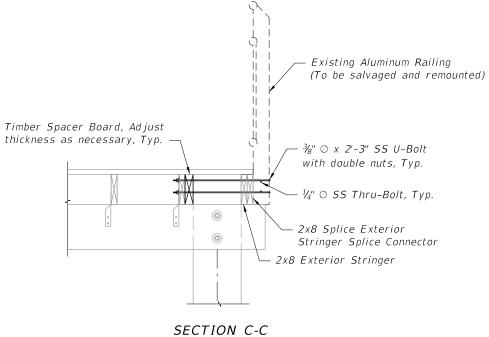


#### Note


- 1. For locations of existing Aluminum Railing System, to be salvaged and remounted, see plan views.
- 2. Install the ¾" U-Bolts so that the U-Bolt bears on the ¼" keeper bolts. Both the U-Bolts and the ¼" keeper bolts shall have a jam nut to ensure nut does not work free.
- 3. The mounting locations of the existing aluminum railing system posts will vary in location with respect to the timber pile locations.
- 4. For Additional Aluminum Pedestrian/Bicycle Picket railing details, see FD0T 2010 Interim Design Standard Index No. 860.

DATE BY	R E V I S I O N S  DESCRIPTION DATE	BY DESCRIPTION	Kimley » Horn	CITY OF PORT ST. LUCIE	EXISTING ALUMINUM RAILING DETAILS	SHEET NO.
			P.E. LICENSE NUMBER 80484 1920 WEKIYA WAY, SUITE 200 WEST PALM BEACH, FL 33411 (561) 845-0665 REGISTRY NO. 35106	PARKS AND RECREATION	RIVERWALK BOARDWALK REHABILITATION	5-16
-				Jerry.Piccolo 8/12/2024 3:57:2-	4 PM K:\WPB Structures\047793010_PSL Boardwalk\047793010\struct\B1ExistingAlum	RailingDetails01.do

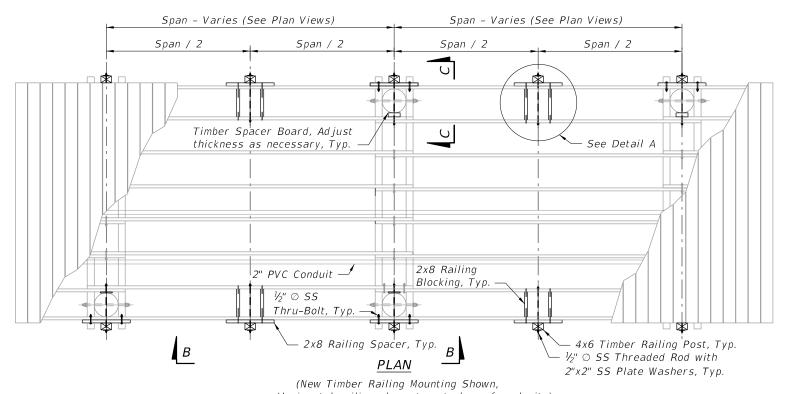

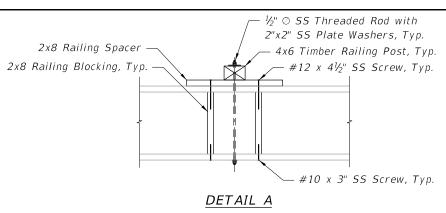


Horizontal railing elements not shown for clarity)

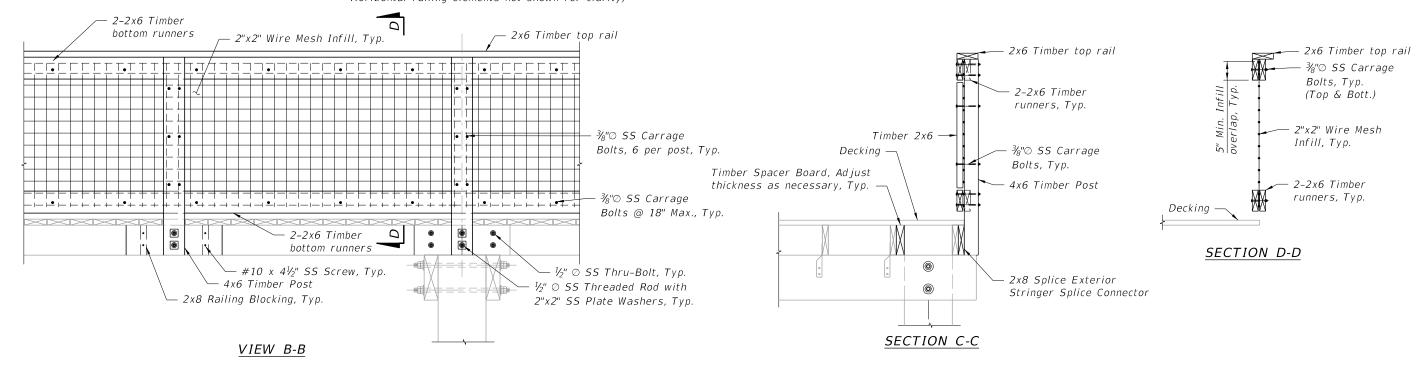



Wire Mesh Infill Notes:


- 1. Wire mesh infill shall be woven and welded steel mesh with minimum 6 gauge wire.
- 2. Wire mesh infill shall be hot dip galvanized or SS 304. Where wire mesh is cut or trimmed, the exposed steel shall be treated with zinc rich paint. Wire mesh shall be black in color and match the existing mesh.
- 3. All bolts shall be carrage bolts or recessed flush with front face of railing.

		7, -	VISIONS		Kimlov W Horn			SHEET	
DATE	BY	DESCRIPTION	DATE BY	DESCRIPTION	Kimiey » Horn  JERRY MARCUS PICCOLO, P.E.	CITY OF PORT ST. LUCIE	TIMBER RAILING DETAILS		
					P.E. LICENSE NUMBER 80484 1920 WEKIYA WAY, 5UITE 200 WEST PALM BEACH, FL 33411 (561) 845-0665 REGISTRY, NO. 35106	PARKS AND RECREATION	RIVERWALK BOARDWALK REHABILITATION	S-17	

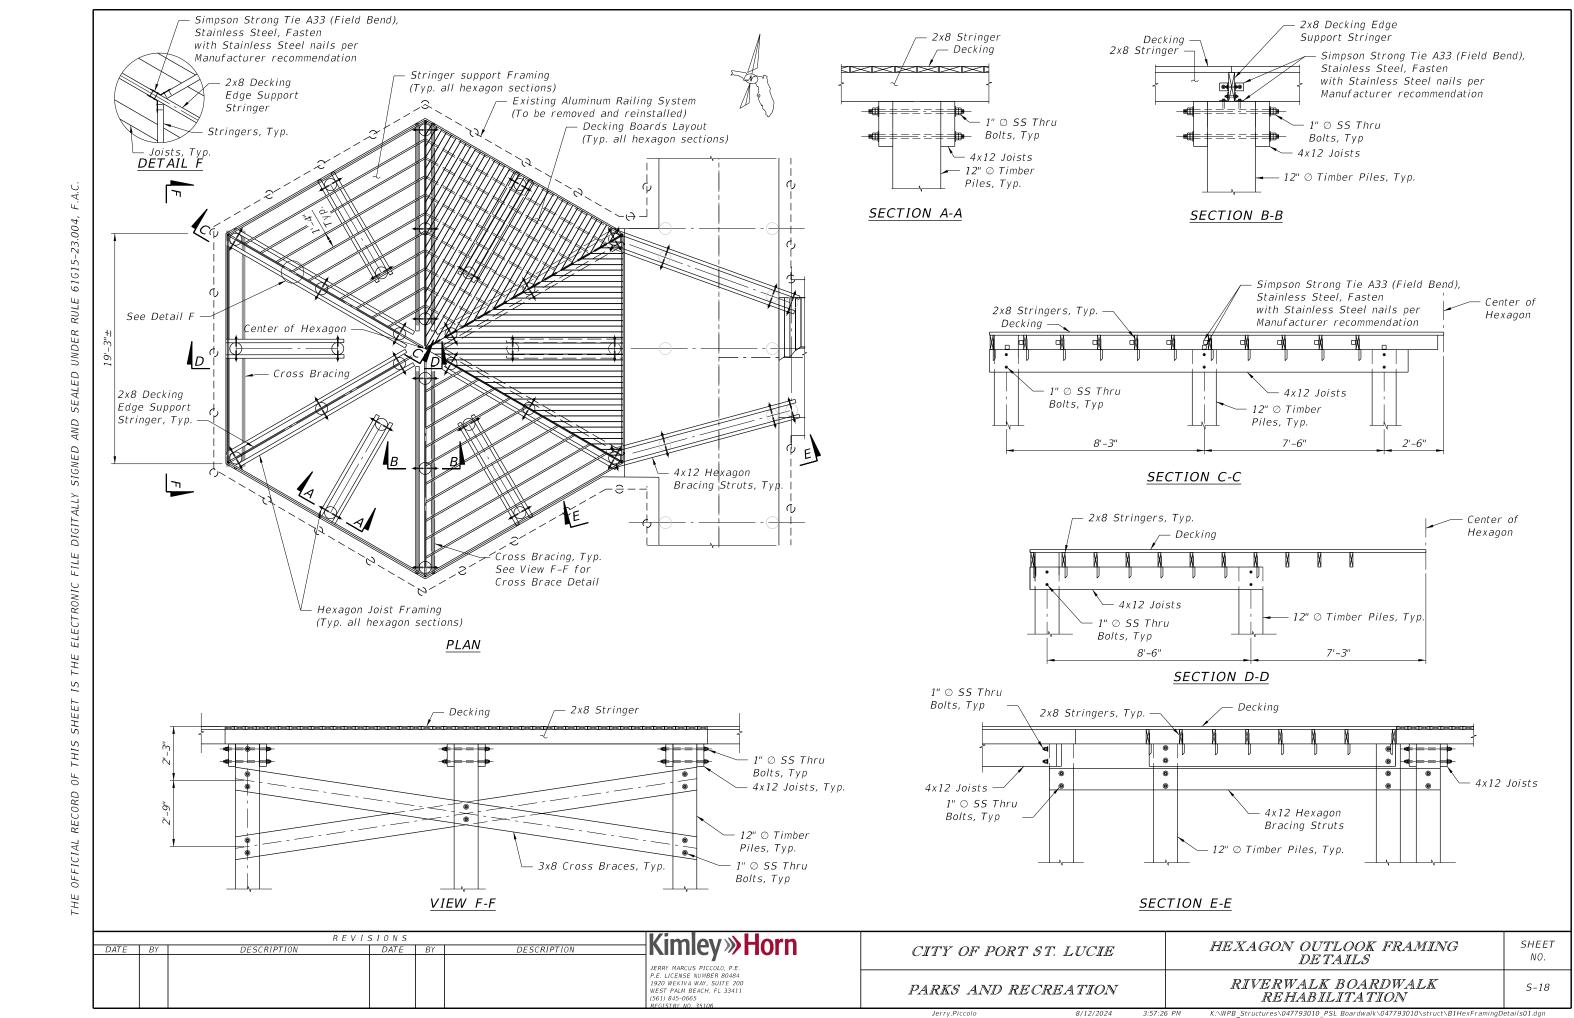

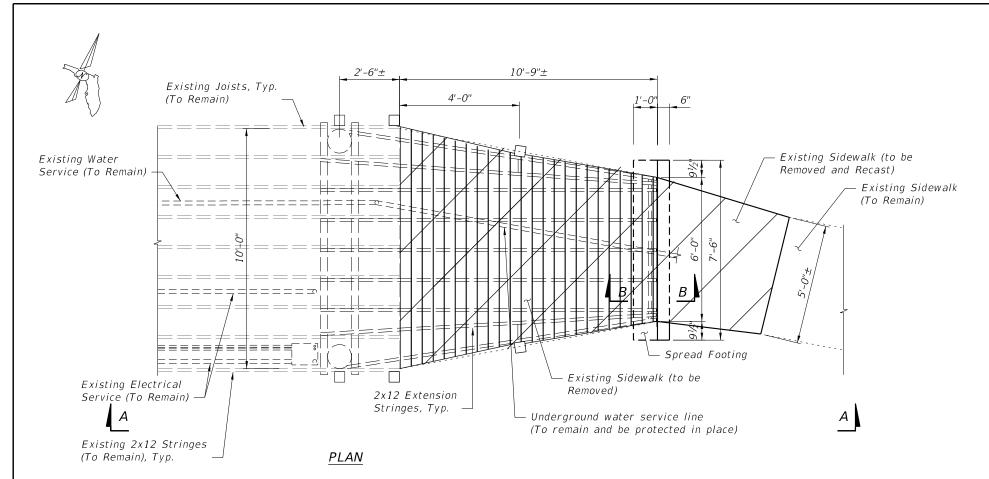

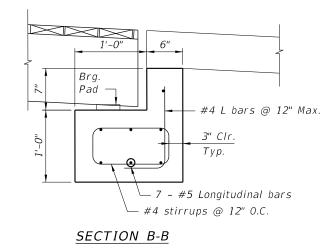


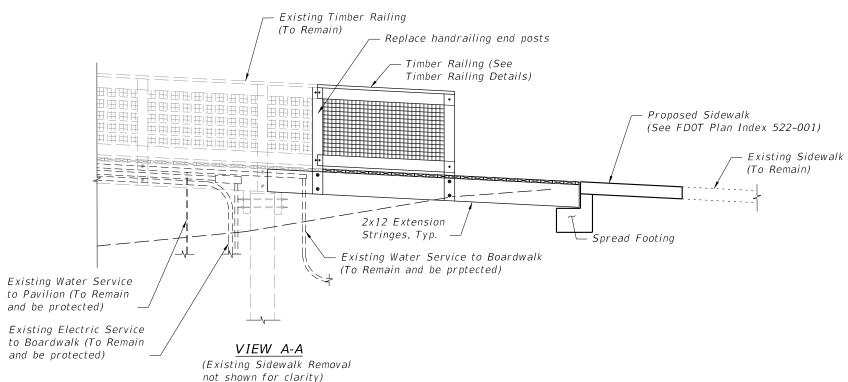

North Boardwalk Extension Notes;

- 1. Soils under the spread footing foundation shall be compacted to minimum 1500 psf.
- 2. ASTM A615 Grade 60 carbon steel per Specifications Section 931.
- 3. Spread footing concrete shall be Type NS concrete in accordance with FDOT Specification section 346. Minimum compressive strength of 3400 psi.
- 4. Bearing pad shall be  $\frac{1}{8}$ " thick x 4" wide neoprene pad.

DATE BY	R DESCRIPTION	DATE BY	DESCRIPTION	JERRY MARCUS PICCOLO, P.E. P.E. LICENSE NUMBER 80484 1920 WEKIVA WAY, SUITE 200 WEST PALM BEACH, FL 33411 (561) 845-0665 REGISTRY NO. 35106	CITY OF PORT ST. LUCIE	NORTH BOARDWALK EXTENSION DETAILS	SHEET NO.
					PARKS AND RECREATION	RIVERWALK BOARDWALK REHABILITATION	5-19
					Jerry.Piccolo 8/12/2024 3:57:28	B PM K:\WPB_Structures\047793010_PSL Boardwalk\047793010\struct\B1NorthBoardw	alkExt01.dgn

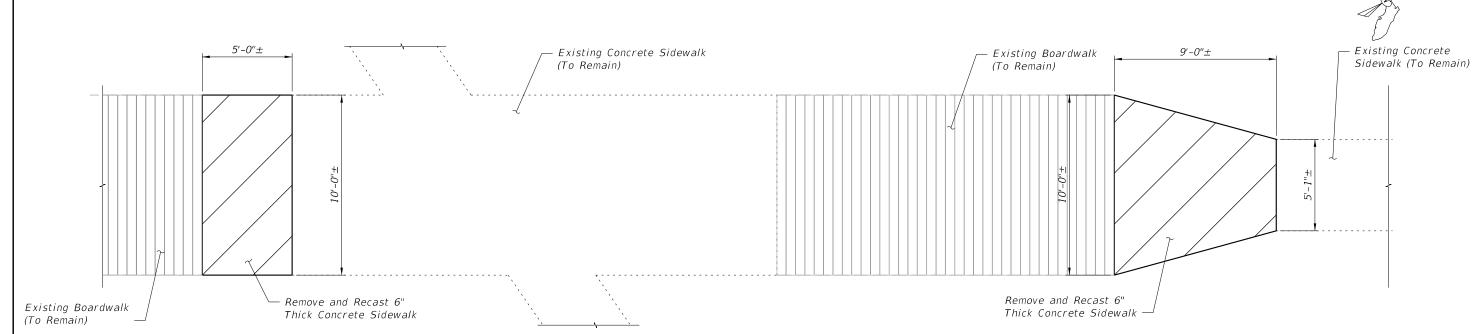


PLAN

- Approach Sidewalk Replacement Notes; 1. Remove all existing concrete and propoerly dispose of off site. 2. Sidewalks shall be rinstalled in accordance with FDOT Standard Specification Section 522 and FDOT Standard Plan Index 522-001.
- 3. Cast sidewalks to tie to existing grades on both longitudinal ends of the new sidewalk replacement sections.
  4. Top surface of sidewalk shall have a broomed finish similar to
- adjacent existing sidewalk to remain.

					Kir	nlev»Horn						
F	DATE	BY	DESCRIPTION	DATE	BY Di	ESCRIPTION	ARCUS PICCOLO, P.E.	CITY OF PORT ST. LUCIE			CONCRETE SIDEWALK DETAILS	
						P.E. LIC. 1920 WE	ENSE NUMBER 80484 KIVA WAY, SUITE 200 JUM BEACH, FL 33411 5-0665	PARKS AND REC	CREATION		RIVERWALK BOARDWALK REHABILITATION	S-20
			-				_	Jerry.Piccolo	8/12/2024	3:57:29 PM	K:\WPB_Structures\047793010_PSL_Boardwalk\047793010\struct\B1NorthSwlk	Approach01.dgn


# Direction of Stationing



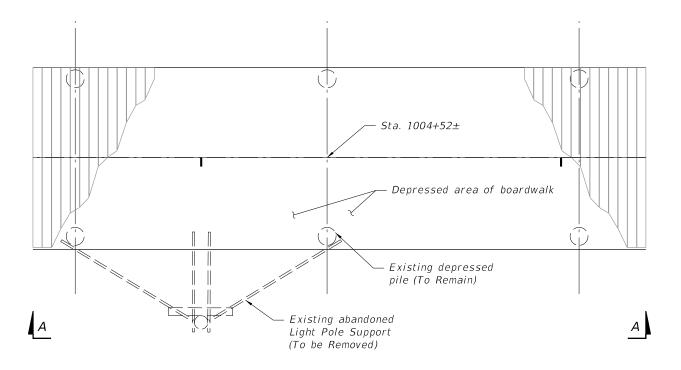



PILE 1004+52± PICTURE (LOOKING SOUTH)

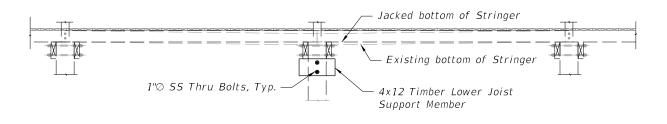


VIEW A-A

<u>PLAN</u>

#### Boardwalk Leveling Guidance


- Remove existing joist/pile through bolts and jack north ends of existing joints up to ensure level longitudinal grade along north edge of boardwalk.
   Drill new holes through the exist joist/pile and reinstall
- 3. Install lower joist support members tightly against bottom of existing jacked and level joists.

DATE BY	DESCRIPTION	EVISIONS  DATE BY	DESCRIPTION	Kimley » Horn  JERRY MARCUS PICCOLO, P.E.	CITY OF PORT ST. LUCIE	EAST/WEST BOARDWALK LEVELING DETAILS	SHEET NO.
				P.E. LICENSE NUMBER 80484 1920 WEKINA AWS, SUITE 200 WEST PALM BEACH, FL 33411 (561) 845-0665 REGISTRY, NO. 35106	PARKS AND RECREATION	RIVERWALK BOARDWALK REHABILITATION	5-21

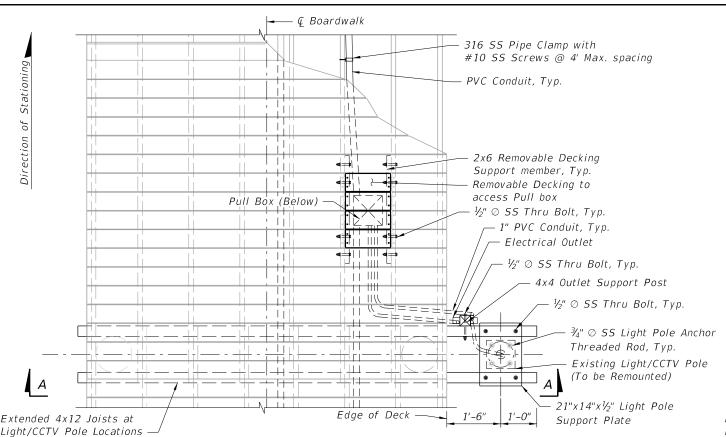

#### PLAN AT LIGHT/CCTV POLE LOCATIONS


(Railing and Railing Mounting not shown for clarity)

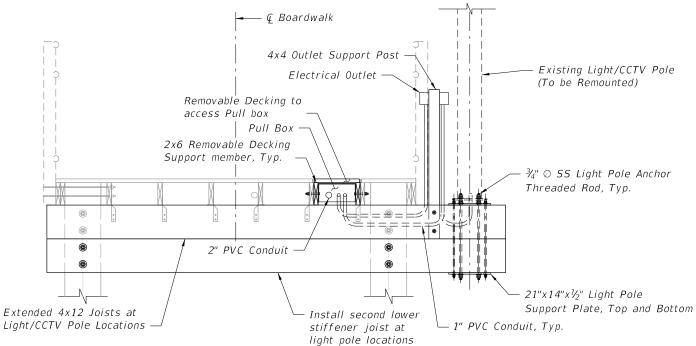

#### SECTION A-A


Lighting/CCTV Utility Notes:

1. Contractor shall salvage the existing light poles, fixtures, and CCTV equipement.

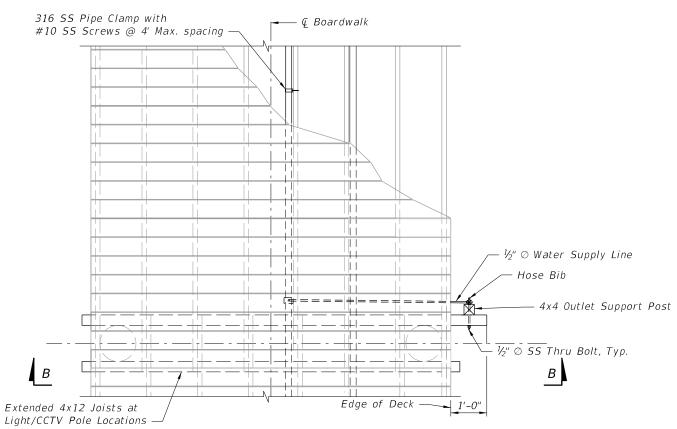

#### PLAN AT HOSE BIB LOCATIONS


(Railing and Railing Mounting not shown for clarity)

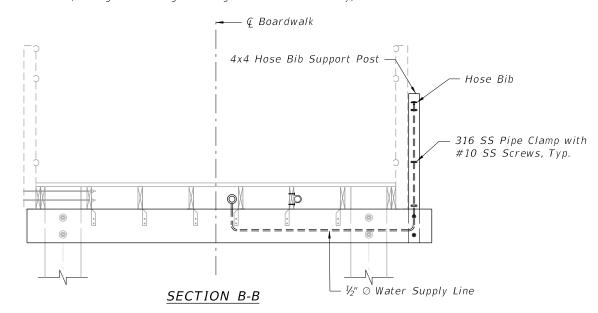



Water Utility Notes:

- 1. Match existing hose bib mounting height.
- 2. Hose bib shall consist of corrosion resistant materials and be tamper resistiant similar to existing hose bibs.
- 3. Hose bib supply line shall connect into 2" HDPE longitudinal line via a tap Saddle Tee. Tap saddle tee shall be marine grade and consist of corrosion resistant materials and 316 SS hardware.


DATE BY	DESCRIPTION F	REVISIONS DATE BY	DESCRIPTION	Kimley»Horn	CITY OF PORT ST. LUCIE	BOARDWALK UTILITY DETAILS (1 OF 2)	SHEET NO.
				JERRY MARCUS PICCOLO, P.E. P.E. LICENSE NUMBER 80484 1920 WEKIYA WAY, SUITE 200 WEST PALM BEACH, FL 33411 (561) 845-0665 BEGISTEY, NO. 38106	PARKS AND RECREATION	RIVERWALK BOARDWALK REHABILITATION	5-22

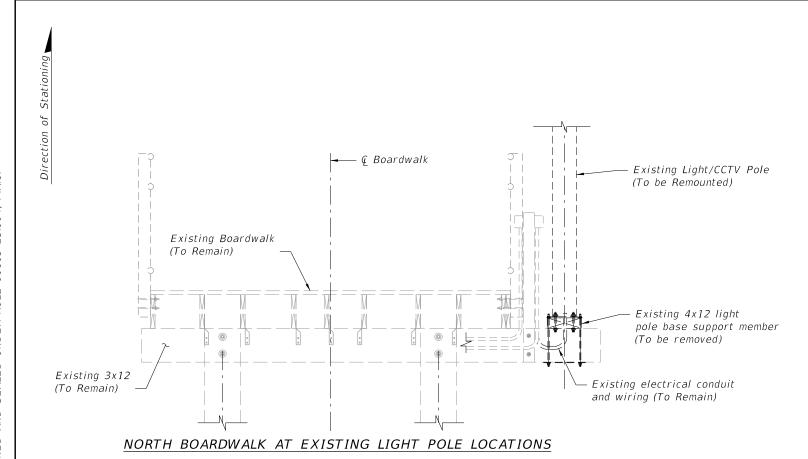

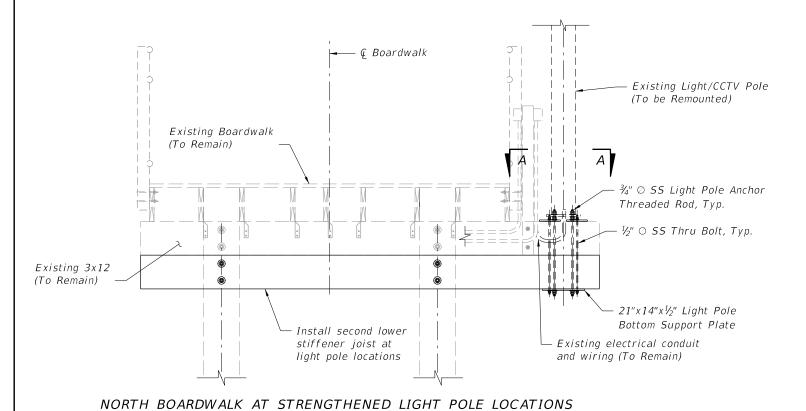

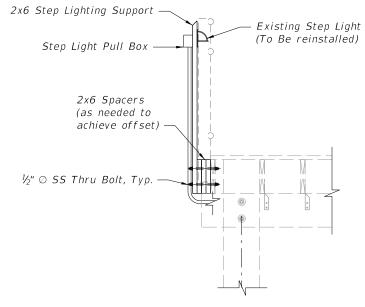

STEP LIGHT SUPPORT DETAIL

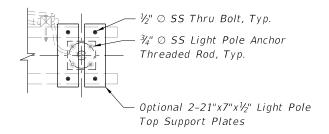


SECTION A-A

DATE	ВҮ	R E V I DESCRIPTION	S I O N S DATE	BY DESCRIPTION	Kimley » Horn  JERRY MARCUS PICCOLO, P.E.	CITY OF PORT ST. LUCIE	BOARDWALK UTILITY DETAILS (2 OF 2)	SHEET NO.
					P.E. LICENSE NUMBER 80484 1920 WEKIVA WAY, SUITE 200 WEST PALM BEACH, FL 33411 (561) 845-0665 REGISTRY, NO. 35106	PARKS AND RECREATION	RIVERWALK BOARDWALK REHABILITATION	5-23
		_	•			Jerry.Piccolo 8/12/2024 3:57	:34 PM K:\WPB Structures\047793010 PSL Boardwalk\047793010\struct\B1UtilityDetails	02.dgn

. REGISTRY NO 35106

REHABILITATION


8/12/2024

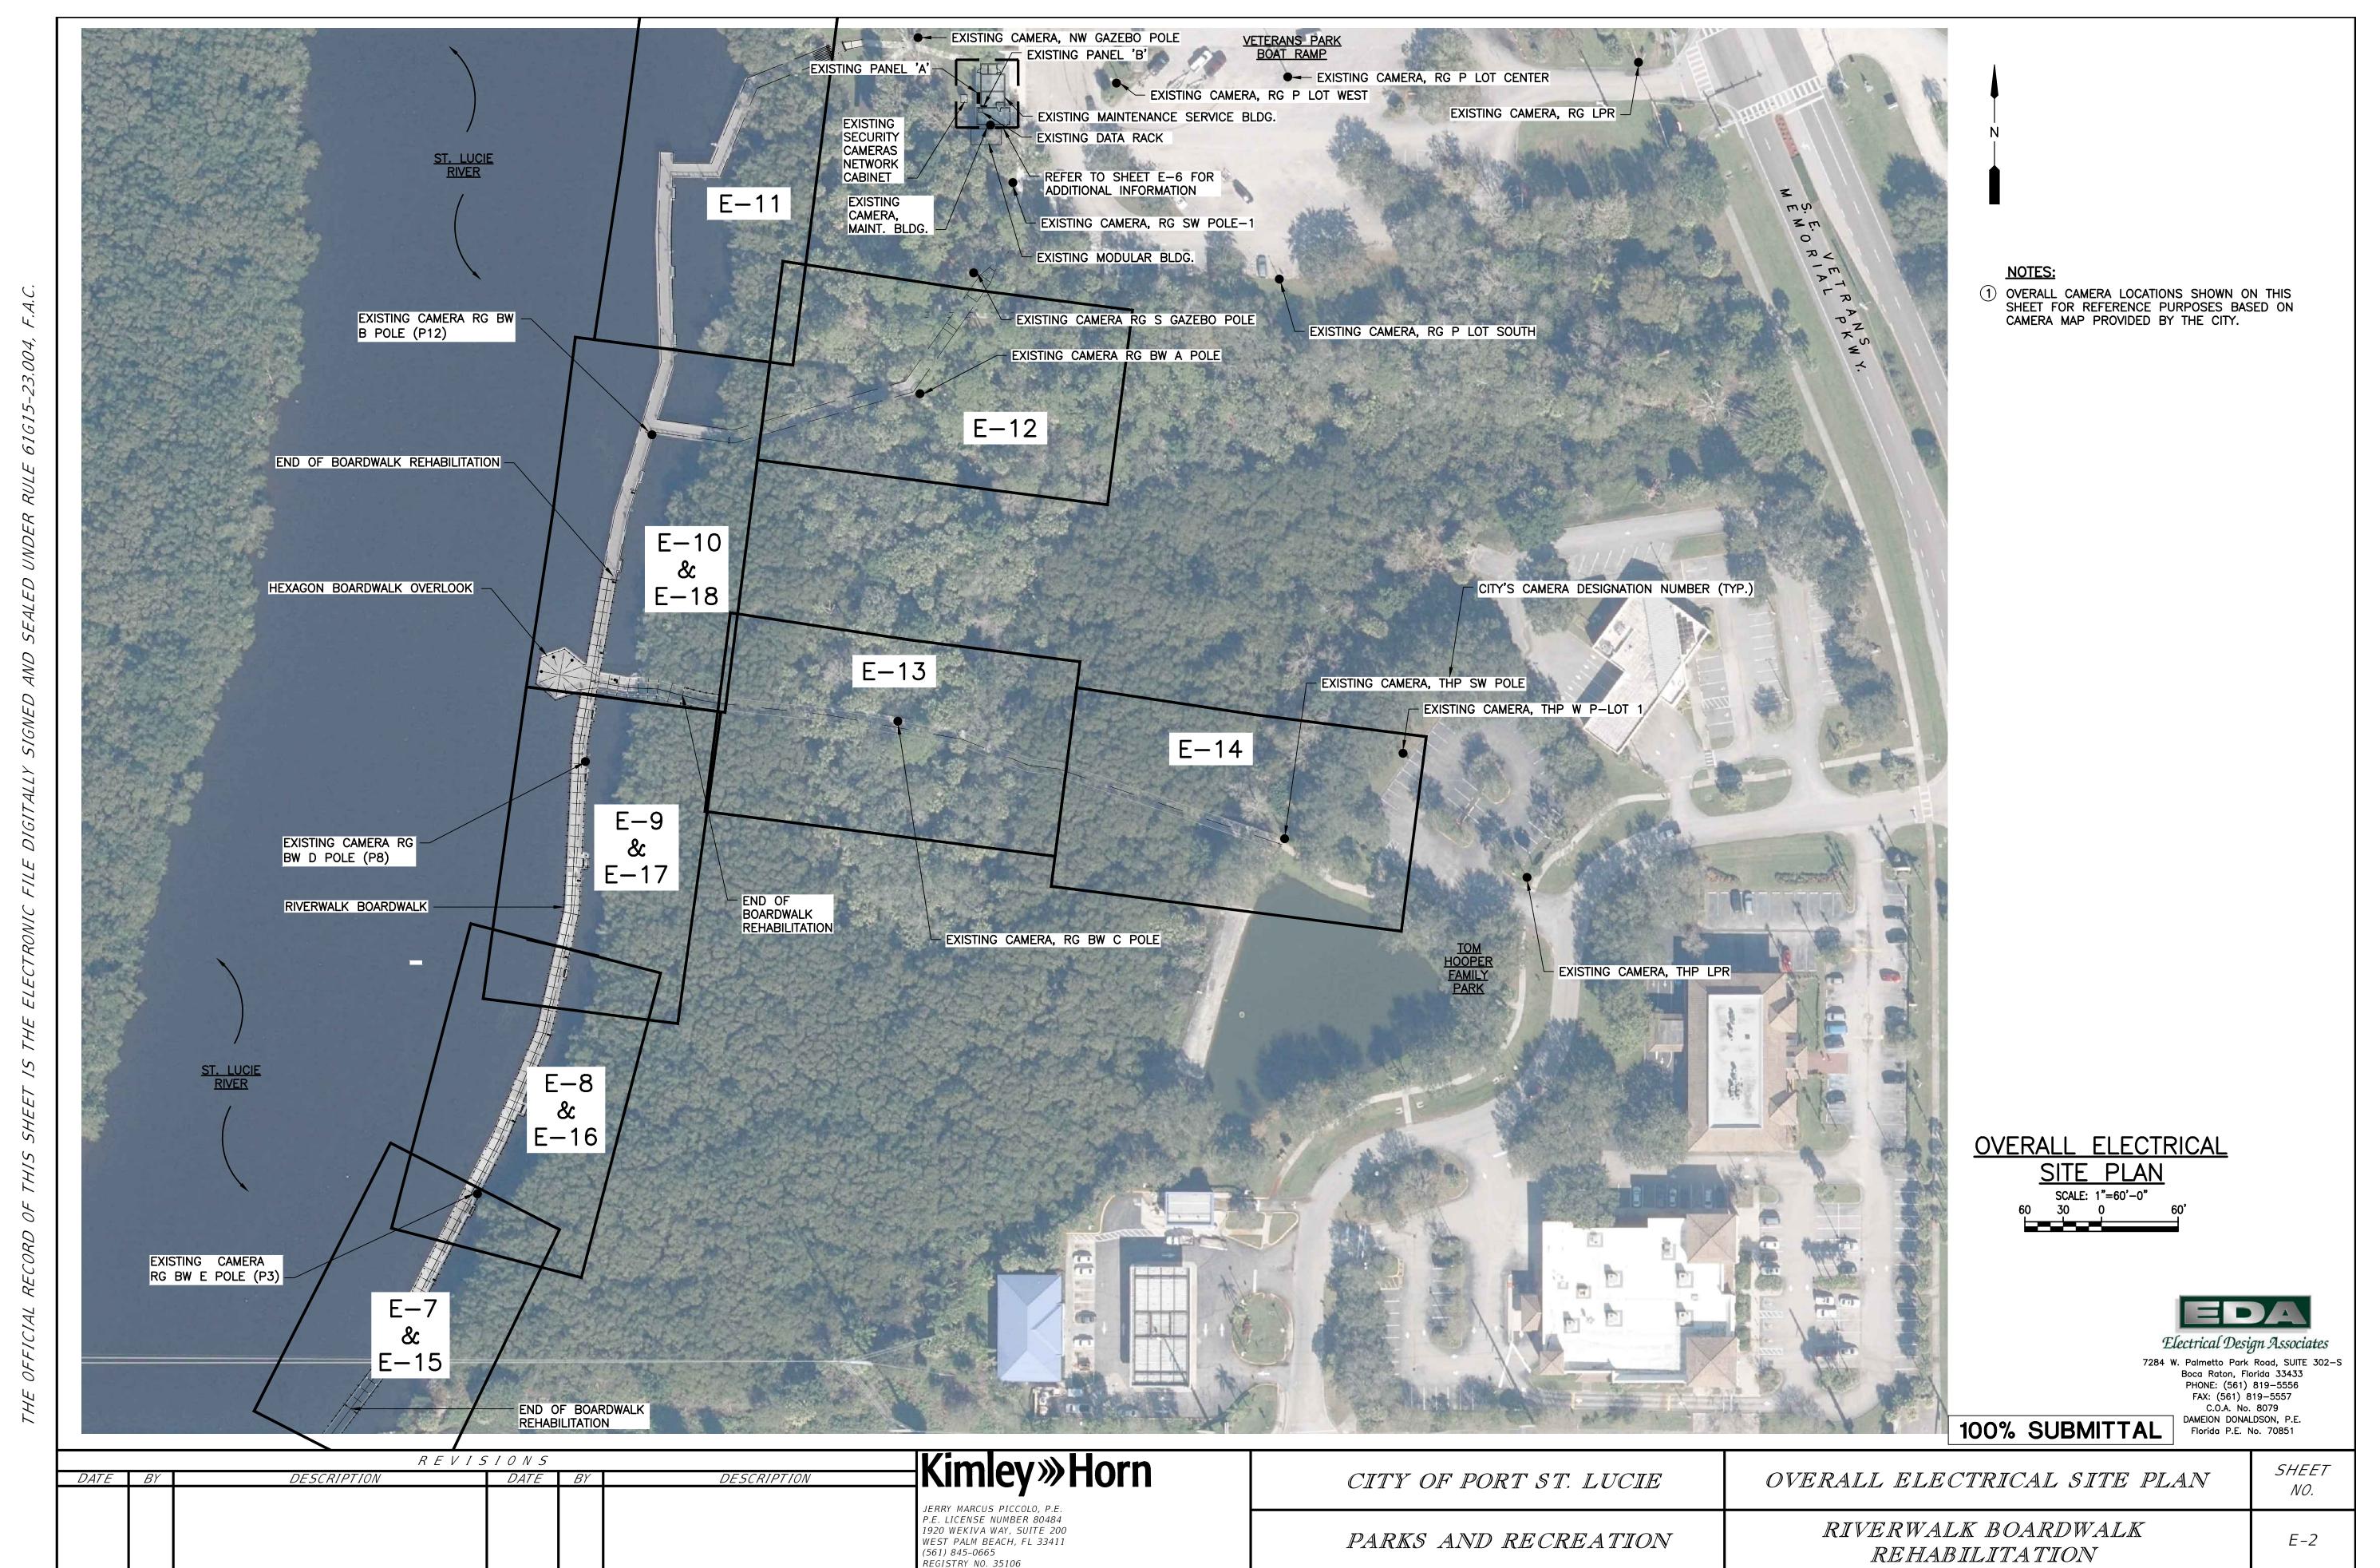

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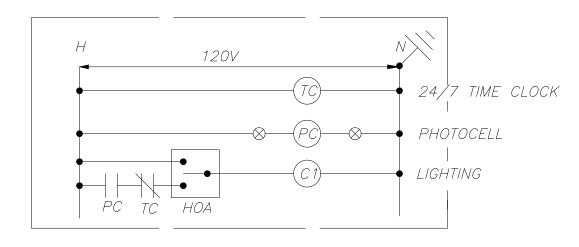
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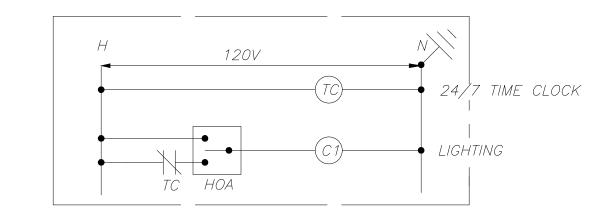


# EXISTING SINGLE LINE DIAGRAM (MAINTENANCE SERVICE BLDG.) SCALE: N.T.S.

PANI	<u>-</u> L:	Α						BUS:	225 /	4MP		VOLT: 120/.	240-1	ø-3W			
LOCA	4 <i>TION:</i>	EXTE	RIOR	WALL (	WEST OF MAINT. SERVICE E	RLDG.)		MAINS:	225A,	2P ME	3	REMARKS: —					
MOU	NTING	: SUR	FACE			POLES: 30						A.I.C. SYMI	M: 10,C	000			
AMDS	DOLE.	WIRE	CND	COND.	LOAD SERVED	BUS	KVA	BUS	S	BUS	KVA	LOAD SERVED	WIRE	GND.	COND	POLE	
AIVII J	1 OLL	VV//\_	GIVD.	COIVD.	LOAD SLIVED	Α	В	Α	В	Α	В	LOAD SERVED	VV//\L	GIVD.	COND.	, r OLL	AIVII
150	2	_	_	_	PANEL B	9.60				_		_	_	_	_	_	_
_	_	_	_	_	_		9.60				_	_	_	_	_	_	_
20	1	_	_	_	BOARDWALK LIGHTING	0.32		1	- 2	0.72		GFCI RECEPTACLE	_	_	_	1	20
20	1	_	_	_	BOARDWALK LIGHTING		0.62	3	<del>-</del> 4		0.36	NORTH CAMERA	_	_	_	1	20
20	1	_	_	_	BOARDWALK LIGHTING	0.10		5	<del> </del> 6	0.72		GFCI RECEPTACLE	_	_	_	1	20
20	1	_	_	_	BOARDWALK LIGHTING		0.07	7	- 8		0.72	GFCI RECEPTACLE	_	_	_	1	20
20	1	_	_	_	BOARDWALK LIGHTING	0.12		9	10	0.72		GFCI RECEPTACLE	_	_	_	1	20
50	1	_	_	_	BOARDWALK LIGHTING		0.10	11	<del>-</del> 12		0.90	GFCI RECEPTACLE	_	_	_	1	20
20	1	_	_	_	LIGHTING CONTACTOR T/C	0.36		13-	14	0.90		GFCI RECEPTACLE	_	_	_	1	20
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20	1	_	_	_	NORTH CAMERAS	0.36		17-	18	0.36		RECEPT. CONTACTOR T/C	_	_	_	1	20
20	1	_	_	_	PARKING LOT LIGHTS		1.00	19	<del>-</del> 20		_	SPARE	_	_	_	1	20
20	1	_	_	_	PARKING LOT LIGHTS	1.00		21-	22	0.36		EASTY ENTRY POLE RECEPT.	_	_	_	1	20
20	1	_	_	_	IRRIGATION PUMP		1.00	23	<del>-</del> 24		_	SPARE	_	_	_	1	20
60	2	_	_	_	FIBER OPTIC CABINET	2.00		25-	26	0.10		SPD	_	_	_	2	30
_	_	_	_	_	FIBER OPTIC CABINET		2.00	27	<del>-</del> 28		0.10	_	_	_	_	_	_
_	_	_	_	_	SPACE	_		29	30	_		SPACE	_	_	_	_	_
TOTA	L (PHA	4 <i>SE):</i>				13.86	14.75			3.88	2.98	NOTES:					
TOTA	L KVA:	•						35.4	7		•	_					
TOTA	L AMP	S:						147.7	79								
TOTA	L DEM.	'AND A	MPS:					147.7	 7.9								

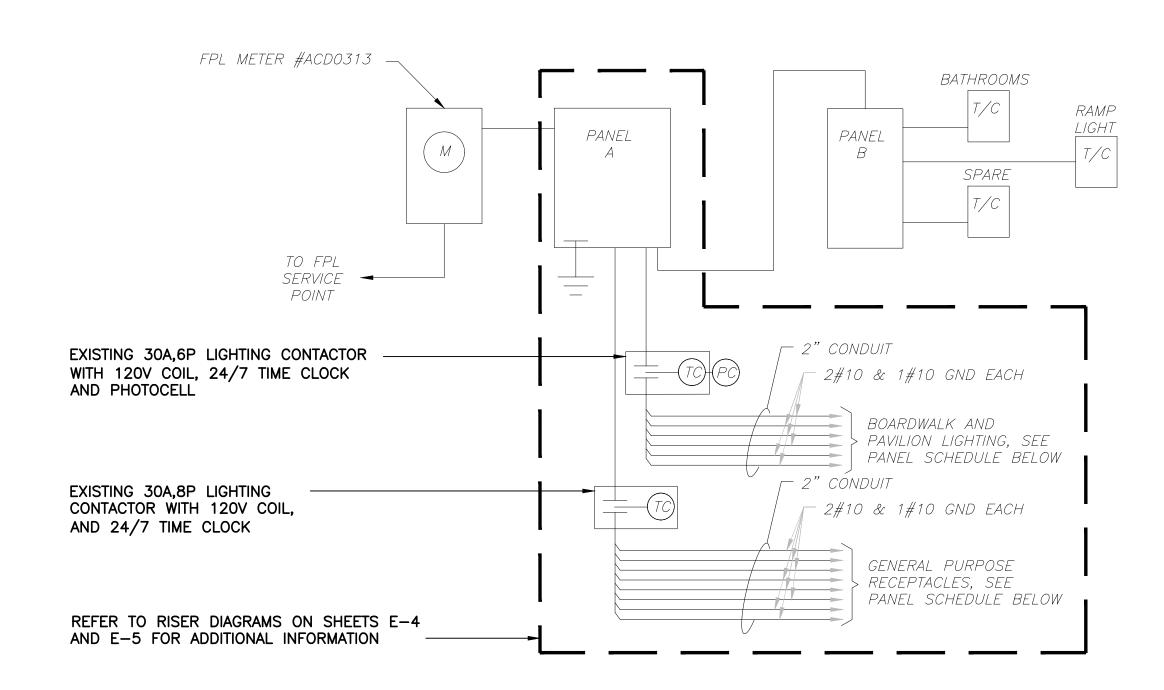

# EXISTING LIGHTING CONTACTOR WIRING DIAGRAM N.T.S.




# EXISTING RECEPTACLE CONTACTOR WIRING DIAGRAM N.T.S.

Tlectrical Design Associates

7284 W. Palmetto Park Road, SUITE 302-S
Boca Raton, Florida 33433
PHONE: (561) 819-5556
FAX: (561) 819-5557
C.O.A. No. 8079
DAMEION DONALDSON, P.E.
Florida P.E. No. 70851


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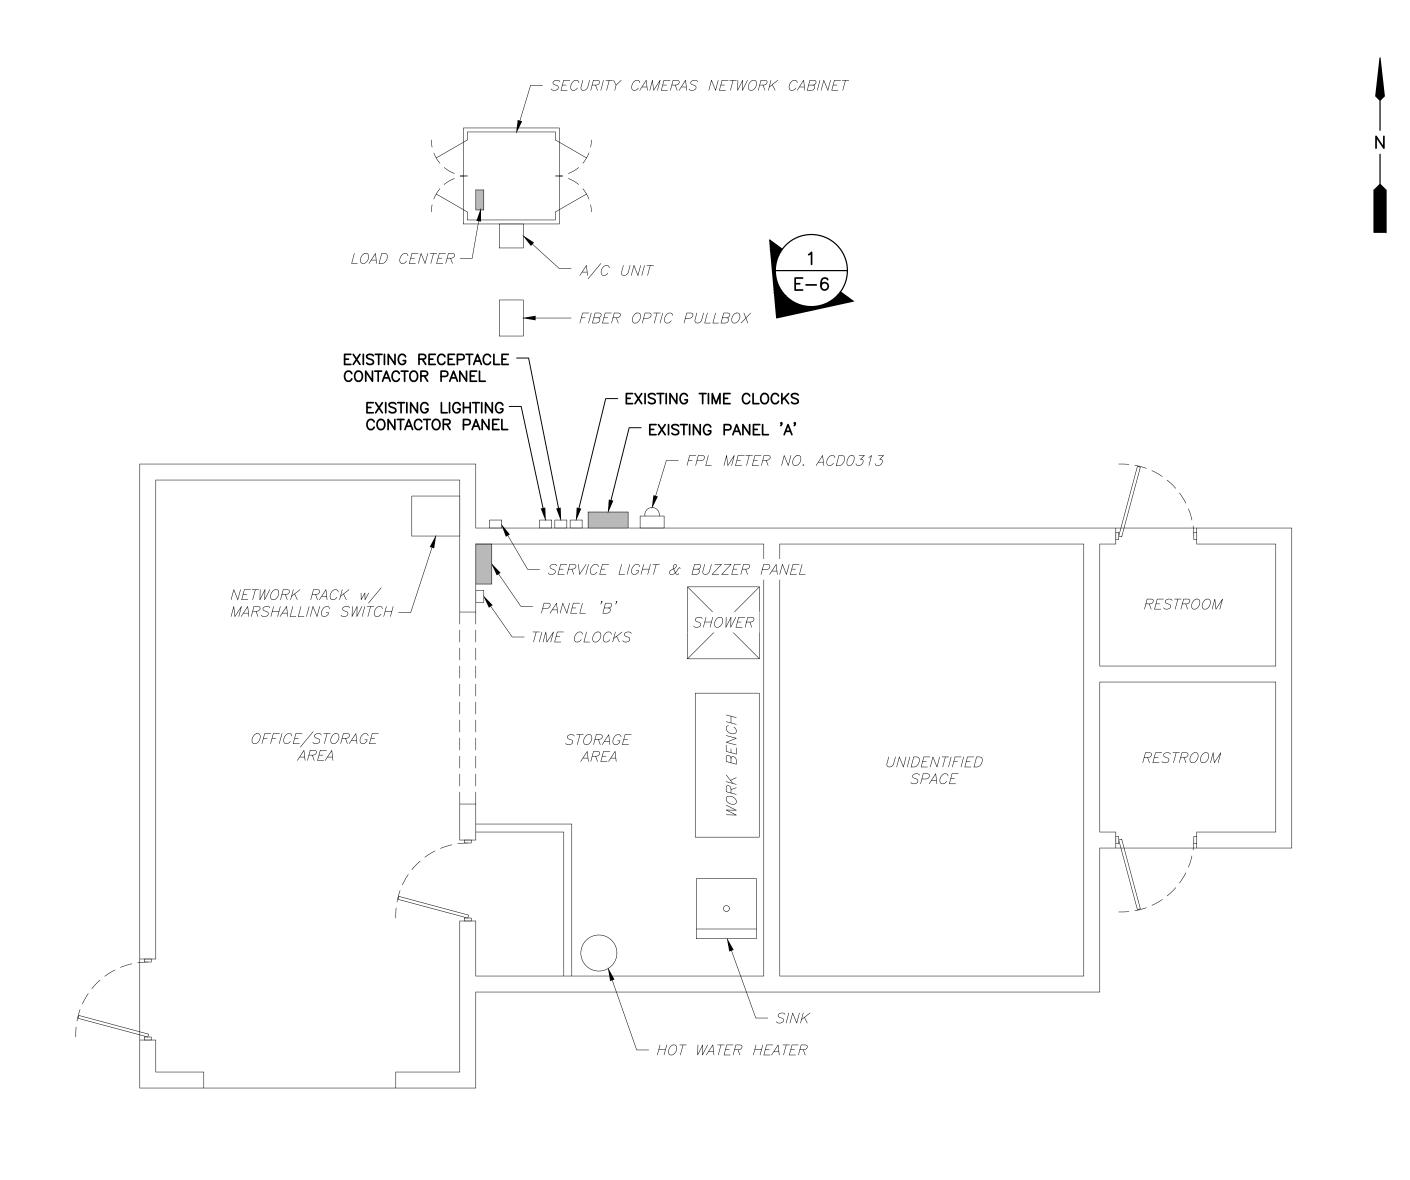
DATE BY	REVISION	ONS  DATE BY	DESCRIPTION	- Kimley» Horn	CITY OF PORT ST. LUCIE	SINGLE LINE DIAGRAM & PANEL SCHEDULE	SHEET NO.
				JERRY MARCUS PICCOLO, P.E. P.E. LICENSE NUMBER 80484 1920 WEKIVA WAY, SUITE 200 WEST PALM BEACH, FL 33411 (561) 845-0665 REGISTRY NO. 35106	PARKS AND RECREATION	RIVERWALK BOARDWALK REHABILITATION	E-3

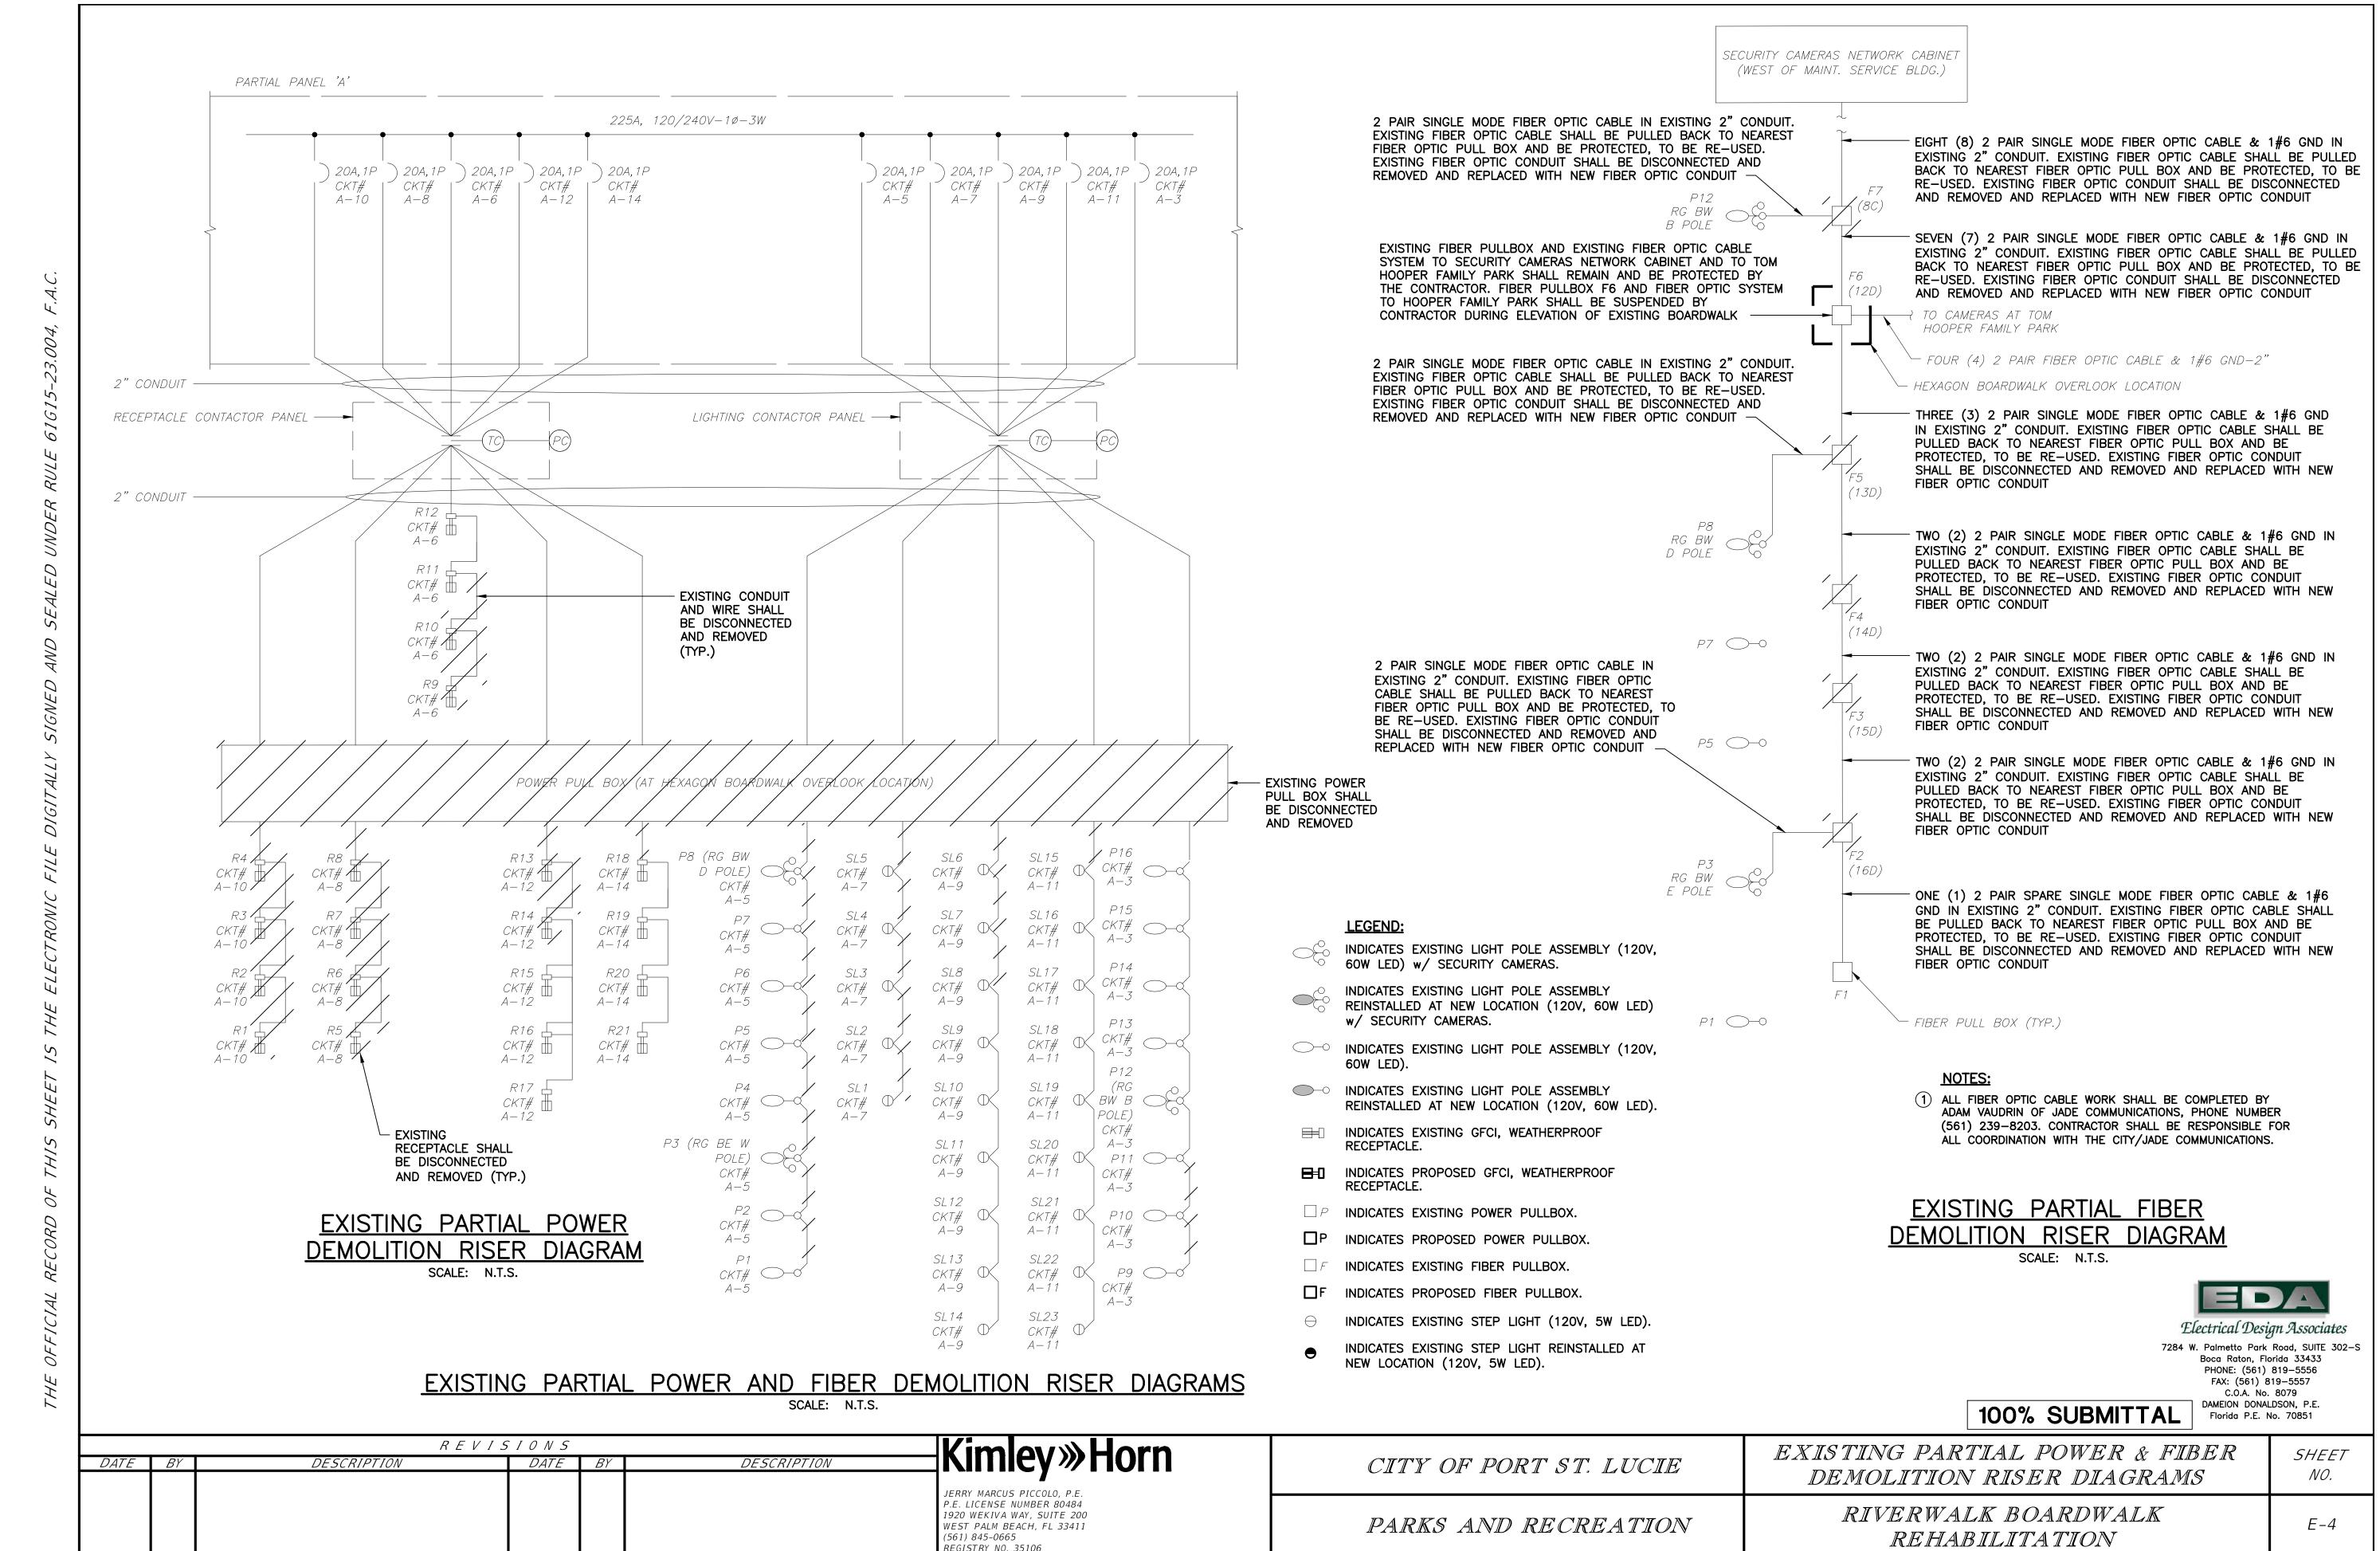


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EXISTING ELECTRICAL EQUIPMENT

SCALE: N.T.S.



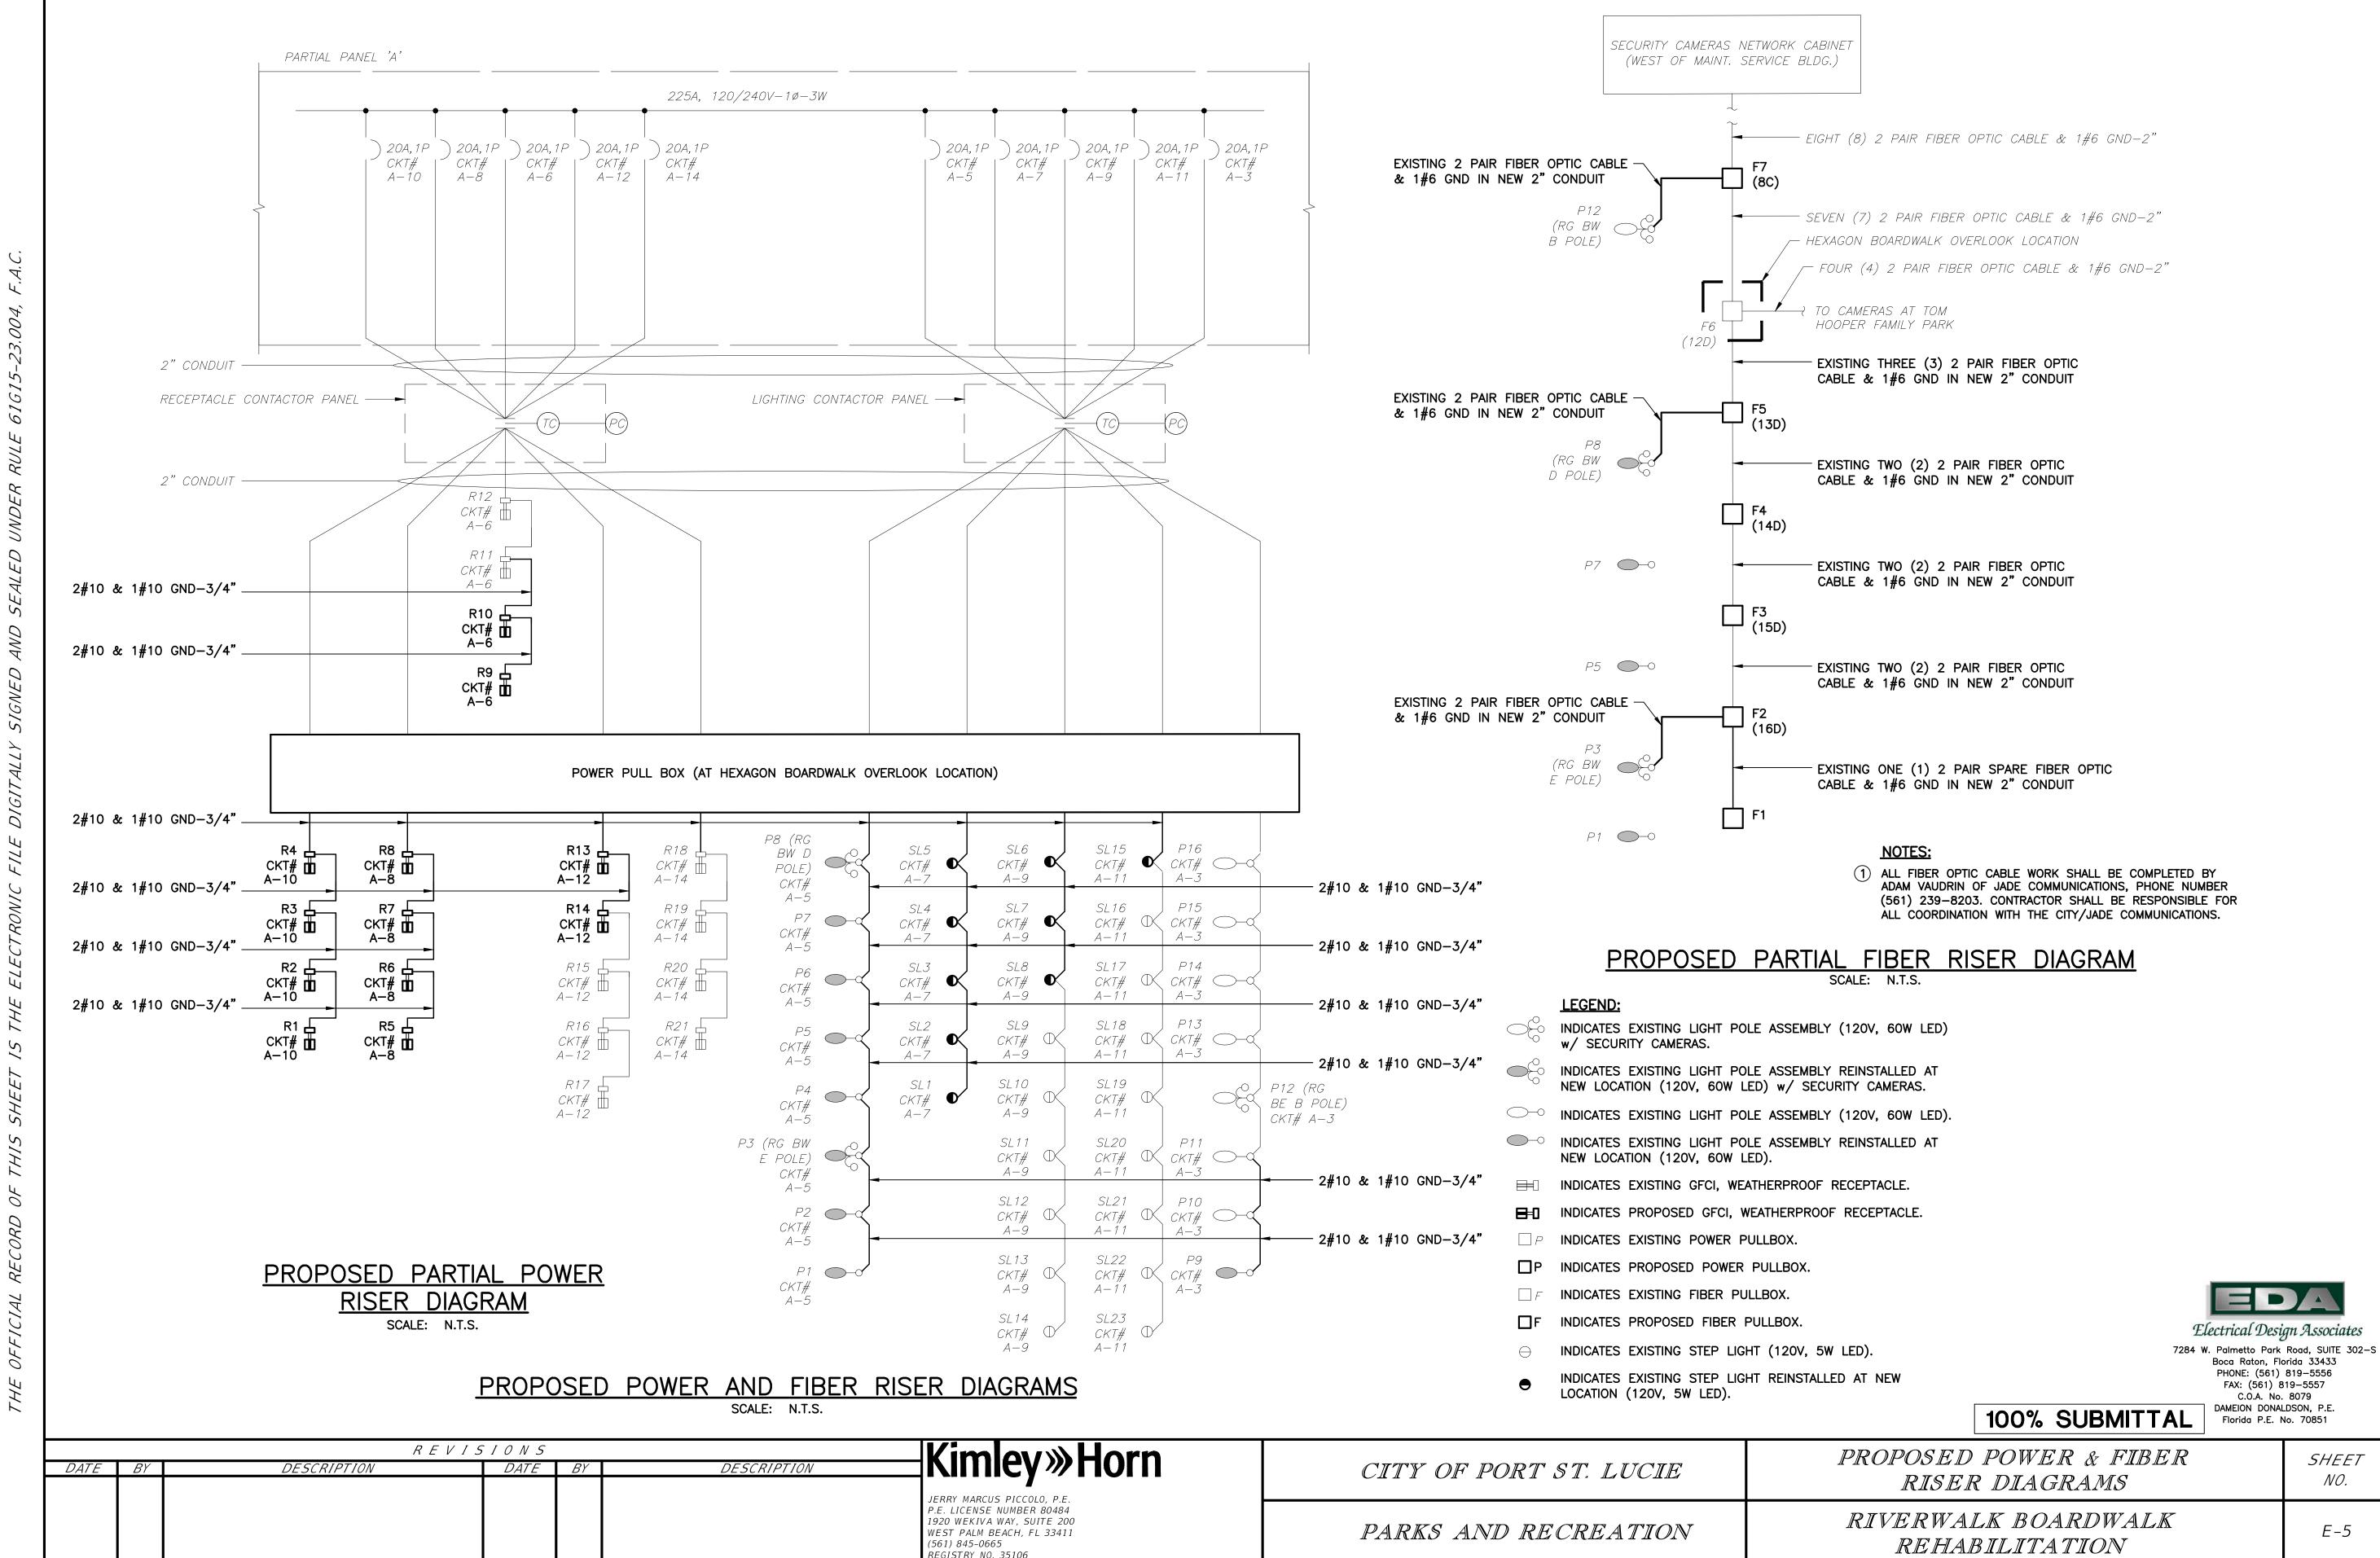


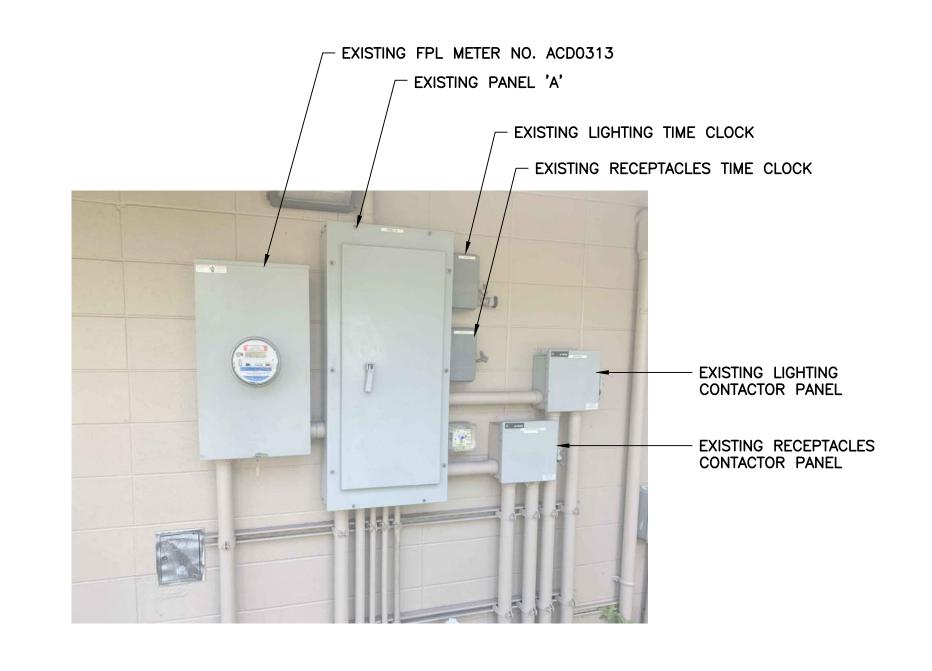Electrical Design Associates 7284 W. Palmetto Park Road, SUITE 302-S
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FAX: (561) 819-5557
C.O.A. No. 8079
DAMEION DONALDSON, P.E.
Florida P.E. No. 70851

100% SUBMITTAL

NTENANCE SERVICE ECTRICAL PLAN	SHEET NO.	

DATE BY	R E V I S I DESCRIPTION	DATE BY	DESCRIPTION	-Kimley» Horn  JERRY MARCUS PICCOLO, P.E.	CITY OF PORT ST. LUCIE	EXISTING MAINTENANCE SERVICE BLDG. ELECTRICAL PLAN	SHEET NO.
				P.E. LICENSE NUMBER 80484 1920 WEKIVA WAY, SUITE 200 WEST PALM BEACH, FL 33411 (561) 845-0665 REGISTRY NO. 35106	PARKS AND RECREATION	RIVERWALK BOARDWALK REHABILITATION	E-6

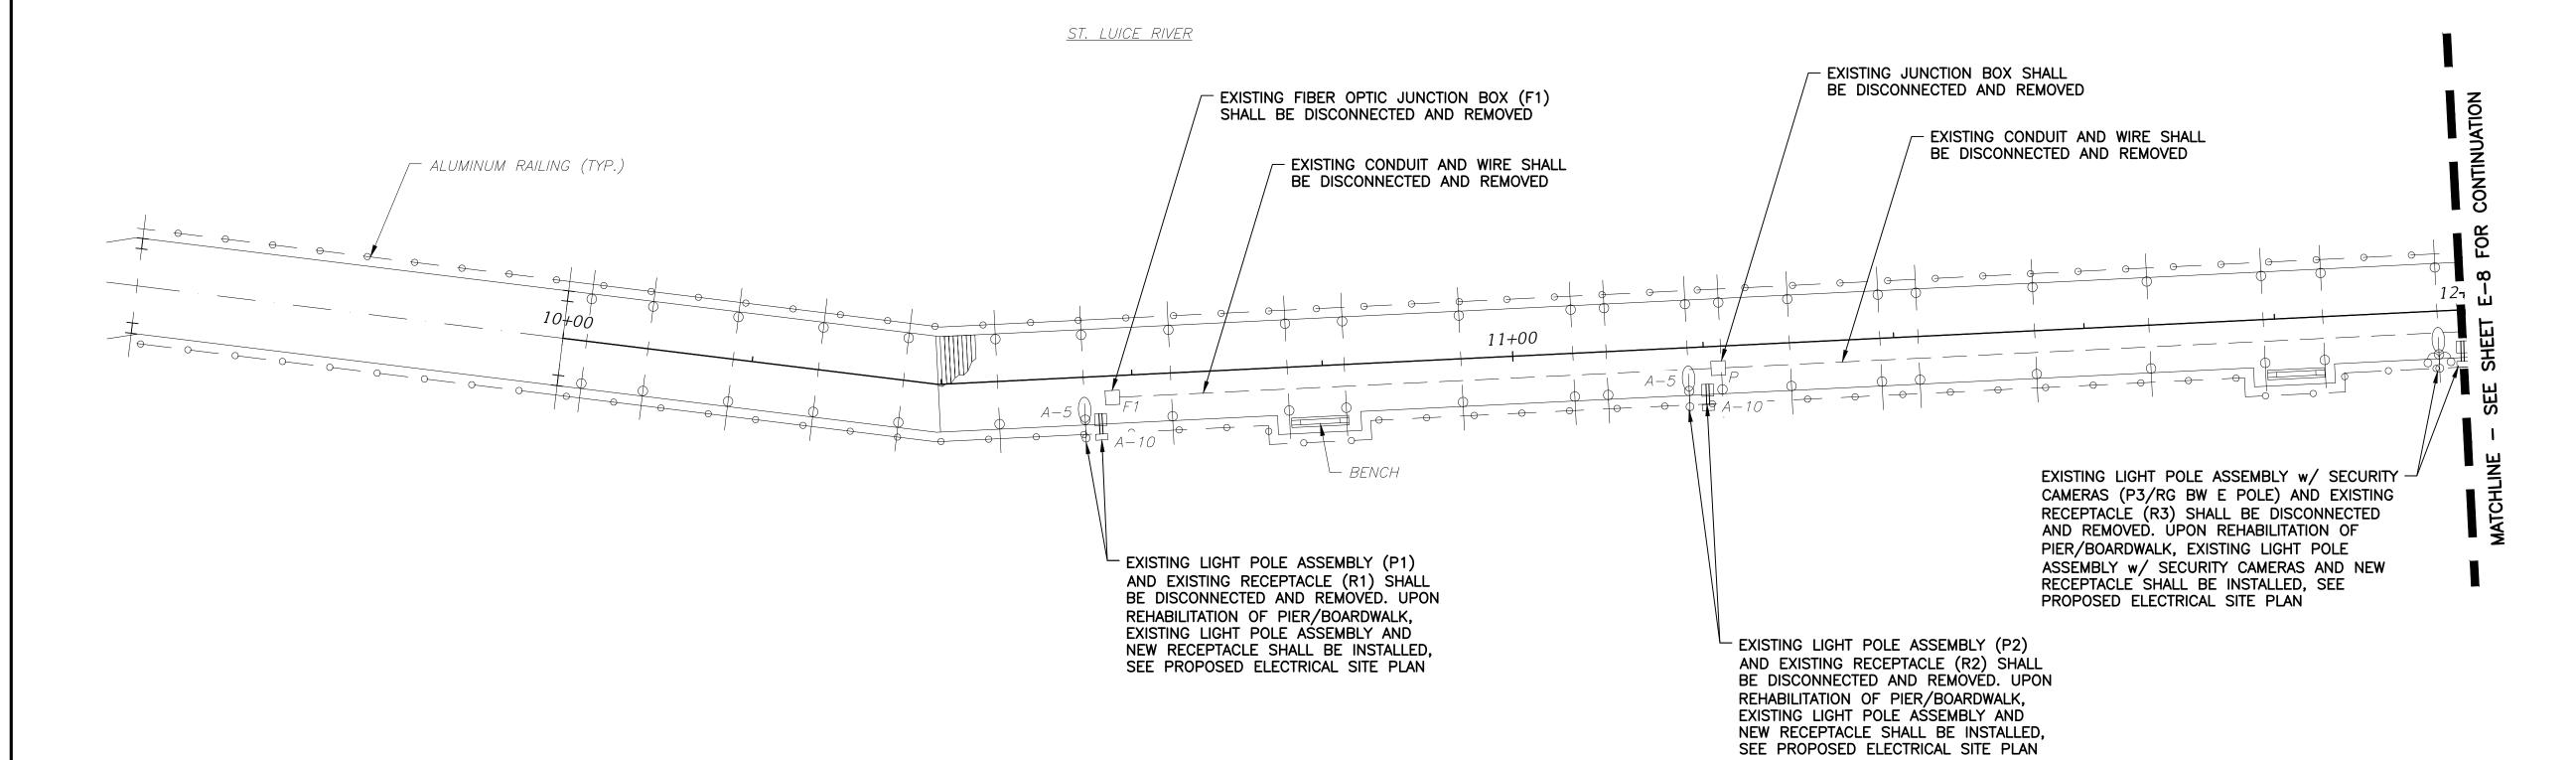

# ELECTRICAL DEMOLITION PLAN - 1

SCALE: 1"=10'-0"
10 5 0 10'

## **LEGEND:**

- indicates existing light pole assembly (120V, 60W LED) w/ SECURITY CAMERAS.
- INDICATES EXISTING LIGHT POLE ASSEMBLY REINSTALLED AT NEW LOCATION (120V, 60W LED) w/ SECURITY CAMERAS.
- INDICATES EXISTING LIGHT POLE ASSEMBLY (120V, 60W LED).
- INDICATES EXISTING LIGHT POLE ASSEMBLY REINSTALLED AT NEW LOCATION (120V, 60W LED).
- INDICATES EXISTING GFCI, WEATHERPROOF RECEPTACLE.
- INDICATES PROPOSED GFCI, WEATHERPROOF RECEPTACLE.
- $\square$  P INDICATES EXISTING POWER PULLBOX.
- P INDICATES PROPOSED POWER PULLBOX.
- $\square$   $\digamma$  INDICATES EXISTING FIBER PULLBOX.
- F INDICATES PROPOSED FIBER PULLBOX.
- $\ominus$  INDICATES EXISTING STEP LIGHT (120V, 5W LED).
- INDICATES EXISTING STEP LIGHT REINSTALLED AT NEW LOCATION (120V, 5W LED).

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DAMEION DONALDSON, P.E.
Florida P.E. No. 70851

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DATE BY	R E V I S DESCRIPTION	S I O N S DATE	ВҮ	DESCRIPTION	-Kimley» Horn  JERRY MARCUS PICCOLO, P.E.	CITY OF PORT ST. LUCIE	ELECTRICAL DEMOLITION PLAN - 1	SHEET NO.
					P.E. LICENSE NUMBER 80484 1920 WEKIVA WAY, SUITE 200 WEST PALM BEACH, FL 33411 (561) 845-0665 REGISTRY NO. 35106	PARKS AND RECREATION	RIVERWALK BOARDWALK REHABILITATION	E-7

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1920 WEKIVA WAY, SUITE 200

WEST PALM BEACH, FL 33411

(561) 845-0665 REGISTRY NO. 35106

Rmeeks 8/12/2024

PARKS AND RECREATION


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E-8

RIVERWALK BOARDWALK


REHABILITATION



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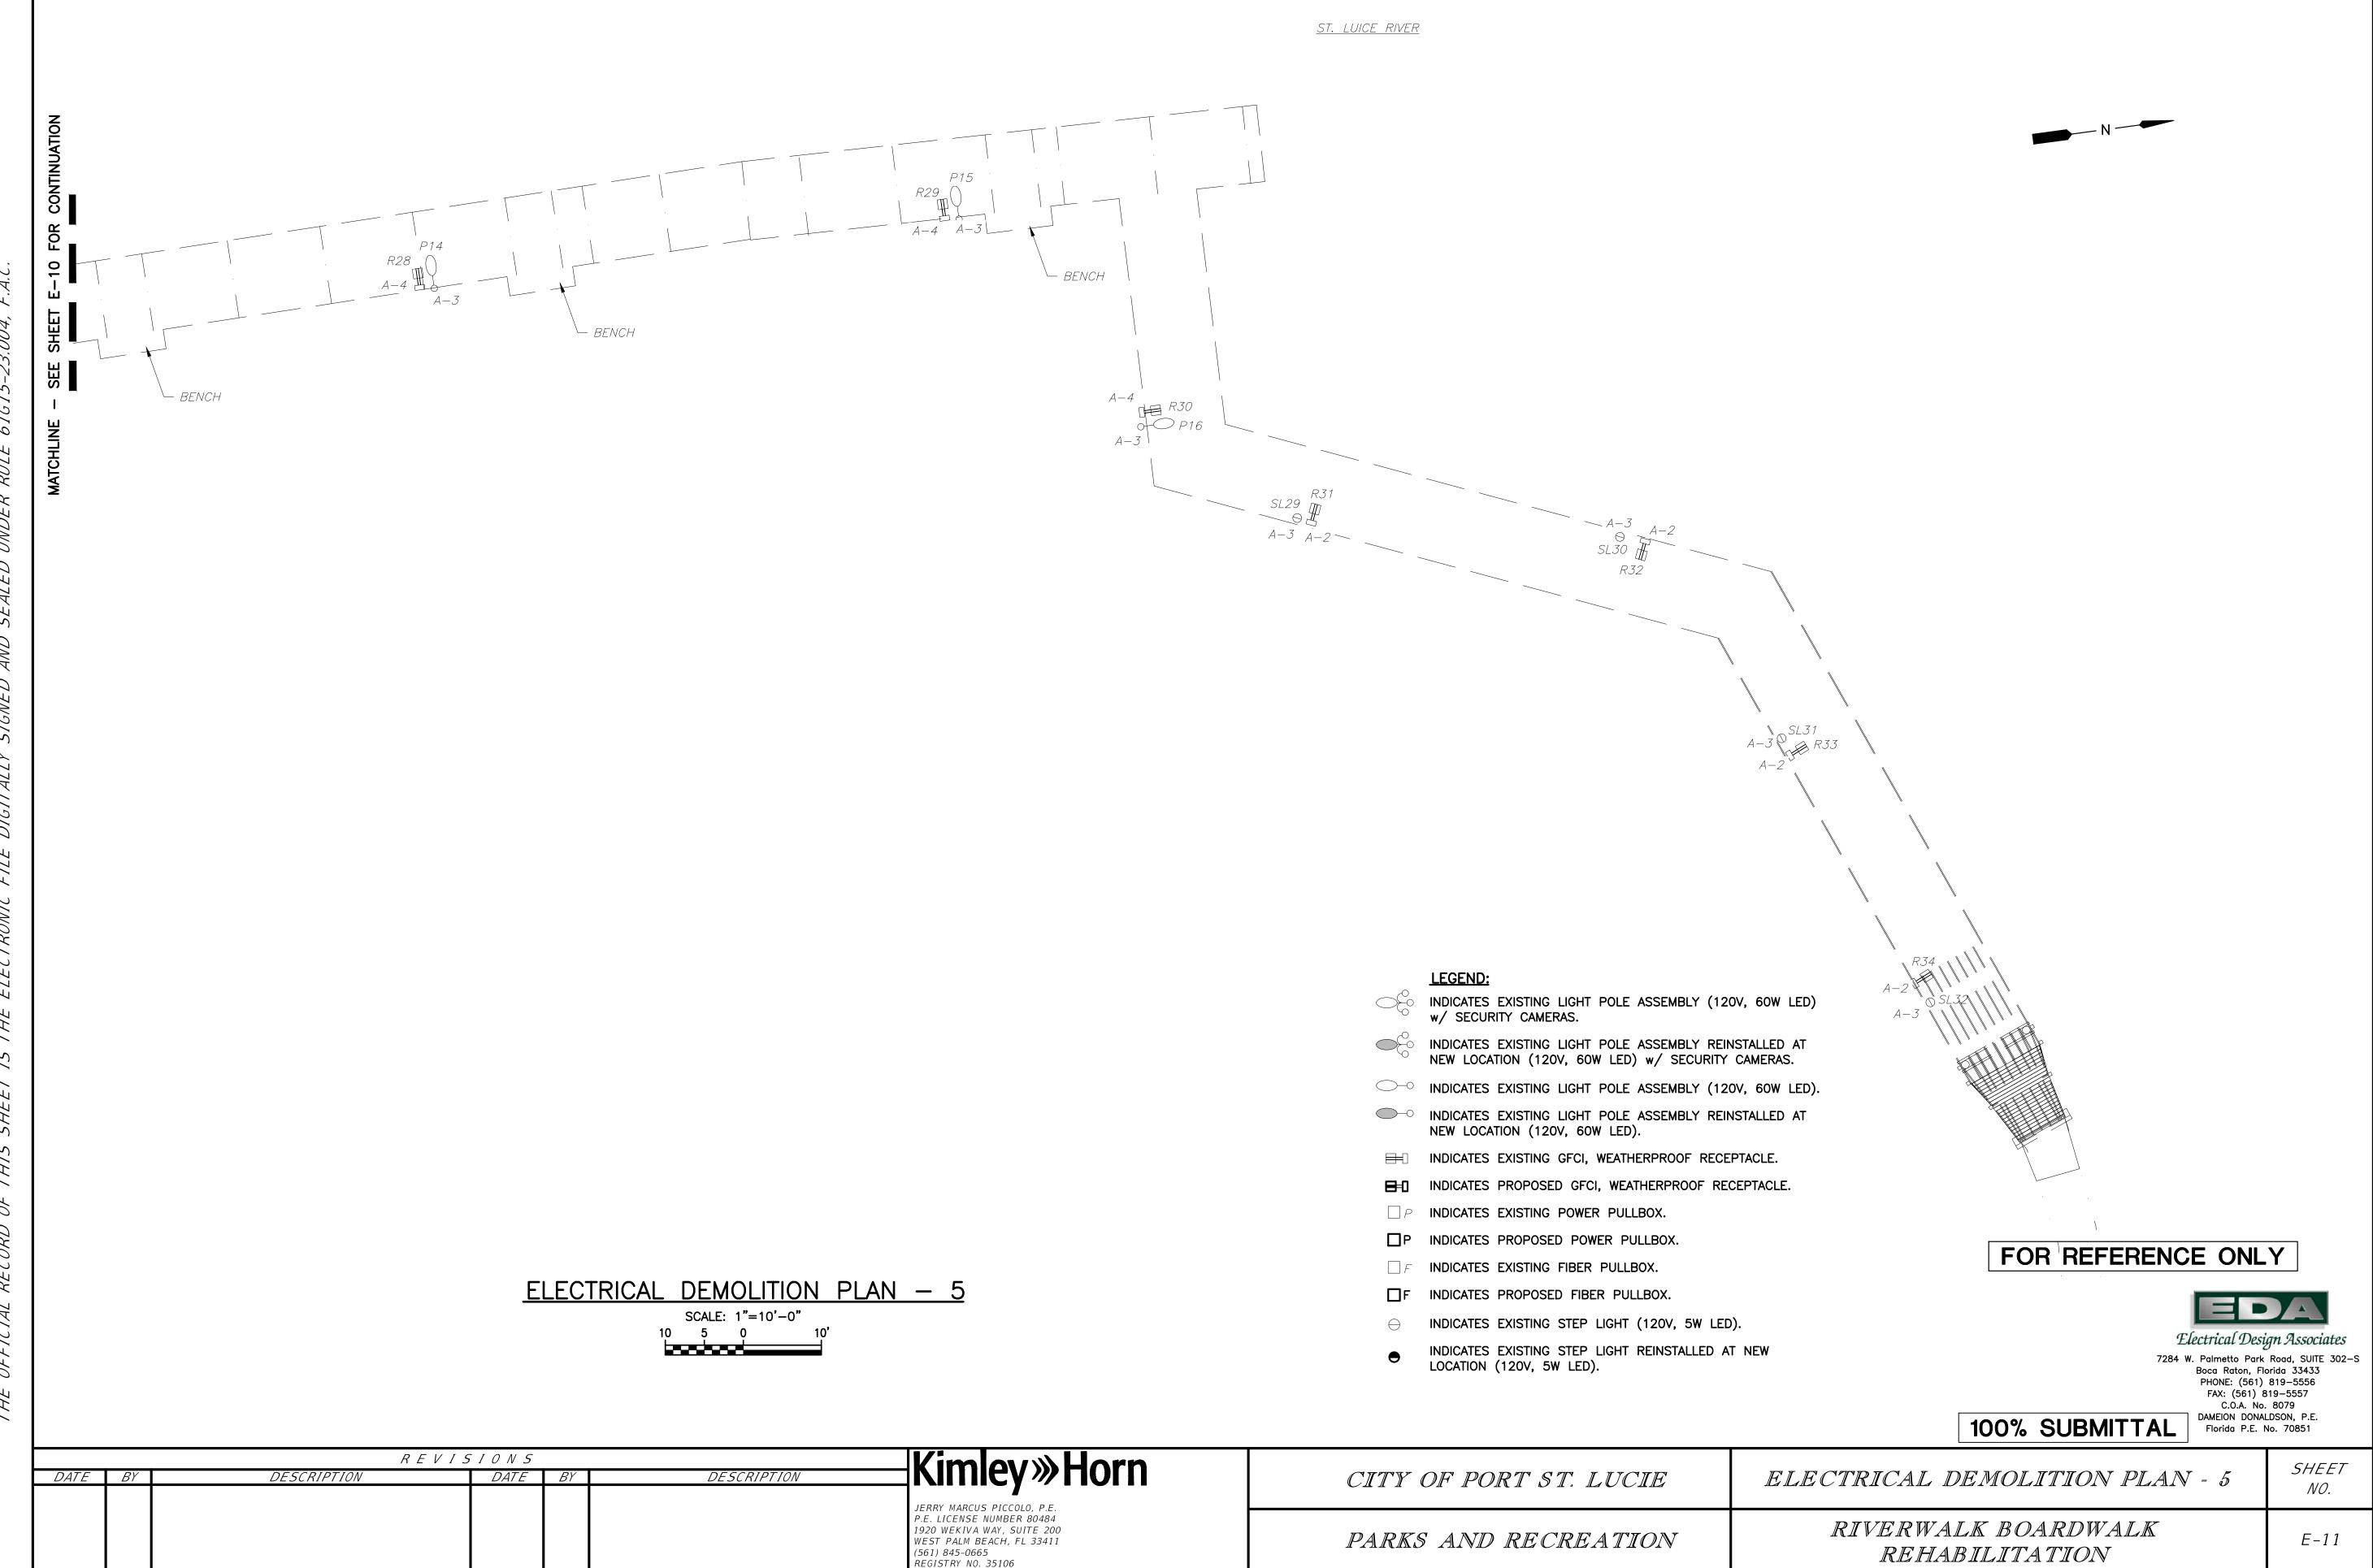
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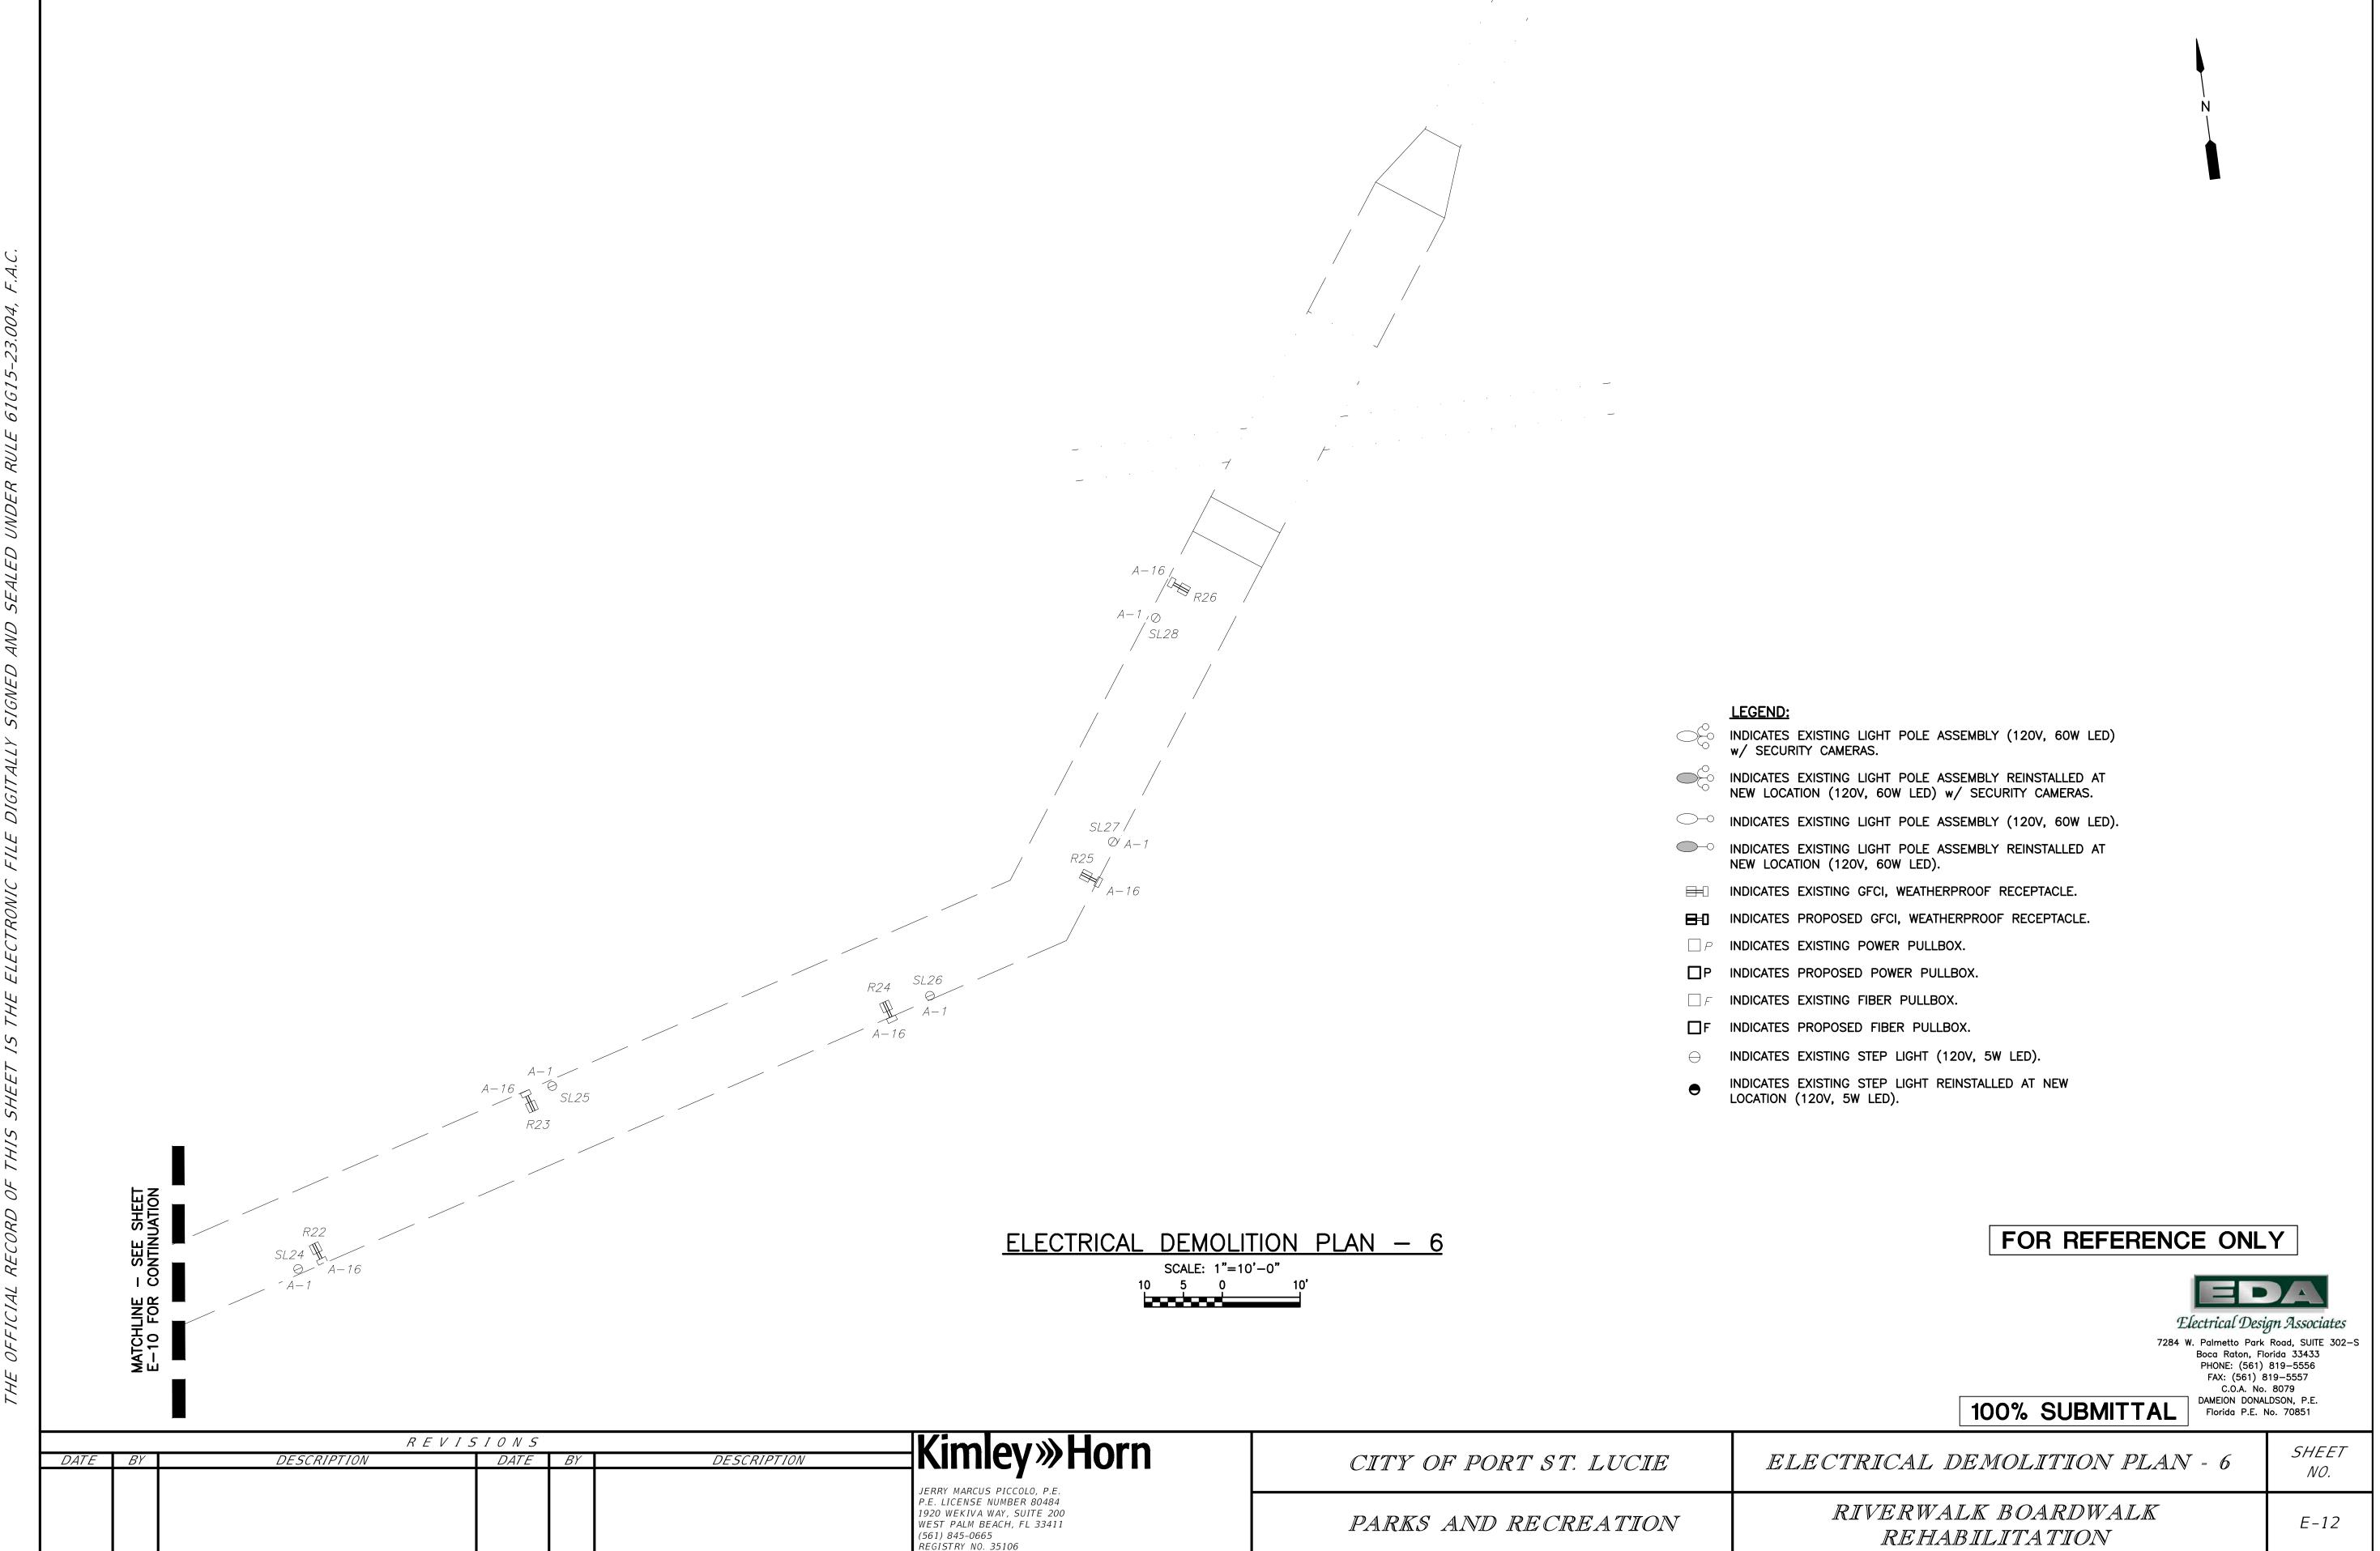
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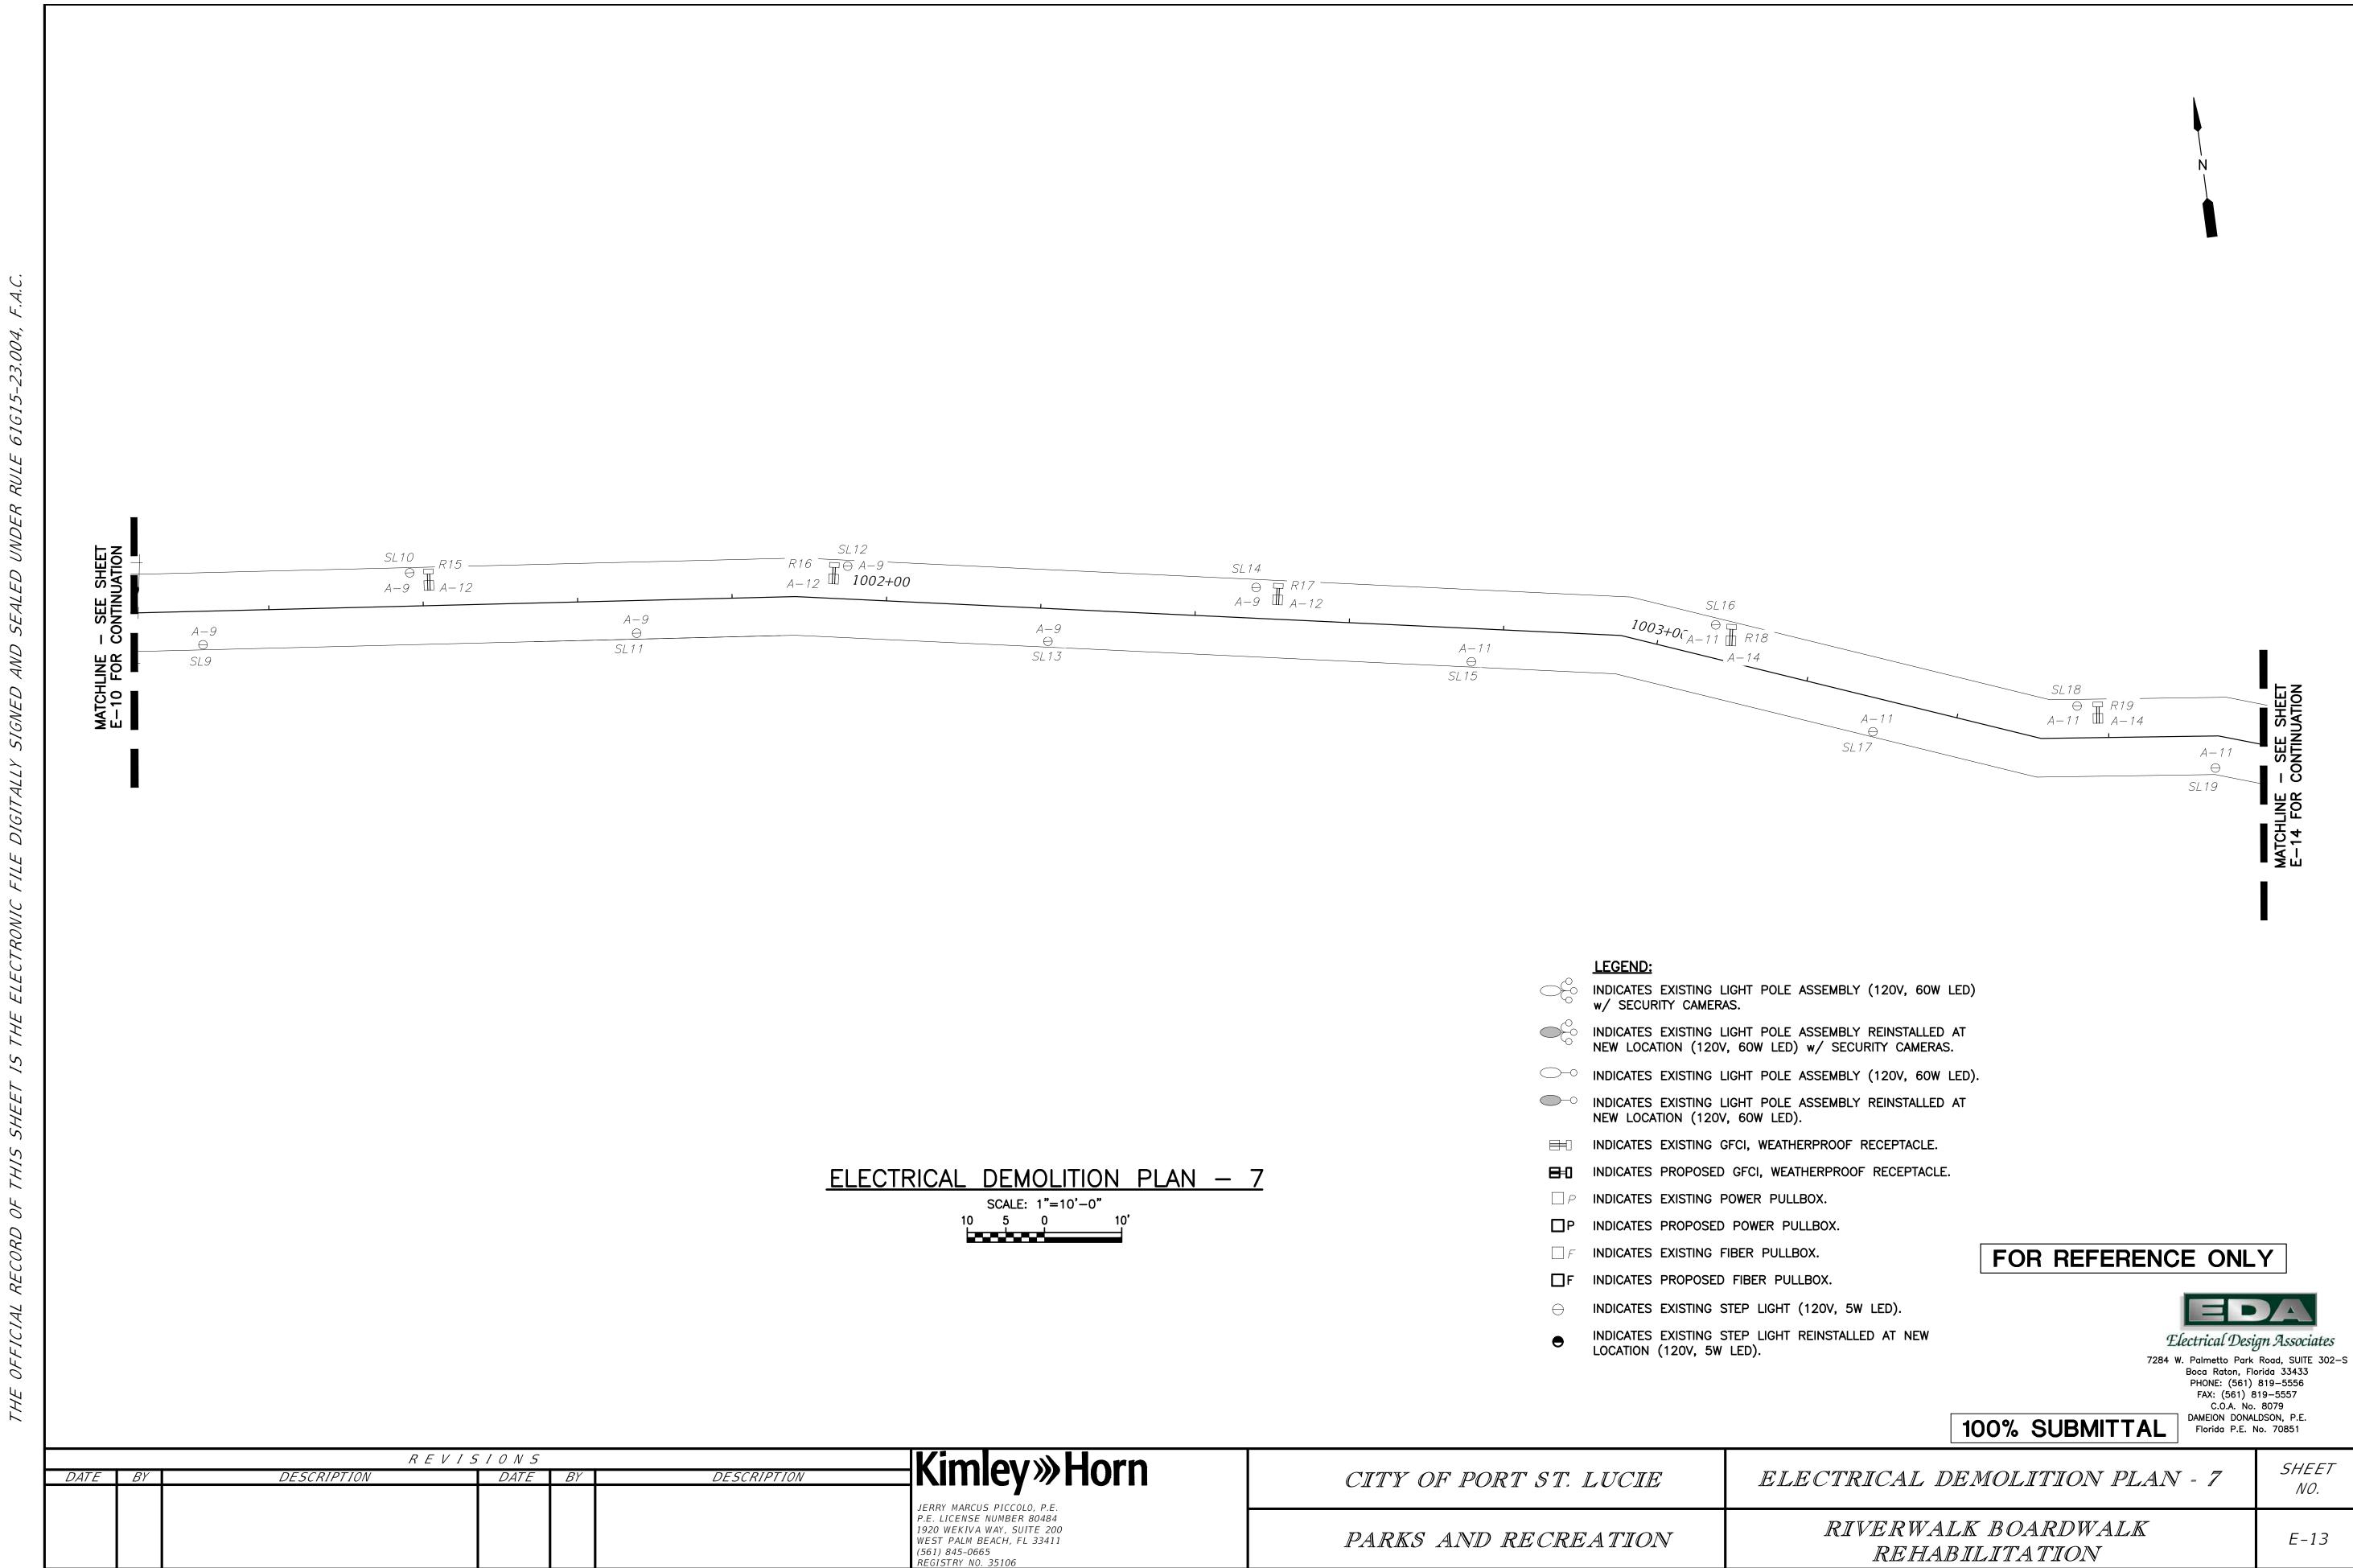

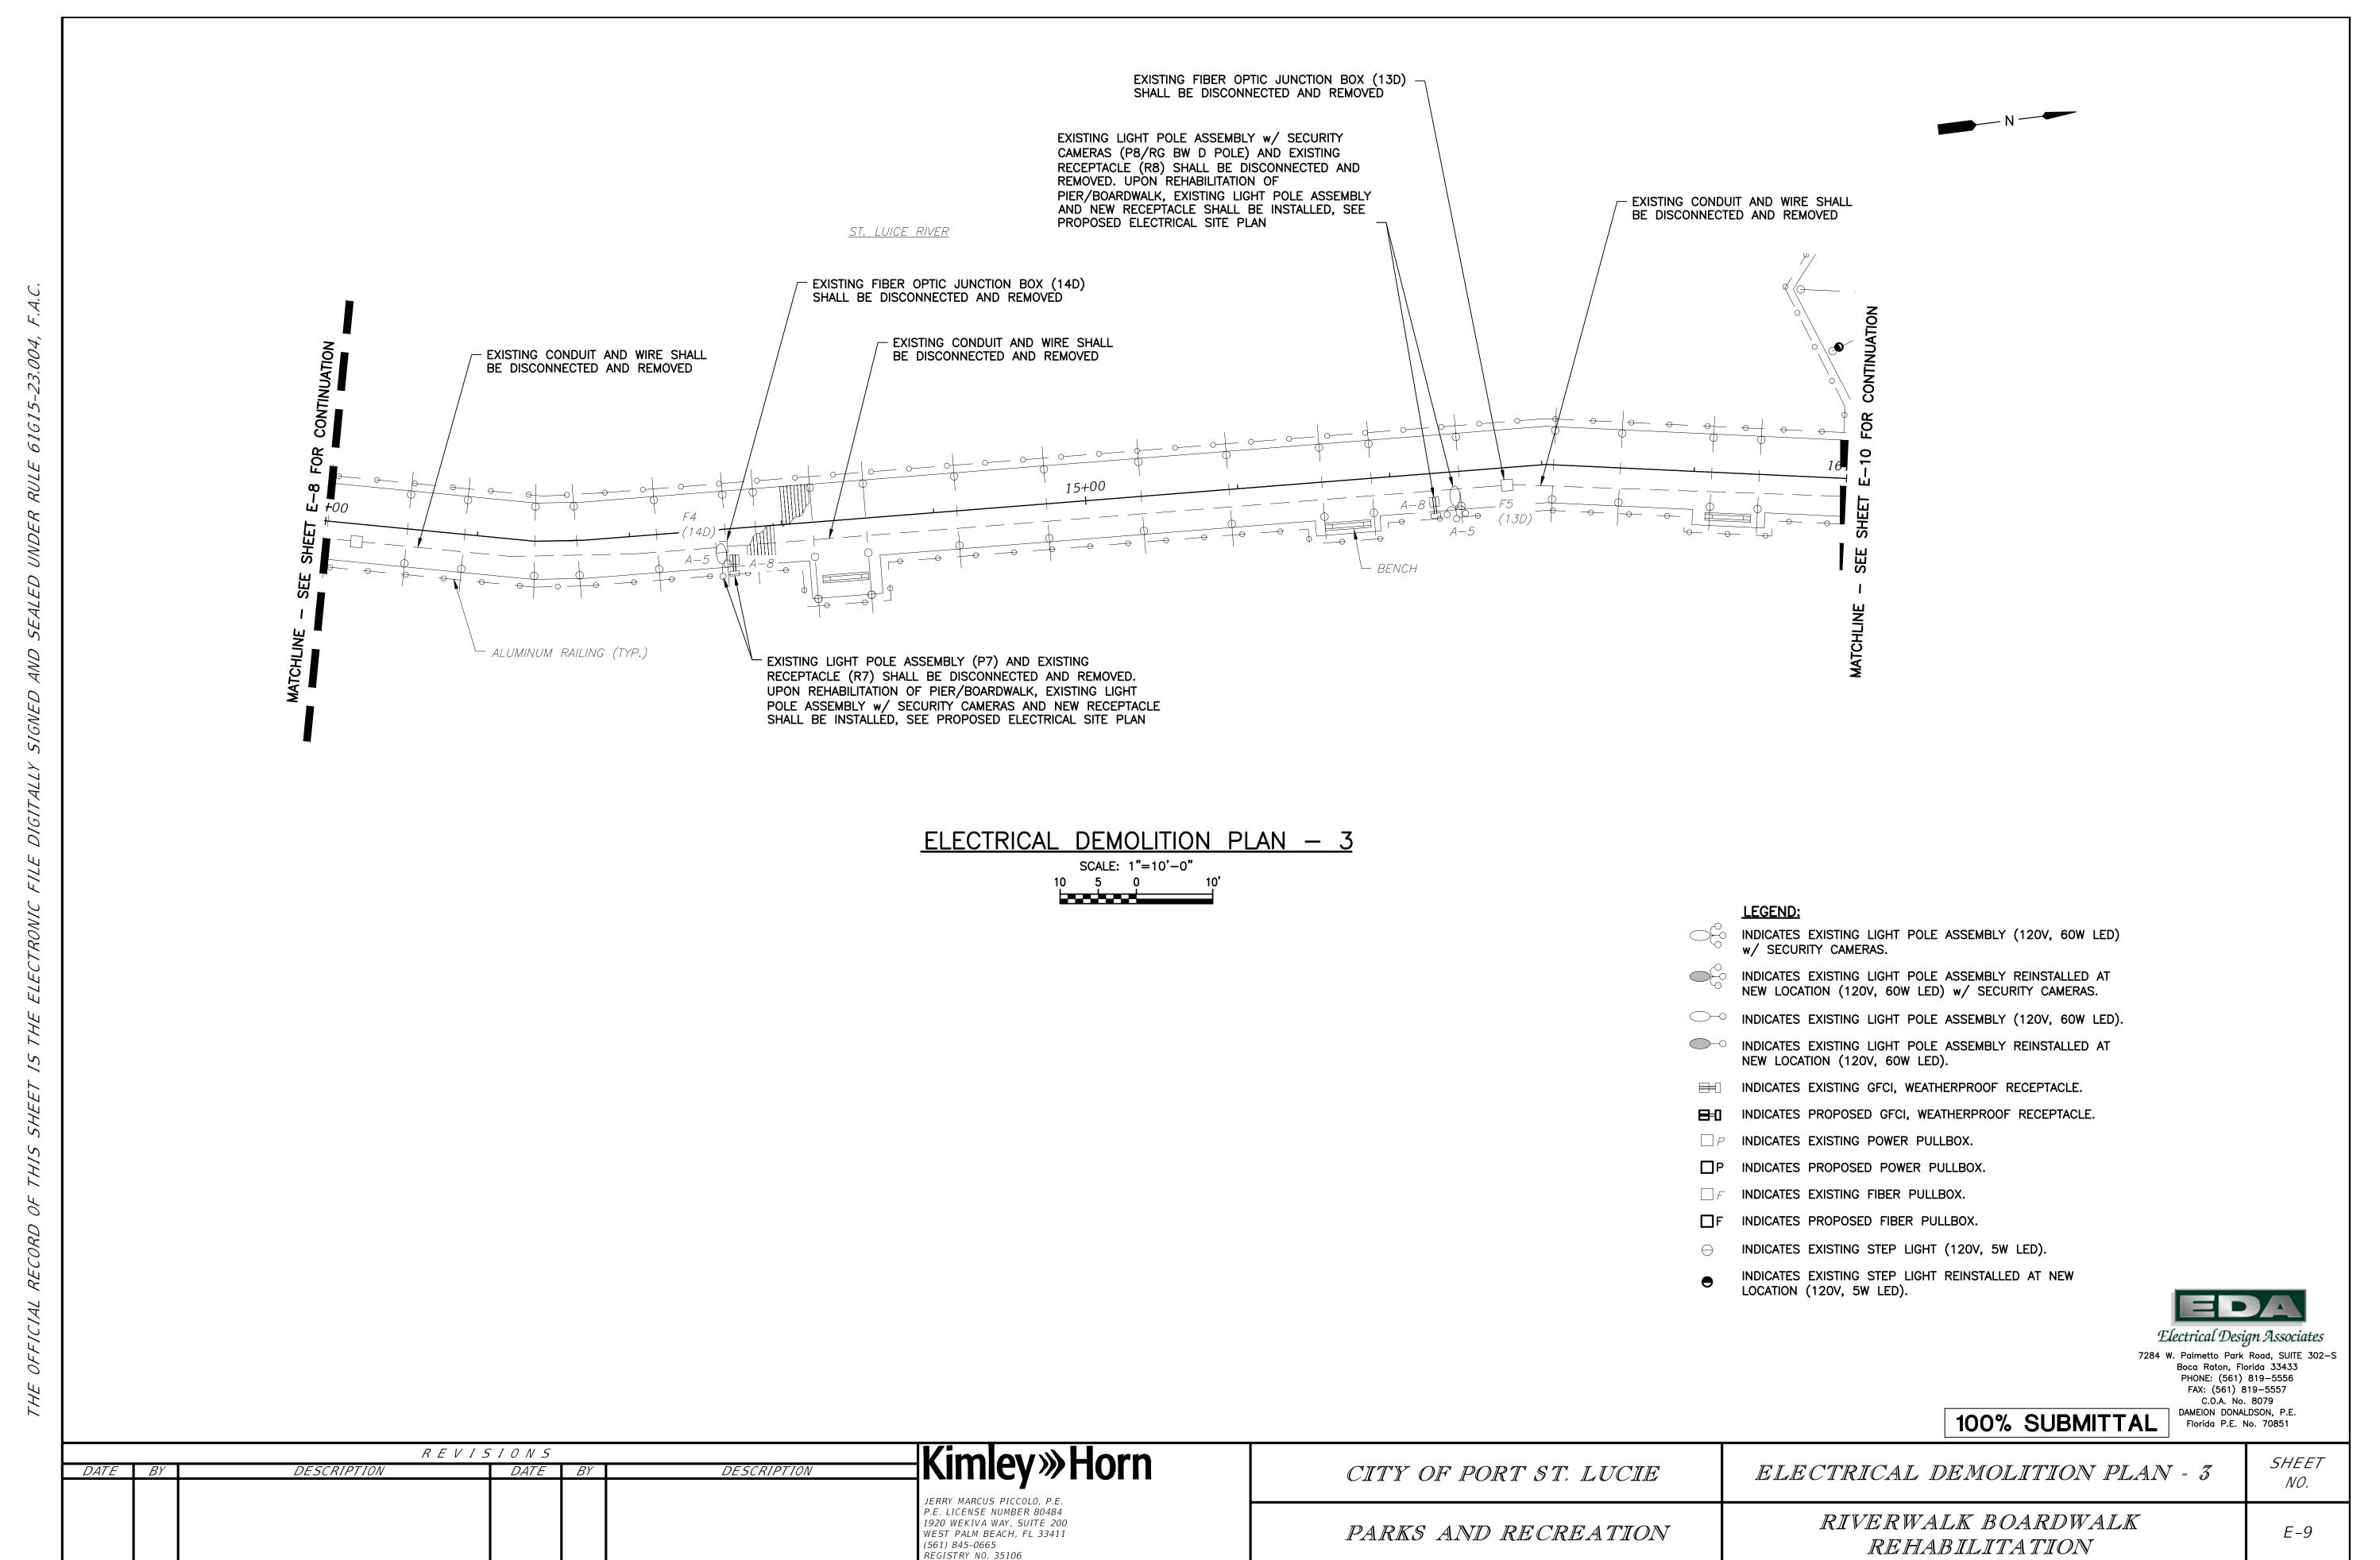
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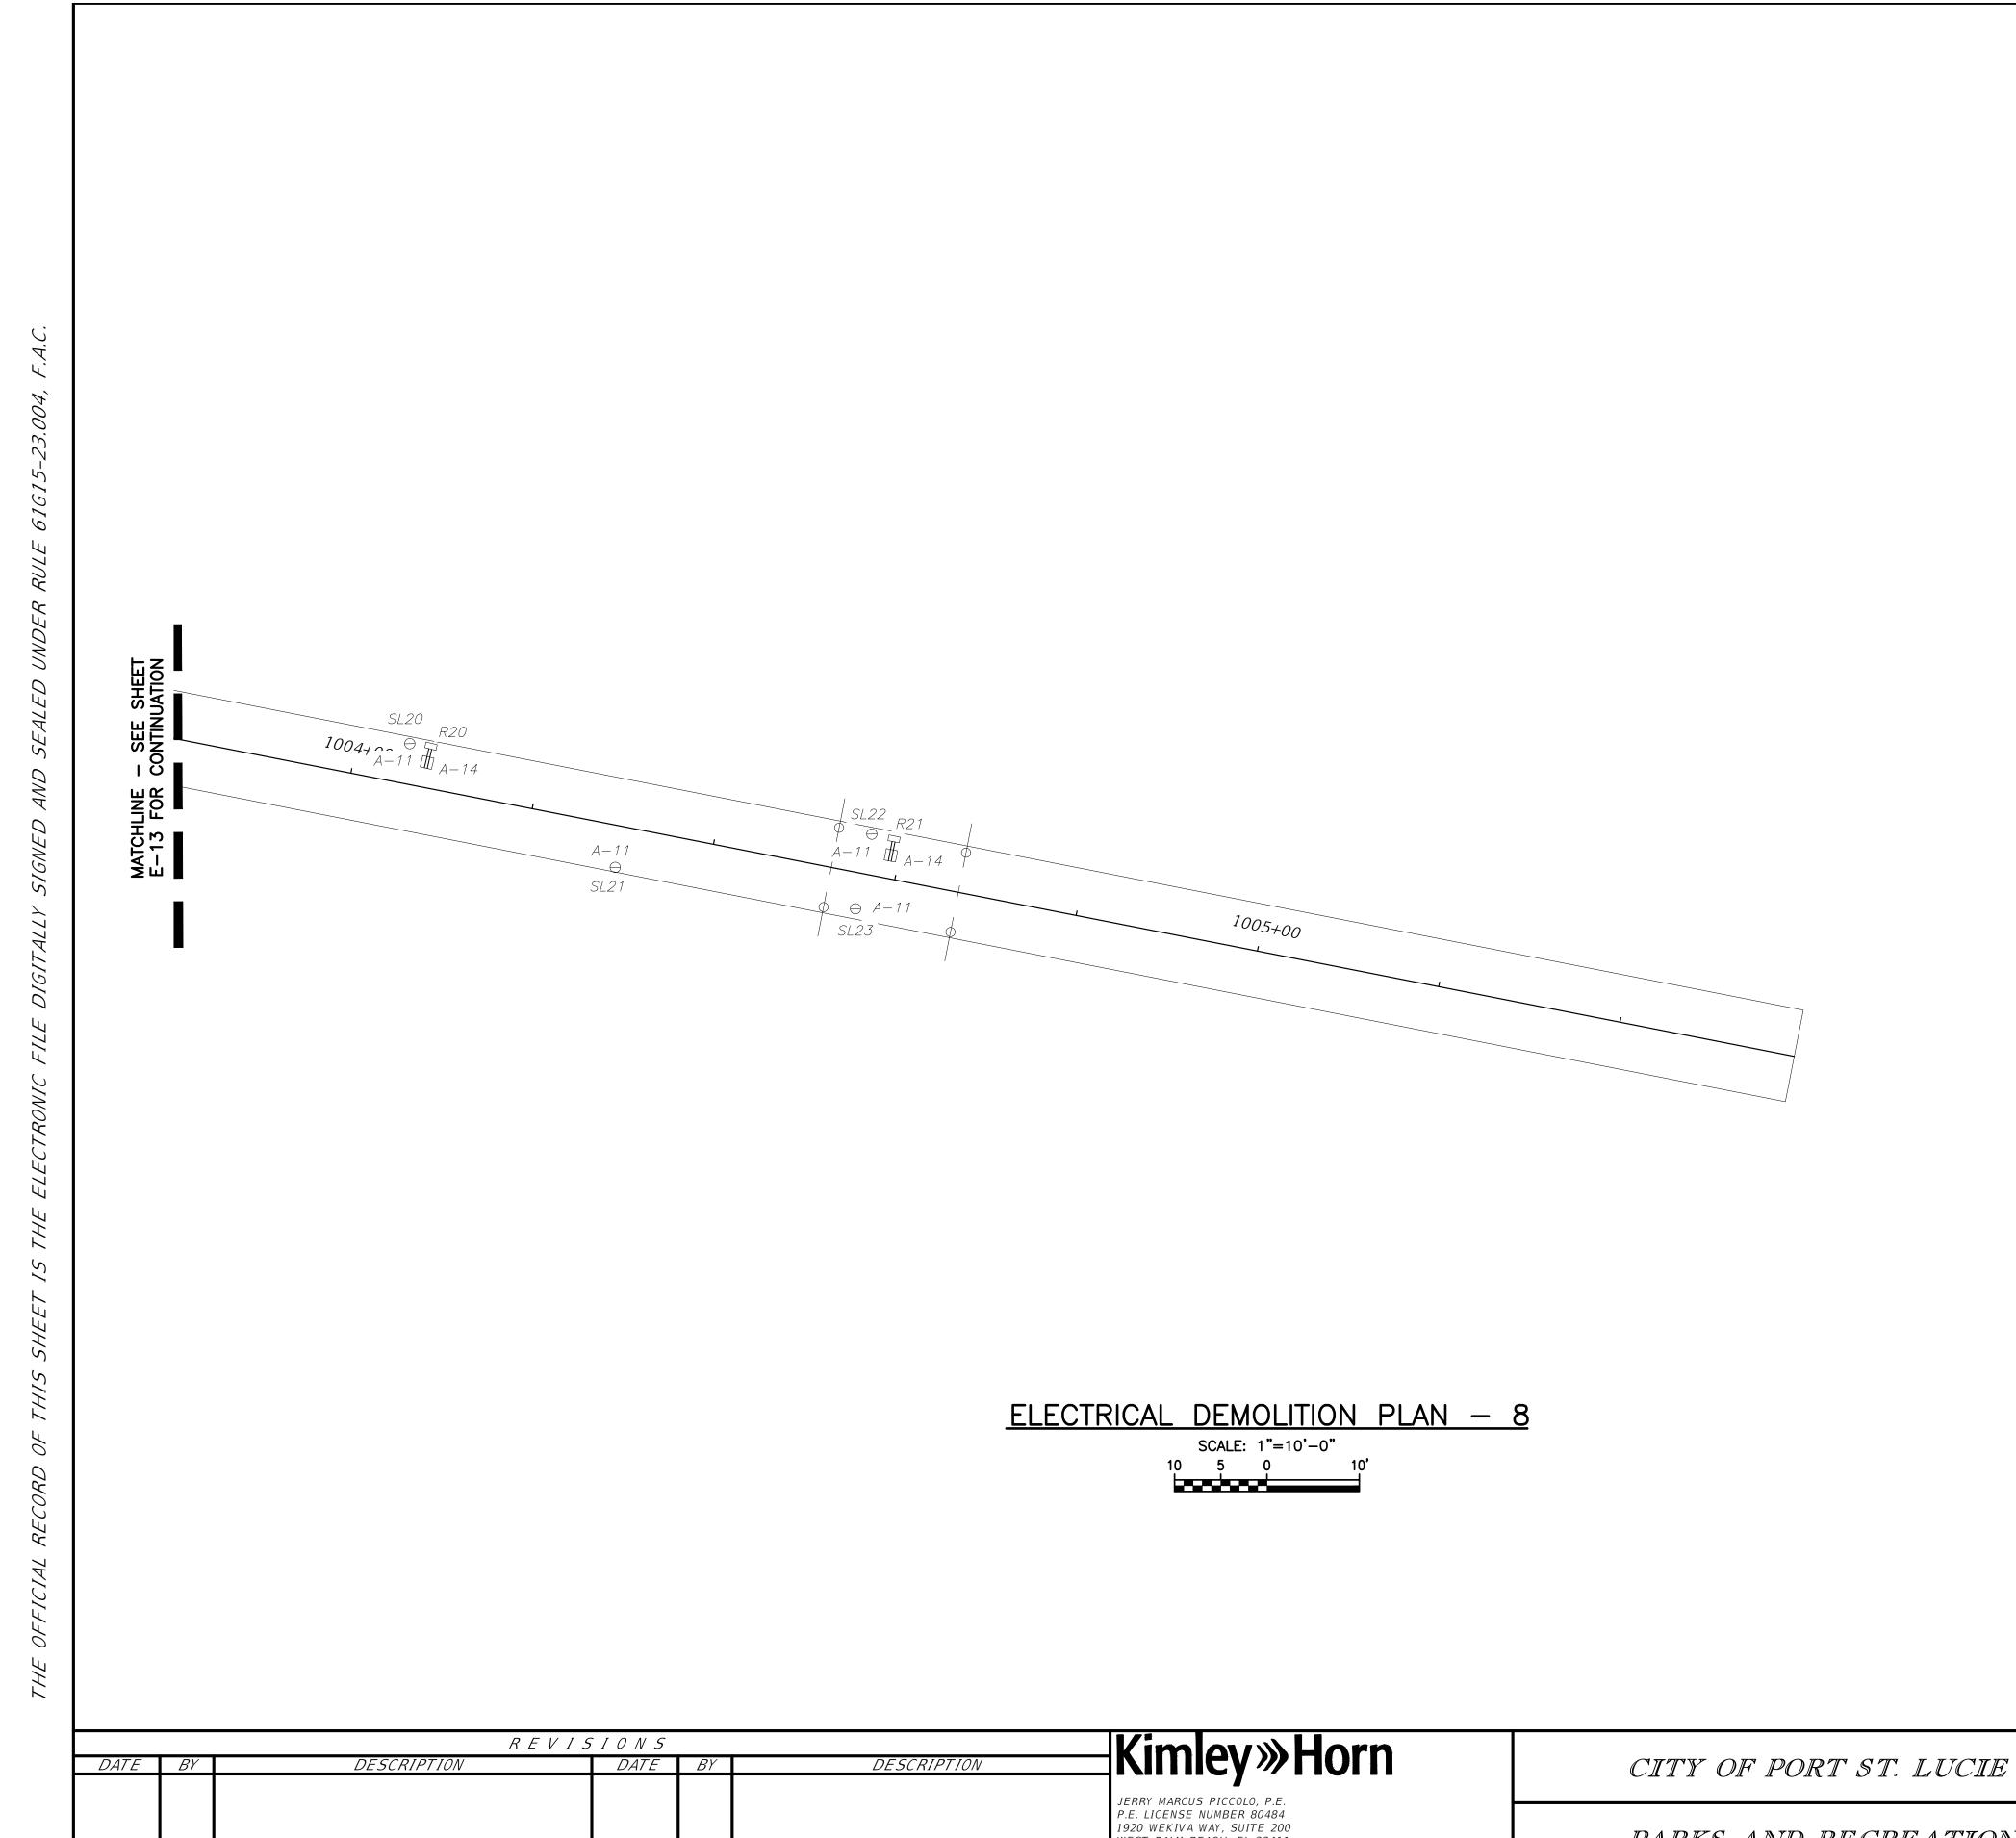
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WEST PALM BEACH, FL 33411

(561) 845-0665 REGISTRY NO. 35106
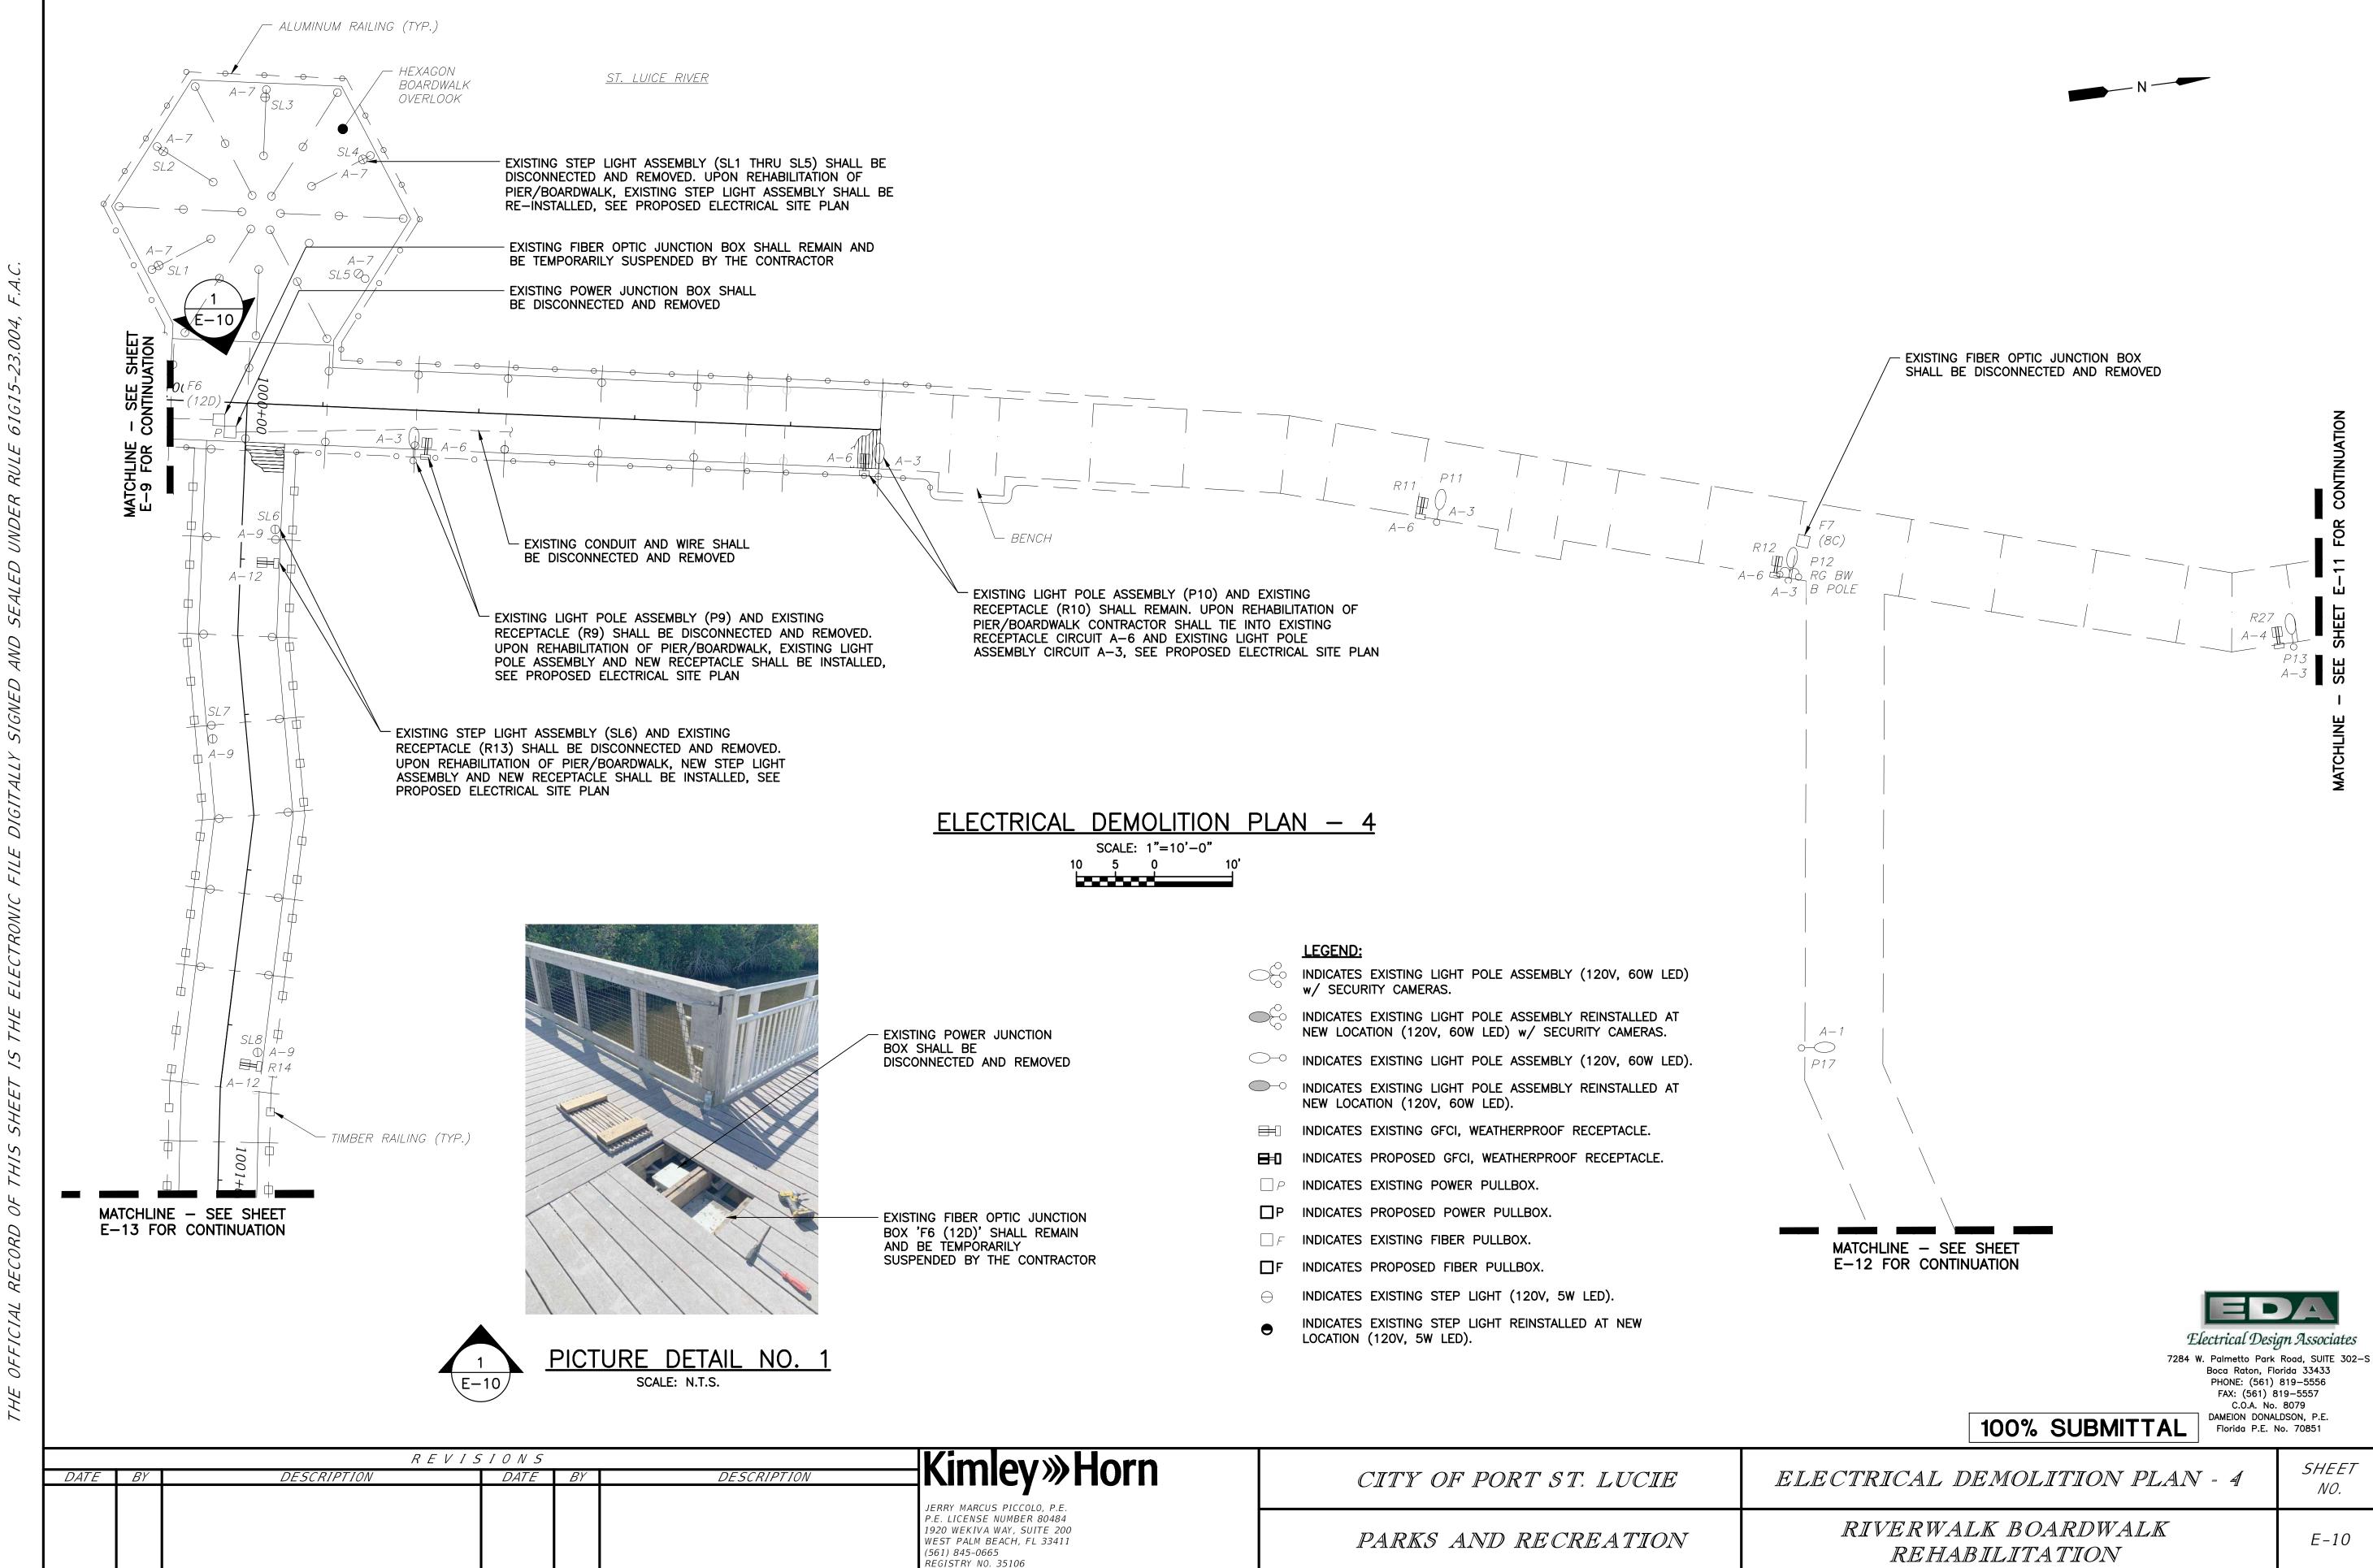
# **LEGEND:**

- INDICATES EXISTING LIGHT POLE ASSEMBLY (120V, 60W LED) w/ SECURITY CAMERAS.
- INDICATES EXISTING LIGHT POLE ASSEMBLY REINSTALLED AT NEW LOCATION (120V, 60W LED) w/ SECURITY CAMERAS.
- INDICATES EXISTING LIGHT POLE ASSEMBLY (120V, 60W LED).
- INDICATES EXISTING LIGHT POLE ASSEMBLY REINSTALLED AT NEW LOCATION (120V, 60W LED).
- INDICATES EXISTING GFCI, WEATHERPROOF RECEPTACLE.
- INDICATES PROPOSED GFCI, WEATHERPROOF RECEPTACLE.
- $\square$   $extcolor{P}$  INDICATES EXISTING POWER PULLBOX.
- P INDICATES PROPOSED POWER PULLBOX.
- $\square$   $\digamma$  INDICATES EXISTING FIBER PULLBOX.
- $\square$ F INDICATES PROPOSED FIBER PULLBOX.
- $\ominus$  INDICATES EXISTING STEP LIGHT (120V, 5W LED).
- INDICATES EXISTING STEP LIGHT REINSTALLED AT NEW LOCATION (120V, 5W LED).

# FOR REFERENCE ONLY



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C.O.A. No. 8079
DAMEION DONALDSON, P.E.
Florida P.E. No. 70851

100% SUBMITTAL

ELECTRICAL DEMOLITION PLAN - 8


RIVERWALK BOARDWALK
REHABILITATION

E-14

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PARKS AND RECREATION

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JERRY MARCUS PICCOLO, P.E. P.E. LICENSE NUMBER 80484

1920 WEKIVA WAY, SUITE 200

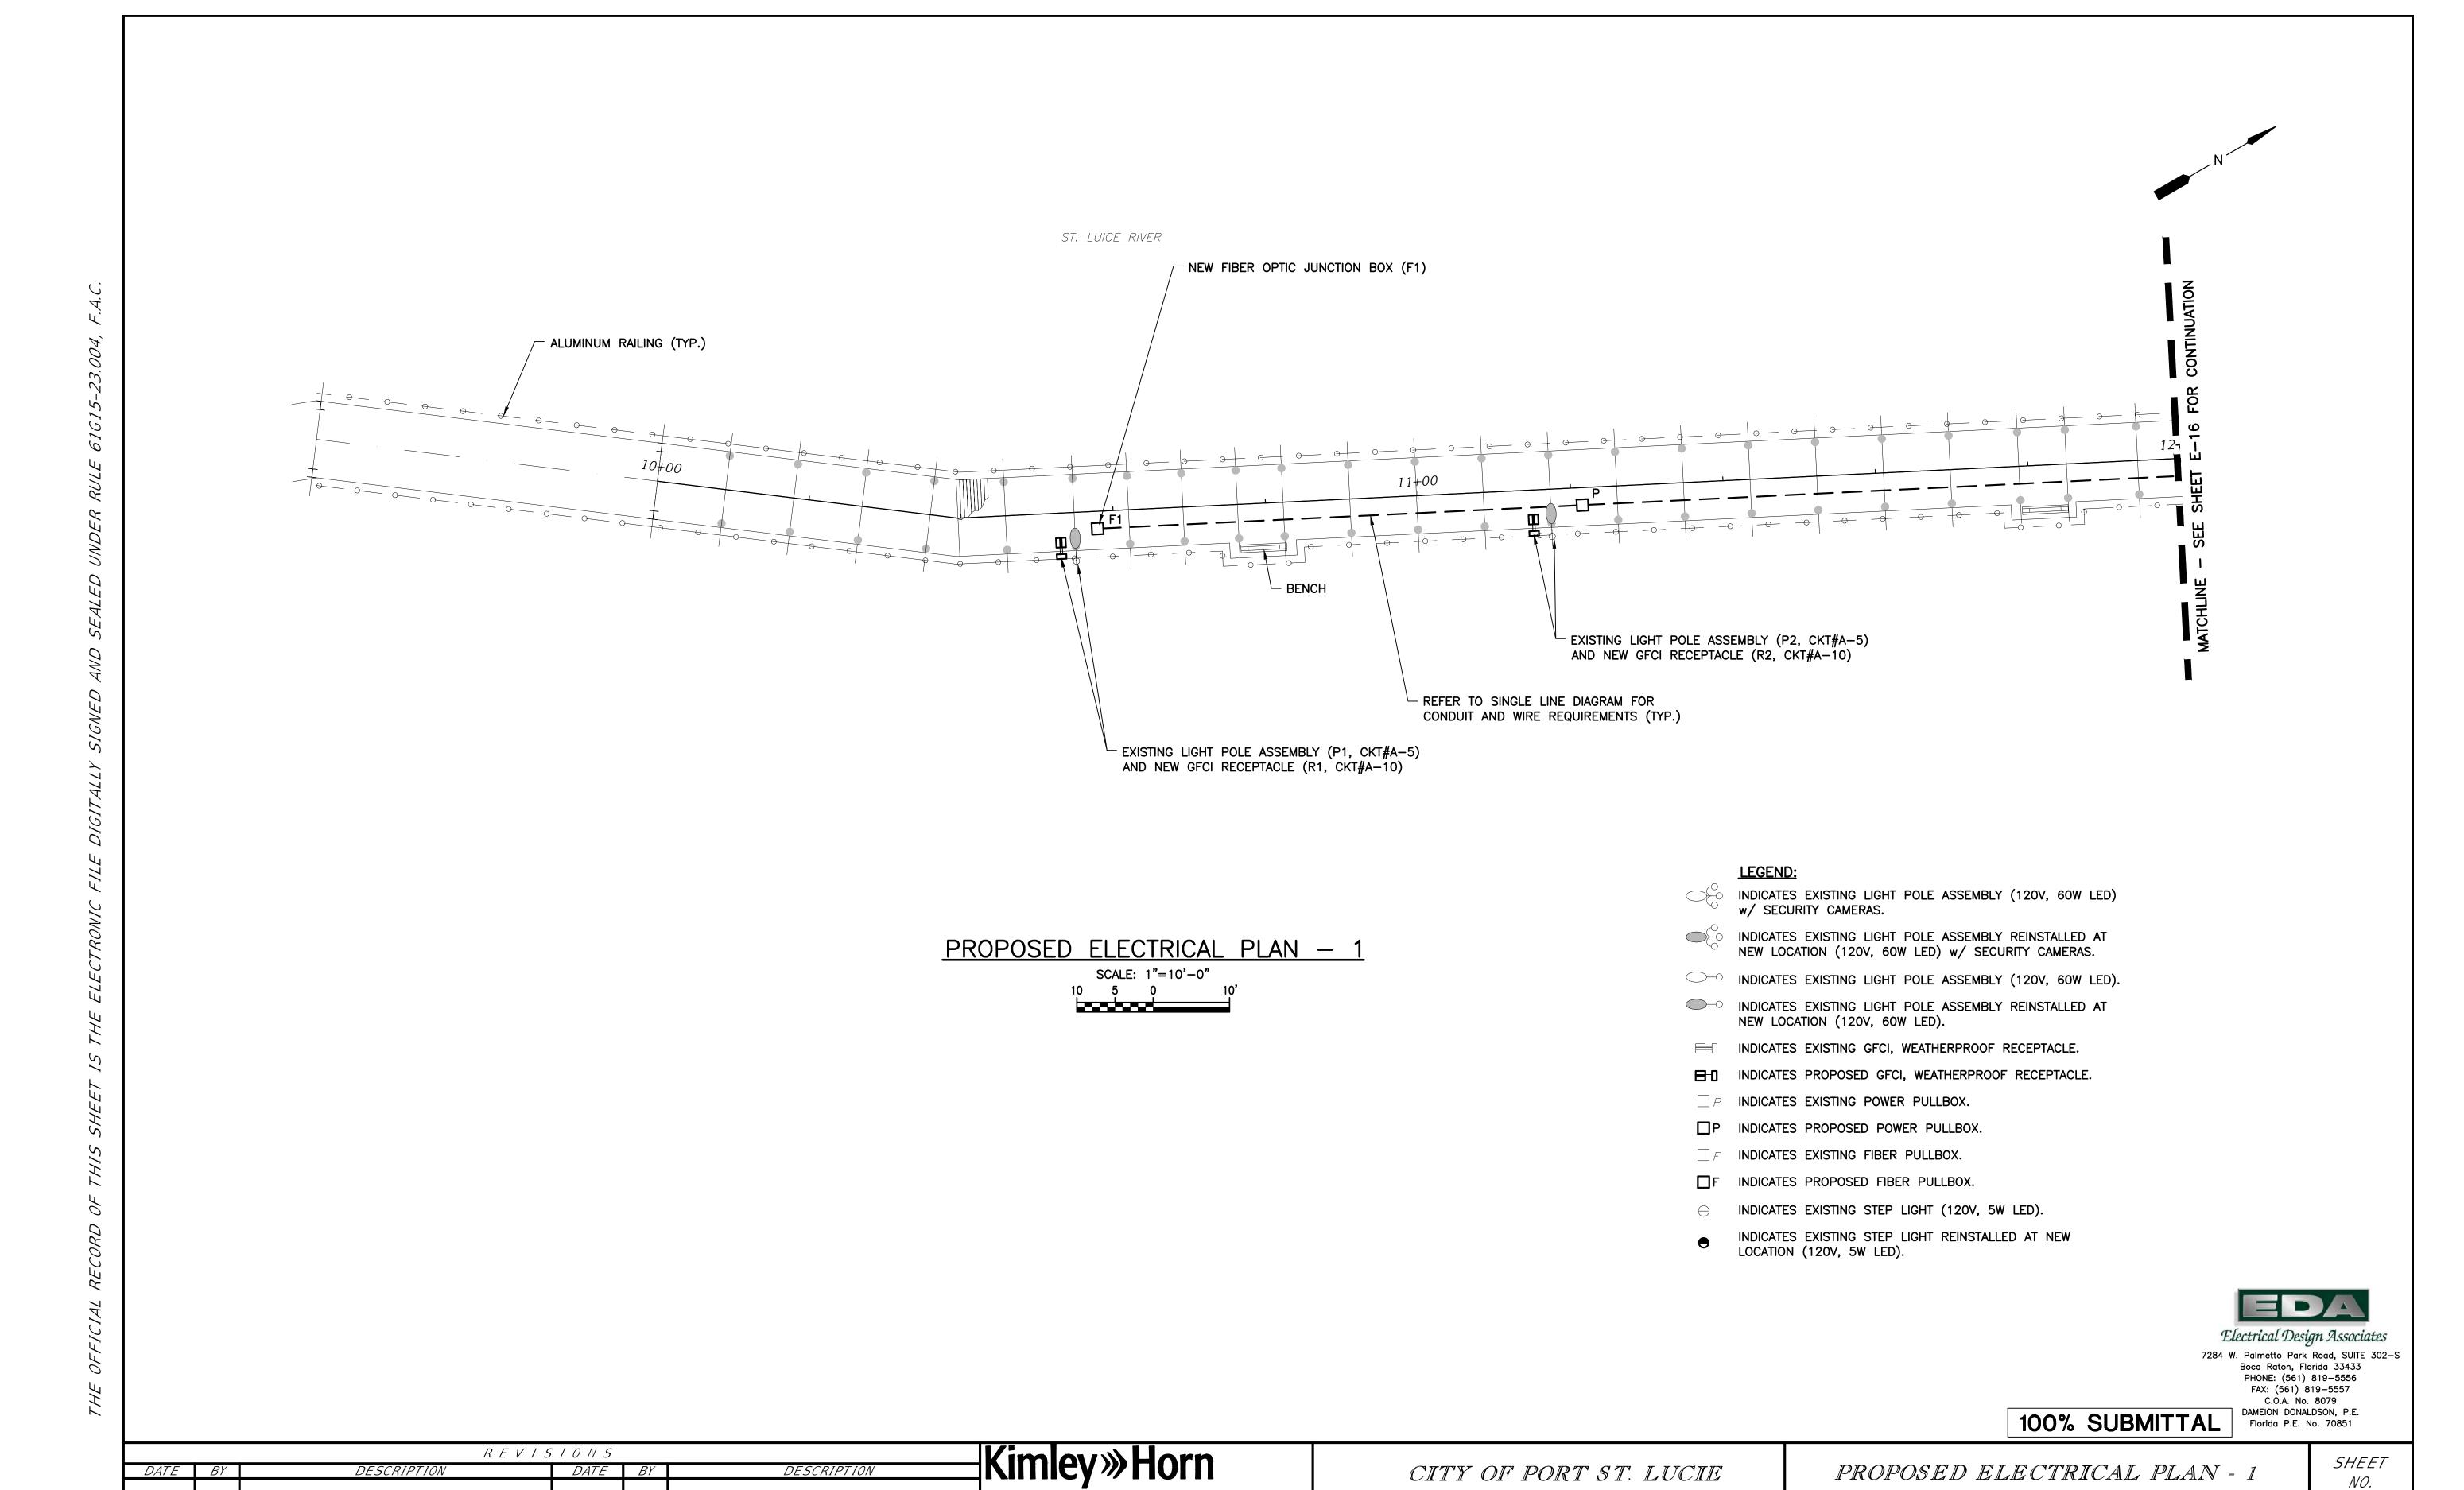
WEST PALM BEACH, FL 33411


(561) 845-0665 REGISTRY NO. 35106 Rmeeks 8/12/2024 10:27:42 AM W:\2\_Active Projects\Kimley Horn\Port St. Lucie\PSL Vets Mem Park Fiber-Riverwalk Brdwlk Rehab\03.\_100 Submittal\Dwgs

PARKS AND RECREATION

RIVERWALK BOARDWALK

E-15

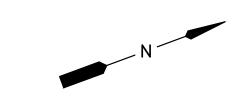

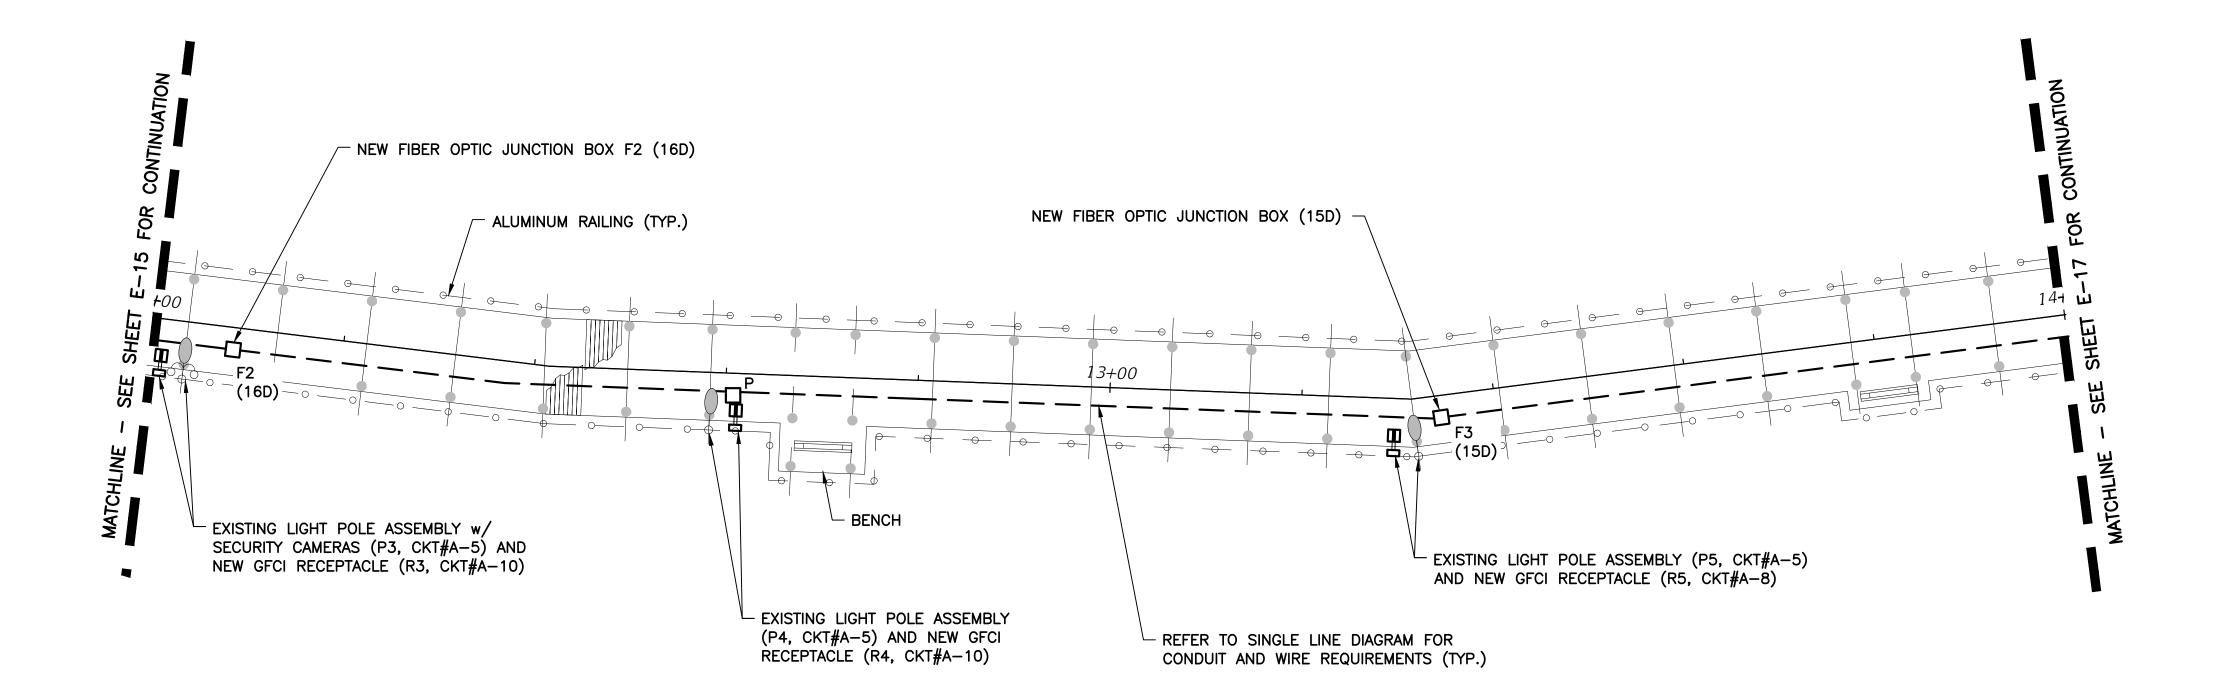

PROPOSED ELECTRICAL PLAN — 2

SCALE: 1"=10'-0"

10 5 0 10'

### LEGEND:

- INDICATES EXISTING LIGHT POLE ASSEMBLY (120V, 60W LED) w/ SECURITY CAMERAS.
- INDICATES EXISTING LIGHT POLE ASSEMBLY REINSTALLED AT NEW LOCATION (120V, 60W LED) w/ SECURITY CAMERAS.
- INDICATES EXISTING LIGHT POLE ASSEMBLY (120V, 60W LED).
- INDICATES EXISTING LIGHT POLE ASSEMBLY REINSTALLED AT NEW LOCATION (120V, 60W LED).
- INDICATES EXISTING GFCI, WEATHERPROOF RECEPTACLE.
- INDICATES PROPOSED GFCI, WEATHERPROOF RECEPTACLE.
- $\square$  P INDICATES EXISTING POWER PULLBOX.
- □ P INDICATES PROPOSED POWER PULLBOX.□ F INDICATES EXISTING FIBER PULLBOX.
- ☐F INDICATES PROPOSED FIBER PULLBOX.
- → INDICATES EXISTING STEP LIGHT (120V, 5W LED).
- INDICATES EXISTING STEP LIGHT REINSTALLED AT NEW LOCATION (120V, 5W LED).



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C.O.A. No. 8079

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DAMEION DONALDSON, P.E.
Florida P.E. No. 70851

DAT	E BY	R E DESCRIPTION	V I S I O N S  DATE BY	DESCRIPTION	Kimley»Horn	CITY OF PORT ST. LUCIE	PROPOSED ELECTRICAL PLAN - 2	SHEET NO.
					JERRY MARCUS PICCOLO, P.E. P.E. LICENSE NUMBER 80484 1920 WEKIVA WAY, SUITE 200 WEST PALM BEACH, FL 33411 (561) 845-0665 REGISTRY NO. 35106	PARKS AND RECREATION	RIVERWALK BOARDWALK REHABILITATION	E-16

Rmeeks

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NEW FIBER OPTIC JUNCTION BOX (13D) ST. LUICE RIVER EXISTING LIGHT POLE ASSEMBLY w/ SECURITY CAMERAS (P8, CKT#A-5) AND NEW GFCI RECEPTACLE (R8, CKT#A-8) - NEW FIBER OPTIC JUNCTION BOX (14D) - ALUMINUM RAILING (TYP.) - EXISTING LIGHT POLE ASSEMBLY (P7, CKT#A-5) AND NEW GFCI RECEPTACLE (R7, CKT#A-8) - EXISTING LIGHT POLE ASSEMBLY (P6, CKT#A-5) AND NEW GFCI RECEPTACLE (R6, CKT#A-8) REFER TO SINGLE LINE DIAGRAM FOR CONDUIT AND WIRE REQUIREMENTS (TYP.) **LEGEND:** INDICATES EXISTING LIGHT POLE ASSEMBLY (120V, 60W LED) w/ SECURITY CAMERAS. INDICATES EXISTING LIGHT POLE ASSEMBLY REINSTALLED AT NEW LOCATION (120V, 60W LED) w/ SECURITY CAMERAS. INDICATES EXISTING LIGHT POLE ASSEMBLY (120V, 60W LED). INDICATES EXISTING LIGHT POLE ASSEMBLY REINSTALLED AT NEW LOCATION (120V, 60W LED). INDICATES EXISTING GFCI, WEATHERPROOF RECEPTACLE. INDICATES PROPOSED GFCI, WEATHERPROOF RECEPTACLE.  $\square$  P INDICATES EXISTING POWER PULLBOX. P INDICATES PROPOSED POWER PULLBOX.  $\square$   $\digamma$  INDICATES EXISTING FIBER PULLBOX. F INDICATES PROPOSED FIBER PULLBOX. INDICATES EXISTING STEP LIGHT (120V, 5W LED). INDICATES EXISTING STEP LIGHT REINSTALLED AT NEW LOCATION (120V, 5W LED). PROPOSED ELECTRICAL PLAN - 3 SCALE: 1"=10'-0" 100% SUBMITTAL REVISIONS DATE BY CITY OF PORT ST. LUCIE PROPOSED ELECTRICAL PLAN - 3 DESCRIPTION DESCRIPTION DATE BY JERRY MARCUS PICCOLO, P.E. P.E. LICENSE NUMBER 80484 RIVERWALK BOARDWALK 1920 WEKIVA WAY, SUITE 200

WEST PALM BEACH, FL 33411

(561) 845-0665 REGISTRY NO. 35106

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REHABILITATION

PARKS AND RECREATION

Electrical Design Associates


7284 W. Palmetto Park Road, SUITE 302-S Boca Raton, Florida 33433 PHONE: (561) 819-5556

FAX: (561) 819-5557 C.O.A. No. 8079 DAMEION DONALDSON, P.E. Florida P.E. No. 70851

SHEET


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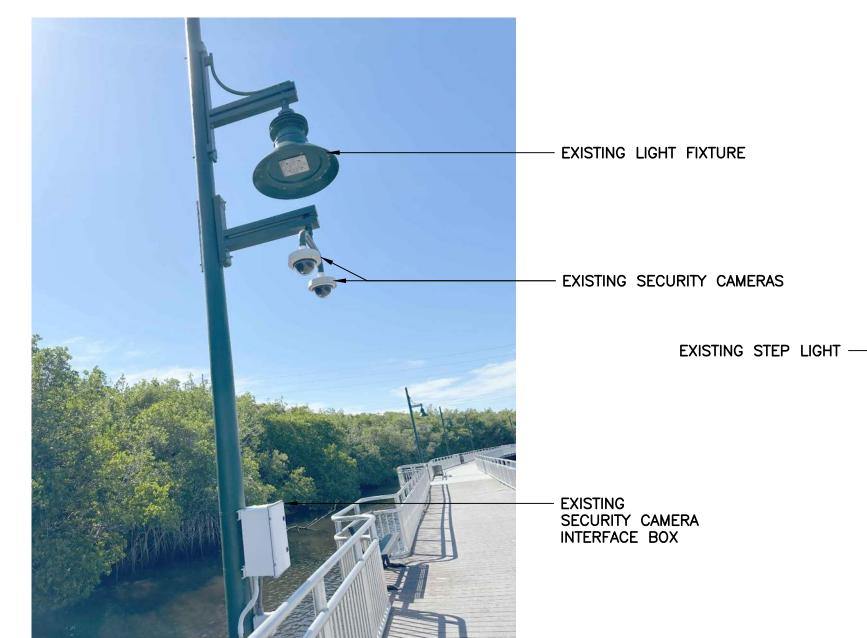
E-17

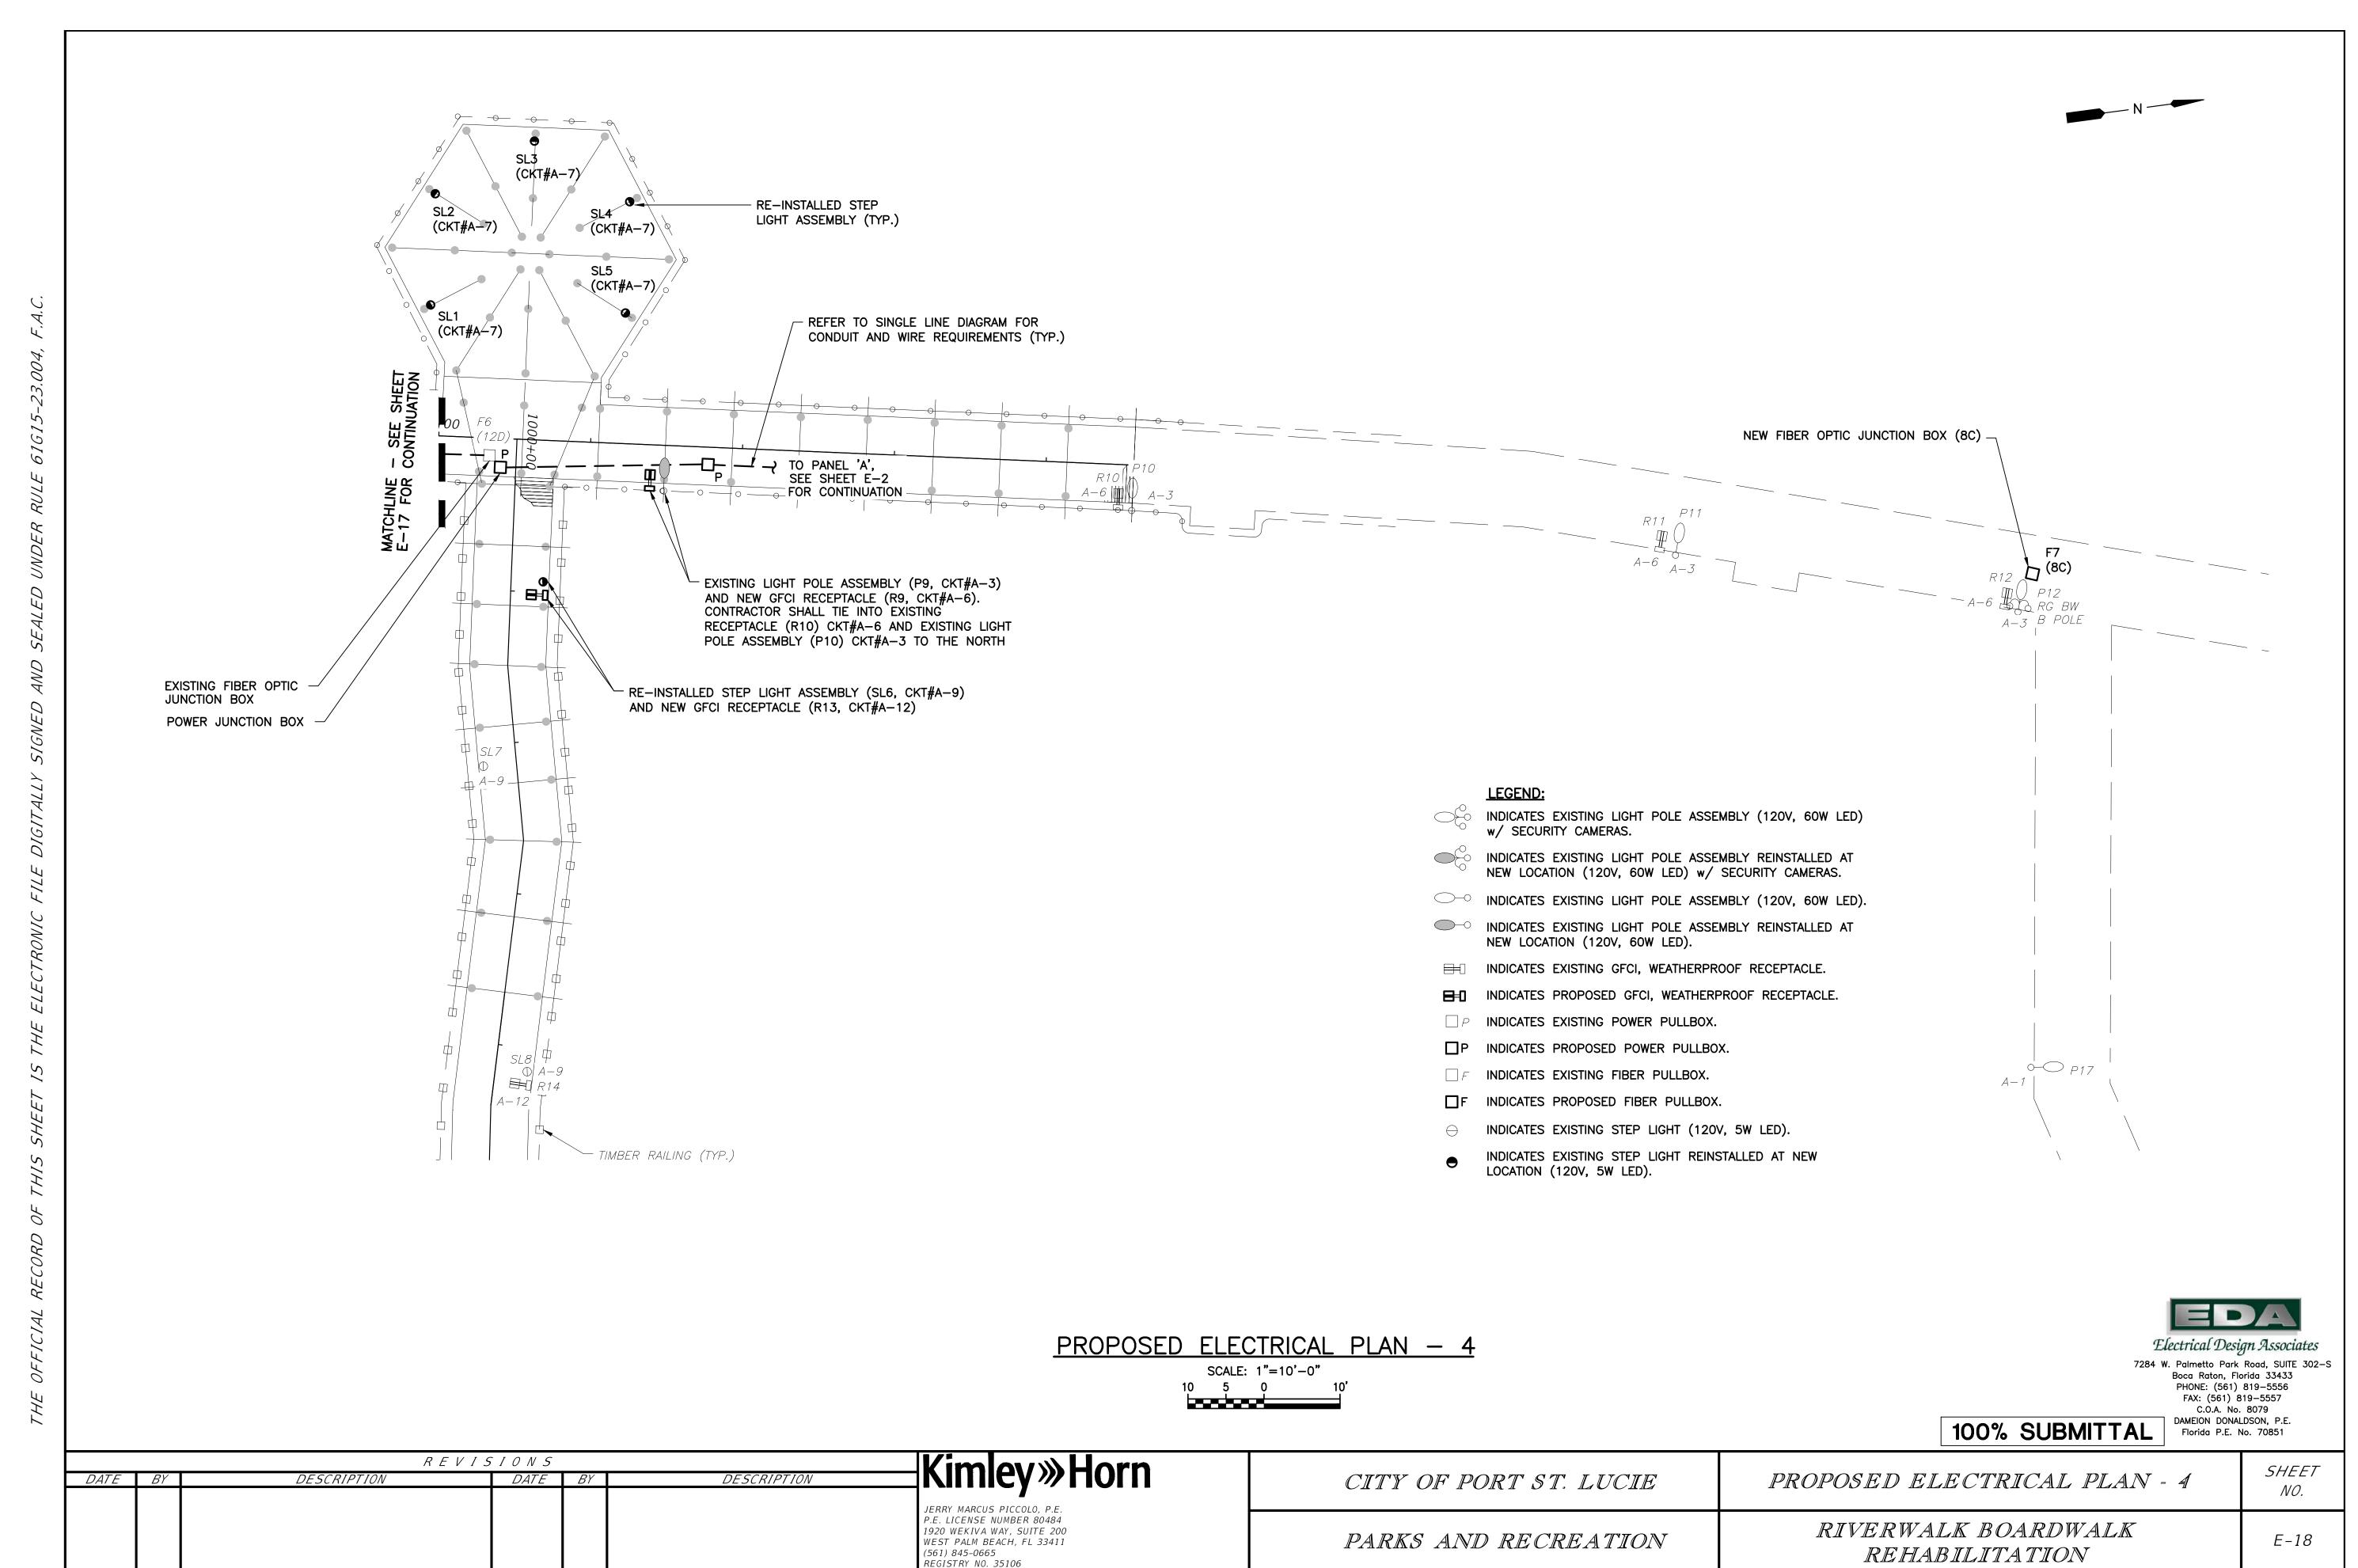


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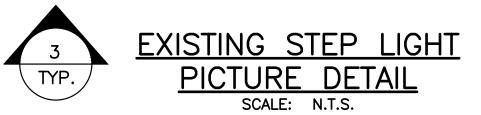








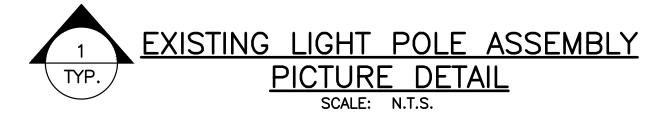



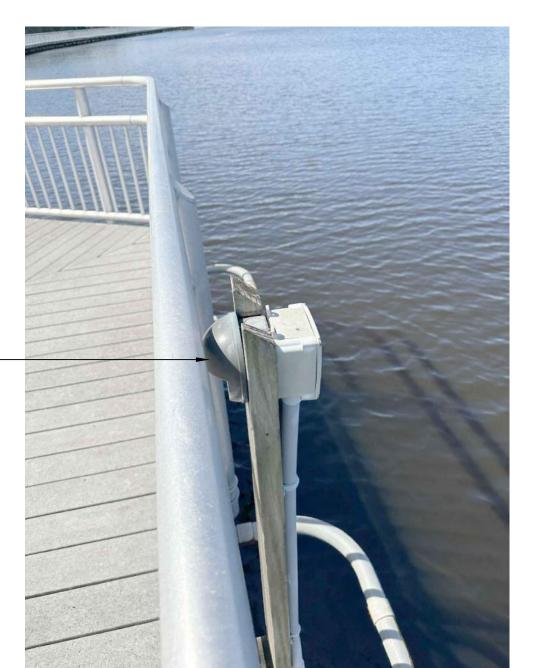

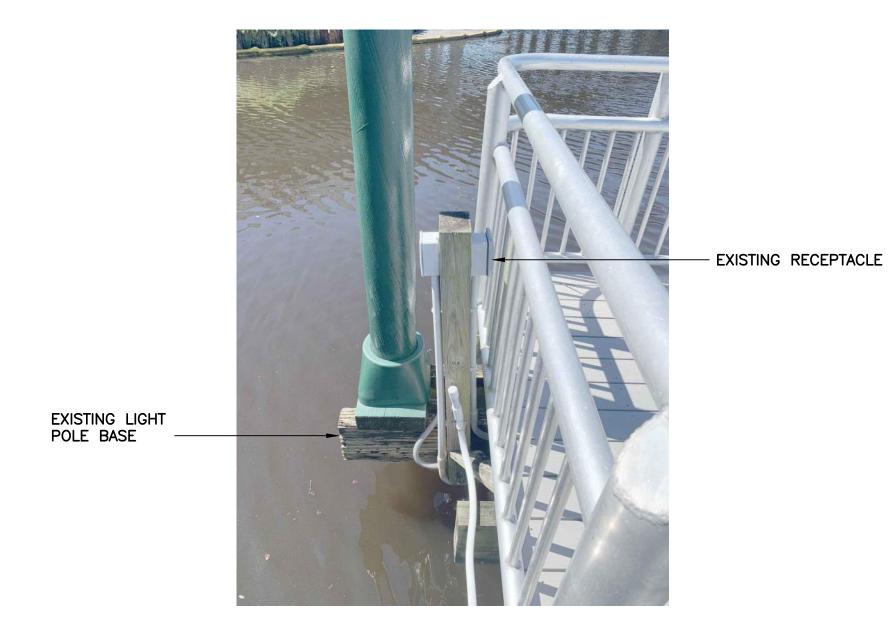


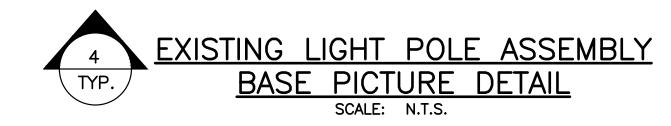



EXISTING RECEPTACLE
PICTURE DETAIL
SCALE: N.T.S.




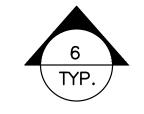

EXISTING PULL BOX PICTURE DETAIL

Electrical Design Associates 7284 W. Palmetto Park Road, SUITE 302-S
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Florida P.E. No. 70851

D 47.5	DV.		SIONS	DV	DECCRIPTION	-Kimley»Horn			SHEET
DATE	BY	DESCRIPTION	DATE	ВТ	<u>DESCRIPTION</u>	<b>,</b>	CITY OF PORT ST. LUCIE	ELECTRICAL PICTURE DETAILS	NO.
						JERRY MARCUS PICCOLO, P.E. P.E. LICENSE NUMBER 80484 1920 WEKIVA WAY, SUITE 200 WEST PALM BEACH, FL 33411 (561) 845-0665 REGISTRY NO. 35106	PARKS AND RECREATION	RIVERWALK BOARDWALK REHABILITATION	E-19

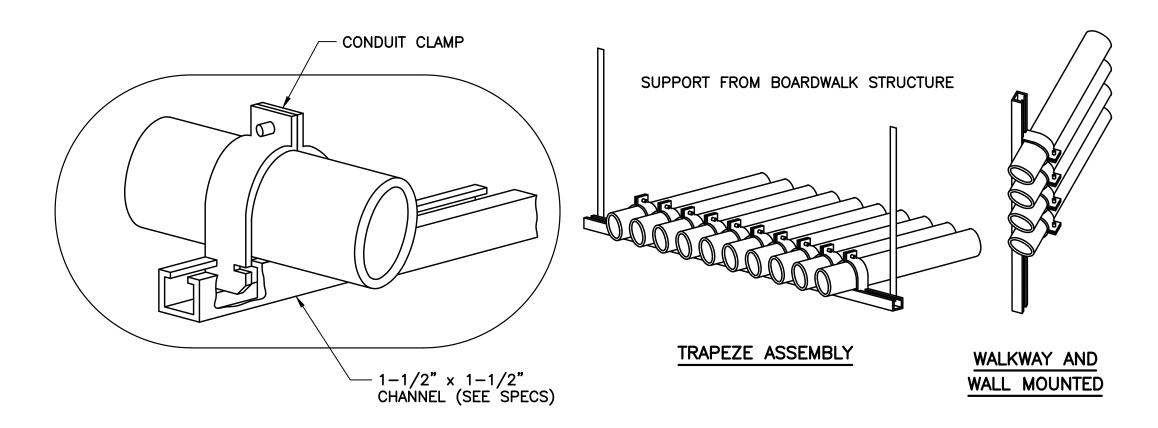

NOTES:

1 ALL MOUNTING HARDWARE SHALL BE 316 SS, UNLESS OTHERWISE NOTED.



REFER TO SHEETS
S-22 & S-23
FOR ADDITIONAL
ELECTRICAL DETAILS



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DATE BY	R E V . DESCRIPTION	ISIONS  DATE BY	DESCRIPTION	— Kimley» Horn  JERRY MARCUS PICCOLO, P.E.	CITY OF PORT ST. LUCIE	ELECTRICAL DETAILS	SHEET NO.
				P.E. LICENSE NUMBER 80484 1920 WEKIVA WAY, SUITE 200 WEST PALM BEACH, FL 33411 (561) 845-0665	PARKS AND RECREATION	RIVERWALK BOARDWALK REHABILITATION	E-20

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