


# CONSTRUCTION PLANS FOR: VERANO SOUTH - POD C, PLAT 2


OWNER:

VERANO DEVELOPMENT, LLC

## LOCATION MAP

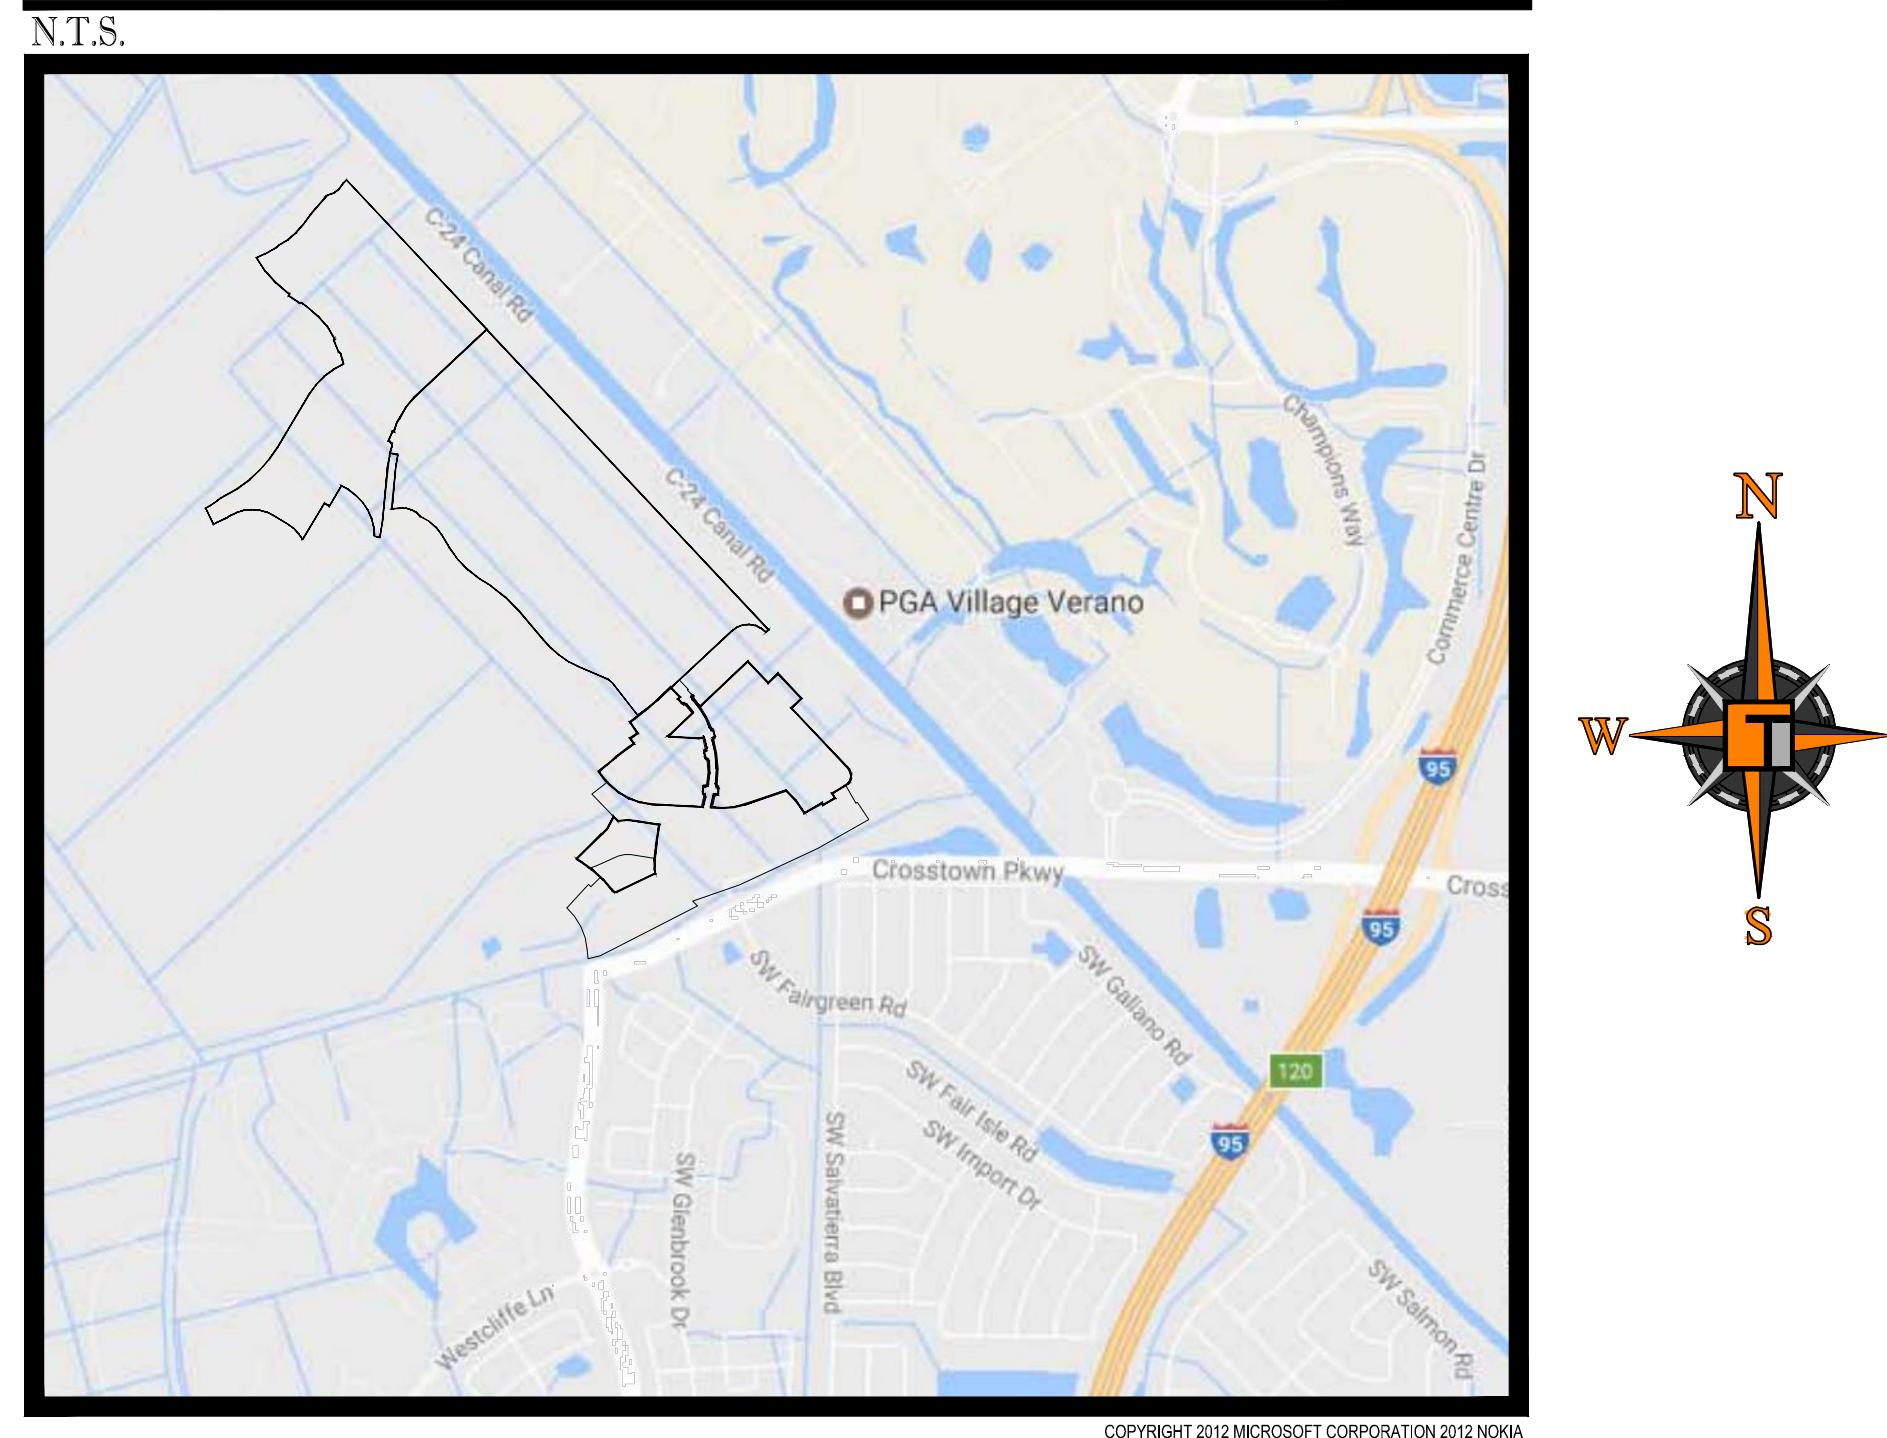

## VICINITY \ AERIAL MAP

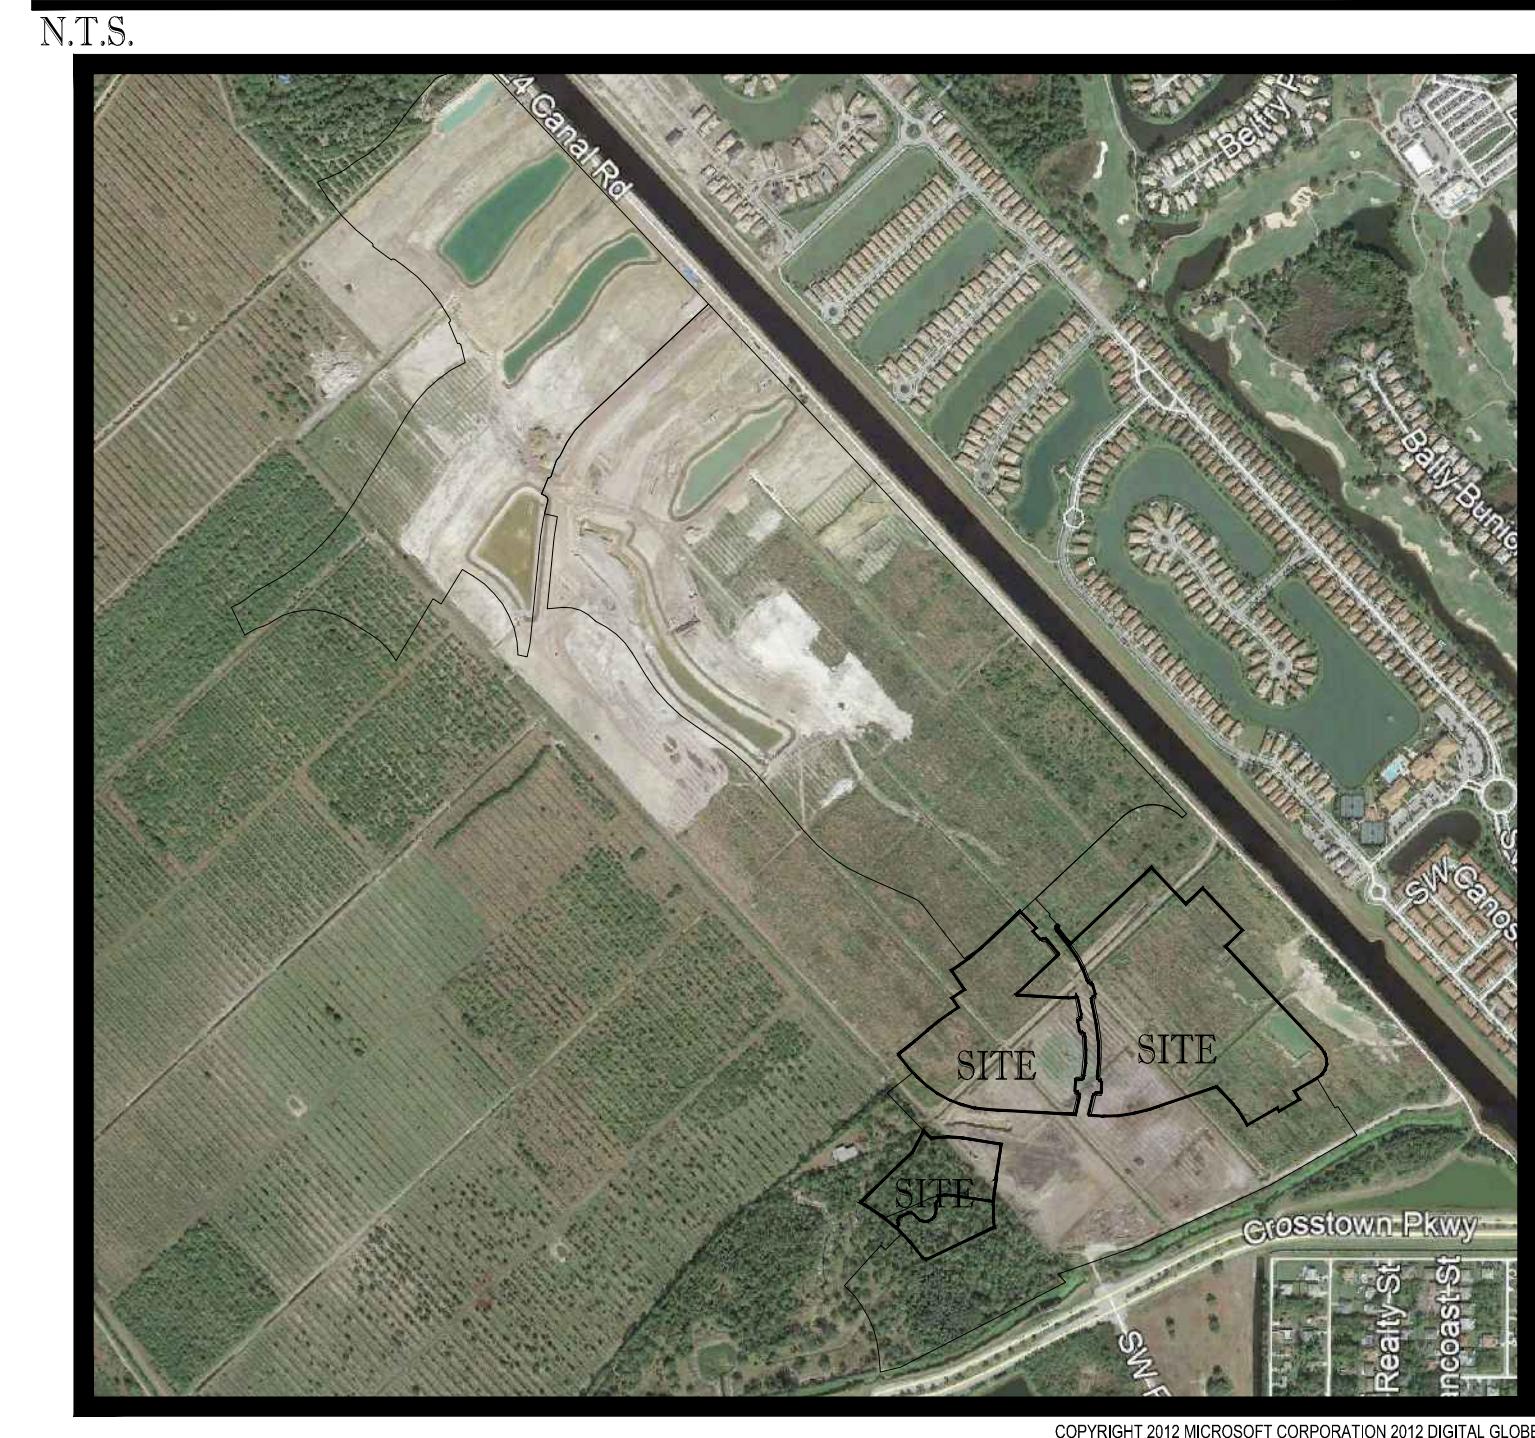

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## PROJECT TEAM

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JUPITER, FL 33458  
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**LANDSCAPE ARCHITECT/PLANNER:**  
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561-697-7024  
CONTACT: WILBUR (BUR) DIVINE



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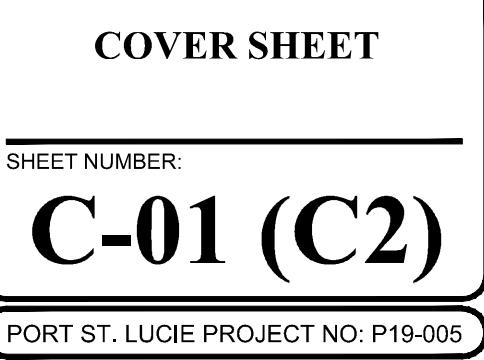
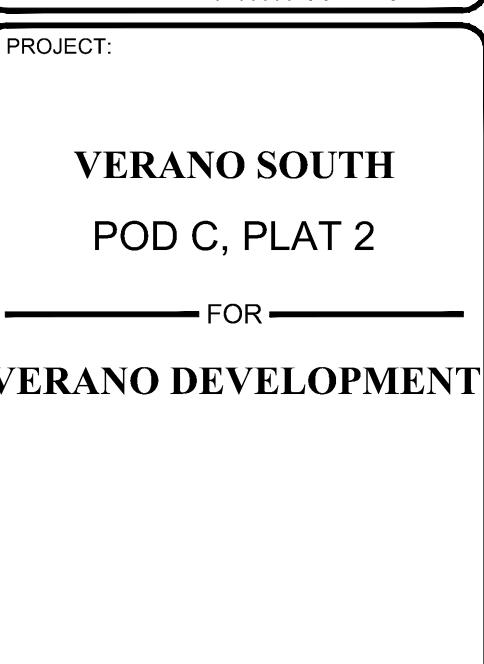
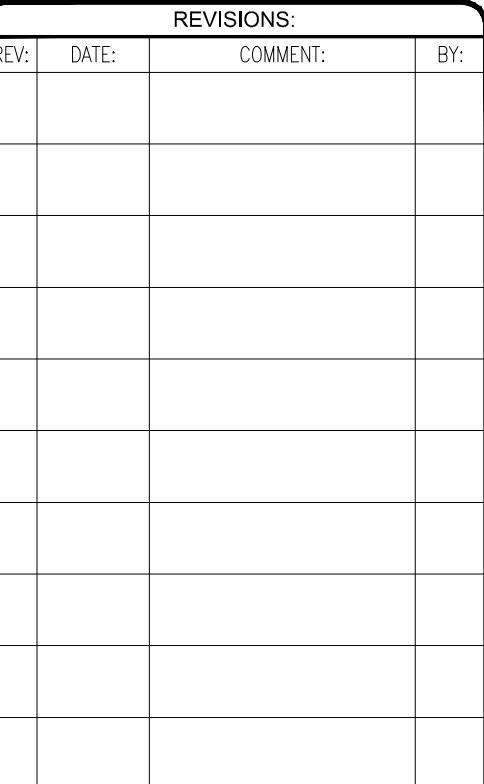
PH: (561) 203-7503  
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THE PROPERTY OWNER, CONTRACTOR, AND AUTHORIZED REPRESENTATIVES SHALL PROVIDE PICKUP, REMOVAL, AND DISPOSAL OF LITTER WITHIN THE PROJECT LINE WITHIN THE CITY'S RIGHT-OF-WAY IN ACCORDANCE WITH CITY CODE, SECTION 41.08 (G)

The contractor and EOR shall ensure that a copy of the Utility Standards Manual, including Standard Details, is available at the project at all times.

PSLUSD PROJECT NO: 11-652-32C  
ELEVATIONS BASED ON NAVD '88



## GENERAL NOTES:

CONTRACTOR IS RESPONSIBLE FOR COMPLIANCE WITH THE NOTES AND SPECIFICATIONS CONTAINED HEREIN. CONTRACTOR SHALL BE RESPONSIBLE TO ENSURE CONFORMANCE TO THESE REQUIREMENTS BY ALL SUBCONTRACTORS.

1. THE FOLLOWING DOCUMENTS ARE INCORPORATED BY REFERENCE AS PART OF THIS SITE PLAN:

- BOUNDARY SURVEY - ARCADIS

PRIOR TO THE START OF CONSTRUCTION, THE CONTRACTOR SHALL VERIFY THAT HE/SHE HAS THE LATEST EDITION OF THE DOCUMENTS REFERENCED ABOVE.

2. ALL HANDICAPPED PARKING SPACES SHALL BE CONSTRUCTED TO MEET, AT A MINIMUM, THE MORE STRINGENT OF THE REQUIREMENTS OF THE "AMERICANS WITH DISABILITIES ACT" (ADA) CODE (42 U.S.C. SEC. 12101 ET SEQ. AND 42 U.S.C. SEC. 4131 ET SEQ.) OR THE REQUIREMENTS OF THE JURISDICTION WHERE THIS PROJECT IS TO BE CONSTRUCTED.

3. PRIOR TO STARTING CONSTRUCTION, THE CONTRACTOR SHALL BE RESPONSIBLE TO ENSURE THAT ALL REQUIRED PERMITS AND APPROVALS HAVE BEEN OBTAINED. NO CONSTRUCTION OR FABRICATION SHALL BEGIN UNTIL THE CONTRACTOR HAS RECEIVED AND THOROUGHLY REVIEWED THE COMMENTS TO ALL PLANS AND OTHER DOCUMENTS REVIEWED AND APPROVED BY THE PERMITTING AUTHORITIES. CONTRACTOR SHALL HAVE COPIES OF ALL PERMITS AND APPROVALS ON SITE AT ALL TIMES.

4. THE OWNER/CONTRACTOR SHALL BE FAMILIAR WITH AND RESPONSIBLE FOR THE PROCUREMENT OF ANY AND ALL CERTIFICATIONS REQUIRED FOR THE ISSUANCE OF A CERTIFICATE OF OCCUPANCY.

5. ALL WORK SHALL BE PERFORMED IN ACCORDANCE WITH THESE PLANS AND SPECIFICATIONS AND ALL APPLICABLE REQUIREMENTS AND STANDARDS OF ALL GOVERNMENTAL ENTITIES HAVING JURISDICTION OVER THIS PROJECT.

6. THE GEOTECHNICAL REPORT AND RECOMMENDATIONS SET FORTH HEREIN ARE A PART OF THE REQUIRED CONSTRUCTION DOCUMENTS AND, IN CASE OF CONFLICT, SHALL TAKE PRECEDENCE UNLESS SPECIFICALLY NOTED OTHERWISE ON THE PLANS. THE CONTRACTOR SHALL NOTIFY THE ENGINEER IN WRITING OF ANY SUCH DISCREPANCY BETWEEN THE GEOTECHNICAL REPORTS AND PLANS AND SPECIFICATIONS PRIOR TO PROCEEDING WITH ANY FURTHER WORK.

7. THE BOUNDARY SURVEY PREPARED BY ARCADIS, SHALL BE CONSIDERED A PART OF THESE PLANS.

8. THESE PLANS ARE BASED ON INFORMATION PROVIDED TO THOMAS ENGINEERING BY THE OWNER AND OTHERS PRIOR TO THE TIME OF PLAN PREPARATION. CONTRACTOR SHALL FIELD VERIFY EXISTING CONDITIONS AND NOTIFY THOMAS ENGINEERING IF ACTUAL SITE CONDITIONS DIFFER FROM THOSE SHOWN ON THE PLAN, OR IF THE PROPOSED WORK CONFLICTS WITH ANY OTHER SITE FEATURES.

9. ALL DIMENSIONS SHOWN ON THE PLANS SHALL BE FIELD VERIFIED BY THE CONTRACTOR PRIOR TO THE START OF CONSTRUCTION. CONTRACTOR SHALL NOTIFY ENGINEER IN WRITING IF ANY DISCREPANCIES EXIST PRIOR TO PROCEEDING WITH CONSTRUCTION. NO EXTRA COMPENSATION SHALL BE PAID TO THE CONTRACTOR FOR WORK HAVING TO BE REDONE DUE TO DIMENSIONS OR GRADES SHOWN INCORRECTLY ON THESE PLANS PRIOR TO THE GIVING OF SUCH NOTIFICATION AND THE ENGINEER'S WRITTEN AUTHORIZATION OF SUCH ADDITIONAL WORK.

10. CONTRACTOR SHALL REFER TO THE ARCHITECTURAL/BUILDING PLANS FOR EXACT LOCATIONS AND DIMENSIONS OF ENTRY/EXIT POINTS, ELEVATIONS, PRECISE BUILDING DIMENSIONS, EXACT BUILDING UTILITY LOCATIONS.

11. PRIOR TO THE START OF CONSTRUCTION, THE CONTRACTOR SHALL COORDINATE THE BUILDING LAYOUT BY CAREFUL REVIEW OF THE SITE PLAN AND LATEST ARCHITECTURAL PLANS (INCLUDING, BUT NOT LIMITED TO, STRUCTURAL, MECHANICAL, ELECTRICAL, PLUMBING AND FIRE SUPPRESSION PLAN, WHERE APPLICABLE). CONTRACTOR SHALL IMMEDIATELY NOTIFY OWNER, ARCHITECT AND SITE ENGINEER OF ANY DISCREPANCIES.

12. DEBRIS SHALL NOT BE BURIED ON THE SUBJECT SITE AND ALL UNSUITABLE EXCAVATED MATERIAL AND DEBRIS (SOLID WASTE) SHALL BE DISPOSED OF IN ACCORDANCE WITH THE REQUIREMENTS OF ALL GOVERNMENTAL AUTHORITIES HAVING JURISDICTION OVER THIS PROJECT.

13. THE CONTRACTOR IS RESPONSIBLE FOR ALL SHORING REQUIRED DURING EXCAVATION (TO BE PERFORMED IN ACCORDANCE WITH CURRENT OSHA STANDARDS) AND ANY ADDITIONAL PRECAUTIONS TO BE TAKEN TO ASSURE THE STABILITY OF ADJACENT AND CONTOGIOUS STRUCTURES.

14. THE CONTRACTOR IS TO EXERCISE EXTREME CARE WHEN PERFORMING ANY WORK ACTIVITIES ADJACENT TO PAVEMENT, STRUCTURES, ETC. WHICH ARE TO REMAIN. CONTRACTOR SHALL BE RESPONSIBLE FOR TAKING THE APPROPRIATE MEASURES REQUIRED TO ENSURE THE STRUCTURAL STABILITY OF SIDEWALKS AND PAVEMENT, ETC. WHICH ARE TO REMAIN, AND TO PROVIDE A SAFE WORK AREA.

15. THE CONTRACTOR IS RESPONSIBLE FOR REPAIRING ANY DAMAGE DONE TO ANY NEW OR EXISTING CONSTRUCTION OR PROPERTY DURING THE COURSE OF CONSTRUCTION, INCLUDING BUT NOT LIMITED TO DRAINAGE, UTILITIES, PAVEMENT, STRIPING, CURB, ETC. THE CONTRACTOR SHALL BE RESPONSIBLE FOR AND SHALL REPLACE ANY SIGNAL, INTERCONNECTION CABLE, WIRING, DUCTS, AND ANY UNDERGROUND ACCESS EQUIPMENT DAMAGED DURING CONSTRUCTION. THE REPAIR OF ANY NEW OR EXISTING CONSTRUCTION OR PROPERTY SHALL RESTORE SUCH CONSTRUCTION OR PROPERTY TO A CONDITION EQUIVALENT TO OR BETTER THAN THE EXISTING CONDITIONS, AND IN CONFORMANCE WITH APPLICABLE CODES. CONTRACTOR IS RESPONSIBLE TO DOCUMENT ALL EXISTING DAMAGE AND NOTIFY THE OWNER AND THE CONSTRUCTION MANAGER PRIOR TO THE START OF CONSTRUCTION.

16. ALL CONCRETE SHALL HAVE THE MINIMUM COMPRESSIVE STRENGTH OF 3,500 PSI AT 28 DAYS UNLESS OTHERWISE NOTED ON THE PLANS, DETAILS AND/OR GEOTECHNICAL REPORT.

17. THE ENGINEER IS NOT RESPONSIBLE FOR CONSTRUCTION METHODS / MEANS FOR COMPLETION OF THE WORK DEPICTED NEITHER ON THESE PLANS, NOR FOR ANY CONFLICTS/SCOPE REVISIONS WHICH RESULT FROM SAME. CONTRACTOR IS RESPONSIBLE FOR DETERMINING THE METHODS/MEANS FOR COMPLETION OF THE WORK PRIOR TO THE COMMENCEMENT OF CONSTRUCTION.

18. THE ENGINEER OF RECORD IS NOT RESPONSIBLE FOR JOB SITE SAFETY NOR HAS THE ENGINEER OF RECORD BEEN RETAINED FOR SUCH PURPOSES.

19. ALL CONTRACTORS MUST CARRY THE SPECIFIED STATUTORY WORKER'S COMPENSATION INSURANCE, EMPLOYER'S LIABILITY INSURANCE AND LIMITS OF COMMERCIAL GENERAL LIABILITY INSURANCE (CGL). ALL CONTRACTORS MUST HAVE THEIR CGL POLICIES ENDORSED TO NAME Thomas ENGINEERING, AND ITS SUB-CONSULTANTS AS ADDITIONAL NAMED INSURERS AND TO PROVIDE CONTRACTUAL LIABILITY COVERAGE SUFFICIENT TO INSURE THIS HOLD HARMLESS AND INDEMNITY OBLIGATIONS ASSUMED BY THE CONTRACTORS. ALL CONTRACTORS MUST FURNISH Thomas ENGINEERING WITH CERTIFICATIONS OF INSURANCE AS EVIDENCE OF THE REQUIRED INSURANCE PRIOR TO COMMENCING WORK AND UPON RENEWAL OF EACH POLICY DURING THE ENTIRE PERIOD OF CONSTRUCTION. IN ADDITION, ALL CONTRACTORS WILL, TO THE FULLEST EXTENT PERMITTED BY LAW, INDEMNIFY AND HOLD HARMLESS Thomas ENGINEERING AND ITS SUB-CONSULTANTS FROM AND AGAINST ANY DAMAGES, LIABILITIES OR COSTS, INCLUDING REASONABLE ATTORNEYS' FEES AND DEFENSE COSTS, ARISING OUT OF OR IN ANY WAY CONNECTED WITH THE PROJECT, INCLUDING ALL CLAIMS BY EMPLOYEES OF THE CONTRACTORS.

20. Thomas ENGINEERING WILL REVIEW AND APPROVE OR TAKE OTHER APPROPRIATE ACTION ON THE CONTRACTOR SUBMITTALS, SUCH AS SHOP DRAWINGS, PRODUCT DATA, SAMPLES, AND OTHER DATA, WHICH THE CONTRACTOR IS REQUIRED TO SUBMIT, BUT ONLY FOR THE LIMITED PURPOSE OF CHECKING FOR CONFORMANCE WITH THE DESIGN INTENT AND THE INFORMATION SHOWN IN THE CONSTRUCTION CONTRACT DOCUMENTS. CONSTRUCTION MEANS AND/OR METHODS, COORDINATION OF THE WORK WITH OTHER TRADES, AND CONSTRUCTION SAFETY PRECAUTIONS ARE THE SOLE RESPONSIBILITY OF THE CONTRACTOR. Thomas ENGINEERING'S SHOP DRAWING REVIEW WILL BE CONDUCTED WITH REASONABLE PROMPTNESS WHILE ALLOWING SUFFICIENT TIME TO PERMIT ADEQUATE REVIEW. REVIEW OF A SPECIFIC ITEM SHALL NOT INDICATE THAT Thomas ENGINEERING HAS REVIEWED THE ENTIRE ASSEMBLY OF WHICH THE ITEM IS A COMPONENT. Thomas ENGINEERING WILL NOT BE RESPONSIBLE FOR ANY DEVIATIONS FROM THE CONSTRUCTION DOCUMENTS NOT BROUGHT TO ITS ATTENTION, IN WRITING, BY THE CONTRACTOR. Thomas ENGINEERING WILL NOT BE REQUIRED TO REVIEW PARTIAL SUBMISSIONS OR THOSE FOR WHICH SUBMISSIONS OF CORRELATED ITEMS HAVE NOT BEEN RECEIVED.

21. NEITHER THE PROFESSIONAL ACTIVITIES OF THOMAS ENGINEERING, NOR THE PRESENCE OF THOMAS ENGINEERING OR ITS EMPLOYEES AND SUB-CONSULTANTS AT A CONSTRUCTION / PROJECT SITE, SHALL RELIEVE THE GENERAL CONTRACTOR OF ITS OBLIGATIONS, DUTIES AND RESPONSIBILITIES INCLUDING, BUT NOT LIMITED TO, CONSTRUCTION MEANS, METHODS, SEQUENCE, TECHNIQUES OR PROCEDURES NECESSARY FOR PERFORMING, SUPERVISING AND COORDINATING THE WORK IN ACCORDANCE WITH THE CONTRACT DOCUMENTS AND ANY HEALTH OR SAFETY PRECAUTIONS REQUIRED BY ANY REGULATORY AGENCIES. THOMAS ENGINEERING AND ITS PERSONNEL HAVE NO AUTHORITY TO EXERCISE ANY CONTROL OVER ANY CONSTRUCTION CONTRACTOR OR ITS EMPLOYEES. CONNECTION WITH THE WORK, OR CONSTRUCTION, SAFETY, OR SCAFFOLDING PROGRAMS, OR PROCEDURES. THE GENERAL CONTRACTOR SHALL BE SOLELY RESPONSIBLE FOR JOB SITE SAFETY. THOMAS ENGINEERING SHALL BE INDEMNIFIED BY THE GENERAL CONTRACTOR AND SHALL BE NAMED AN ADDITIONAL INSURED UNDER THE GENERAL CONTRACTOR'S POLICIES OF GENERAL LIABILITY INSURANCE.

22. IF THE CONTRACTOR DEVIATES FROM THE PLANS AND SPECIFICATIONS, INCLUDING THE NOTES CONTAINED HEREIN, WITHOUT FIRST OBTAINING THE PRIOR WRITTEN AUTHORIZATION OF THE ENGINEER

FOR SUCH DEVIATIONS, CONTRACTOR SHALL BE SOLELY RESPONSIBLE FOR THE PAYMENT OF ALL COSTS INCURRED IN CORRECTING ANY WORK DONE WHICH DEVIATES FROM THE PLANS, ALL FINES AND/OR PENALTIES ASSESSED WITH RESPECT THERETO AND ALL COMPENSATORY OR PUNITIVE DAMAGES RESULTING THEREFROM. THE CONTRACTOR SHALL INDEMNIFY AND HOLD THE OWNER AND ENGINEER HARMLESS FROM ALL SUCH COSTS RELATED TO SAME.

23. CONTRACTOR IS RESPONSIBLE FOR MAINTENANCE AND PROTECTION OF TRAFFIC PLAN FOR ALL WORK THAT AFFECTS PUBLIC TRAVEL, EITHER IN THE R.O.W. OR ON SITE. THE COST FOR THIS ITEM SHOULD BE INCLUDED IN THE CONTRACTOR'S PRICE.

24. IF THE CONTRACTOR DEVIATES FROM THE PLANS AND SPECIFICATIONS, INCLUDING THE NOTES CONTAINED THEREON, WITHOUT FIRST OBTAINING PRIOR WRITTEN AUTHORIZATION FOR SUCH DEVIATIONS FROM THE OWNER AND ENGINEER, IT SHALL BE RESPONSIBLE FOR THE PAYMENT OF ALL COSTS TO CORRECT ANY WORK DONE, ALL FINES OR PENALTIES ASSESSED WITH RESPECT THERETO AND ALL COMPENSATORY OR PUNITIVE DAMAGES RESULTING THEREFROM. THE CONTRACTOR SHALL INDEMNIFY AND HOLD THE OWNER AND ENGINEER HARMLESS FROM ALL SUCH COSTS TO CORRECT ANY SUCH WORK AND FROM ALL SUCH FINES AND PENALTIES, COMPENSATION AND PUNITIVE DAMAGES AND COSTS OF ANY NATURE RESULTING THEREFROM.

25. CONTRACTOR SHALL CONFIRM ADA ACCESSIBILITY PRIOR TO INSTALLING FINISHING COURSES OF SIDEWALKS AND PARKING AREAS.

26. UPON THE RECEIPT OF THE "NOTICE TO PROCEED", THE CONTRACTOR SHALL CONTACT THE ENGINEER OF RECORD AND ARRANGE A RECONSTRUCTION CONFERENCE TO INCLUDE ALL INVOLVED GOVERNMENTAL AGENCIES, UTILITY OWNERS, THE OWNER AND THE ENGINEER OF RECORD.

27. CONTRACTOR SHALL PROVIDE MINIMUM 48 HOUR NOTICE TO ENGINEER AND APPLICABLE AGENCIES FOR SCHEDULING INSPECTIONS.

28. PRIOR TO THEIR CONSTRUCTION OR INSTALLATION, SHOP DRAWINGS SHALL BE SUBMITTED TO AND APPROVED BY THE ENGINEER OF RECORD AND CITY OF PORT ST LUCIE FOR THE FOLLOWING: CATCH BASINS, FIRE HYDRANTS, VALVES, AND ALL REQUIRED ACCESSORIES. IT IS THE RESPONSIBILITY OF THE CONTRACTOR TO OBTAIN ALL OTHER AGENCY APPROVALS IF REQUIRED.

29. IT SHALL BE THE CONTRACTOR'S RESPONSIBILITY TO ARRANGE FOR OR SUPPLY TEMPORARY WATER SERVICE, SANITARY FACILITIES AND ELECTRICITY.

30. MAINTENANCE OF TRAFFIC IN THE PUBLIC RIGHTS-OF-WAY SHALL BE IN ACCORDANCE WITH M.U.T.C.D. AND APPROVED BY CITY OF PORT ST LUCIE WHERE APPLICABLE PRIOR TO IMPLEMENTATION.

31. ALL OPEN TRENCHES AND HOLES ADJACENT TO ROADWAYS OR WALKWAYS SHALL BE PROPERLY MARKED AND BARRICADED TO ASSURE THE SAFETY OF BOTH VEHICULAR AND PEDESTRIAN TRAFFIC.

32. NO TRENCHES OR HOLES NEAR WALKWAYS, IN ROADWAYS OR THEIR SHOULDERS ARE THE LEFT OPEN DURING NIGHTTIME HOURS WITHOUT EXPRESS PERMISSION FROM CITY OF PORT ST LUCIE.

33. IT SHALL BE THE RESPONSIBILITY OF THE GENERAL CONTRACTOR FOR ANY NECESSARY CONSTRUCTION, PAVEMENT MARKING AND SIGNAGE OR ANY PEDESTRIAN SIGNALIZATION AND/OR SIGNAL MODIFICATION TO ACCOMMODATE AN ALTERNATE SAFE WALK ROUTE. ALL RESTORED TRAFFIC CONTROL DEVICES SHALL BE IN ACCORDANCE WITH THE GOVERNING AGENCY'S TRAFFIC ENGINEERING STANDARDS.

34. CONTRACTOR SHALL STAKE EASEMENT, SIDEWALK, CURBING AND/OR ROAD RIGHT OF WAY LINES DURING CONSTRUCTION OF WATER, SEWER AND DRAINAGE FACILITIES THAT ARE REQUIRED TO LINE UP WITH ABOVE GROUND FACILITIES.

## SANITARY SEWER:

1. DISTANCE AND LENGTHS SHOWN ON PLANS REFERENCE THE CENTER OF STRUCTURES.

2. CONSTRUCTION AND INSTALLATION OF SANITARY SEWER SHALL FOLLOW CITY OF PORT ST LUCIE UTILITY DEPARTMENT MINIMUM CONSTRUCTION STANDARDS, LATEST EDITION

3. TESTING OF SANITARY SEWER SHALL BE BASED ON CITY OF PORT ST LUCIE UTILITY DEPARTMENT MINIMUM CONSTRUCTION STANDARDS, LATEST EDITION

## WATER DISTRIBUTION AND/OR SANITARY SEWER FORCEMAN SYSTEM

1. NO CONNECTIONS TO THE EXISTING LINES SHALL BE MADE UNTIL PRESSURE TESTS, FOR THE WATER AND SEWER FORCE MAINS, AND BACTERIOLOGICAL TESTS HAVE BEEN PERFORMED AND THE SYSTEM IS ACCEPTABLE TO CITY OF PORT ST LUCIE UTILITY DEPARTMENT.

2. CONSTRUCTION AND INSTALLATION OF WATERMAIN SHALL FOLLOW CITY OF PORT ST LUCIE UTILITIES DEPARTMENT MINIMUM CONSTRUCTION STANDARDS, LATEST EDITION

3. TESTING OF WATERMAIN SHALL BE BASED ON CITY OF PORT ST LUCIE UTILITIES DEPARTMENT MINIMUM CONSTRUCTION STANDARDS, LATEST EDITION

4. ALL WATER MAIN PIPE, INCLUDING FITTINGS, INSTALLED ON OR AFTER AUGUST 28, 2003, EXCEPT PIPE INSTALLED UNDER A CONSTRUCTION PERMIT FOR WHICH THE DEPARTMENT RECEIVED A COMPLETE APPLICATION BEFORE AUGUST 28, 2003, SHALL BE COLOR CODED, OR MARKED USING BLUE AS A PREDOMINANT COLOR TO DIFFERENTIATE DRINKING WATER FROM RECLAIMED OR OTHER WATER. UNDERGROUND PLASTIC PIPE SHALL BE SOLID-WALL BLUE PIPE, SHALL HAVE A CO-EXTRUDED BLUE EXTERNAL SKIN, OR SHALL BE WHITE OR BLACK PIPE WITH BLUE STRIPES INCORPORATED INTO, OR APPLIED TO, THE PIPE WALL; AND UNDERGROUND METAL OR CONCRETE PIPE SHALL HAVE BLUE STRIPES APPLIED TO THE PIPE WALL. PIPE STRIPED DURING MANUFACTURING OF THE PIPE SHALL HAVE CONTINUOUS STRIPES THAT RUN PARALLEL TO THE AXIS OF THE PIPE, THAT ARE LOCATED AT NO GREATER THAN 90-DEGREE INTERVALS AROUND THE PIPE, AND THAT WILL REMAIN INTACT DURING AND AFTER INSTALLATION OF THE PIPE. IF TAPE OR PAINT SHALL BE APPLIED IN A CONTINUOUS LINE THAT RUNS PARALLEL TO THE AXIS OF THE PIPE AND THAT IS LOCATED ALONG THE TOP OF THE PIPE; FOR PIPES WITH AN INTERNAL DIAMETER OF 24 INCHES OR GREATER, TAPE OR PAINT SHALL BE APPLIED IN CONTINUOUS LINES ALONG EACH SIDE OF THE PIPE AS WELL AS ALONG THE TOP OF THE PIPE. ABOVEGROUND PIPE AT DRINKING WATER TREATMENT PLANTS SHALL BE COLOR CODED AND LABELED IN ACCORDANCE WITH SUBSECTION 62-555.320(10), F.A.C., AND ALL OTHER ABOVEGROUND PIPE SHALL BE PAINTED BLUE OR SHALL BE COLOR CODED OR MARKED LIKE UNDERGROUND PIPE.

## SEPARATION OF WATER AND SEWER MAINS:

1. SEPARATION OF WATER, SEWER, AND STORM SHALL BE BASED ON CITY OF PORT ST LUCIE UTILITY DEPARTMENT MINIMUM CONSTRUCTION STANDARDS AND SHALL MEET THE LATEST F.A.C. 62-555.314

2. ALL PSLUSD PIPES SHALL HAVE A MINIMUM HORIZONTAL SEPARATION OF 5' FROM ALL OTHER UNDERGROUND UTILITIES AND A VERTICAL SEPARATION OF AT LEAST 18". SEE PSLUSD UTILITY STANDARDS MANUAL FOR ADDITIONAL SPECS.

## STORM DRAINAGE:

### GENERAL:

1. CATCH BASIN GRATES AND RIM ELEVATIONS AS SHOWN ON PLANS SHALL BE ADJUSTED TO CONFORM TO NEW OR EXISTING GRADES.

2. DISTANCES AND LENGTHS SHOWN ON PLANS REFERENCE INSIDE WALLS OF THE STRUCTURE.

3. ALL HIGH DENSITY POLYETHYLENE PIPE AND FITTINGS SHALL MEET THE REQUIREMENTS OF AASHTO M - 294 LATEST REVISIONS. ALL PIPING TO BE NON-PERFORATED TUBING, EXCEPT WHERE EXTRUSION TRENCH IS PROPOSED.

4. ALL YARD DRAIN BASINS ARE TO BE HIGH DENSITY POLYETHYLENE PRODUCT AND SHALL MEET ASTM LATEST MINIMUM STANDARDS.

5. ALL DRAINAGE CATCH BASINS AND STRUCTURES SHALL BE PRECAST CONCRETE AND SHALL MEET THE REQUIREMENTS OF A.S.T.M. SPECIFICATION C-478 AND 64T, UNLESS OTHERWISE NOTED IN THE PLANS. NO BLOCK CATCH BASINS WILL BE ALLOWED. THE MINIMUM WALL AND SLAB THICKNESS SHALL BE 8 INCHES AND THE MINIMUM REINFORCING SHALL BE NO. 4 BARS AT 12 INCHES EACH WAY UNLESS OTHERWISE INDICATED. CONCRETE SHALL BE MINIMUM OF f<sub>c</sub>=3750 PSI AT 28 DAYS.

6. THE CONTRACTOR SHALL FOLLOW CITY OF PORT ST LUCIE DETAILS FOR PIPE BACKFILL REQUIREMENTS SAID DETAIL IS INCLUDED IN THE DRAINAGE DETAIL SHEETS OF THIS PLAN SET

7. ALL PIPE JOINTS SHALL BE WRAPPED IN FILTER FABRIC

8. PROVIDE A MINIMUM PROTECTIVE COVER OF 30 INCHES OVER STORM SEWER AND AVOID UNNECESSARY CROSSING BY HEAVY CONSTRUCTION VEHICLES DURING CONSTRUCTION.

9. THE CONTRACTOR SHALL NOTIFY CITY OF PORT ST LUCIE ENGINEERING DEPARTMENT/ FDOT AND THE ENGINEER OF RECORD AT LEAST 7 DAYS PRIOR TO THE START OF THE CONSTRUCTION AND INSPECTION.

4. ELEVATIONS AROUND ISLAND AREAS WILL ALSO BE REQUIRED.

5. WHERE CONCRETE IS TO BE USED AS A FINISHED PRODUCT FOR THE ROADWAY OR PARKING LOT ROCK "AS-BUILTS" WILL BE REQUIRED AS INDICATED ABOVE, AS WELL AS "AS-BUILTS" ON THE FINISHED CONCRETE AT LOCATIONS WHERE THERE IS A FINISH GRADE ELEVATION SHOWN ON THE DESIGN PLANS.

6. "AS-BUILTS" SHALL BE TAKEN ON ALL PAVED AND UNPAVED SWALES, PRIOR TO PLACEMENT OF ASPHALT OR TOPSOIL/SOD, AT ENOUGH INTERMEDIATE POINTS TO CONFIRM SLOPE CONSISTENCY AND CONFORMANCE TO THE PLAN DETAILS.

K. UPON COMPLETION OF THE WORK, THE CONTRACTOR SHALL PREPARE RECORD DRAWINGS, "AS-BUILTS", BASED ON CITY OF PORT ST LUCIE UTILITY DEPARTMENT AND CITY OF PORT ST LUCIE ENGINEERING DEPARTMENT REQUIREMENTS AND SPECIFICATIONS.

## PROJECT CLOSEOUT:

### CLEANING UP:

1. DURING CONSTRUCTION, THE PROJECT SITE AND ALL ADJACENT AREAS SHALL BE MAINTAINED IN A NEAT AND CLEAN MANNER, AND UPON FINAL CLEAN-UP, THE PROJECT SITE SHALL BE LEFT CLEAR OF ALL SURPLUS MATERIAL OR TRASH. THE PAVED AREAS SHALL BE SWEEP BROOM CLEAN.

2. THE CONTRACTOR SHALL RESTORE OR REPLACE, WHEN AND AS DIRECTED, ANY PUBLIC OR PRIVATE PROPERTY DAMAGED BY HIS WORK, EQUIPMENT, OR EMPLOYEES, TO A CONDITION AT LEAST EQUAL TO THAT EXISTING IMMEDIATELY PRIOR TO THE BEGINNING OF OPERATIONS. TO THAT END, THE CONTRACTOR SHALL DO, AS REQUIRED, ALL NECESSARY HIGHWAY, DRIVEWAY, WALK AND LANDSCAPING WORK. SUITABLE MATERIALS AND METHODS SHALL BE USED FOR SUCH RESTORATION.

3. WHERE MATERIAL OR DEBRIS HAS BEEN WASHED OR FLOWED INTO OR HAS BEEN PLACED IN WATER COURSES, DITCHES, DRAINS, CATCH BASINS, OR ELSEWHERE AS A RESULT OF THE CONTRACTOR'S OPERATIONS, SUCH MATERIAL OR DEBRIS SHALL BE REMOVED AND SATISFACTORILY DISPOSED OF DURING THE PROGRESS OF THE WORK, AND THE AREA KEPT IN A CLEAN AND NEAT CONDITION.

4. ALL PROPERTY MONUMENTS OR PERMANENT REFERENCES, REMOVED OR DESTROYED BY THE CONTRACTOR DURING CONSTRUCTION SHALL BE RESTORED BY A STATE OF FLORIDA REGISTERED LAND SURVEYOR AND MAPPER AT THE CONTRACTOR'S EXPENSE.

5. ALL PAVED & UNPAVED SURFACES DISTURBED OR DAMAGED AS A RESULT OF CONSTRUCTION ACTIVITIES SHALL BE RESTORED TO A CONDITION EQUAL TO OR BETTER THAN THAT WHICH EXISTED BEFORE THE CONSTRUCTION.

REVISIONS:

REV: DATE: COMMENT: BY:

THOMAS ENGINEERING GROUP




CIVIL ENGINEERS - PROJECT MANAGERS - LAND PLANNING - LANDSCAPE ARCHITECTS

1000 CORPORATE DR.

SUITE 300

FT. LAUDERDALE, FL 33344

P: 954-202-7000

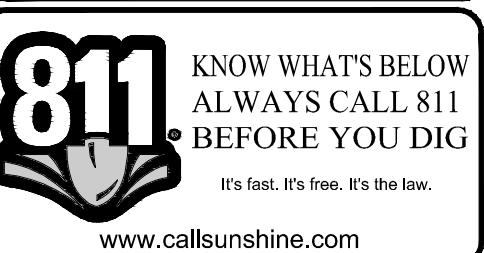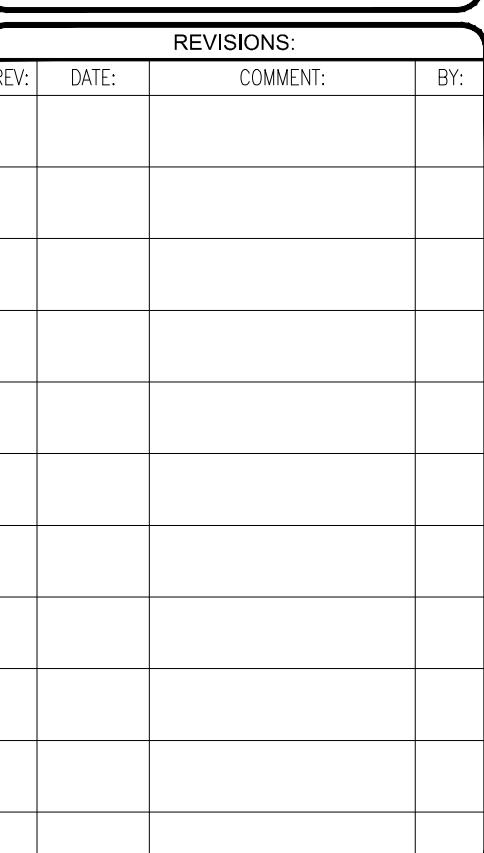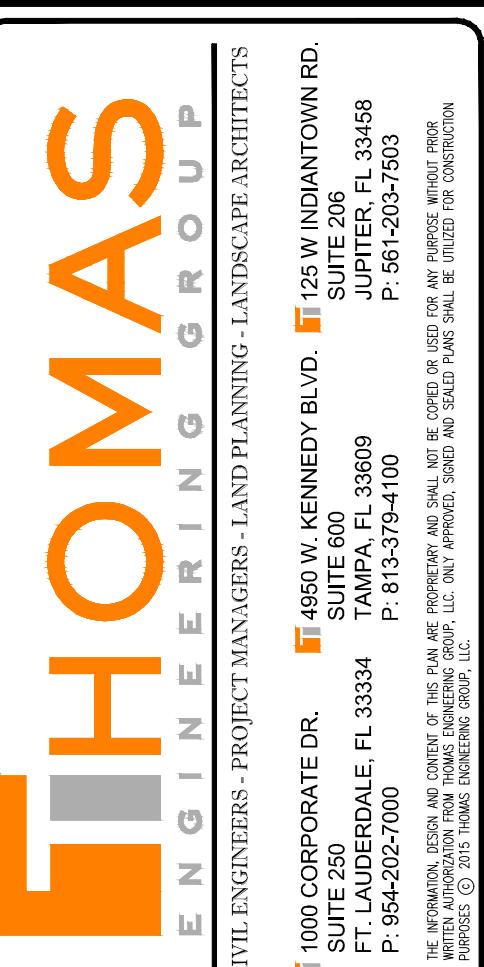

PROJECT No.:	FJ160006
DRAWN BY:	MJL
CHECKED BY:	BMU
DATE:	9-1-18
CAD I.D.:	FJ160006-KEY-SHEET




PROJECT: **VERANO SOUTH**  
POD C, PLAT 2  
FOR  
**VERANO DEVELOPMENT**

# PORT SAINT LUCIE FLORIDA

PEBWORTH PROFESSIONAL PLAZA  
125 W. INDIANTOWN RD, SUITE 206  
JUPITER, FL 33458  
PH: (561) 203-7503  
FX: (561) 203-7721

BRANDON M. ULMER  
No. 68345  
April 24, 2019  
FLORIDA LICENSE No. 68345  
FLORIDA BUSINESS CERT. OF AUTH. No. 27528

SHEET TITLE:	<b>KEY SHEET</b>	
<hr/>		
SHEET NUMBER:	<b>C-03 (C2)</b>	
<hr/>		
PORT ST. LUCIE PROJECT NO: P19-005		

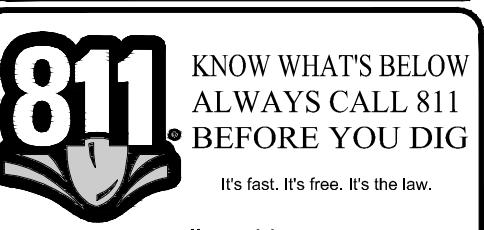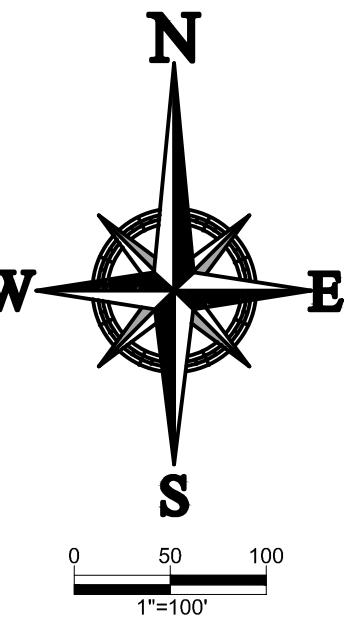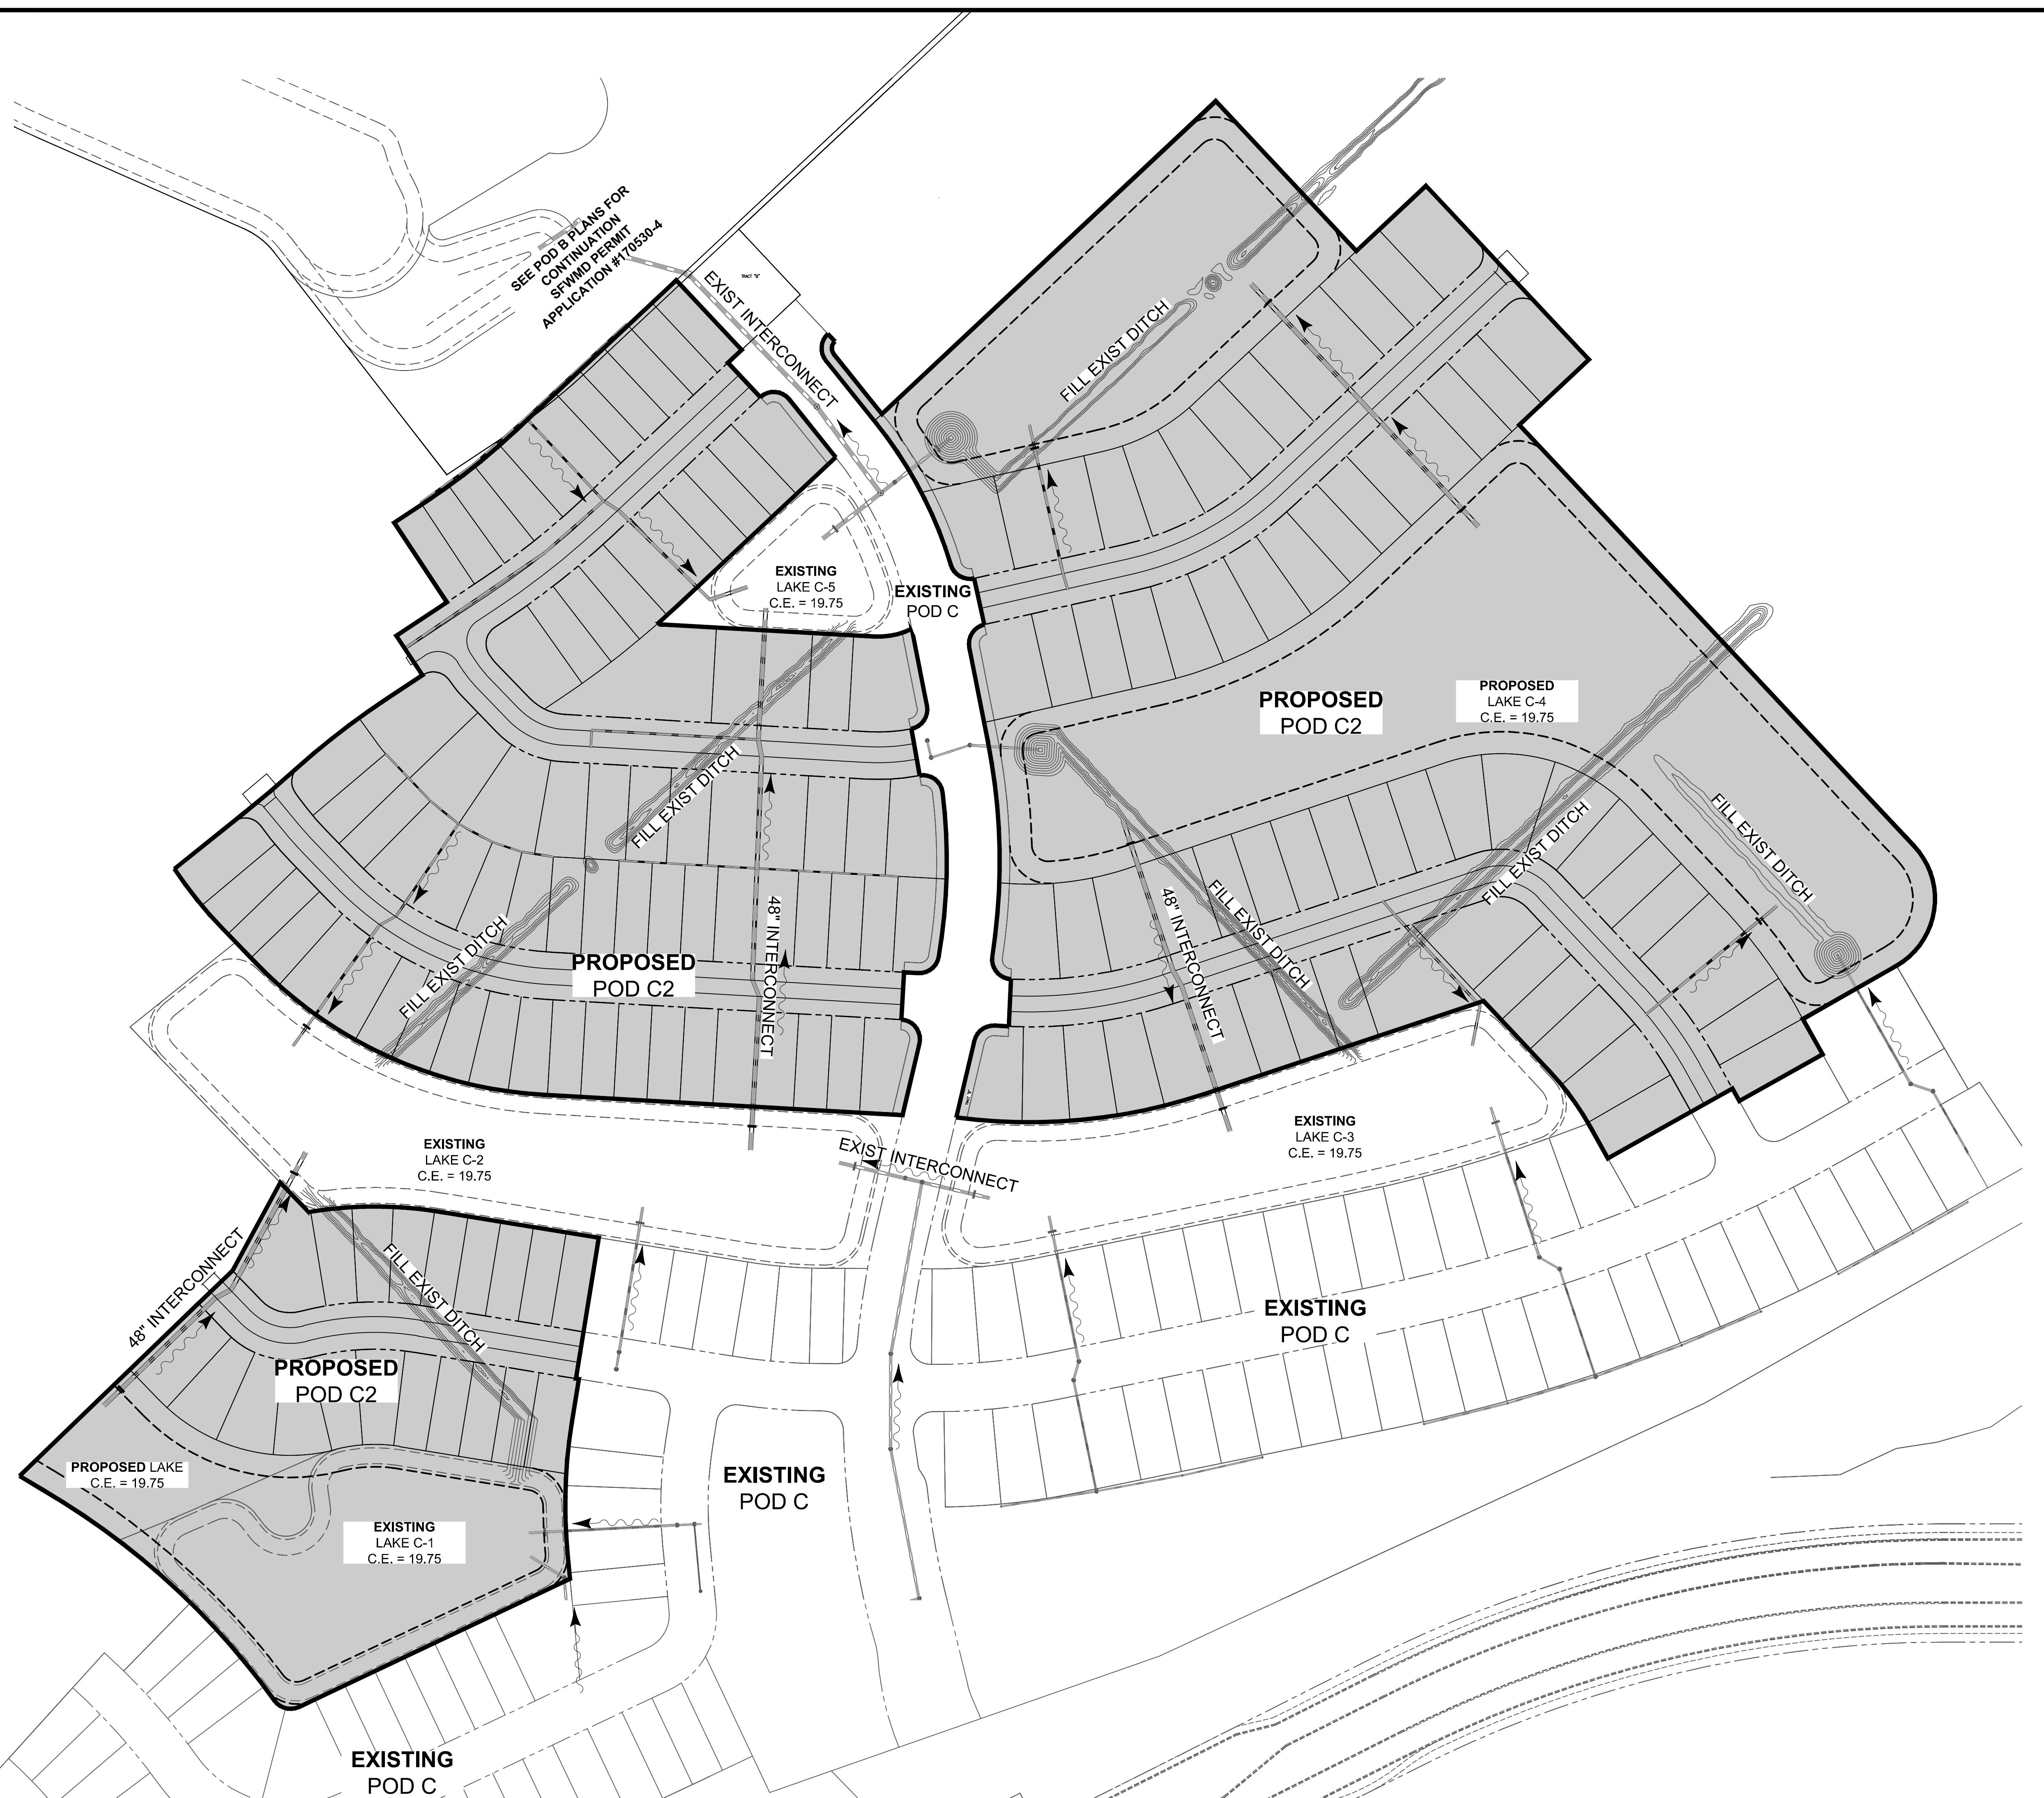

OBJECT No.: FJ160006  
AWN BY: MJL  
ECKED BY: BMU  
TE: 9-1-18  
D.I.D.: FJ160006-PHASING-MAP

PROJECT: **VERANO SOUTH**  
**POD C, PLAT 2**

---

FOR

**VERANO DEVELOPMENT**

## PORT SAINT LUCIE FLORIDA

PEBWORTH PROFESSIONAL PLAZA  
125 W. INDIANTOWN RD, SUITE 206  
JUPITER, FL 33458  
PH: (561) 203-7503  
FX: (561) 203-7721

BRANDON M. ULMER  
FLORIDA LICENSE NO. 68345  
No. 68345  
PROFESSIONAL ENGINEER  
April 24, 2019  
FLORIDA LICENSE NO. 68345  
FLORIDA BUSINESS CERT. OF AUTH. NO. 27528

EET TITLE: **PHASING PLAN**

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EET NUMBER: **C-04 (C2)**

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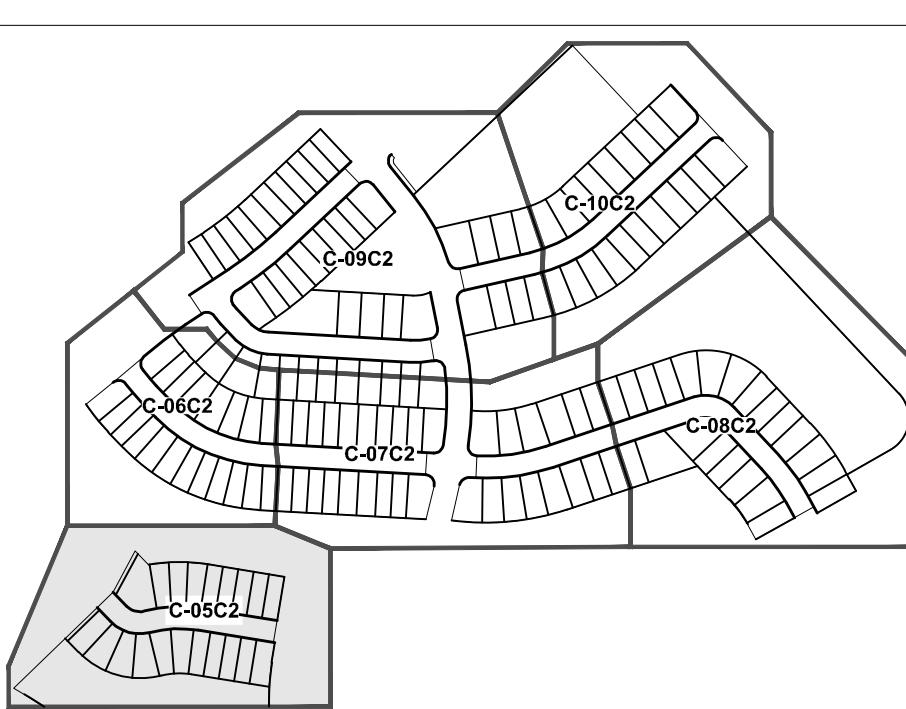
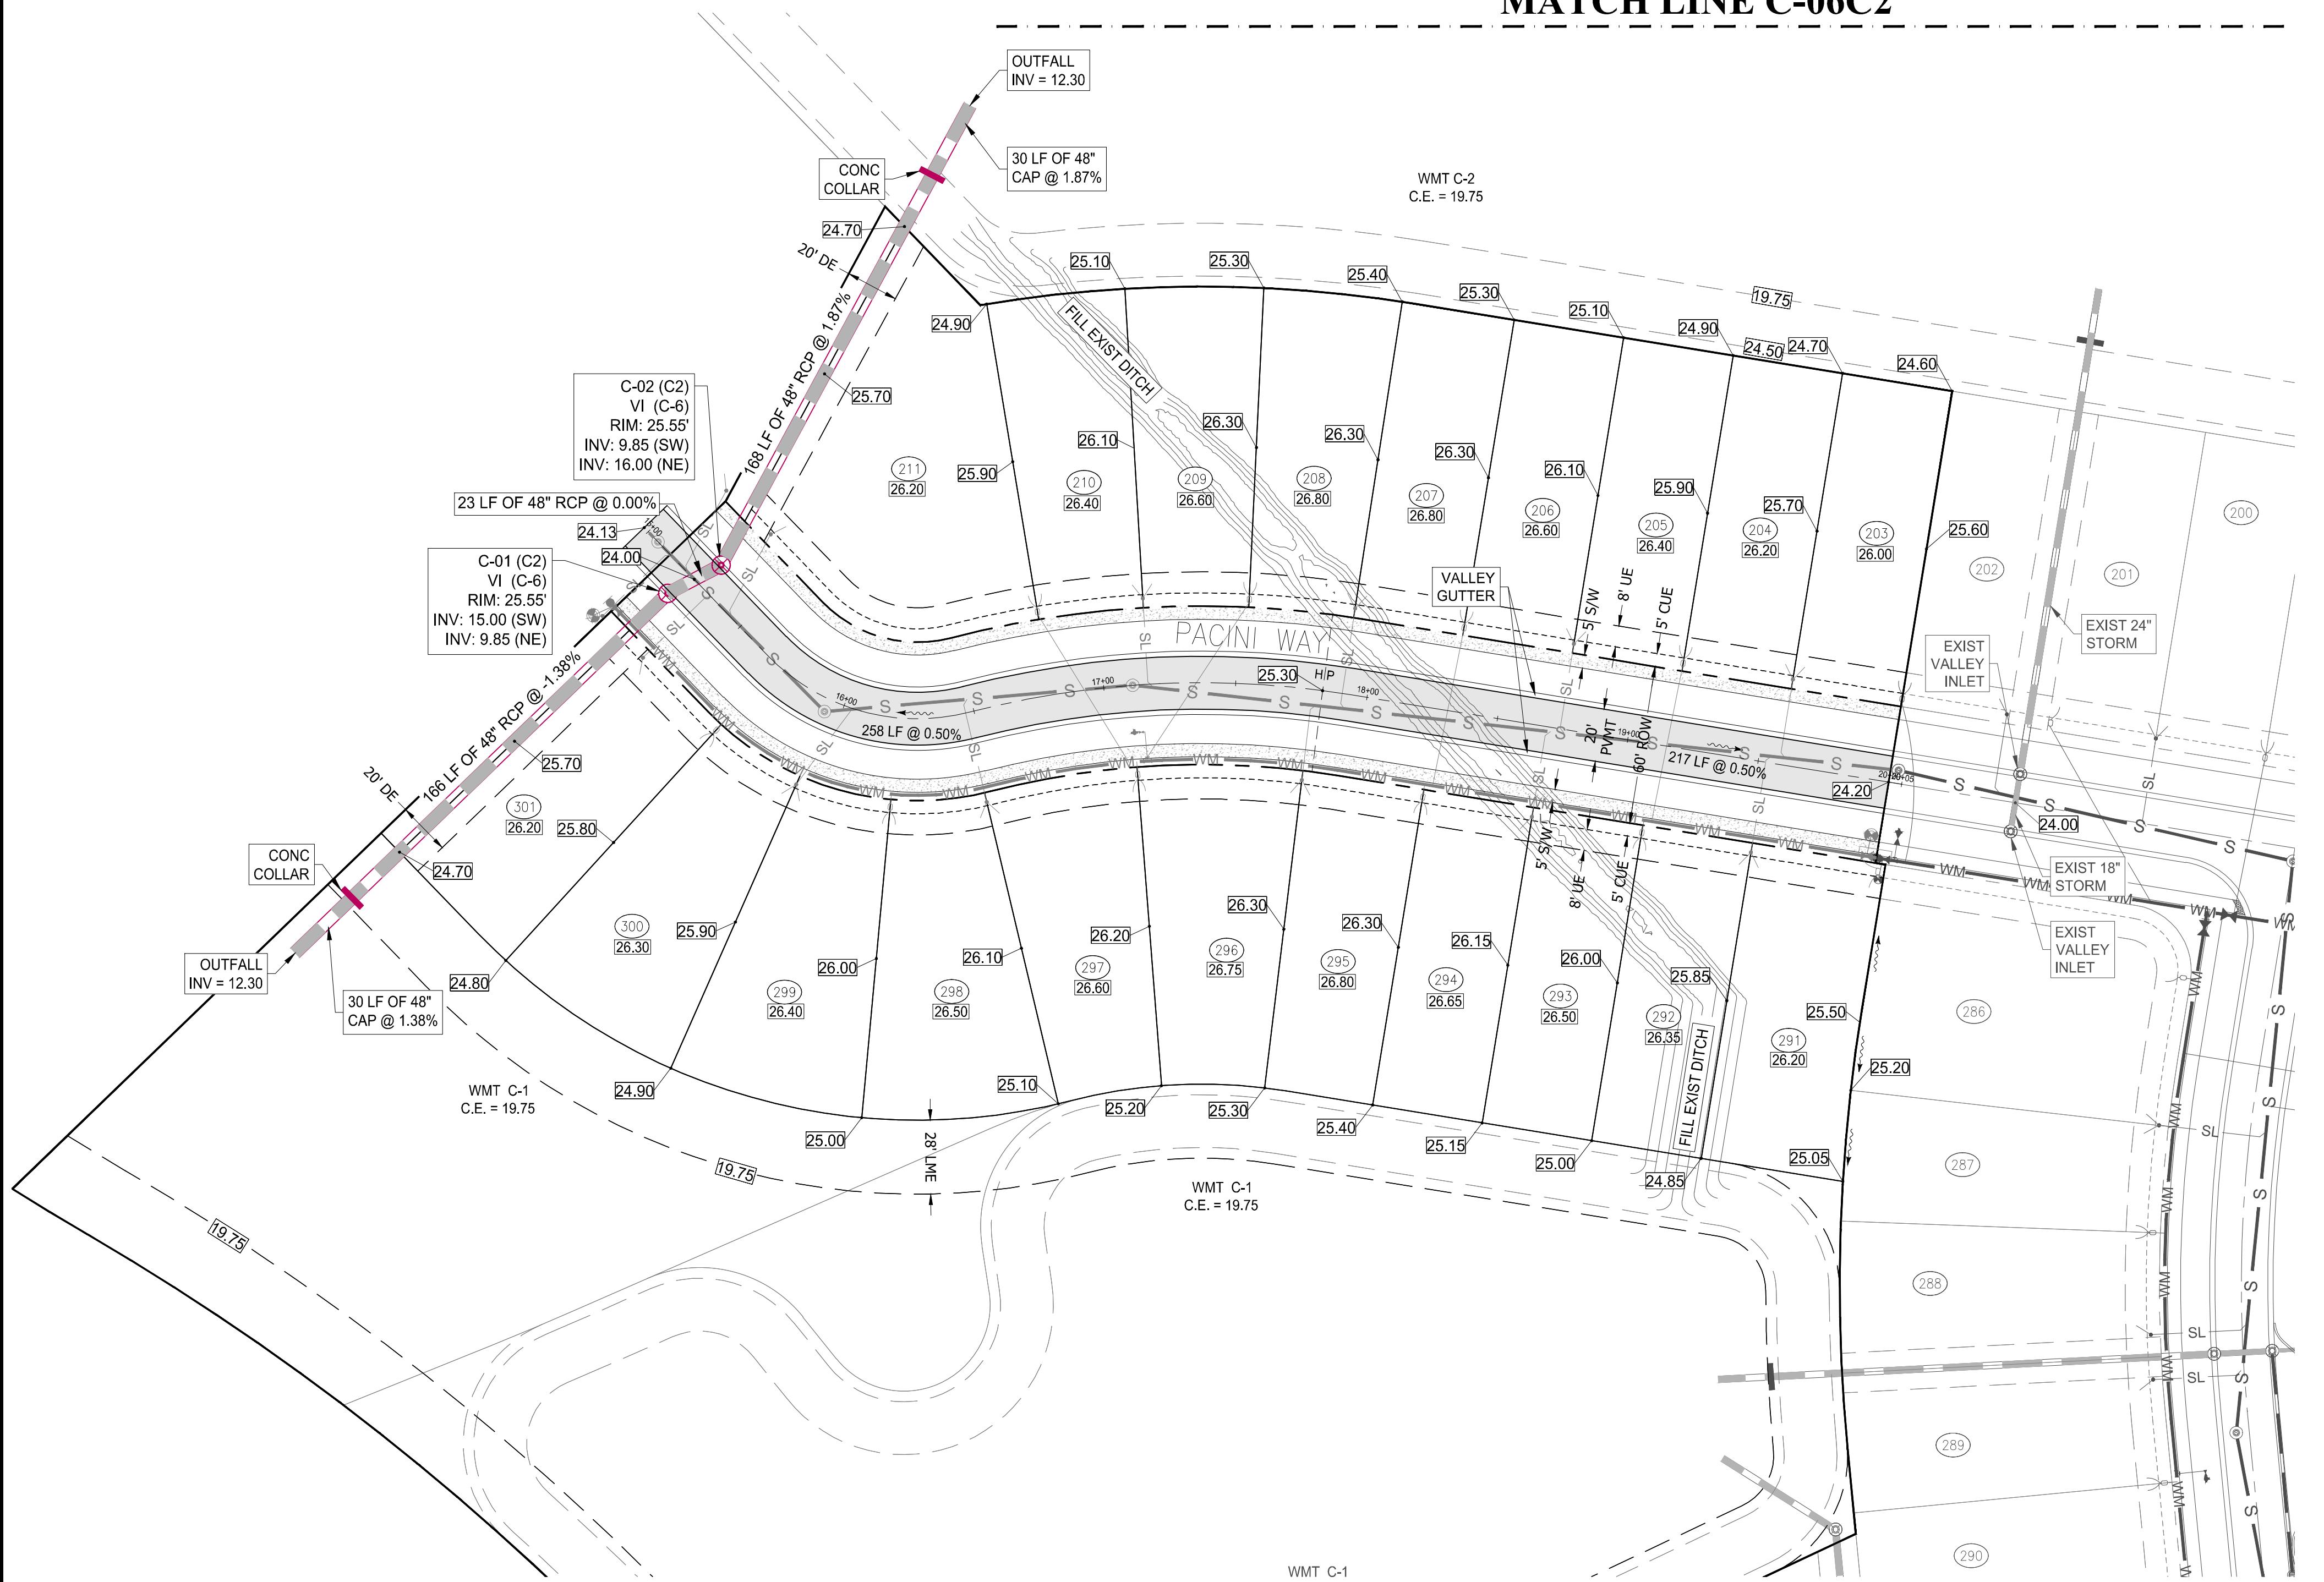
ORT ST. LUCIE PROJECT NO: P19-005

# MATCH LINE C-06C2

## CONSTRUCTION NOTES:

1. CONTRACTOR TO SAW-CUT AT ALL LOCATIONS OF REMOVAL OF EXISTING CONC. S/W, CONC. CURB AND ASPHALT UNLESS OTHERWISE NOTED. ALL BASE AND SUBBASE MATERIAL SHALL BE REMOVED WITHIN THE PROPOSED LANDSCAPED AREA.
2. CONTRACTOR TO MATCH EXIST. GRADES AND TO CONSTRUCT A SMOOTH TRANSITION FROM EXISTING FACILITIES TO PROPOSED.
3. CONTRACTOR TO REMOVE ALL CONSTRUCTION DEBRIS FROM CONSTRUCTION SITE AND DISPOSE PER LOCAL ORDINANCES.
4. CONTRACTOR TO ENSURE ALL CONSTRUCTION IS IN ACCORDANCE WITH CITY DESIGN STANDARDS.
5. CONTRACTOR TO SOD ALL DISTURBED AREAS, SODDING INCLUDES MAINTAINING SLOPE AND SOD UNTIL COMPLETION AND ACCEPTANCE OF THE TOTAL PROJECT OR GROWTH IS ESTABLISHED WHICHEVER COMES LAST.
6. ALL EXISTING TRAFFIC SIGNS DISTURBED DURING CONSTRUCTION SHALL BE REINSTALLED WHERE APPLICABLE BY THE CONTRACTOR.
7. THESE PLANS REFLECT CONDITIONS KNOWN DURING PLAN DEVELOPMENT. IN THE EVENT THAT ACTUAL PHYSICAL CONDITIONS PREVENT THE APPLICATION OF THESE STANDARDS OR THE PROGRESSION OF THE WORK, THE CONTRACTOR SHALL NOTIFY THE ENGINEER PRIOR TO CONSTRUCTION OF AFFECTED AREA.
8. THE CONTRACTOR SHALL PROTECT ALL EXISTING STRUCTURES, STORM DRAINS, UTILITIES, AND OTHER FACILITIES TO REMAIN AND SHALL REPAIR ANY DAMAGES DUE TO HIS/HER CONSTRUCTION ACTIVITIES AT NO ADDITIONAL COST TO THE OWNER.
9. NOTIFY SUNSHINE STATE ONE CALL (1-800-432-4770) OR (811) PRIOR TO CONSTRUCTION.
10. PROJECT BASED ON DESIGN SURVEY PREPARED BY OTHERS.
11. THE CONTRACTOR SHALL NOT ENCROACH ONTO PRIVATE PROPERTY WITHOUT EASEMENTS NECESSARY FOR COMPLETION OF THE WORK.

$$\underline{E: 1'' = 40'}$$





## KEYMAP

# ENGINEERING LEGEND

Description	Found (Yes/No)	Agency Contact Information	Management Plan (Yes/No)	Relocation plan (Yes/No)
Wetlands				
Rare Habitat				
Threatened Species				
Endangered Species				
Species of Special Concern				
Invasive / Exotic Vegetation				

ENVIRONMENTAL ASSESSMENT HAS BEEN ADDRESSED UNDER THE OVERALL  
DRI THEREFORE NO ADDITIONAL ENVIRONMENTAL REPORT IS REQUIRED

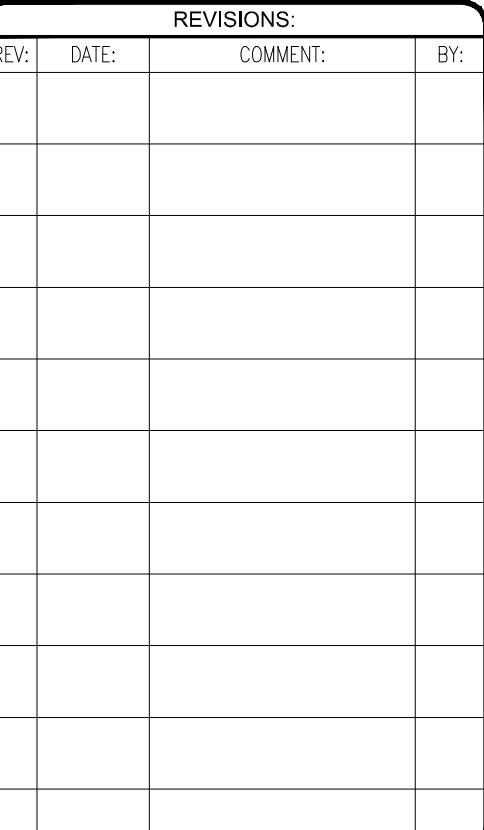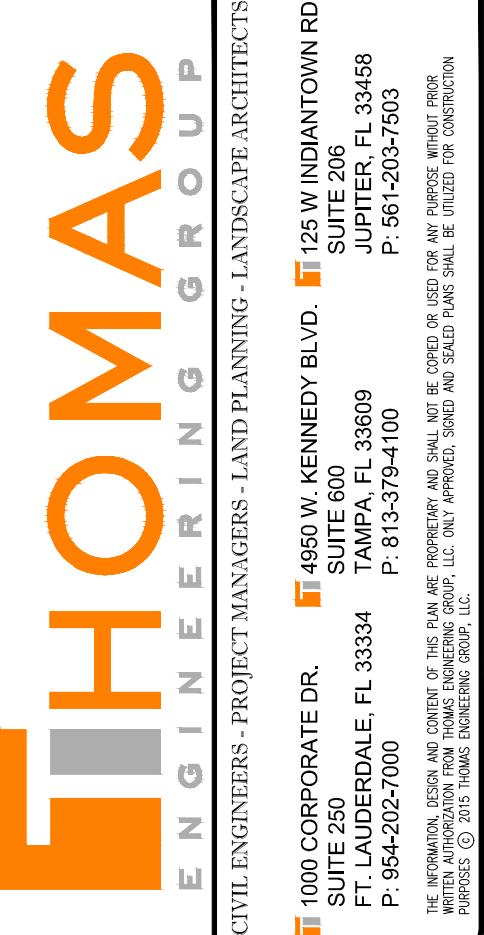

The image features a large, stylized '811' logo with a black and white striped background. To the right of the logo, the text 'KNOW WHAT'S BELOW' is on the first line, 'ALWAYS CALL 811' is on the second line, and 'BEFORE YOU DIG' is on the third line. Below this main text, a smaller line of text reads 'It's fast. It's free. It's the law.'

PROJECT No.:	FJ160006
DRAWN BY:	MJL
CHECKED BY:	BMU
DATE:	9-1-18
CAD I.D.:	FJ160006-PGD-PLANS


PROJECT:

# VERANO SOUTH

## POD C, PLAT 2



PEBWORTH PROFESSIONAL PLAZA  
125 W. INDIANTOWN RD, SUITE 206  
JUPITER, FL 33458  
PH: (561) 203-7503  
FX: (561) 203-7721  
[www.ThomasEngineeringGroup.com](http://www.ThomasEngineeringGroup.com)

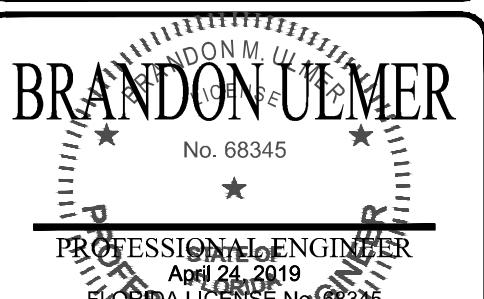

FLORIDA LICENSE NO. 08345  
FLORIDA BUSINESS CERT. OF AUTH. No. 27528

**SHEET TITLE:**  
**PAVING, GRADING AND**  
**DRAINAGE PLAN**


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SHEET NUMBER:  
**C-05 (C2)**

PORT ST. LUCIE PROJECT NO: P19-005

## CONSTRUCTION NOTES:


- CONTRACTOR TO SAW-CUT AT ALL LOCATIONS OF REMOVAL OF EXISTING CONC. SW, CONC. CURB AND ASPHALT UNLESS OTHERWISE NOTED. ALL BASE AND SUBBASE MATERIAL SHALL BE REMOVED WITHIN THE PROPOSED LANDSCAPED AREA.
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- THESE PLANS REFLECT CONDITIONS KNOWN DURING PLAN DEVELOPMENT. IN THE EVENT THAT ACTUAL PHYSICAL CONDITIONS PREVENT THE APPLICATION OF THESE STANDARDS OR THE PROGRESSION OF THE WORK, THE CONTRACTOR SHALL NOTIFY THE ENGINEER PRIOR TO CONSTRUCTION OF AFFECTED AREA.
- THE CONTRACTOR SHALL PROTECT ALL EXISTING STRUCTURES, STORM DRAINS, UTILITIES, AND OTHER FACILITIES TO REMAIN AND SHALL REPAIR ANY DAMAGES DUE TO HIS/HER CONSTRUCTION ACTIVITIES AT NO ADDITIONAL COST TO THE OWNER.
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- PROJECT BASED ON DESIGN SURVEY PREPARED BY OTHERS.
- THE CONTRACTOR SHALL NOT ENCROACH ONTO PRIVATE PROPERTY WITHOUT EASEMENTS NECESSARY FOR COMPLETION OF THE WORK.

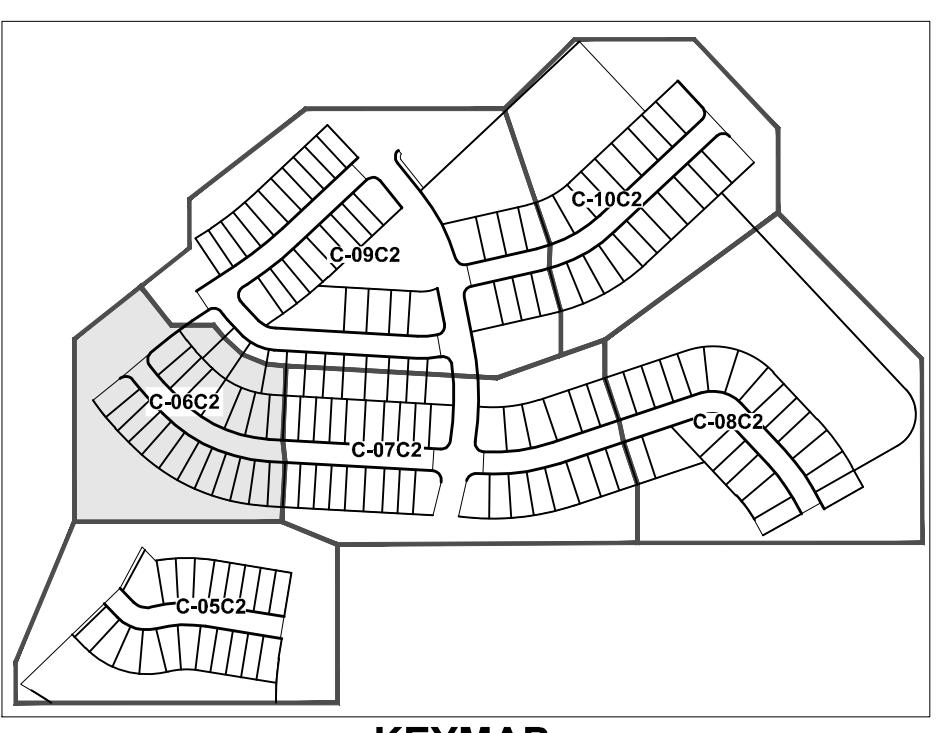

KEYMAP



www.callsunshine.com

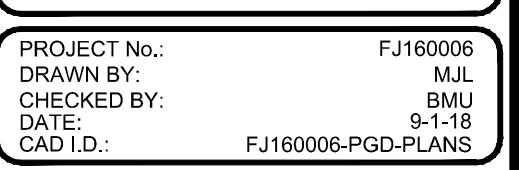

PROJECT:  
VERANO SOUTH  
POD C, PLAT 2  
FOR  
VERANO DEVELOPMENT



PEBWORTH PROFESSIONAL PLAZA  
125 W. INDIANTOWN RD, SUITE 206  
JUPITER, FL 34551  
PH: (561) 203-7703  
FX: (561) 203-7721  
www.ThomasEngineeringGroup.com




PROFESSIONAL ENGINEER  
April 24, 2019  
FLORIDA LICENSE NO. 49385  
FLORIDA BUSINESS LICENSE NO. 7528

SHEET TITLE:  
PAVING, GRADING AND  
DRAINAGE PLAN

SHEET NUMBER:  
C-06 (C2)


PSLUSD PROJECT NO: 11-652-32C  
ELEVATIONS BASED ON NAVD '88  
PORT ST. LUCIE PROJECT NO: P19-005

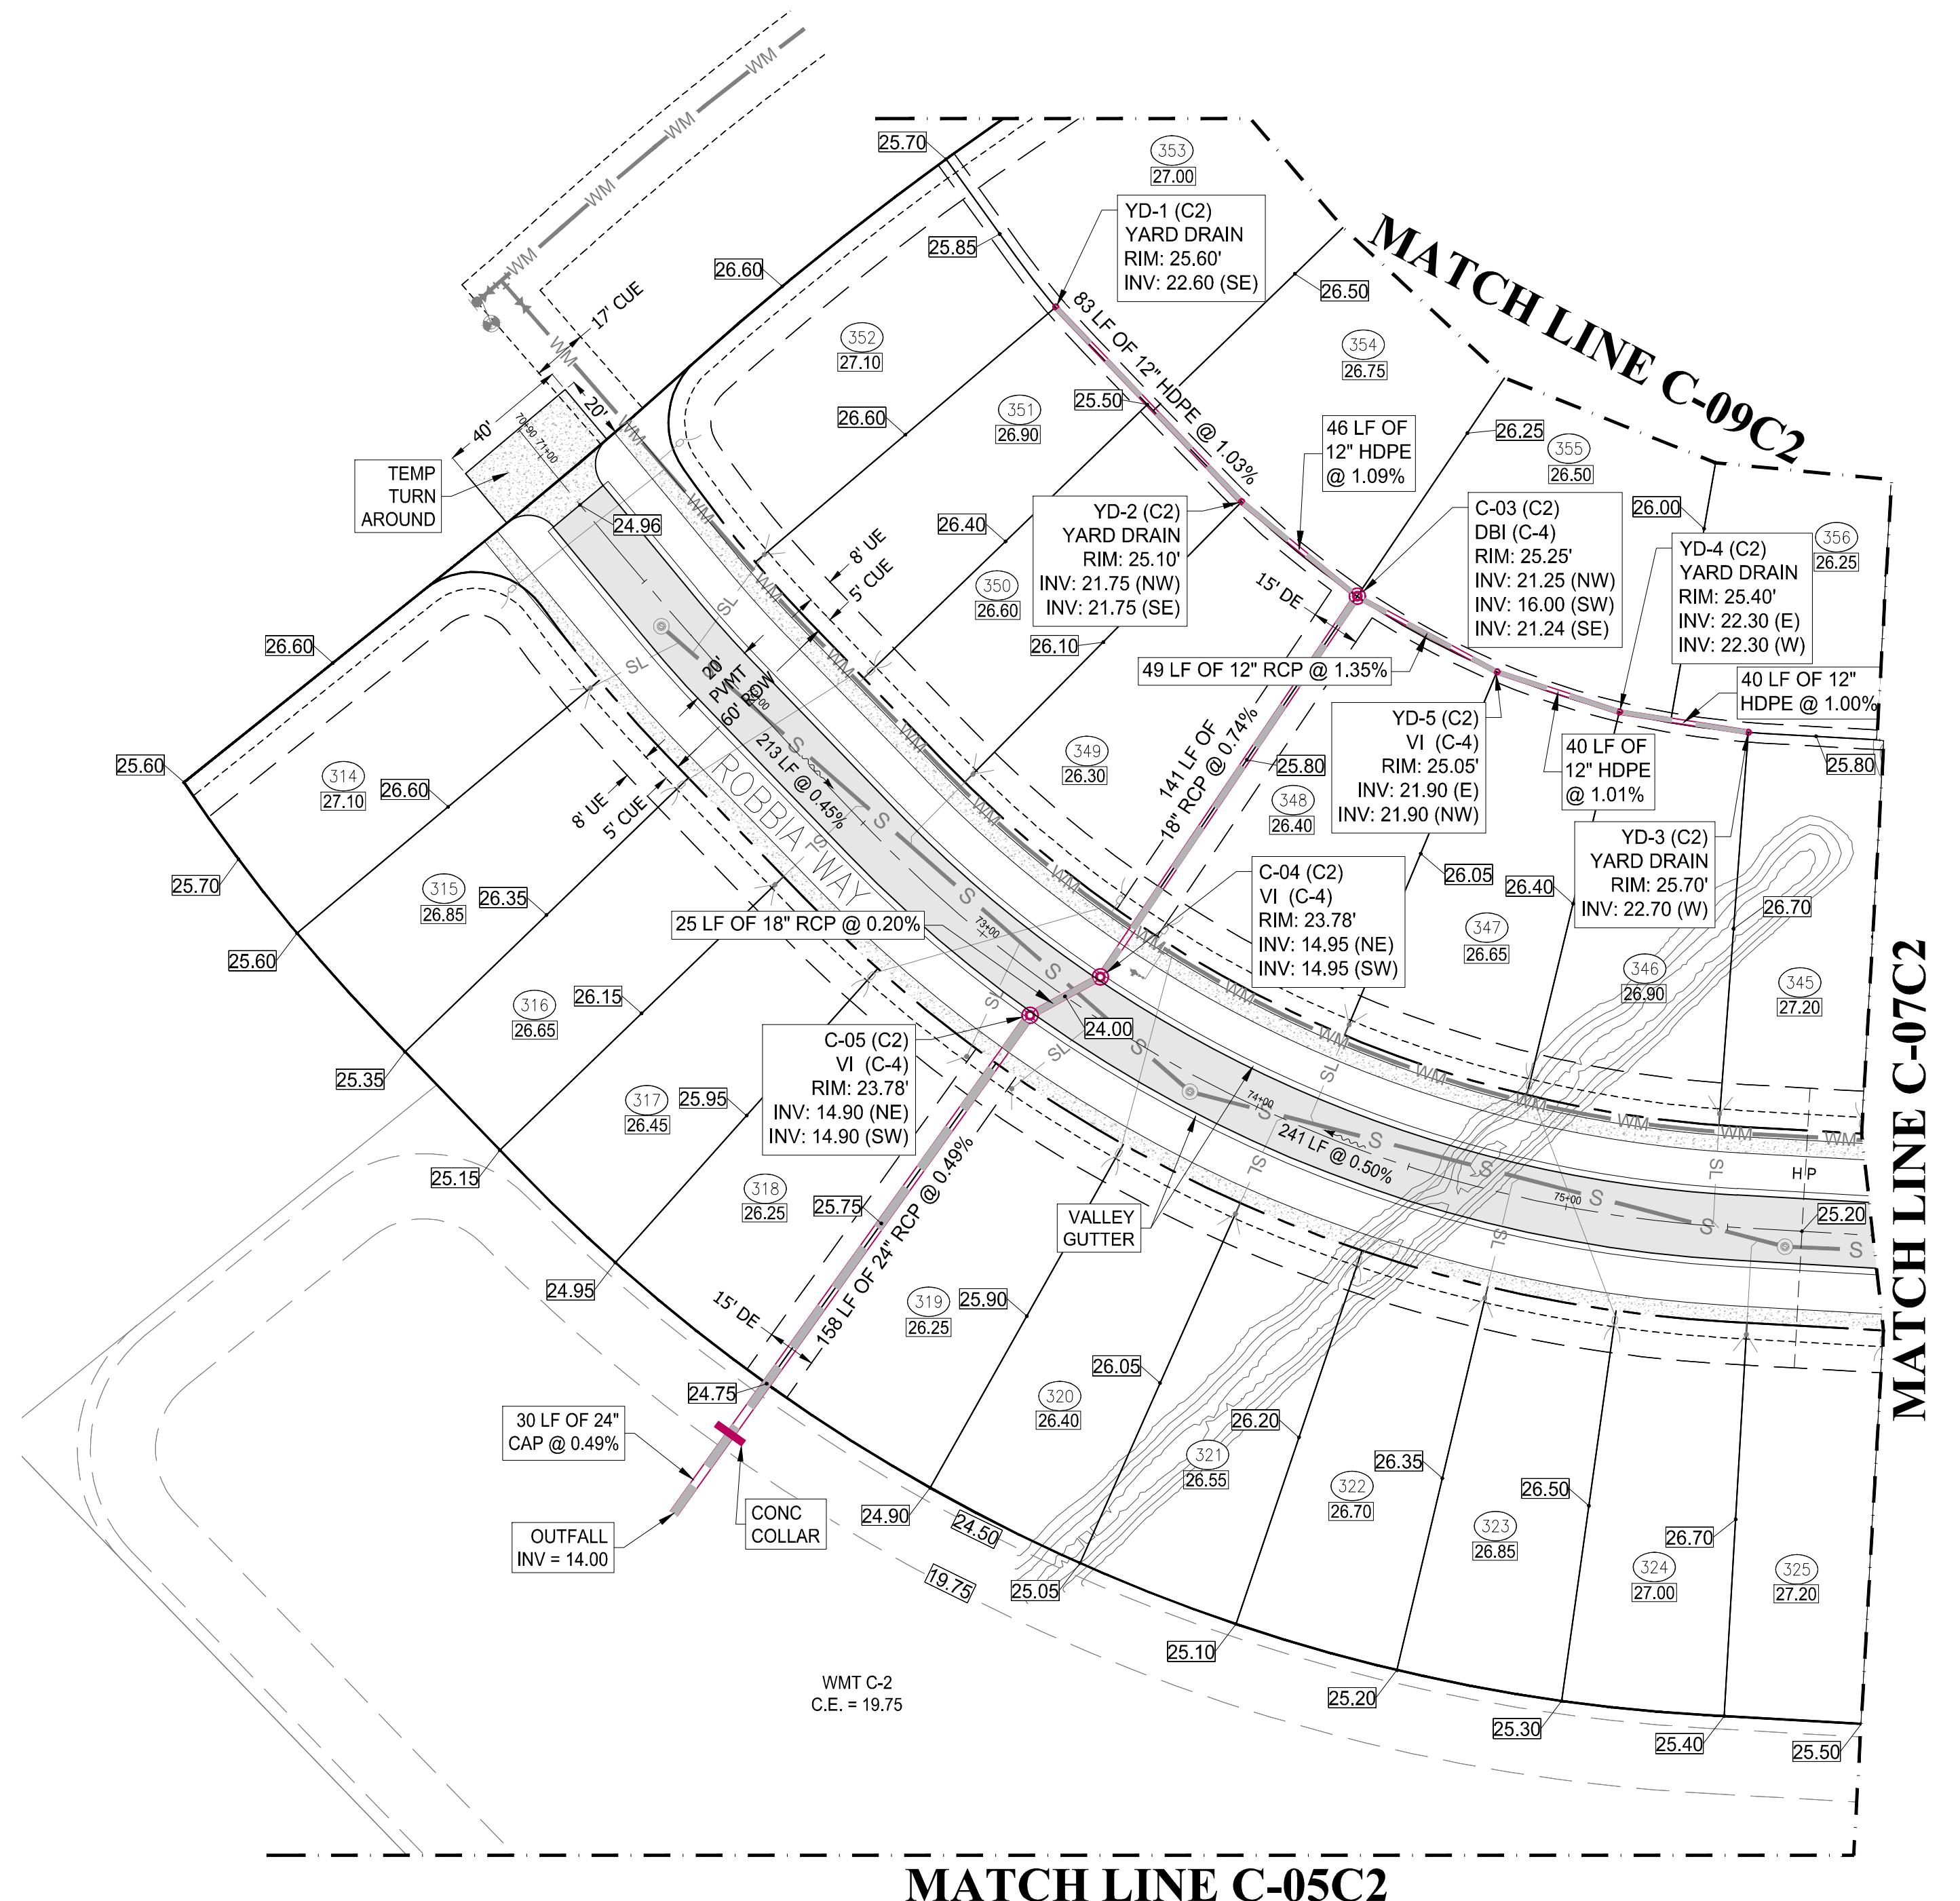


ENGINEERING LEGEND	
WATER MAIN	WM WM
STORM SEWER	SW SW
SANITARY SEWER MAIN	S S
FORCE MAIN	FM FM
CATCH BASIN	(C)
MANHOLE	(M)
PROPOSED ELEVATION	—
FIRE HYDRANT	•
DECORATIVE LIGHTING	◇
RIGHT OF WAY / CUE /UE	—
WATER SERVICE	W
SEWER SERVICE	S
LOT NUMBER / FINISH FLOOR	(49) 26.45
24" STOP BAR AND STOP SIGN	—





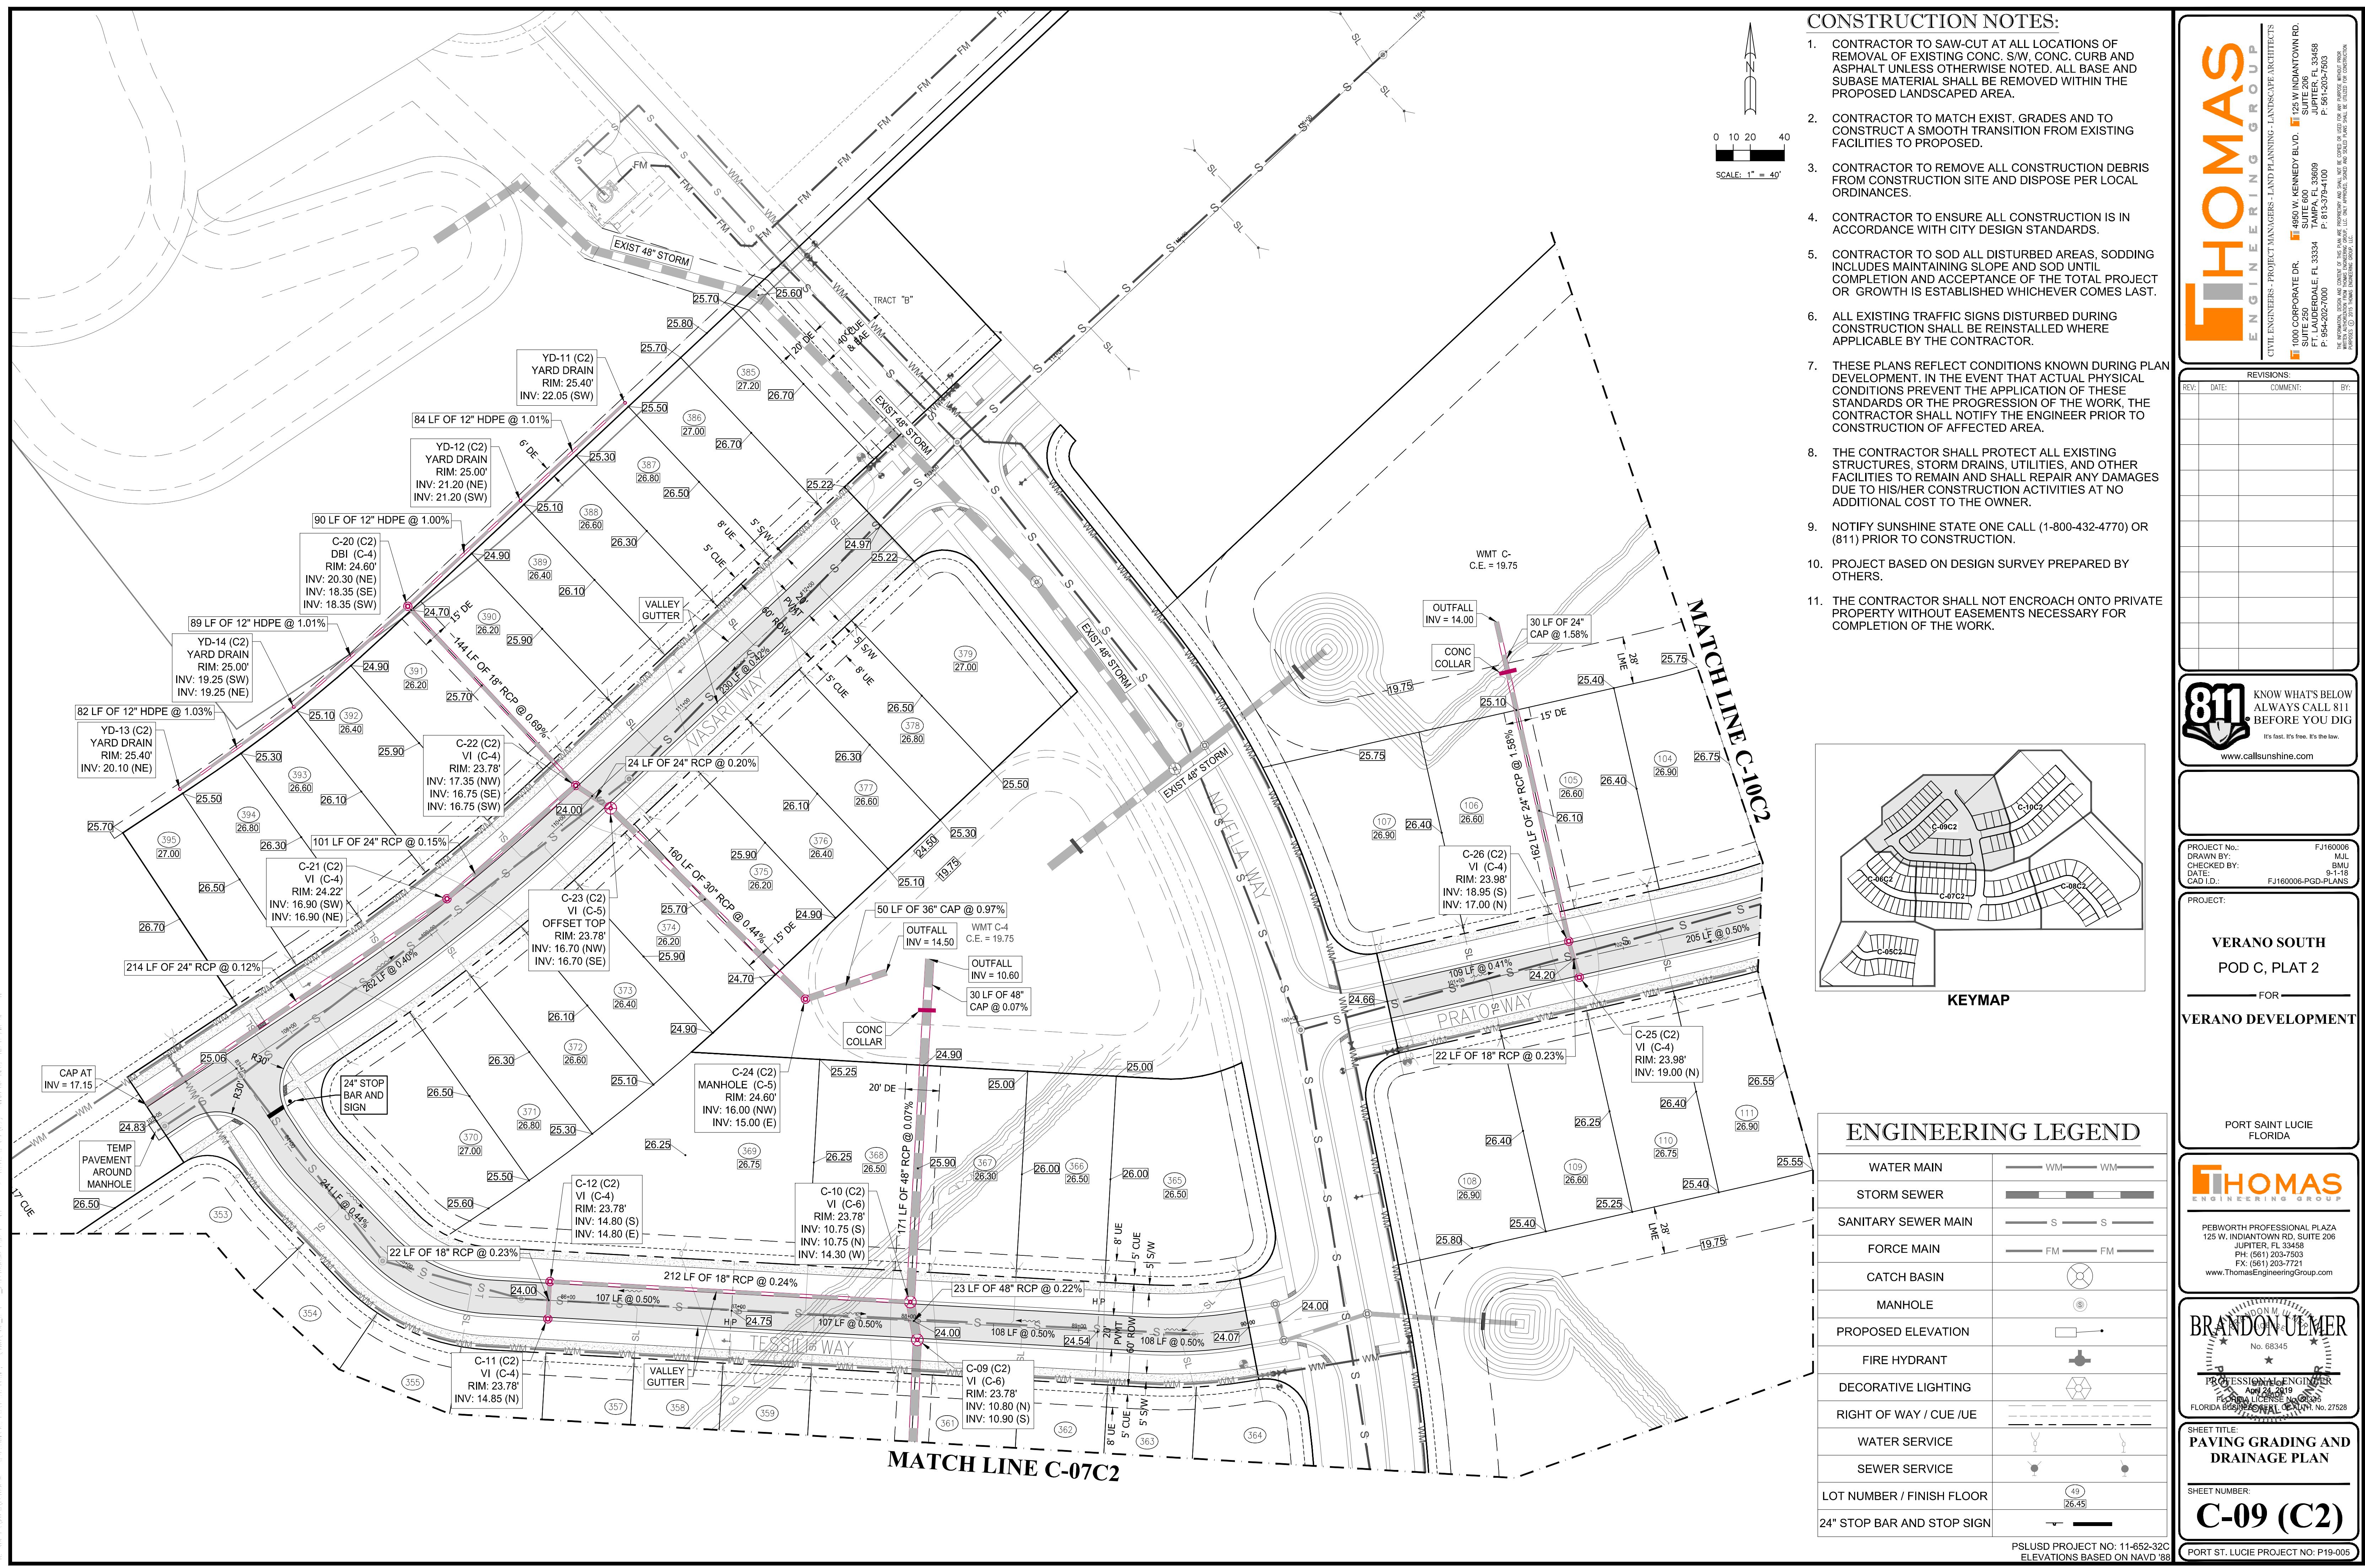

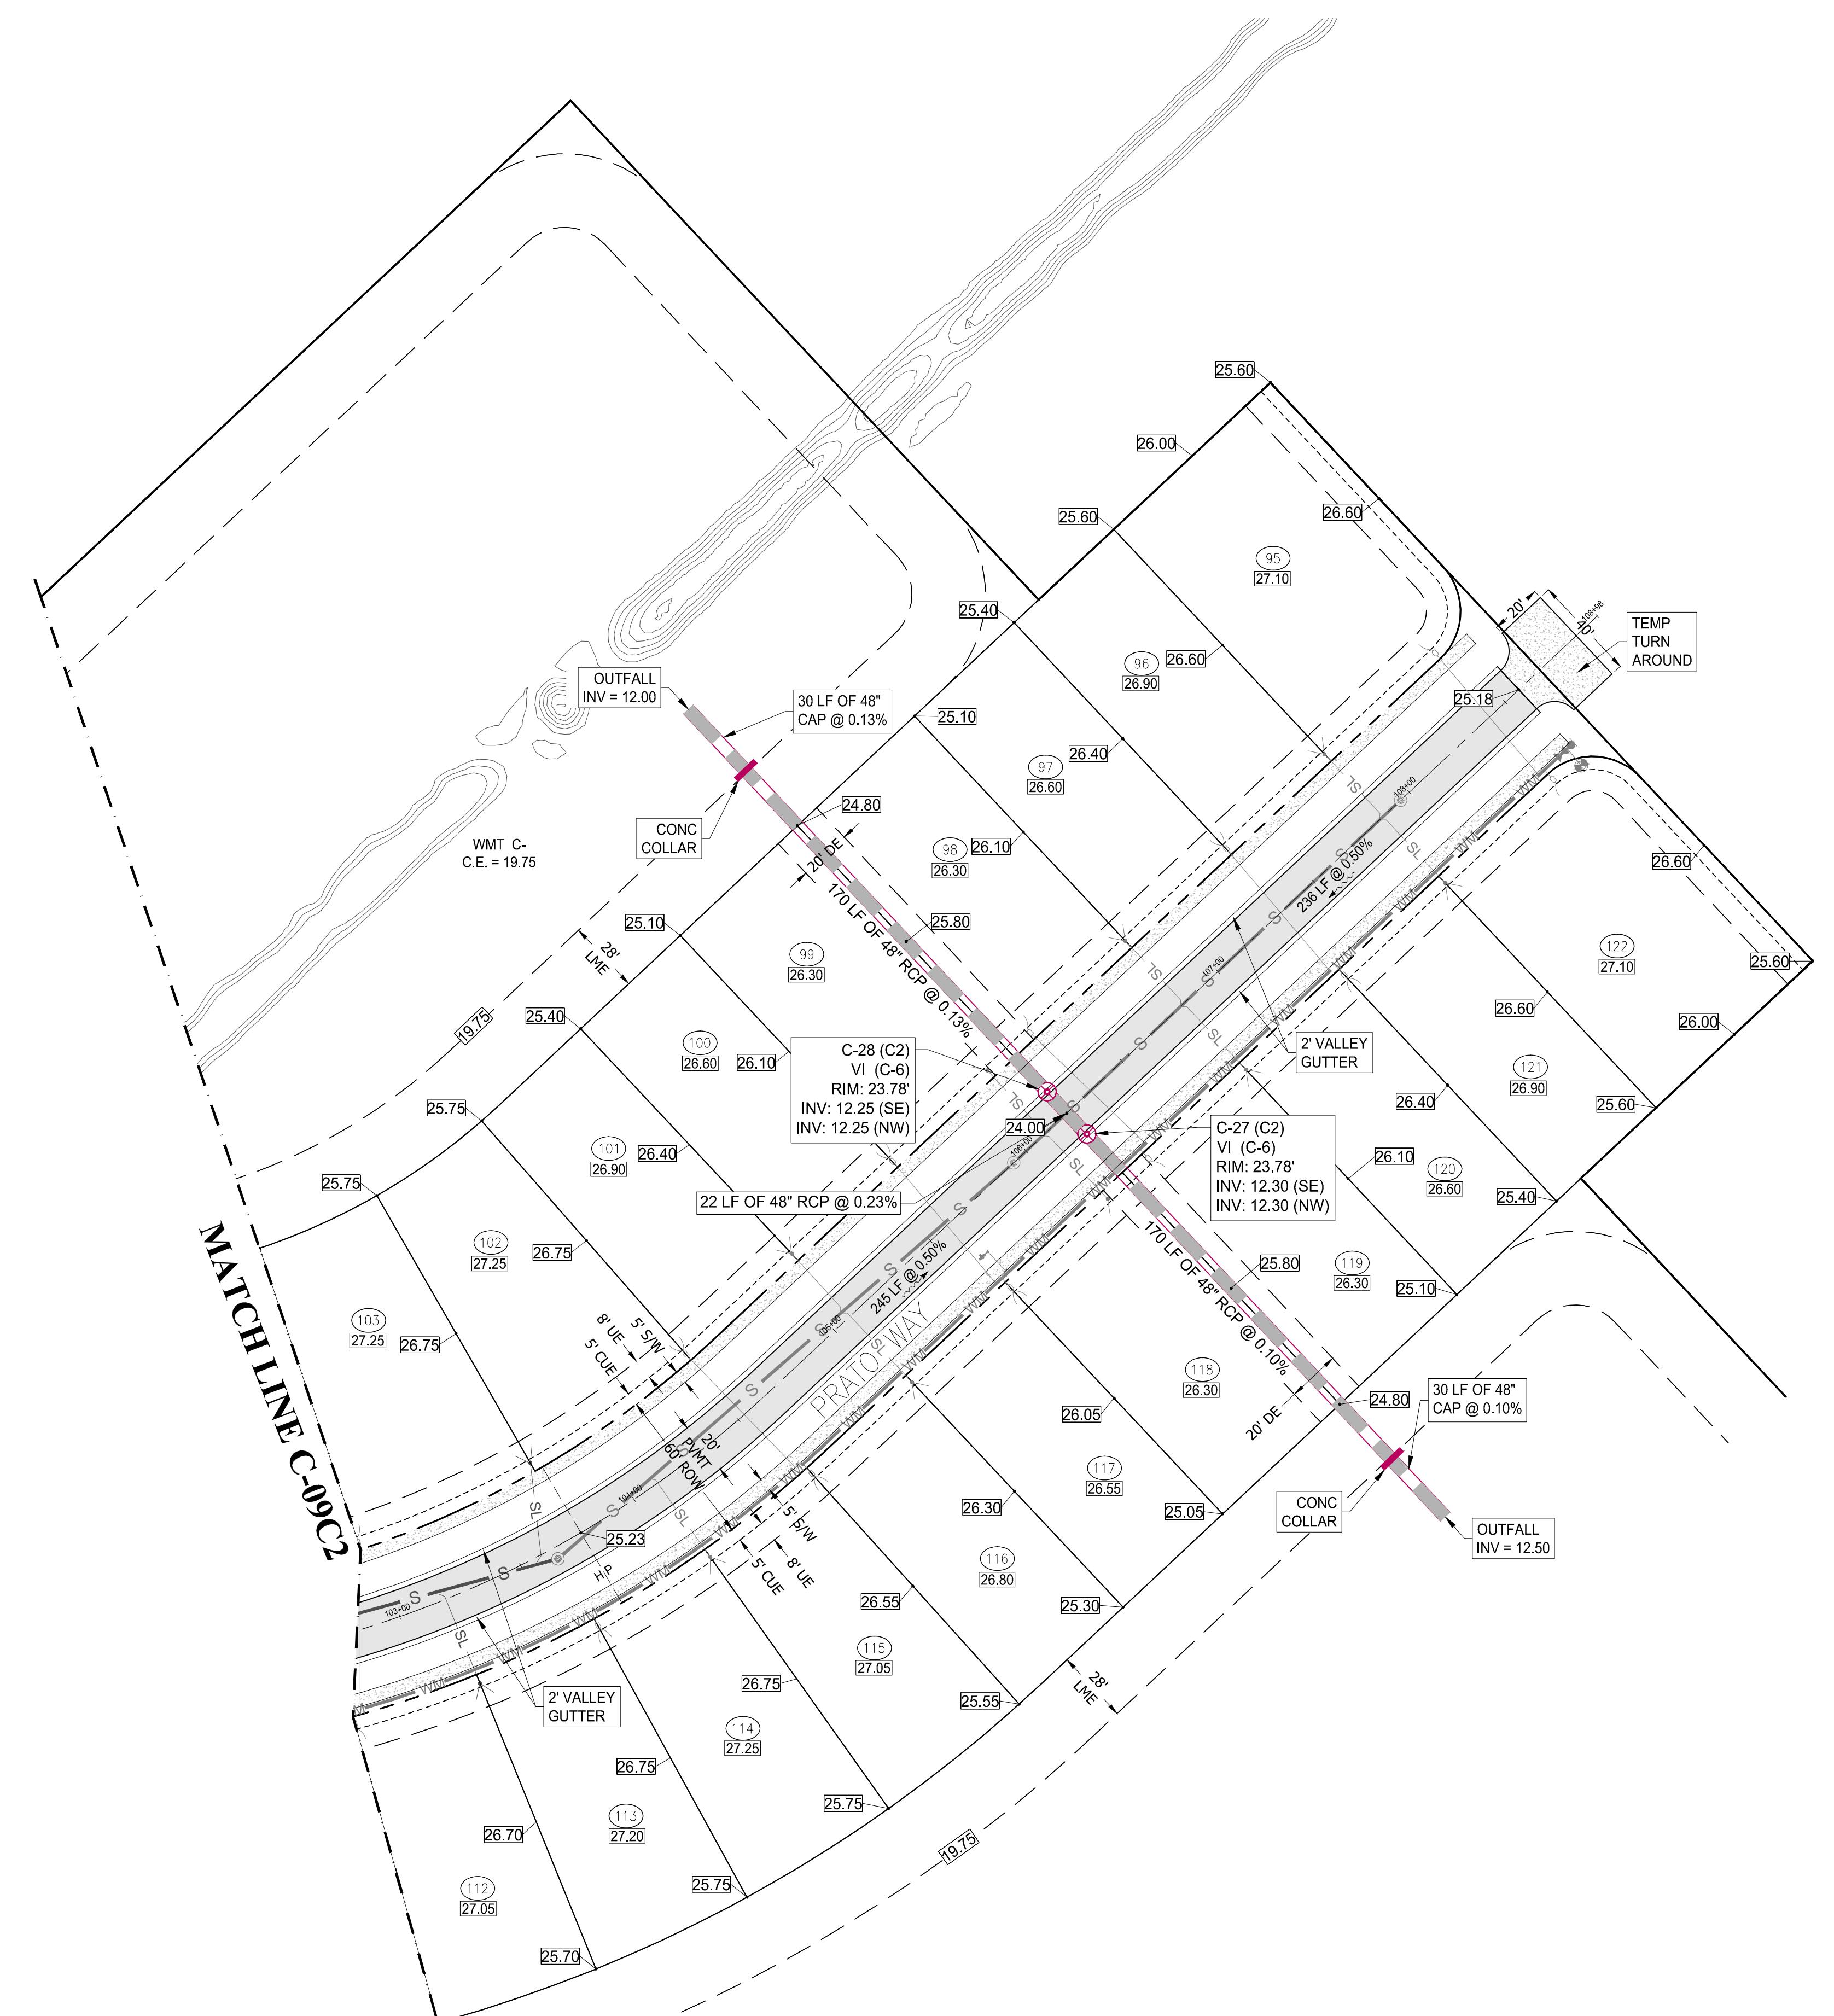

## CONSTRUCTION NOTES:

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11. THE CONTRACTOR SHALL NOT ENCROACH ONTO PRIVATE PROPERTY WITHOUT EASEMENTS NECESSARY FOR COMPLETION OF THE WORK.

# ENGINEERING LEGEND

WATER MAIN	
STORM SEWER	
SANITARY SEWER MAIN	
FORCE MAIN	
CATCH BASIN	
MANHOLE	
PROPOSED ELEVATION	
FIRE HYDRANT	
DECORATIVE LIGHTING	
RIGHT OF WAY / CUE / UE	
WATER SERVICE	
SEWER SERVICE	
LOT NUMBER / FINISH FLOOR	
4" STOP BAR AND STOP SIGN	

**THOMAS**  
ENGINEERING GROUP

CIVIL ENGINEERS - PROJECT MANAGERS - LAND PLANNING - LANDSCAPE ARCHITECTS

1000 CORPORATE DR.  
SUITE 250  
FT. LAUDERDALE, FL 33334  
P. 954-202-7000

4950 W. KENNEDY BLVD.  
SUITE 600  
TAMPA, FL 33609  
P. 813-379-4100

125 W INDIANTOWN RD  
SUITE 206  
JUPITER, FL 33458  
P. 561-203-7503

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[www.callsunshine.com](http://www.callsunshine.com)

PROJECT No.:	FJ160006
DRAWN BY:	MJL
CHECKED BY:	BMU
DATE:	9-1-18
SAP/H.D.:	FJ160006 PCP PLANS

PROJECT: **VERANO SOUTH**  
**POD C, PLAT 2**

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# PORT SAINT LUCIE FLORIDA

**SHEET TITLE:**  
**PAVING GRADING AND  
DRAINAGE PLAN**

---

SHEET NUMBER:

## C-10 (C2)

PORT ST. LUCIE PROJECT NO: P19-005

REVISIONS:  
REV: DATE: COMMENT: BY:




PROJECT No.: FJ160006  
DRAWN BY: M.J.L.  
CHECKED BY: D.W.  
DATE: 9-1-18  
CAD I.D.: FJ160006-PGD-DETAILS

PROJECT:  
**VERANO SOUTH**  
POD C, PLAT 2  
FOR  
**VERANO DEVELOPMENT**

NOTES:  
1- MATERIAL: ASTM-A48 CLASS 35B  
GRAY IRON.  
2- FRAME WT: 290 LBS. APP.  
3- GRATE WT: 120 LBS. APP. EA.

**U.S. FOUNDRY & MFG. CORP.**  
MEDLEY, FLORIDA  
USF 5113 FRAME & 6194 GRATE

DWN. BY: A.M. SCALE: 1" = 1' DATE: 08/15/94  
CHK. BY: DWG. NO: A3177 REV: □


PROFESSIONAL ENGINEER  
April 24, 2019  
FLORIDA LICENSE NO. 88385  
FLORIDA BUSINESS PEAL NO. 27528

SHEET TITLE:  
**PAVING, GRADING AND  
DRAINAGE DETAILS**

SHEET NUMBER:

**C-11 (C2)**


PSLUSD PROJECT NO: 11-652-32C  
ELEVATIONS BASED ON NAVD '88  
PORT ST. LUCIE PROJECT NO: P19-005

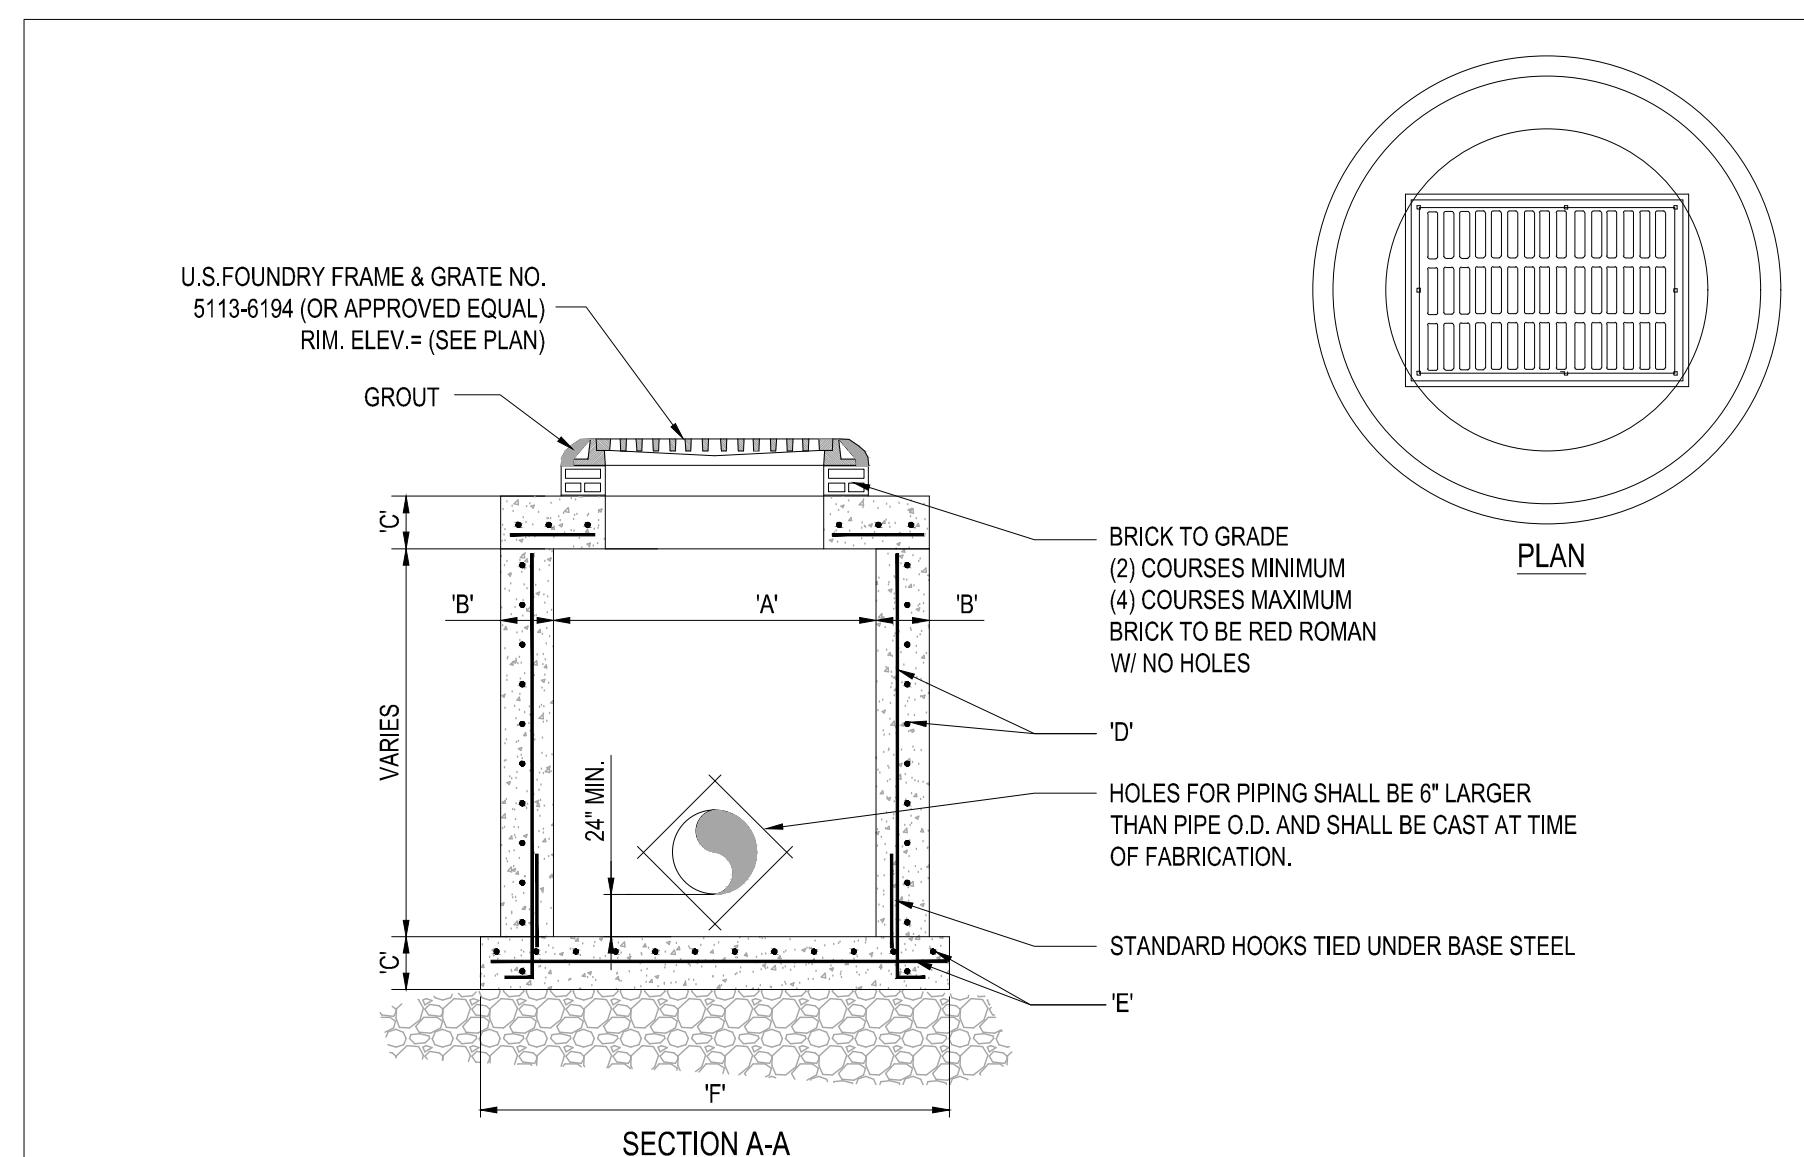

TYPE	"A"	"B"	"C"	"D"	"E"	"F"
C-4	4'-0" Ø	8"	8"	# 4 @ 12" C.C.E.W.	# 4 @ 12" C.C.E.W.	6'-4" Ø
C-5	5'-0" Ø	8"	8"	# 5 @ 12" C.C.E.W.	# 5 @ 12" C.C.E.W.	7'-4" Ø
C-6	6'-0" Ø	8"	8"	# 5 @ 12" C.C.E.W.	# 5 @ 6" C.C.E.W.	8'-4" Ø
C-7	7'-0" Ø	8"	8"	# 5 @ 12" C.C.E.W.	# 5 @ 6" C.C.E.W.	9'-4" Ø
C-8	8'-0" Ø	10"	10"	2-W.W.M. w/ # 4 @ 12" C.C. VERT	# 5 @ 6" C.C.E.W.	10'-8" Ø

## 1 PRECAST CIRCULAR VALLEY INLET


SCALE: NONE

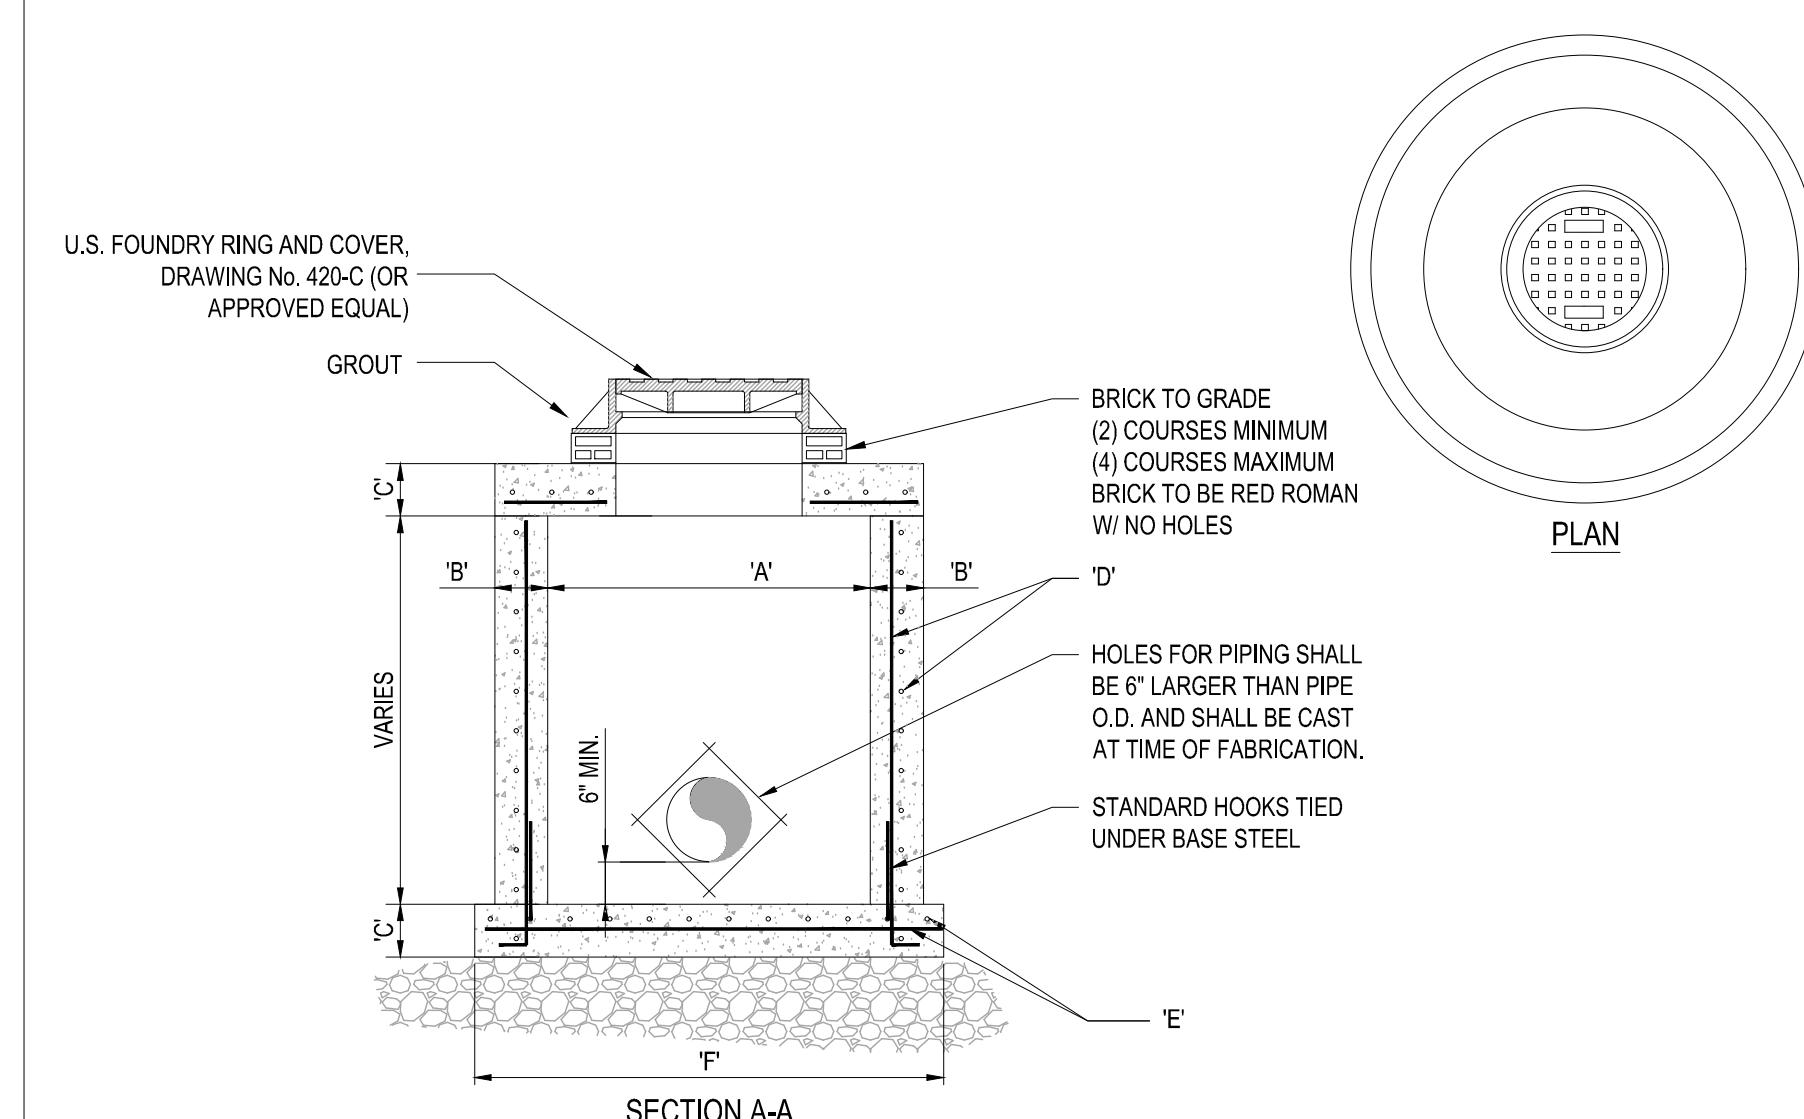

TYPE	"A"	"B"	"C"	"D"	"E"	"F"
M-4	4'-0" Ø	8"	8"	# 4 @ 12" C.C.E.W.	# 4 @ 12" C.C.E.W.	6'-4" Ø
M-5	5'-0" Ø	8"	8"	# 5 @ 12" C.C.E.W.	# 5 @ 12" C.C.E.W.	7'-4" Ø
M-6	6'-0" Ø	8"	8"	# 5 @ 12" C.C.E.W.	# 5 @ 6" C.C.E.W.	8'-4" Ø
M-7	7'-0" Ø	8"	8"	# 5 @ 12" C.C.E.W.	# 5 @ 6" C.C.E.W.	9'-4" Ø
M-8	8'-0" Ø	10"	10"	2-W.W.M. w/ # 4 @ 12" C.C. VERT	# 5 @ 6" C.C.E.W.	10'-8" Ø

## 4 PRECAST CIRCULAR DRAINAGE MANHOLE


SCALE: NONE

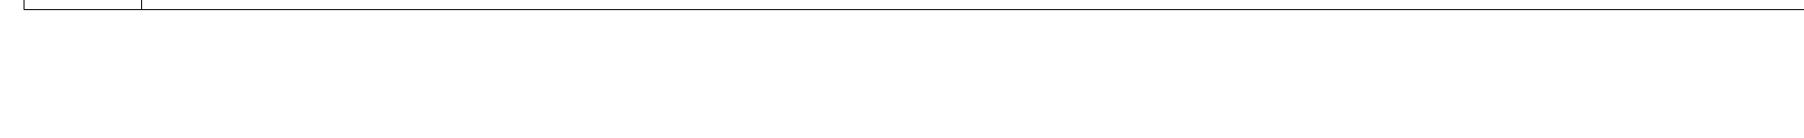

TYPE	"A"	"B"	"C"	"D"	"E"	"F"
M-4	4'-0" Ø	8"	8"	# 4 @ 12" C.C.E.W.	# 4 @ 12" C.C.E.W.	6'-4" Ø
M-5	5'-0" Ø	8"	8"	# 5 @ 12" C.C.E.W.	# 5 @ 12" C.C.E.W.	7'-4" Ø
M-6	6'-0" Ø	8"	8"	# 5 @ 12" C.C.E.W.	# 5 @ 6" C.C.E.W.	8'-4" Ø
M-7	7'-0" Ø	8"	8"	# 5 @ 12" C.C.E.W.	# 5 @ 6" C.C.E.W.	9'-4" Ø
M-8	8'-0" Ø	10"	10"	2-W.W.M. w/ # 4 @ 12" C.C. VERT	# 5 @ 6" C.C.E.W.	10'-8" Ø

## 5 PRECAST CONCRETE-TOP SLAB FOR DRAINAGE MANHOLES

SCALE: NONE

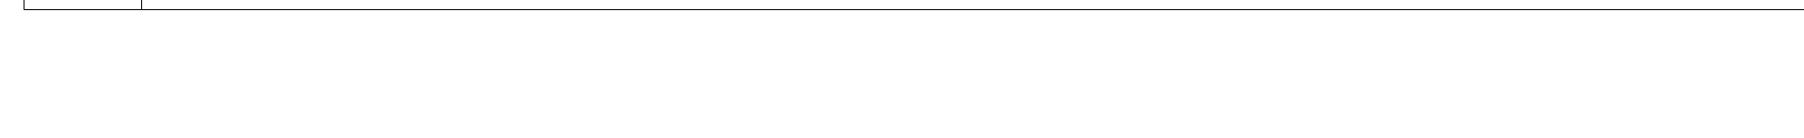

TYPE	"A"	"B"	"C"	"D"	"E"	"F"
M-4	4'-0" Ø	8"	8"	# 4 @ 12" C.C.E.W.	# 4 @ 12" C.C.E.W.	6'-4" Ø
M-5	5'-0" Ø	8"	8"	# 5 @ 12" C.C.E.W.	# 5 @ 12" C.C.E.W.	7'-4" Ø
M-6	6'-0" Ø	8"	8"	# 5 @ 12" C.C.E.W.	# 5 @ 6" C.C.E.W.	8'-4" Ø
M-7	7'-0" Ø	8"	8"	# 5 @ 12" C.C.E.W.	# 5 @ 6" C.C.E.W.	9'-4" Ø
M-8	8'-0" Ø	10"	10"	2-W.W.M. w/ # 4 @ 12" C.C. VERT	# 5 @ 6" C.C.E.W.	10'-8" Ø

SCALE: NONE



NOTE:  
1. RING AND COVER TO BE TYPE U.S.F. No. 420-C

SCALE: NONE

NOTE:  
1- MATERIAL: ASTM-A48 CLASS 35B  
GRAY IRON.  
2- FRAME WT: 290 LBS. APP.  
3- GRATE WT: 120 LBS. APP. EA.

SCALE: NONE

NOTE:  
1- MATERIAL: ASTM-A48 CLASS 35B  
GRAY IRON.  
2- FRAME WT: 290 LBS. APP.  
3- GRATE WT: 120 LBS. APP. EA.

SCALE: NONE

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3- GRATE WT: 120 LBS. APP. EA.

SCALE: NONE

NOTE:  
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GRAY IRON.  
2- FRAME WT: 290 LBS. APP.  
3- GRATE WT: 120 LBS. APP. EA.

SCALE: NONE

NOTE:  
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GRAY IRON.  
2- FRAME WT: 290 LBS. APP.  
3- GRATE WT: 120 LBS. APP. EA.

SCALE: NONE

NOTE:  
1- MATERIAL: ASTM-A48 CLASS 35B  
GRAY IRON.  
2- FRAME WT: 290 LBS. APP.  
3- GRATE WT: 120 LBS. APP. EA.

SCALE: NONE

NOTE:  
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GRAY IRON.  
2- FRAME WT: 290 LBS. APP.  
3- GRATE WT: 120 LBS. APP. EA.

SCALE: NONE

NOTE:  
1- MATERIAL: ASTM-A48 CLASS 35B  
GRAY IRON.  
2- FRAME WT: 290 LBS. APP.  
3- GRATE WT: 120 LBS. APP. EA.

SCALE: NONE


NOTE:  
1- MATERIAL: ASTM-A48 CLASS 35B  
GRAY IRON.  
2- FRAME WT: 290 LBS. APP.  
3- GRATE WT: 120 LBS. APP. EA.


SCALE: NONE

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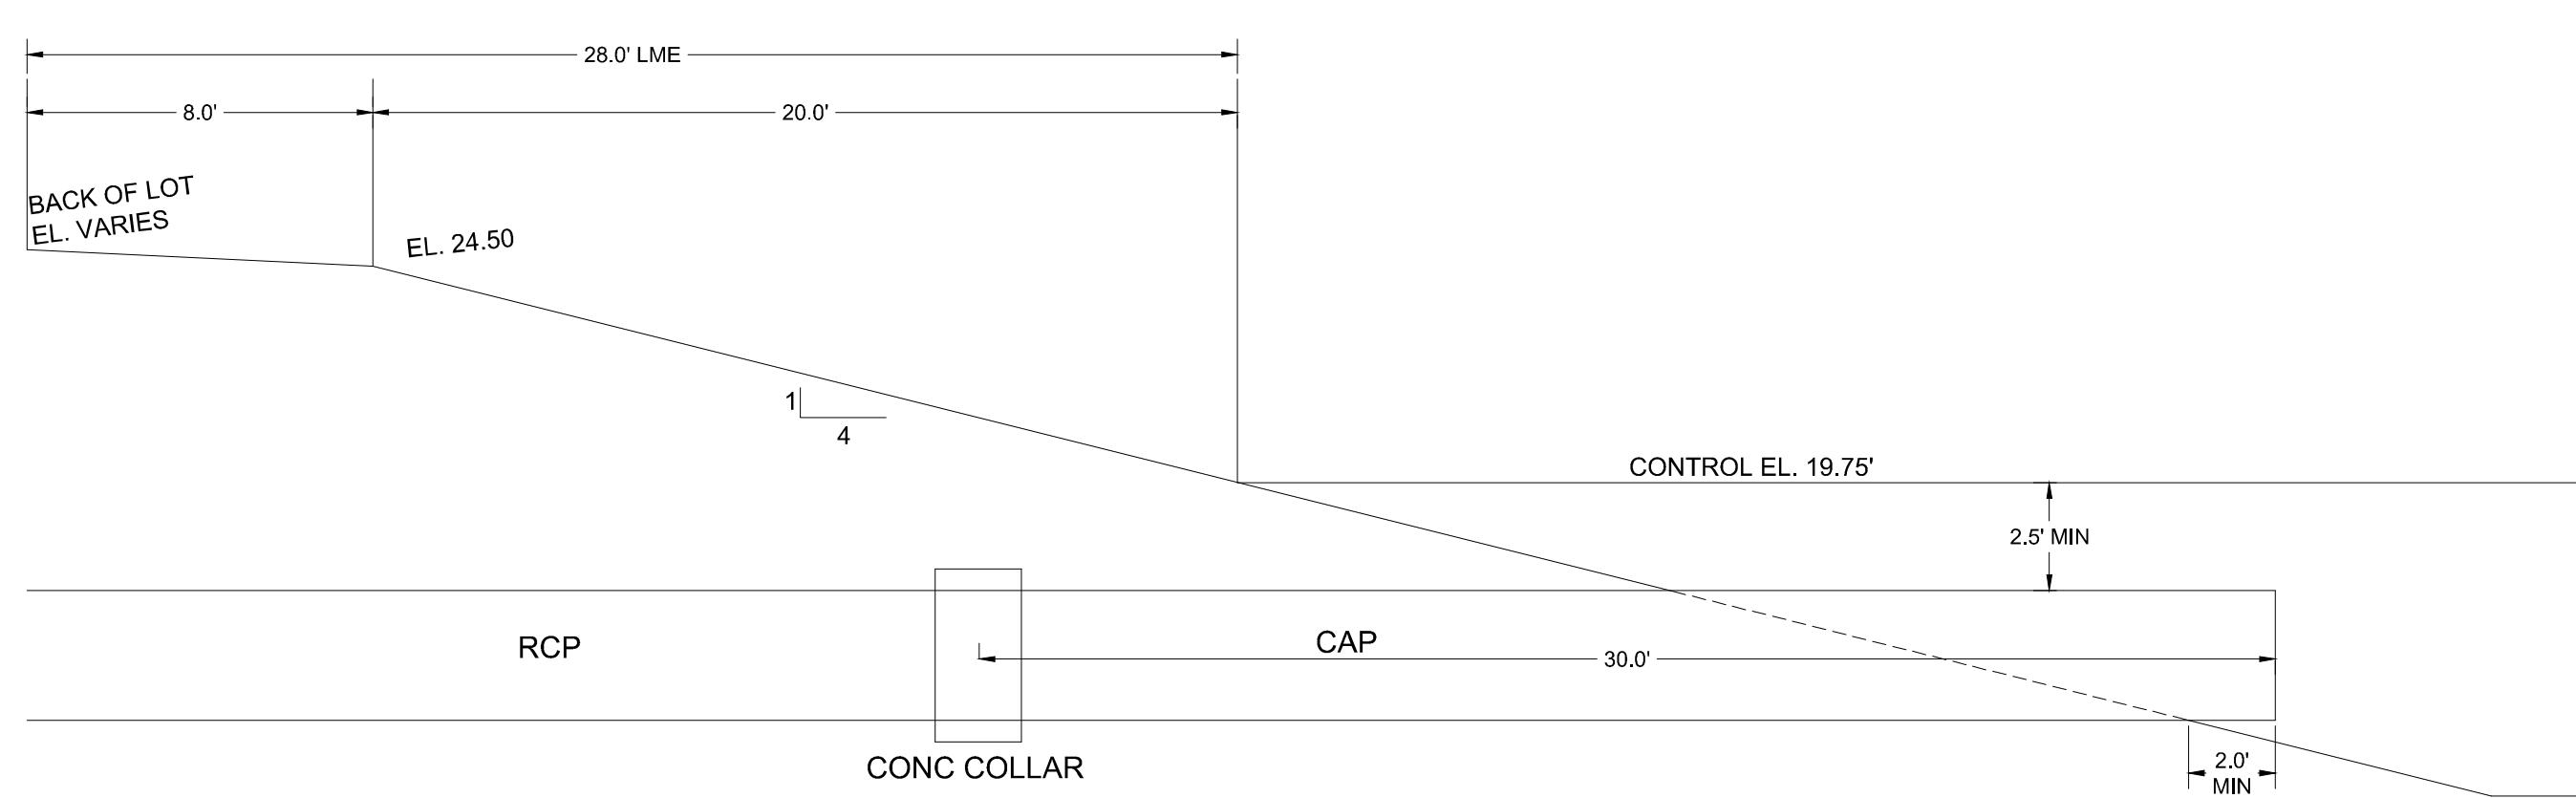
SCALE: NONE

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GRAY IRON.




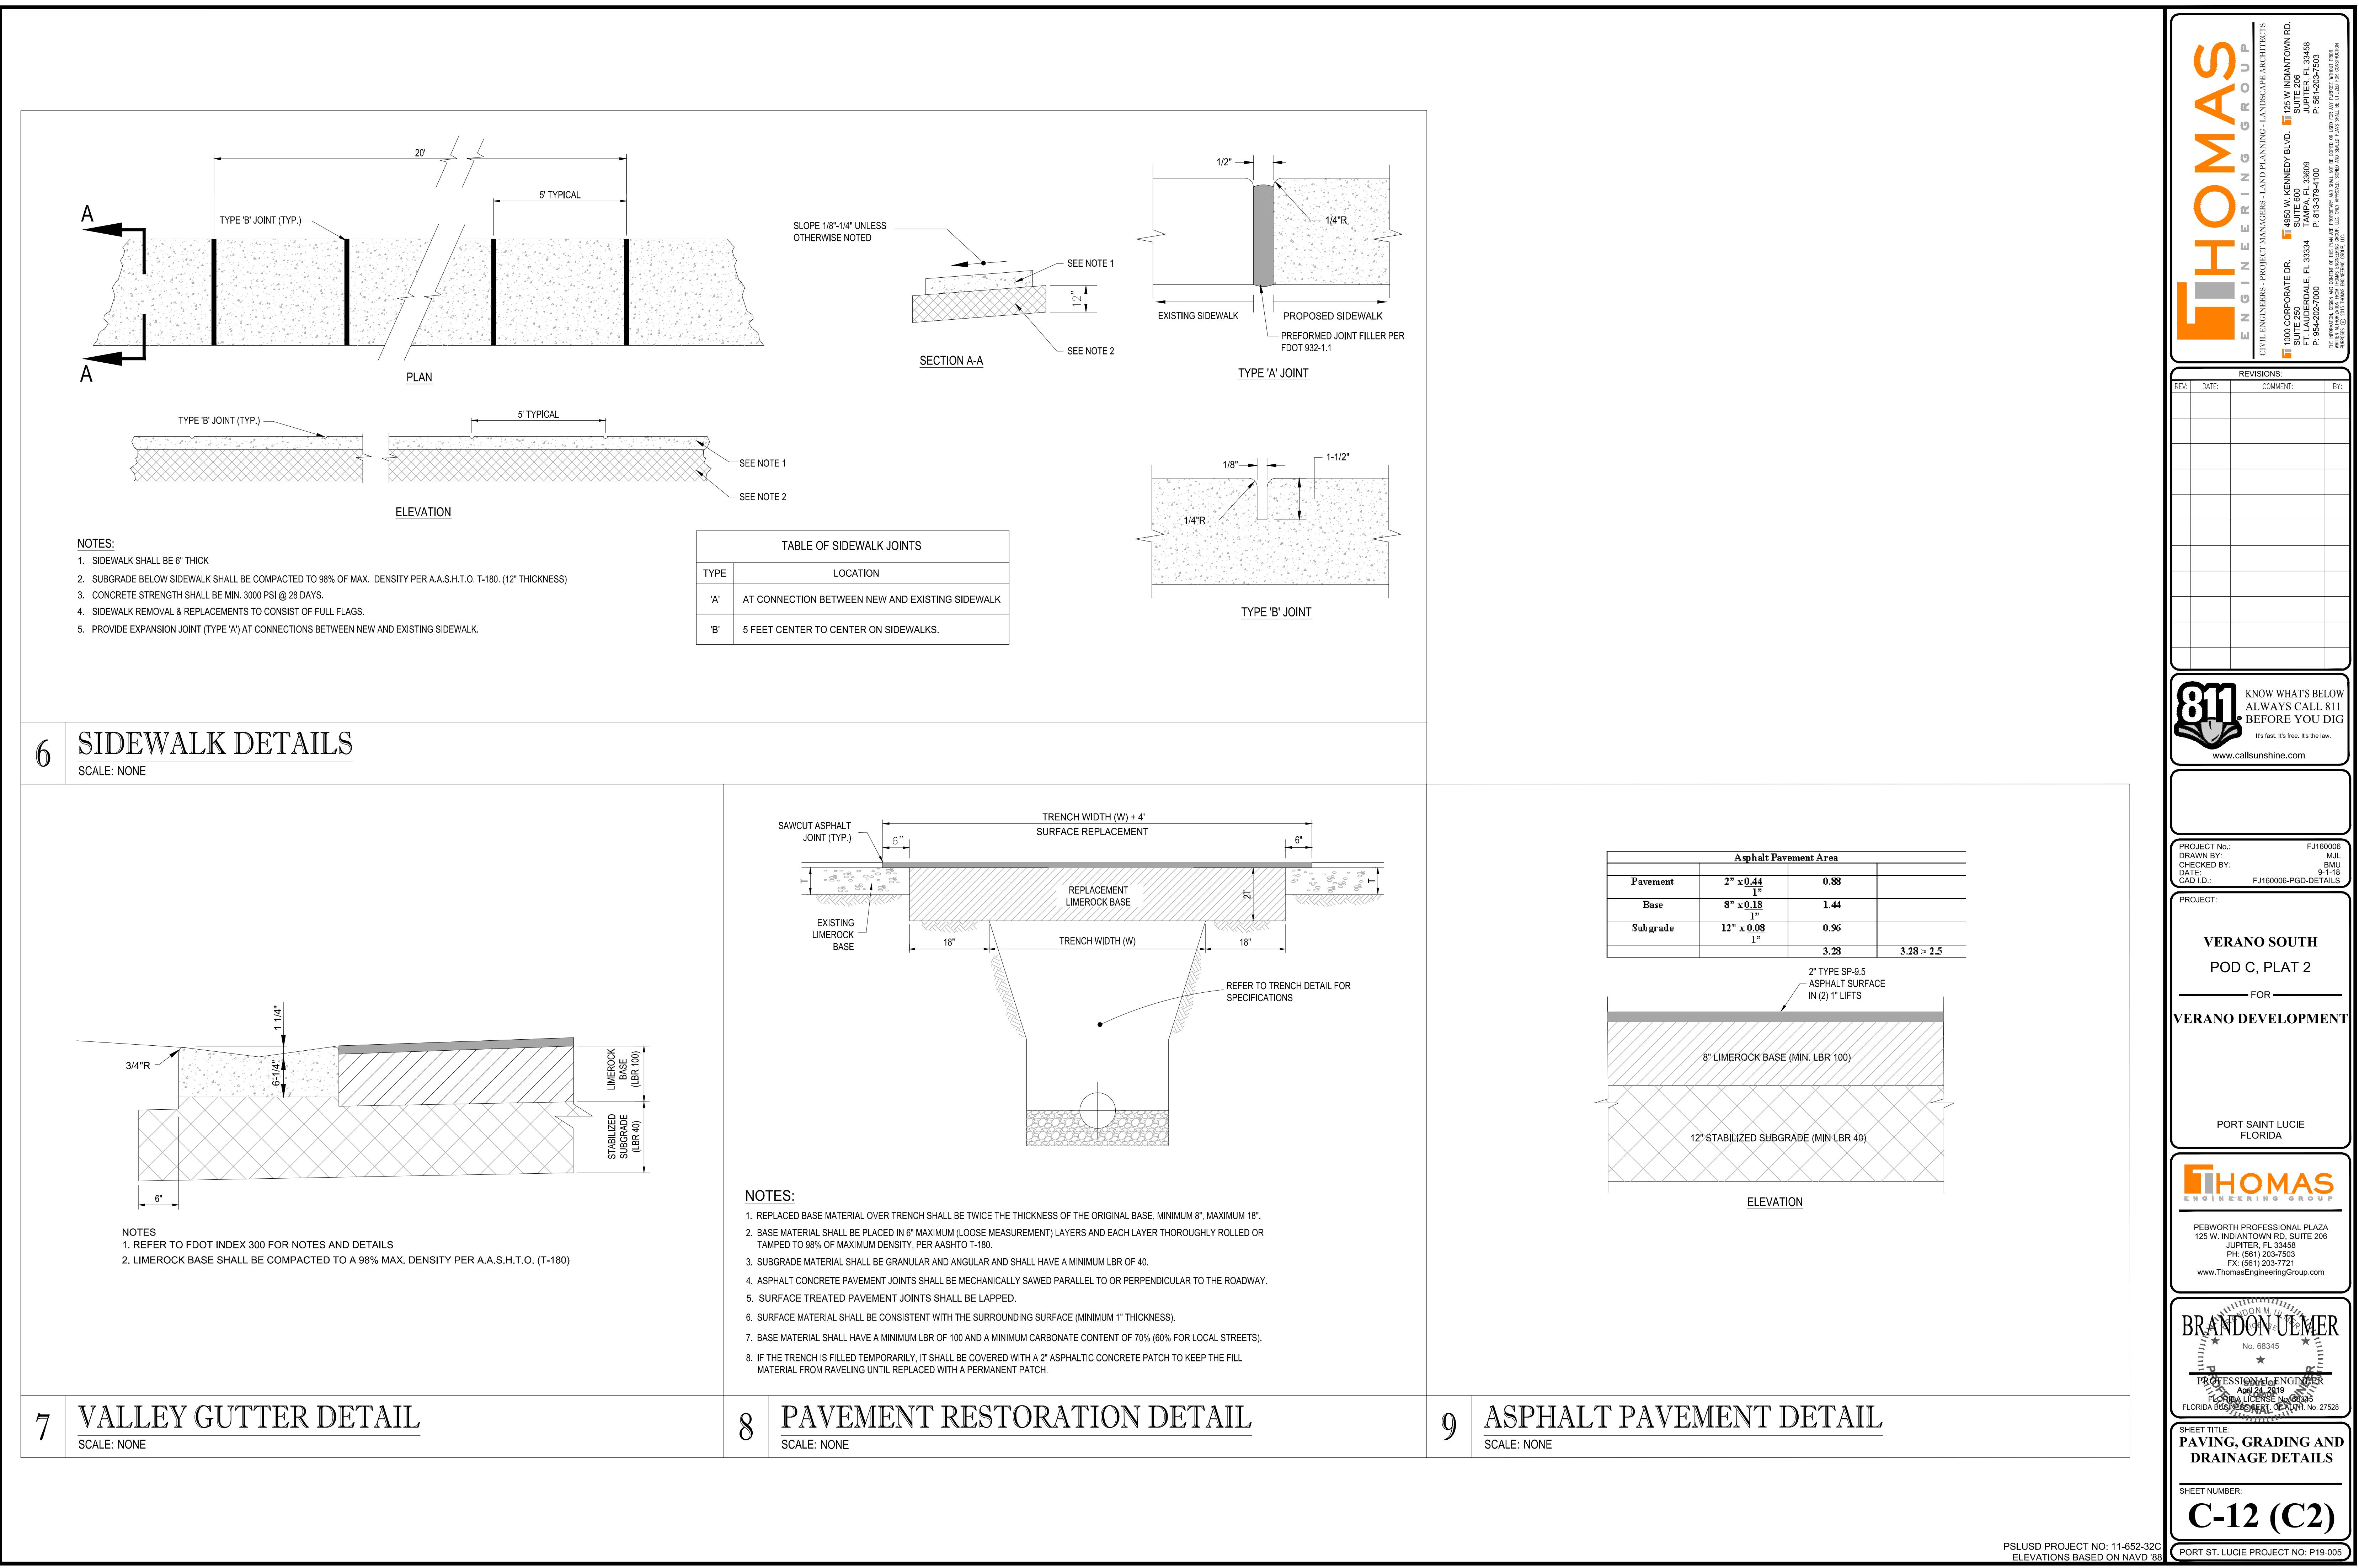

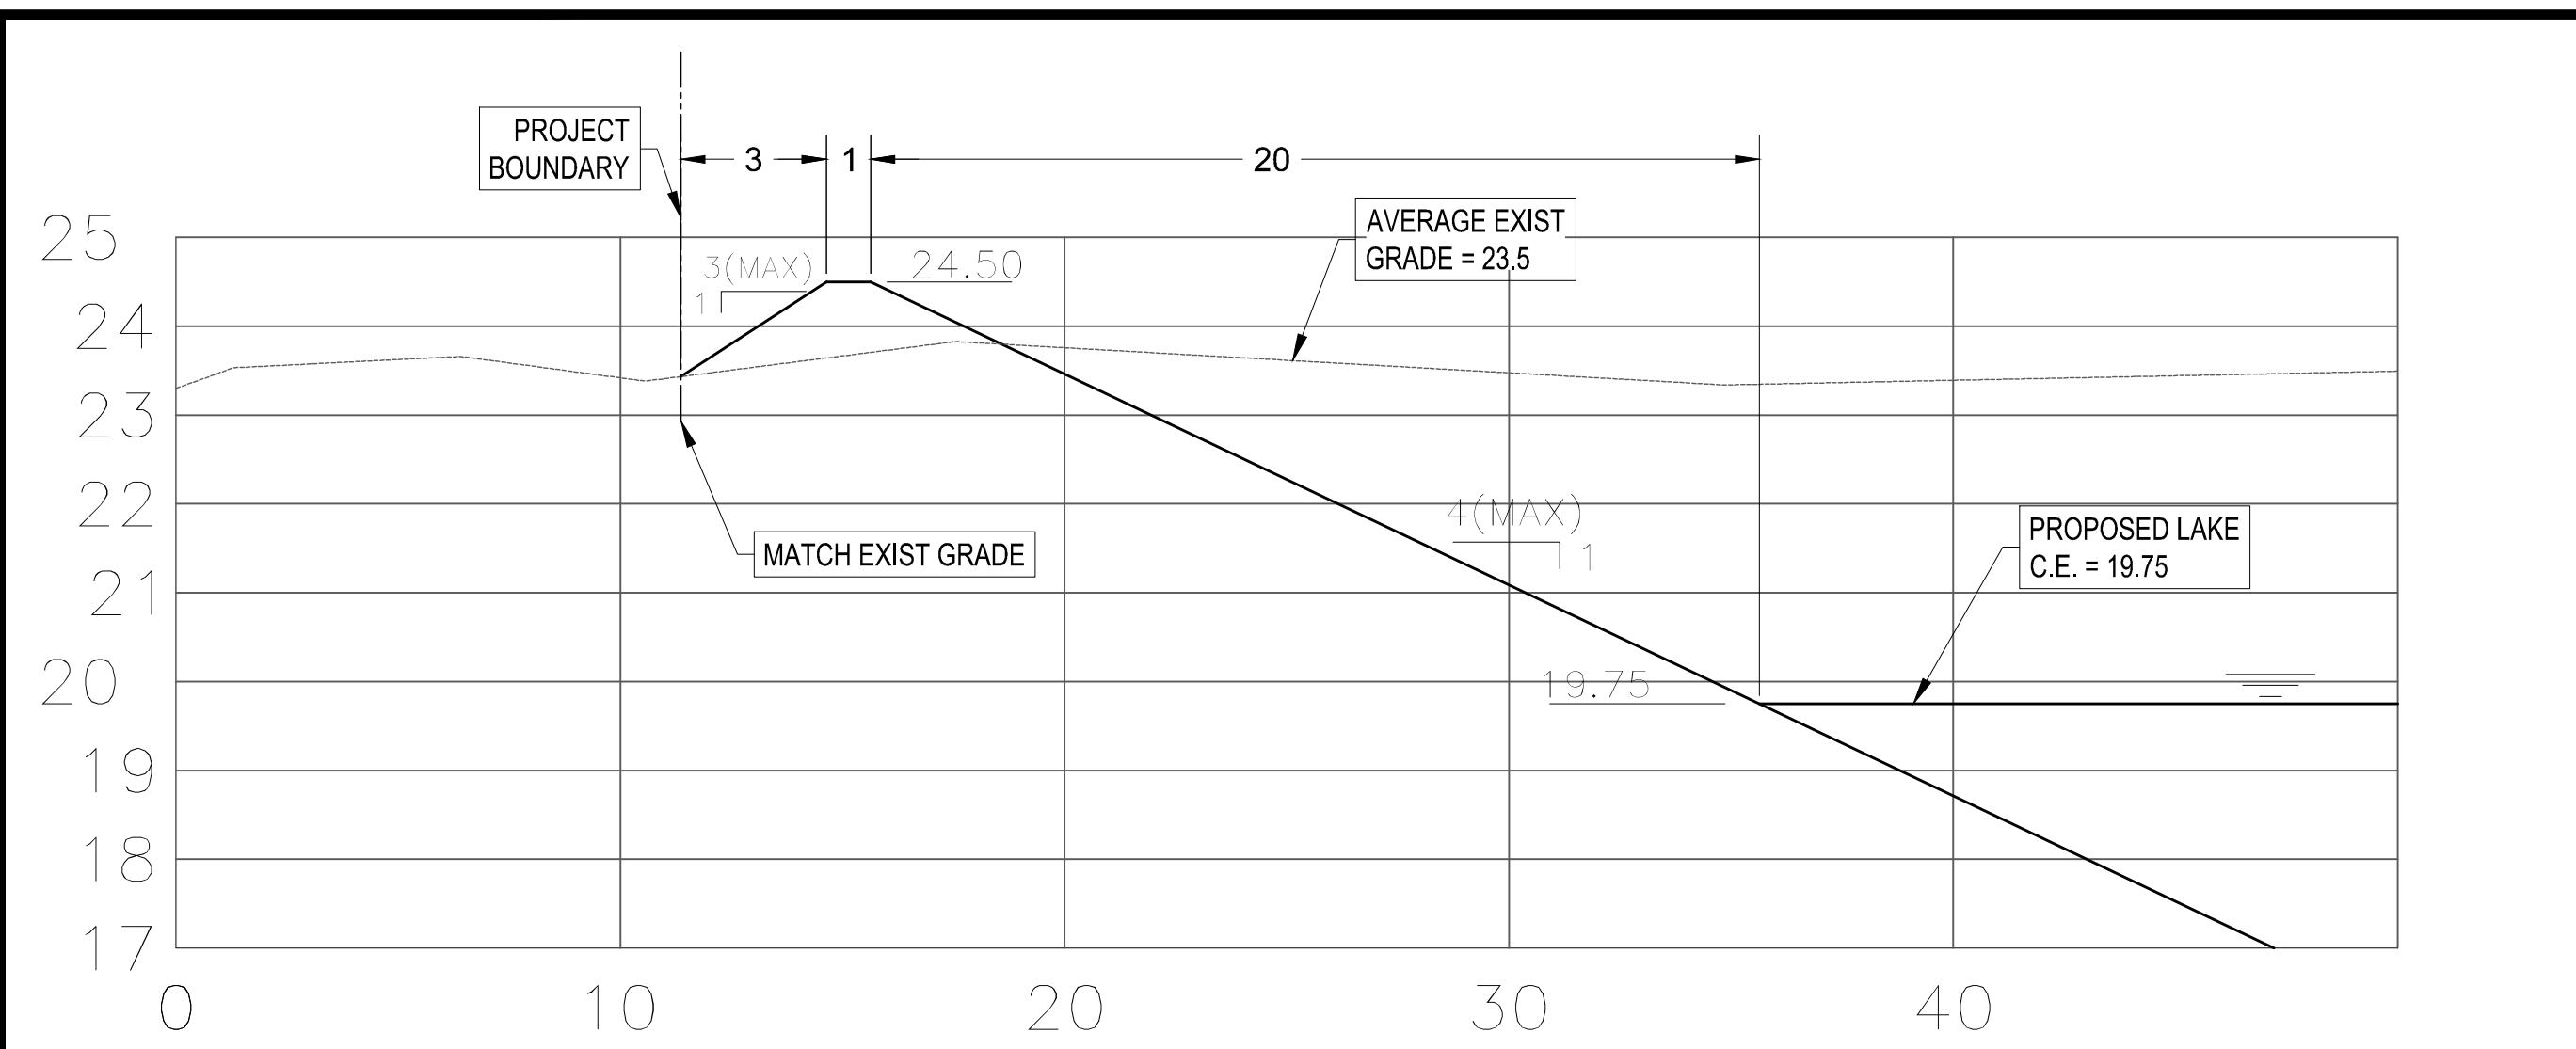
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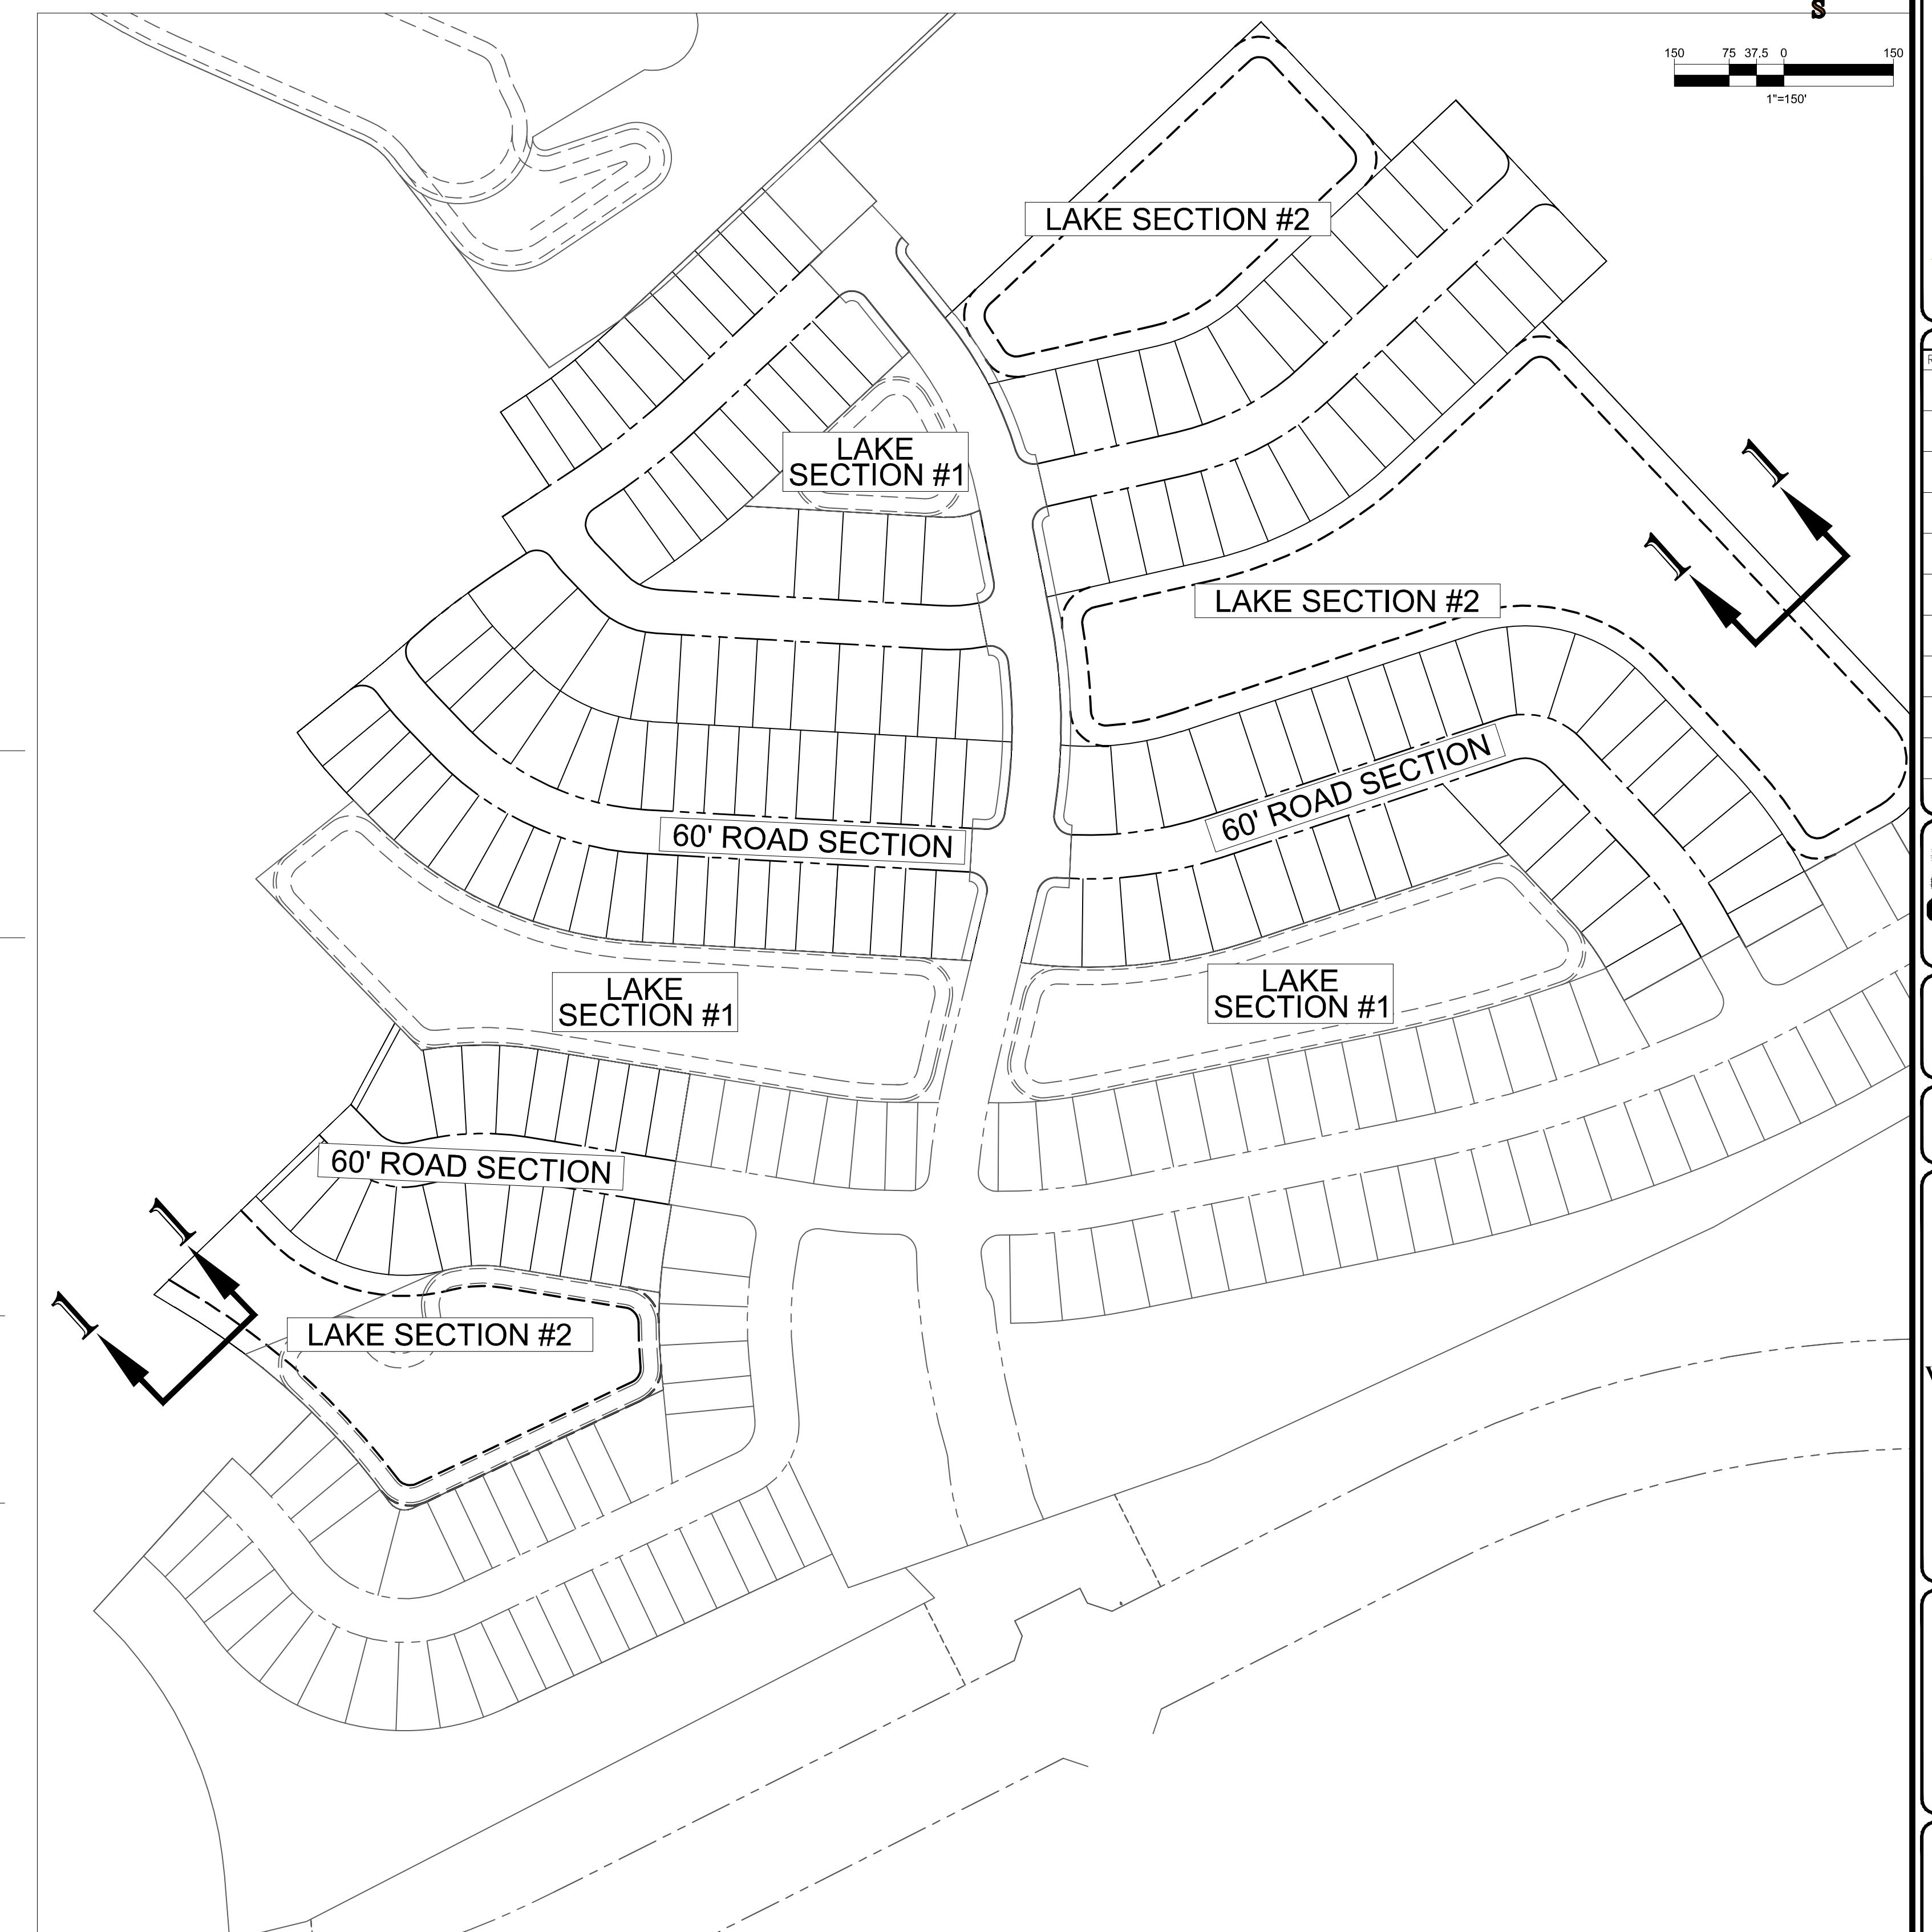
TYPICAL LAKE SECTION #1



TYPICAL LAKE SECTION #2

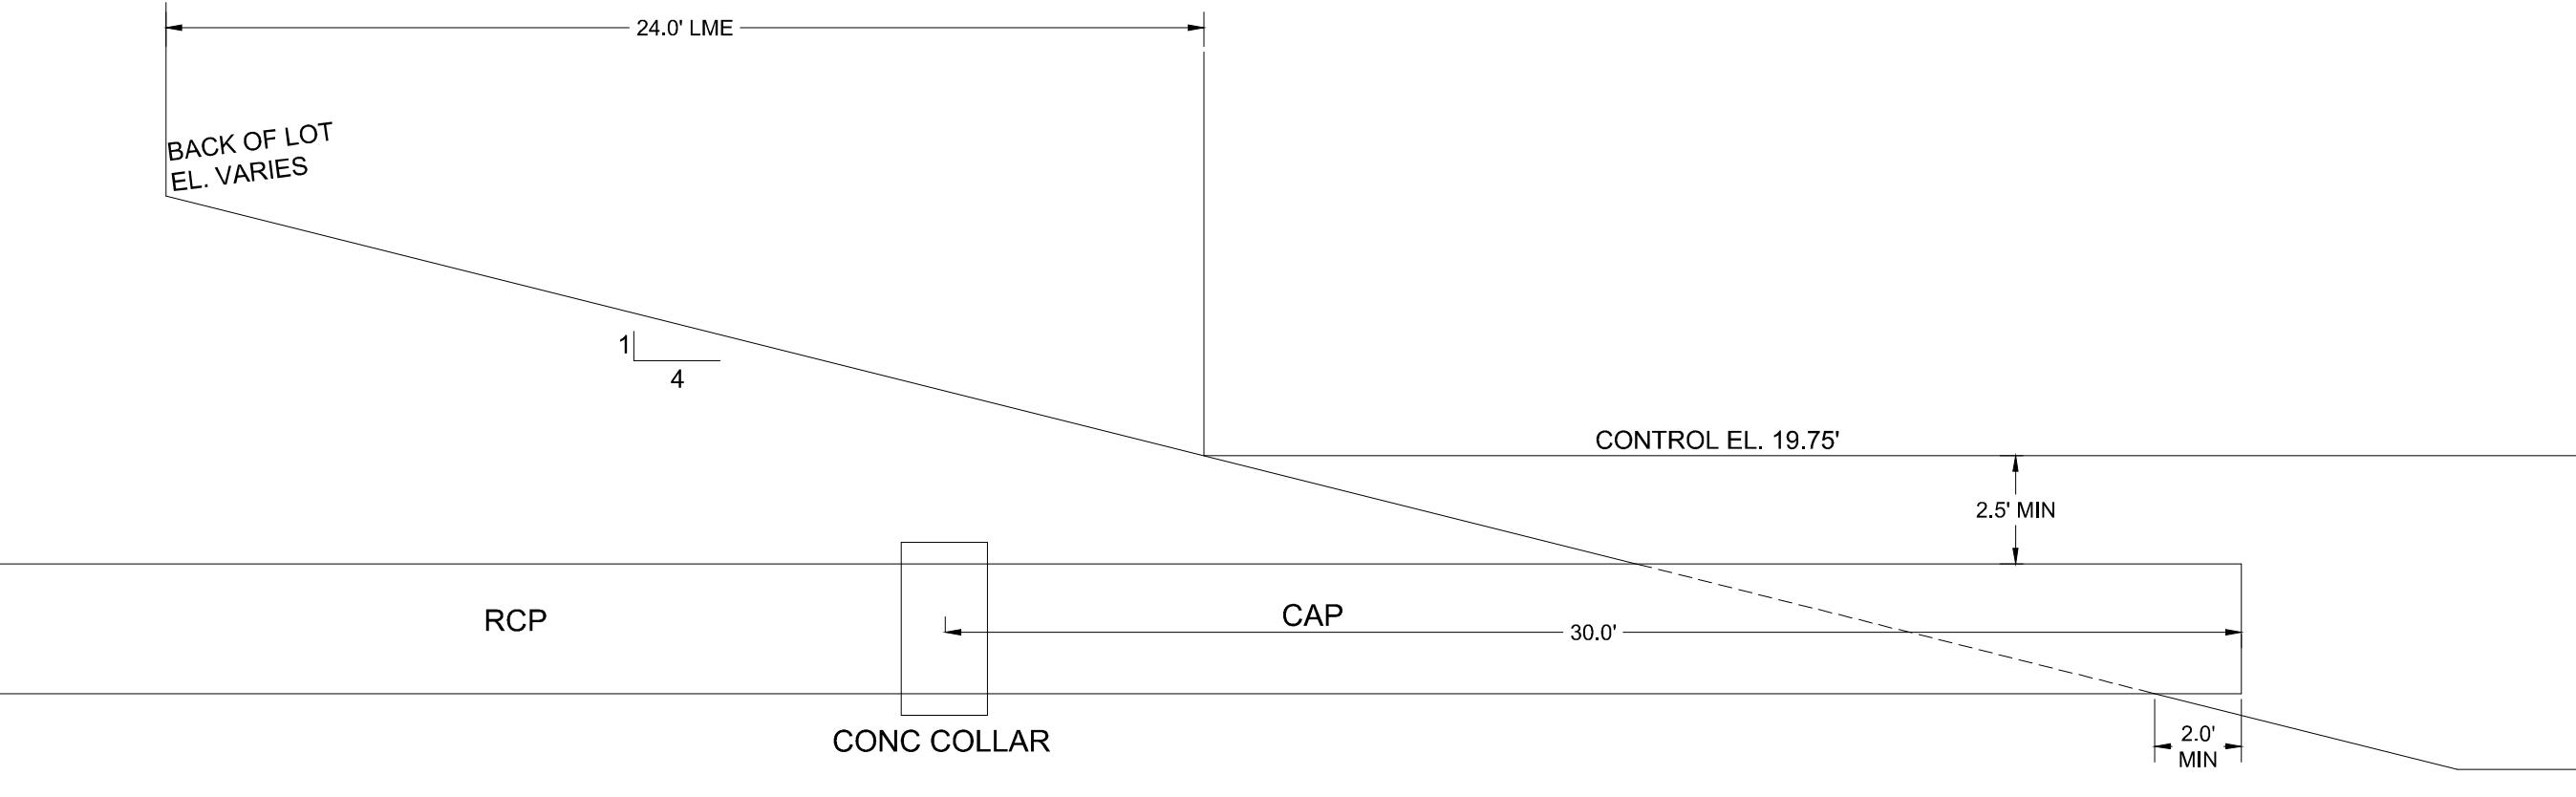

60' RIGHT-OF-WAY  
TYPICAL SECTION

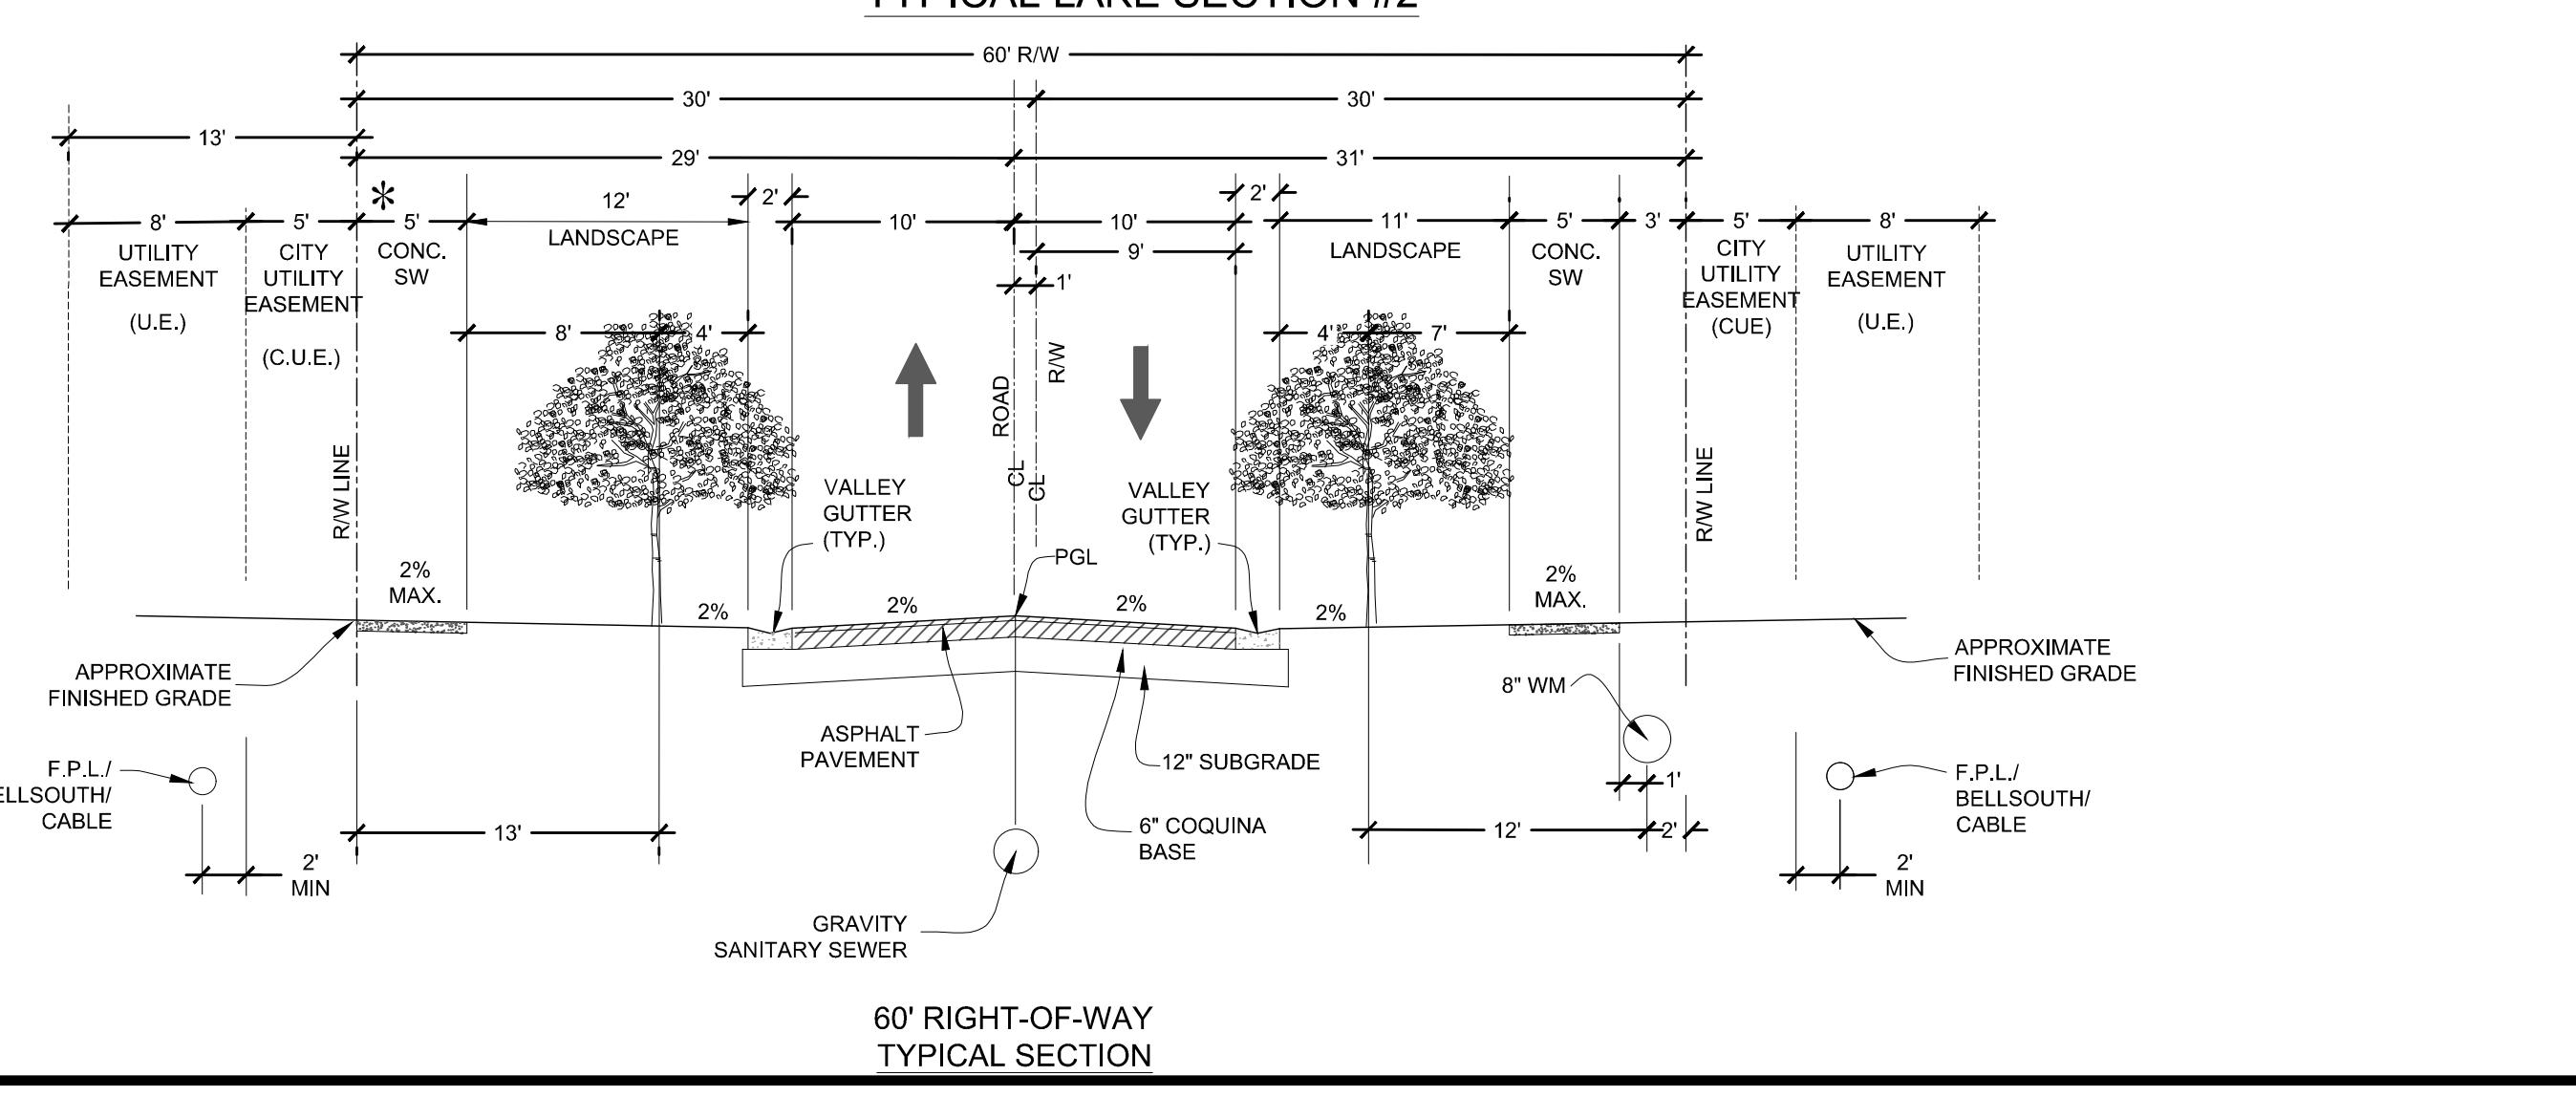

SECTIONS LOCATION MAP

**THOMAS**  
ENGINEERING GROUP  
CIVIL ENGINEERS - PROJECT MANAGERS - LAND PLANNING - LANDSCAPE ARCHITECTS  
100 CORPORATE DR.  
SUITE 100  
FT. LAUDERDALE, FL 33344  
P: 954-292-7000  
F: 954-292-7001  
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REVISIONS:  
REV: DATE: COMMENT: BY:  
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PROJECT No.: FJ160006  
DRAWN BY: M.J.L.  
CHECKED BY: D.W.M.  
DATE: 9-1-18  
CAD.I.D.: FJ160006-PGD-SECTIONS

PROJECT:  
VERANO SOUTH  
POD C, PLAT 2  
FOR  
VERANO DEVELOPMENT

PORT SAINT LUCIE  
FLORIDA

**THOMAS**  
ENGINEERING GROUP  
PEBWORTH PROFESSIONAL PLAZA  
125 W. INDIANTOWN, SUITE 206  
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FX: (561) 203-7721  
www.ThomasEngineeringGroup.com

BRANDON ULMER  
No. 68345  
PROFESSIONAL ENGINEER  
FLORIDA LICENSE NO. 048345  
FLORIDA BUSINESS PRACTICE No. 27528

SHEET TITLE:  
PAVING, GRADING AND  
DRAINAGE SECTIONS

SHEET NUMBER:  
C-13 (C2)



A horizontal number line with tick marks at 0, 20, and 40. The segment from 0 to 20 is shaded black, the segment from 20 to 40 is white, and the segment from 40 to the end of the line is black.



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PROJECT No.:	FJ160006
DRAWN BY:	MJL
CHECKED BY:	BMU
DATE:	9-1-18
CAD I.D.:	FJ160006-MASTER-UTIL

PROJECT: **VERANO SOUTH**  
**POD C, PLAT 2**  
— FOR —  
**VERANO DEVELOPMENT**

# PORT SAIN LUCIE FLORIDA

The logo for Thomas Engineering Group. It features a stylized orange 'T' icon followed by the word 'HOMAS' in large, bold, orange letters. Below 'HOMAS' is the word 'ENGINEERING GROUP' in a smaller, grey, sans-serif font. A horizontal line is positioned below the text.

**SHEET TITLE:**

---

SHEET NUMBER:

# C-14 (C2)

## CONSTRUCTION NOTES:

1. CONTRACTOR TO SAW-CUT AT ALL LOCATIONS OF REMOVAL OF EXISTING CONC. S/W, CONC. CURB AND ASPHALT UNLESS OTHERWISE NOTED. ALL BASE AND SUBBASE MATERIAL SHALL BE REMOVED WITHIN THE PROPOSED LANDSCAPED AREA.
2. CONTRACTOR TO MATCH EXIST. GRADES AND TO CONSTRUCT A SMOOTH TRANSITION FROM EXISTING FACILITIES TO PROPOSED.
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6. ALL EXISTING TRAFFIC SIGNS DISTURBED DURING CONSTRUCTION SHALL BE REINSTALLED WHERE APPLICABLE BY THE CONTRACTOR.
7. THESE PLANS REFLECT CONDITIONS KNOWN DURING PLAN DEVELOPMENT. IN THE EVENT THAT ACTUAL PHYSICAL CONDITIONS PREVENT THE APPLICATION OF THESE STANDARDS OR THE PROGRESSION OF THE WORK, THE CONTRACTOR SHALL NOTIFY THE ENGINEER PRIOR TO CONSTRUCTION OF AFFECTED AREA.
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9. NOTIFY SUNSHINE STATE ONE CALL (1-800-432-4770) OR (811) PRIOR TO CONSTRUCTION.
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FJ160

**ANNO SOUTH  
D C, PLAT 2  
FOR**


PORT SAINT LUCIE  
FLORIDA

# THOMAS ENGINEERING GROUP

# WATER AND SEWER PLAN


15 (C2)

# ENGINEERING LEGEND

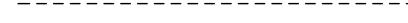
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STORM SEWER	
SANITARY SEWER MAIN	
SANITARY SEWER LATERAL	
CATCH BASIN	
MANHOLE	
FIRE HYDRANT	
DECORATIVE LIGHTING	
RIGHT OF WAY	
UTILITY EASEMENT	
WATER SERVICE	
SEWER SERVICE	

ELUSD PROJECT NO. 11-032-32C  
ELEVATIONS BASED ON NAVD '88

10.1007/s00332-010-9000-0

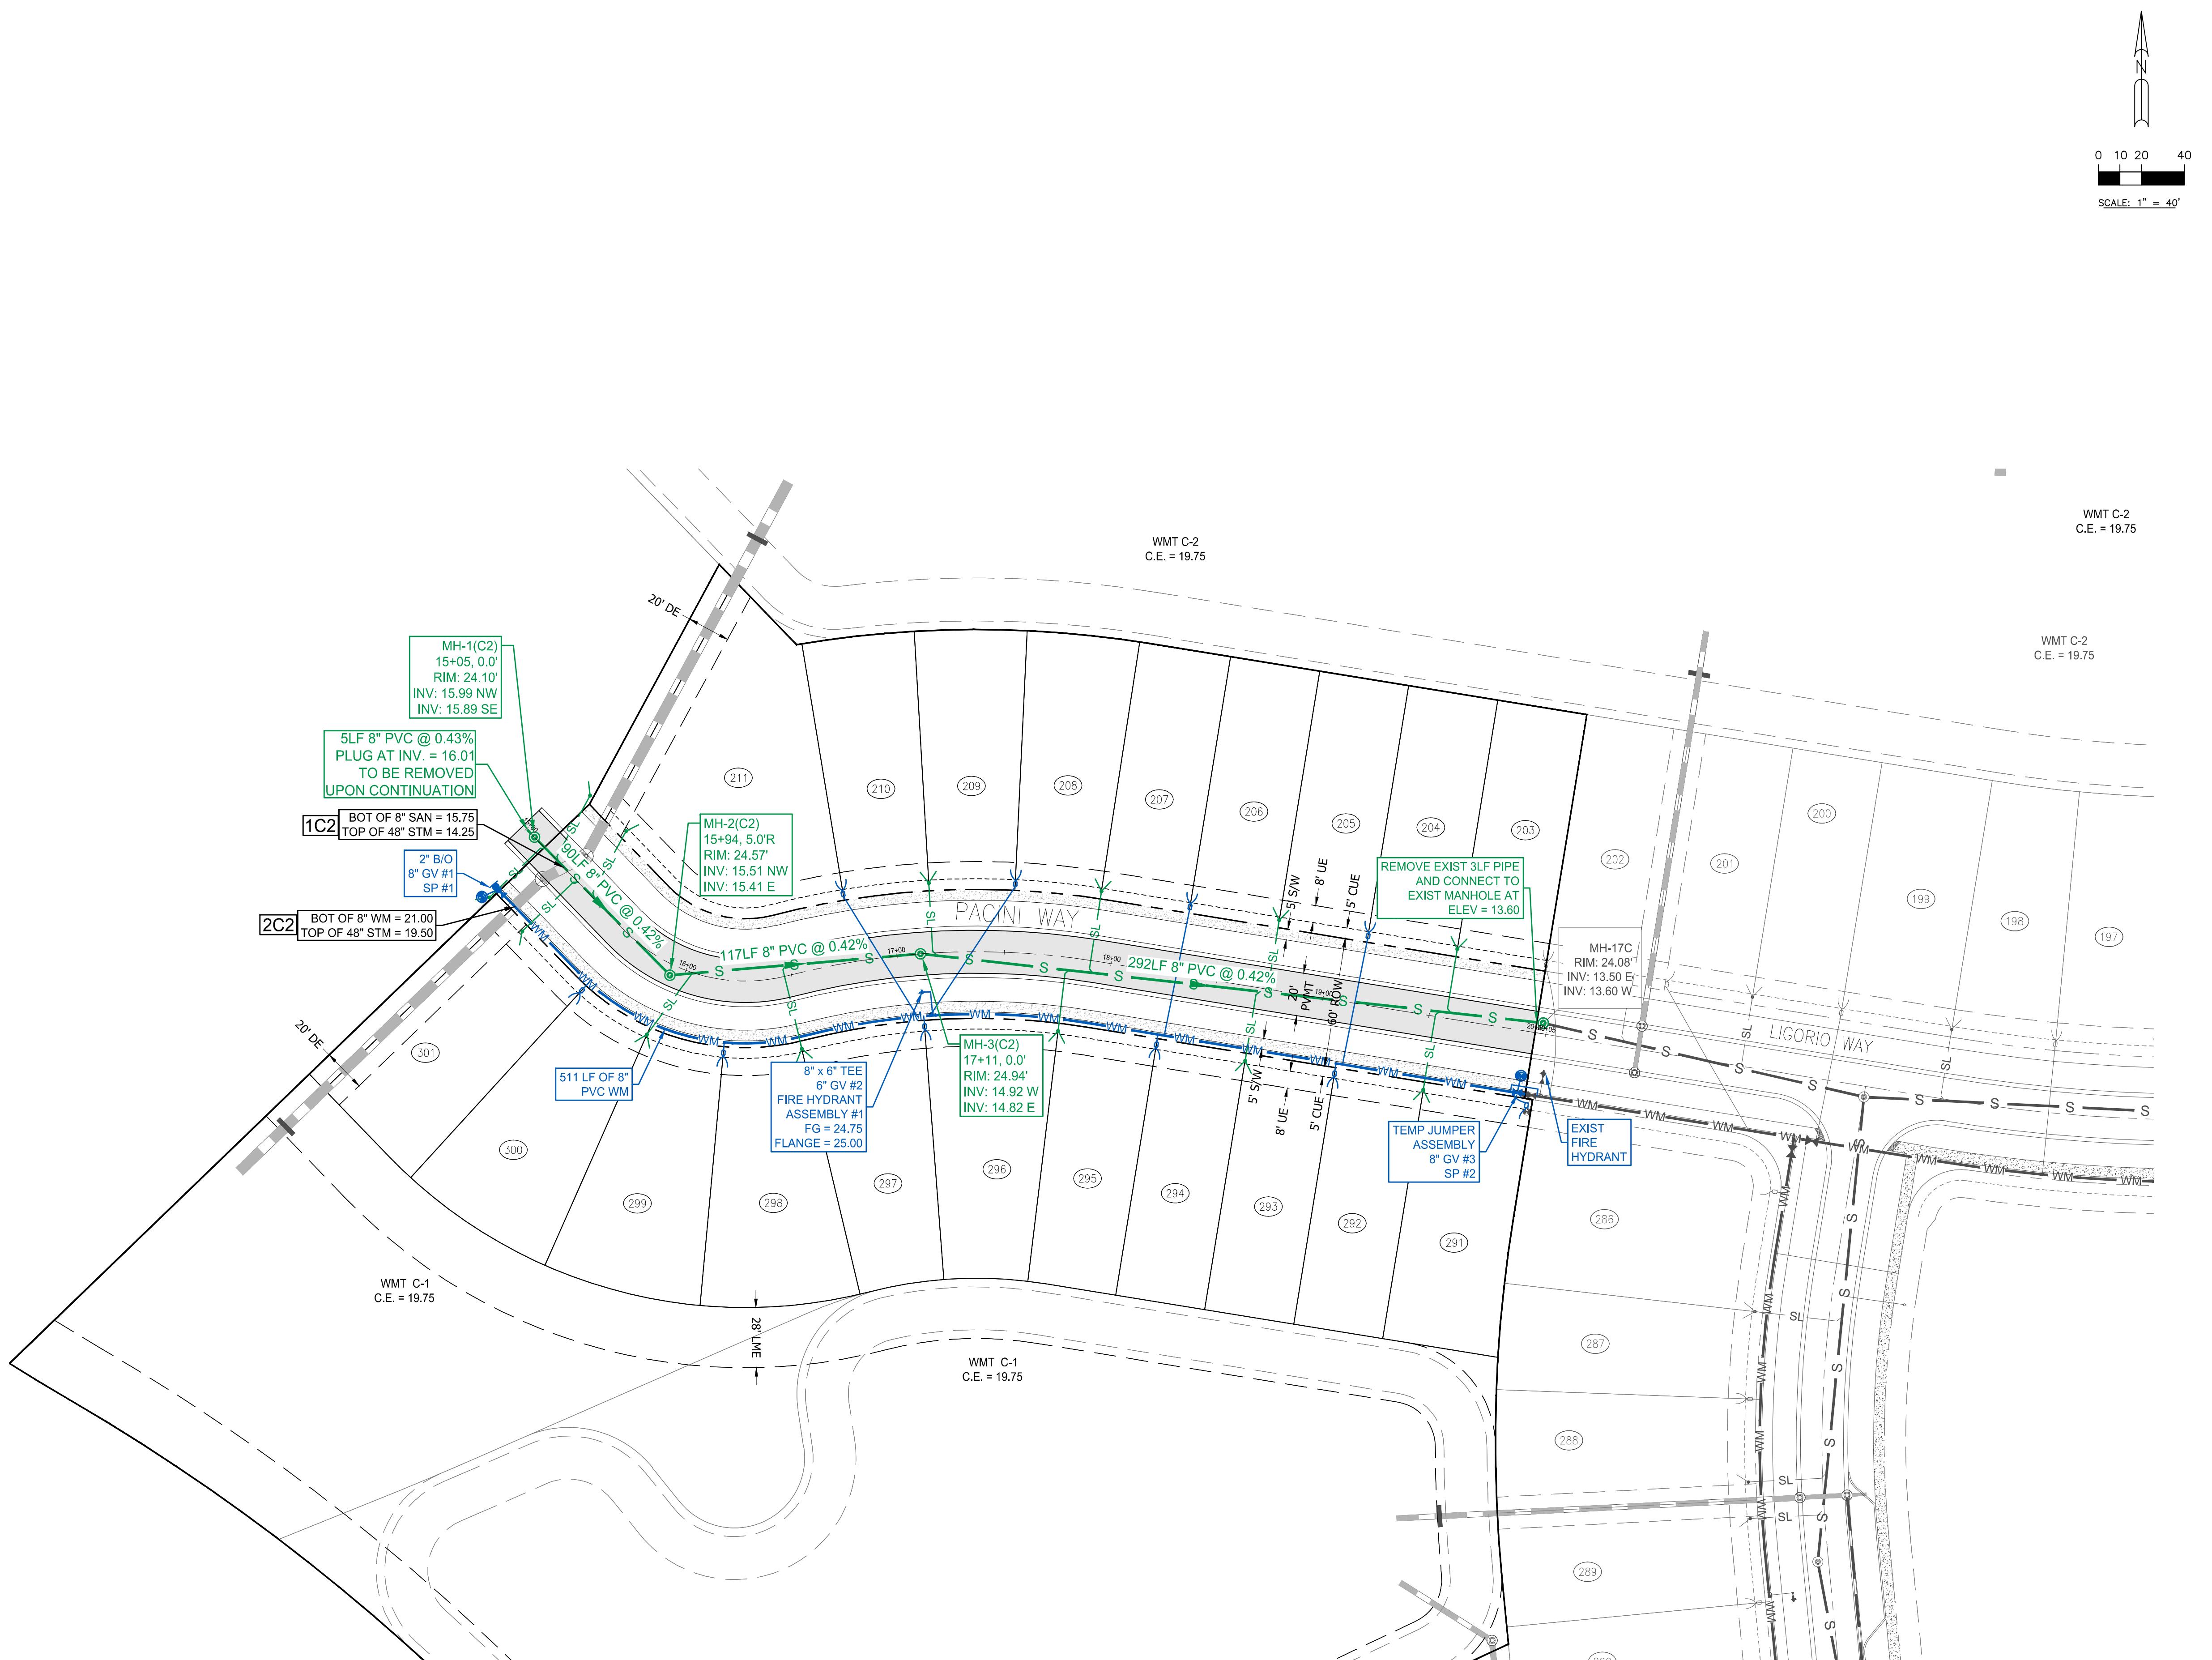




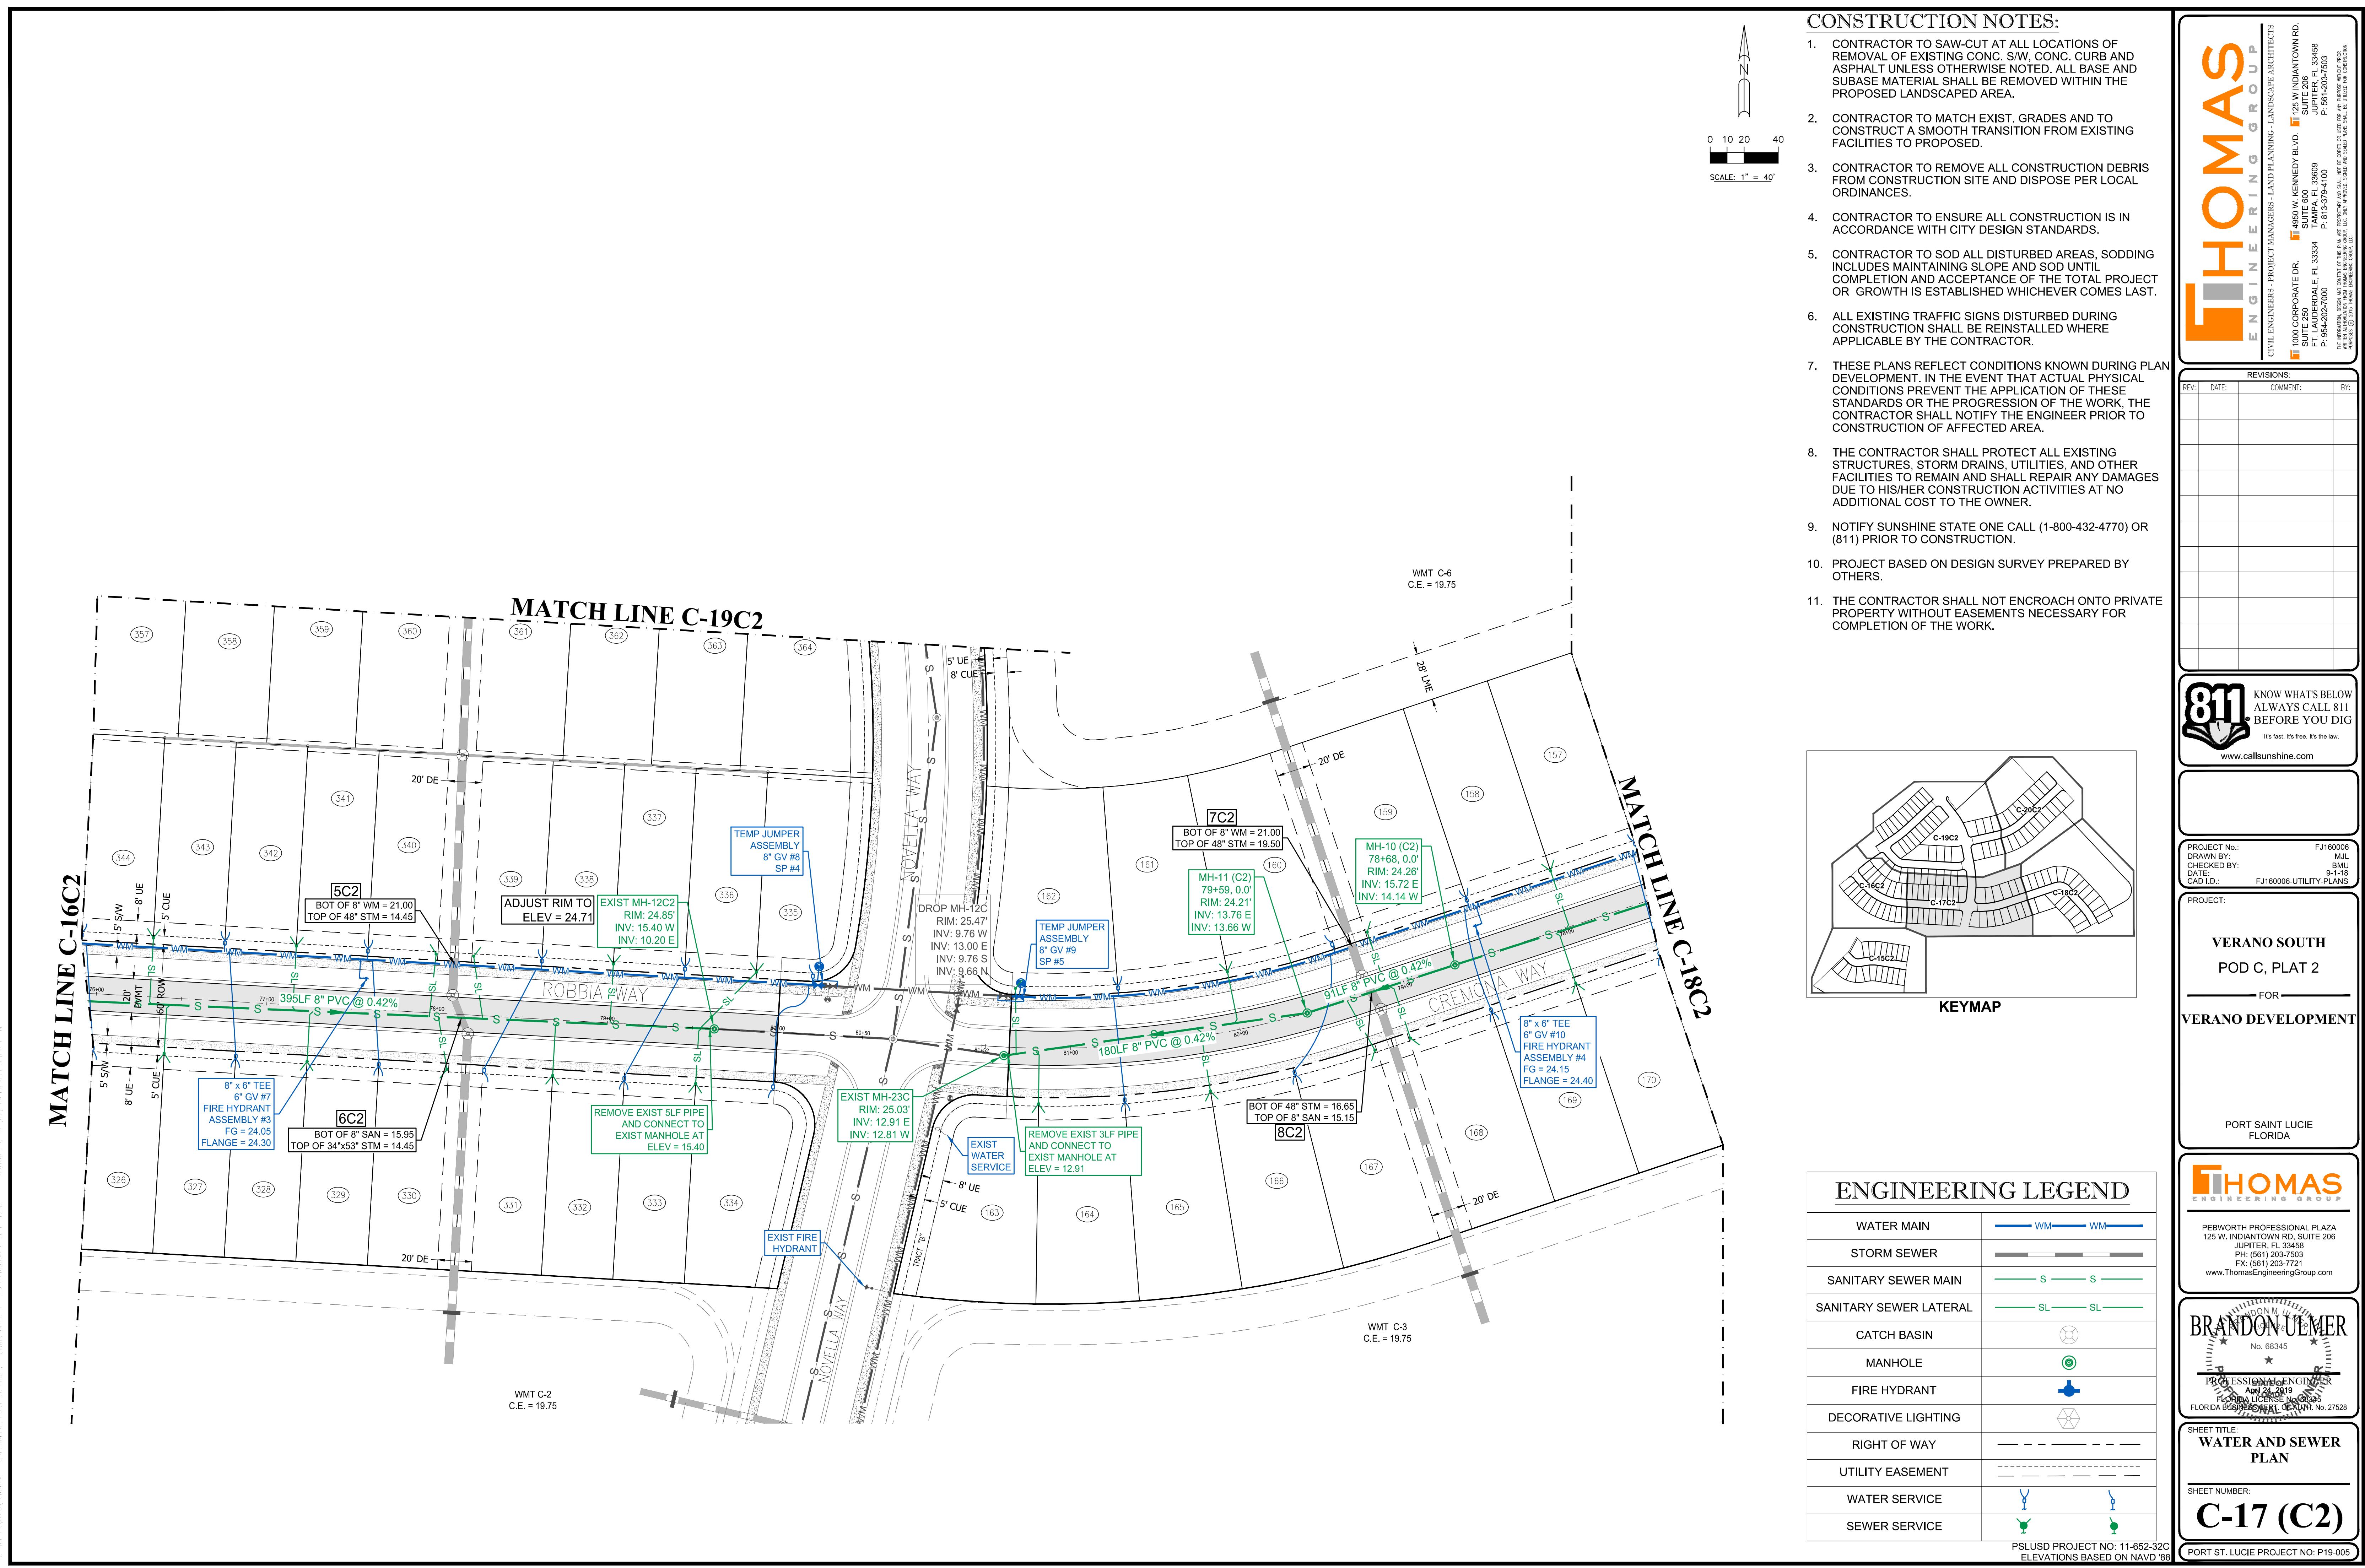


Printed on Wednesday, April 24, 2019, 4:47 PM by Michael Lepeltier  
Professional Computing Solutions  
1200 23rd Street, Suite 200  
Denver, CO 80205  
Phone: 303-296-1111  
Fax: 303-296-1112  
Email: [info@denverpc.com](mailto:info@denverpc.com)

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## CONSTRUCTION NOTES:


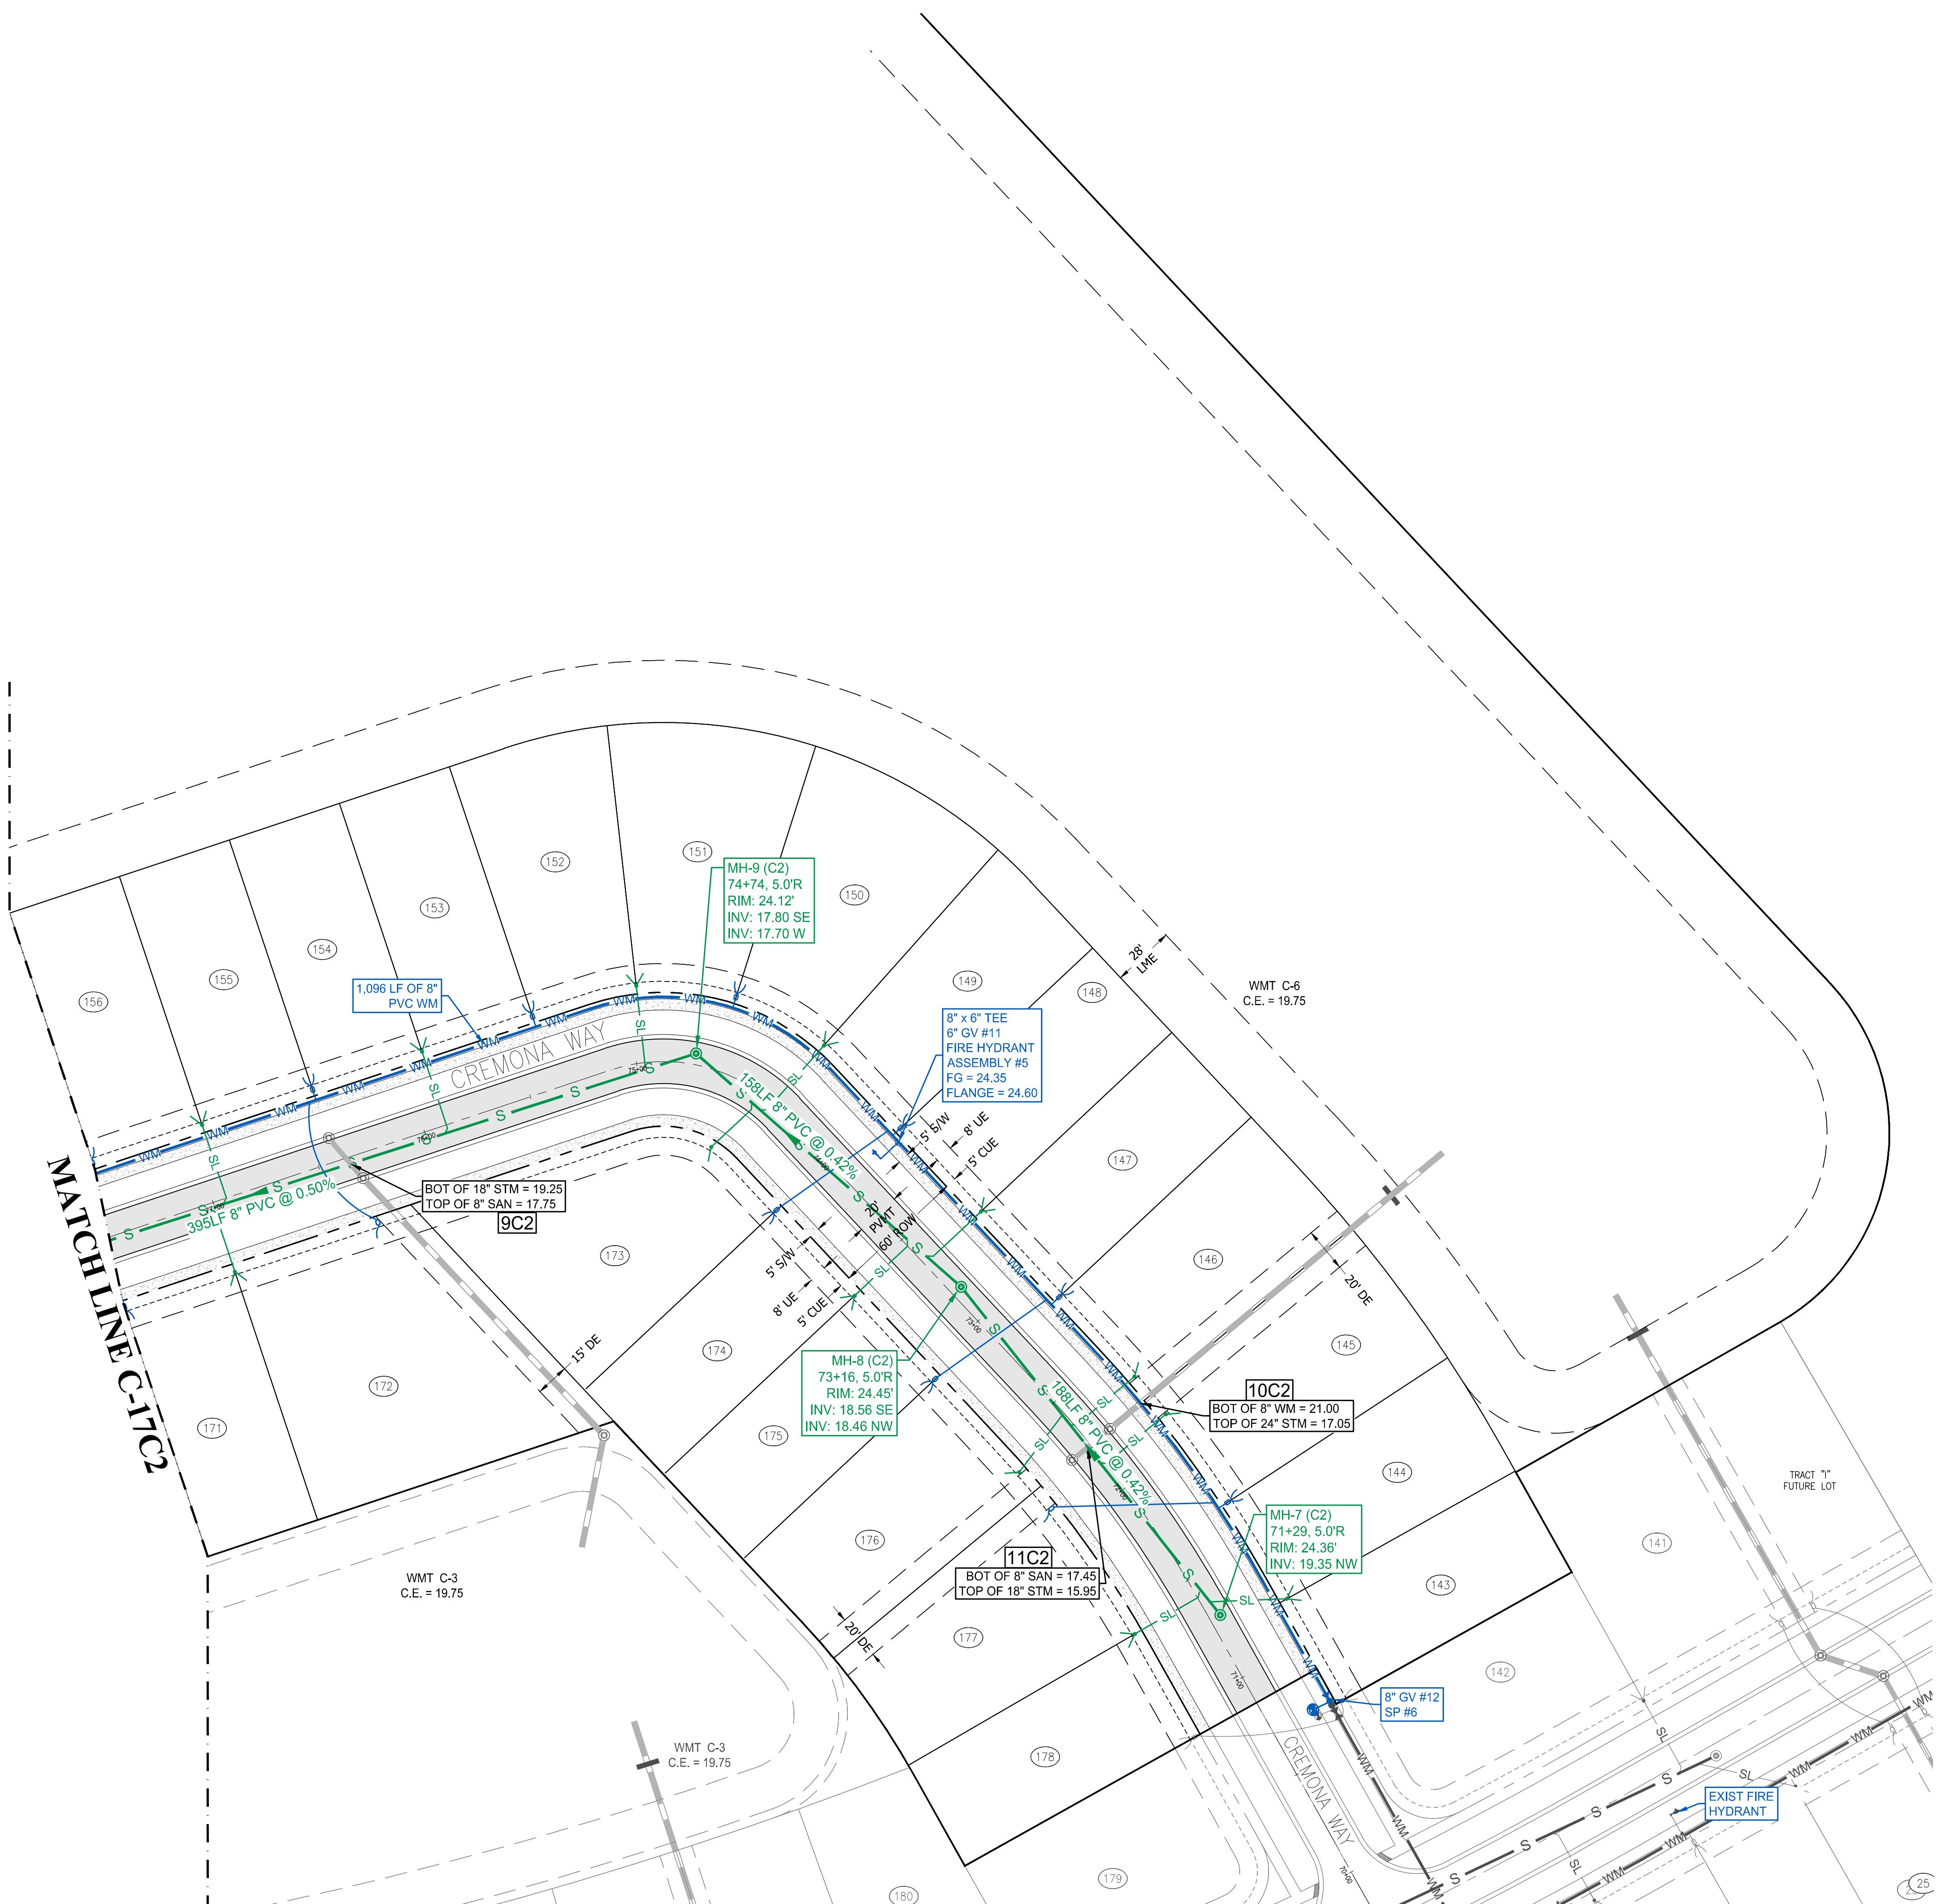
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10. PROJECT BASED ON DESIGN SURVEY PREPARED BY OTHERS.
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## KEYMAP

# ENGINEERING LEGEND

WATER MAIN	
STORM SEWER	
SANITARY SEWER MAIN	
SANITARY SEWER LATERAL	
CATCH BASIN	
MANHOLE	
FIRE HYDRANT	
DECORATIVE LIGHTING	
RIGHT OF WAY	
UTILITY EASEMENT	
WATER SERVICE	 
SEWER SERVICE	 

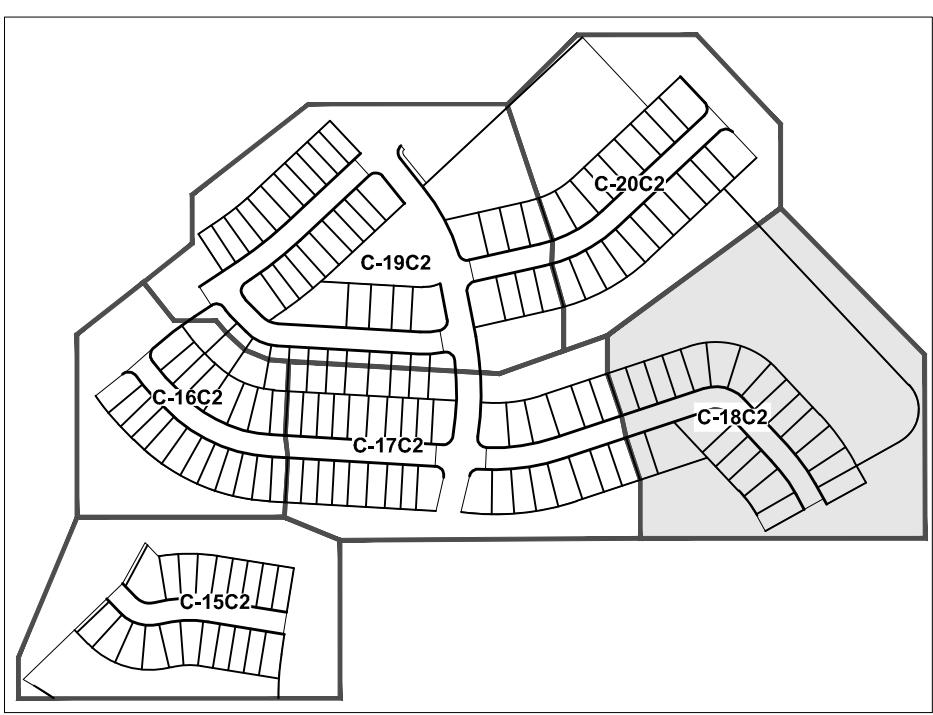

PROJECT No.:	FJ160006
DRAWN BY:	MJL
CHECKED BY:	BMU
DATE:	9-1-18
CAD I.D.:	FJ160006-UTILITY-PLANS

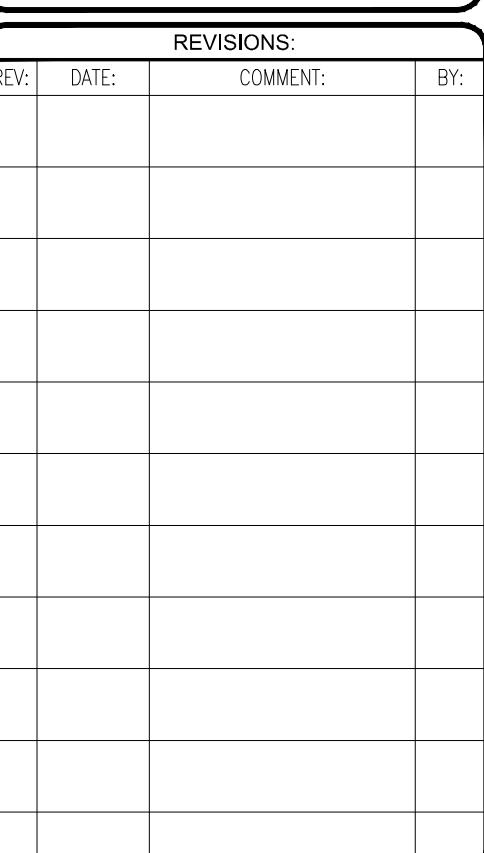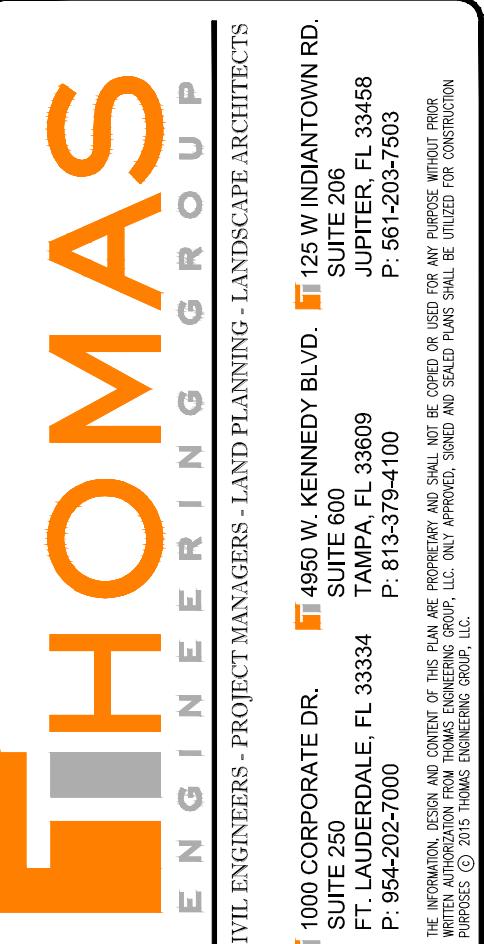PROJECT: **VERANO SOUTH**  
**POD C, PLAT 2**

---

FOR

---

VERANO DEVELOPMENT

PORT SAINT LUCIE



PEBWORTH PROFESSIONAL PLAZA  
125 W. INDIANTOWN RD, SUITE 206  
JUPITER, FL 33458  
PH: (561) 203-7503  
FX: (561) 203-7721  
[www.ThomasEngineeringGroup.com](http://www.ThomasEngineeringGroup.com)



A rectangular seal for a Professional Engineer. It features a black border with the words "PROFESSIONAL ENGINEER" at the top and "FLORIDA" at the bottom. Inside the border, there is a stylized background with vertical lines and a central five-pointed star. The date "April 24, 2019" is printed in the center. Below the date, the text "FLORIDA LICENSE No. 68345" and "FLORIDA BUSINESS CERT. OF HEALTH No. 27528" are printed.

SHEET TITLE:  
**WATER AND SEWER  
PLAN**


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SHEET NUMBER:

## C-18 (C2)


PLUSD PROJECT NO: 11-652-32C  
ELEVATIONS BASED ON NAVD '88  
PORT ST. LUCIE PROJECT NO: P19-005



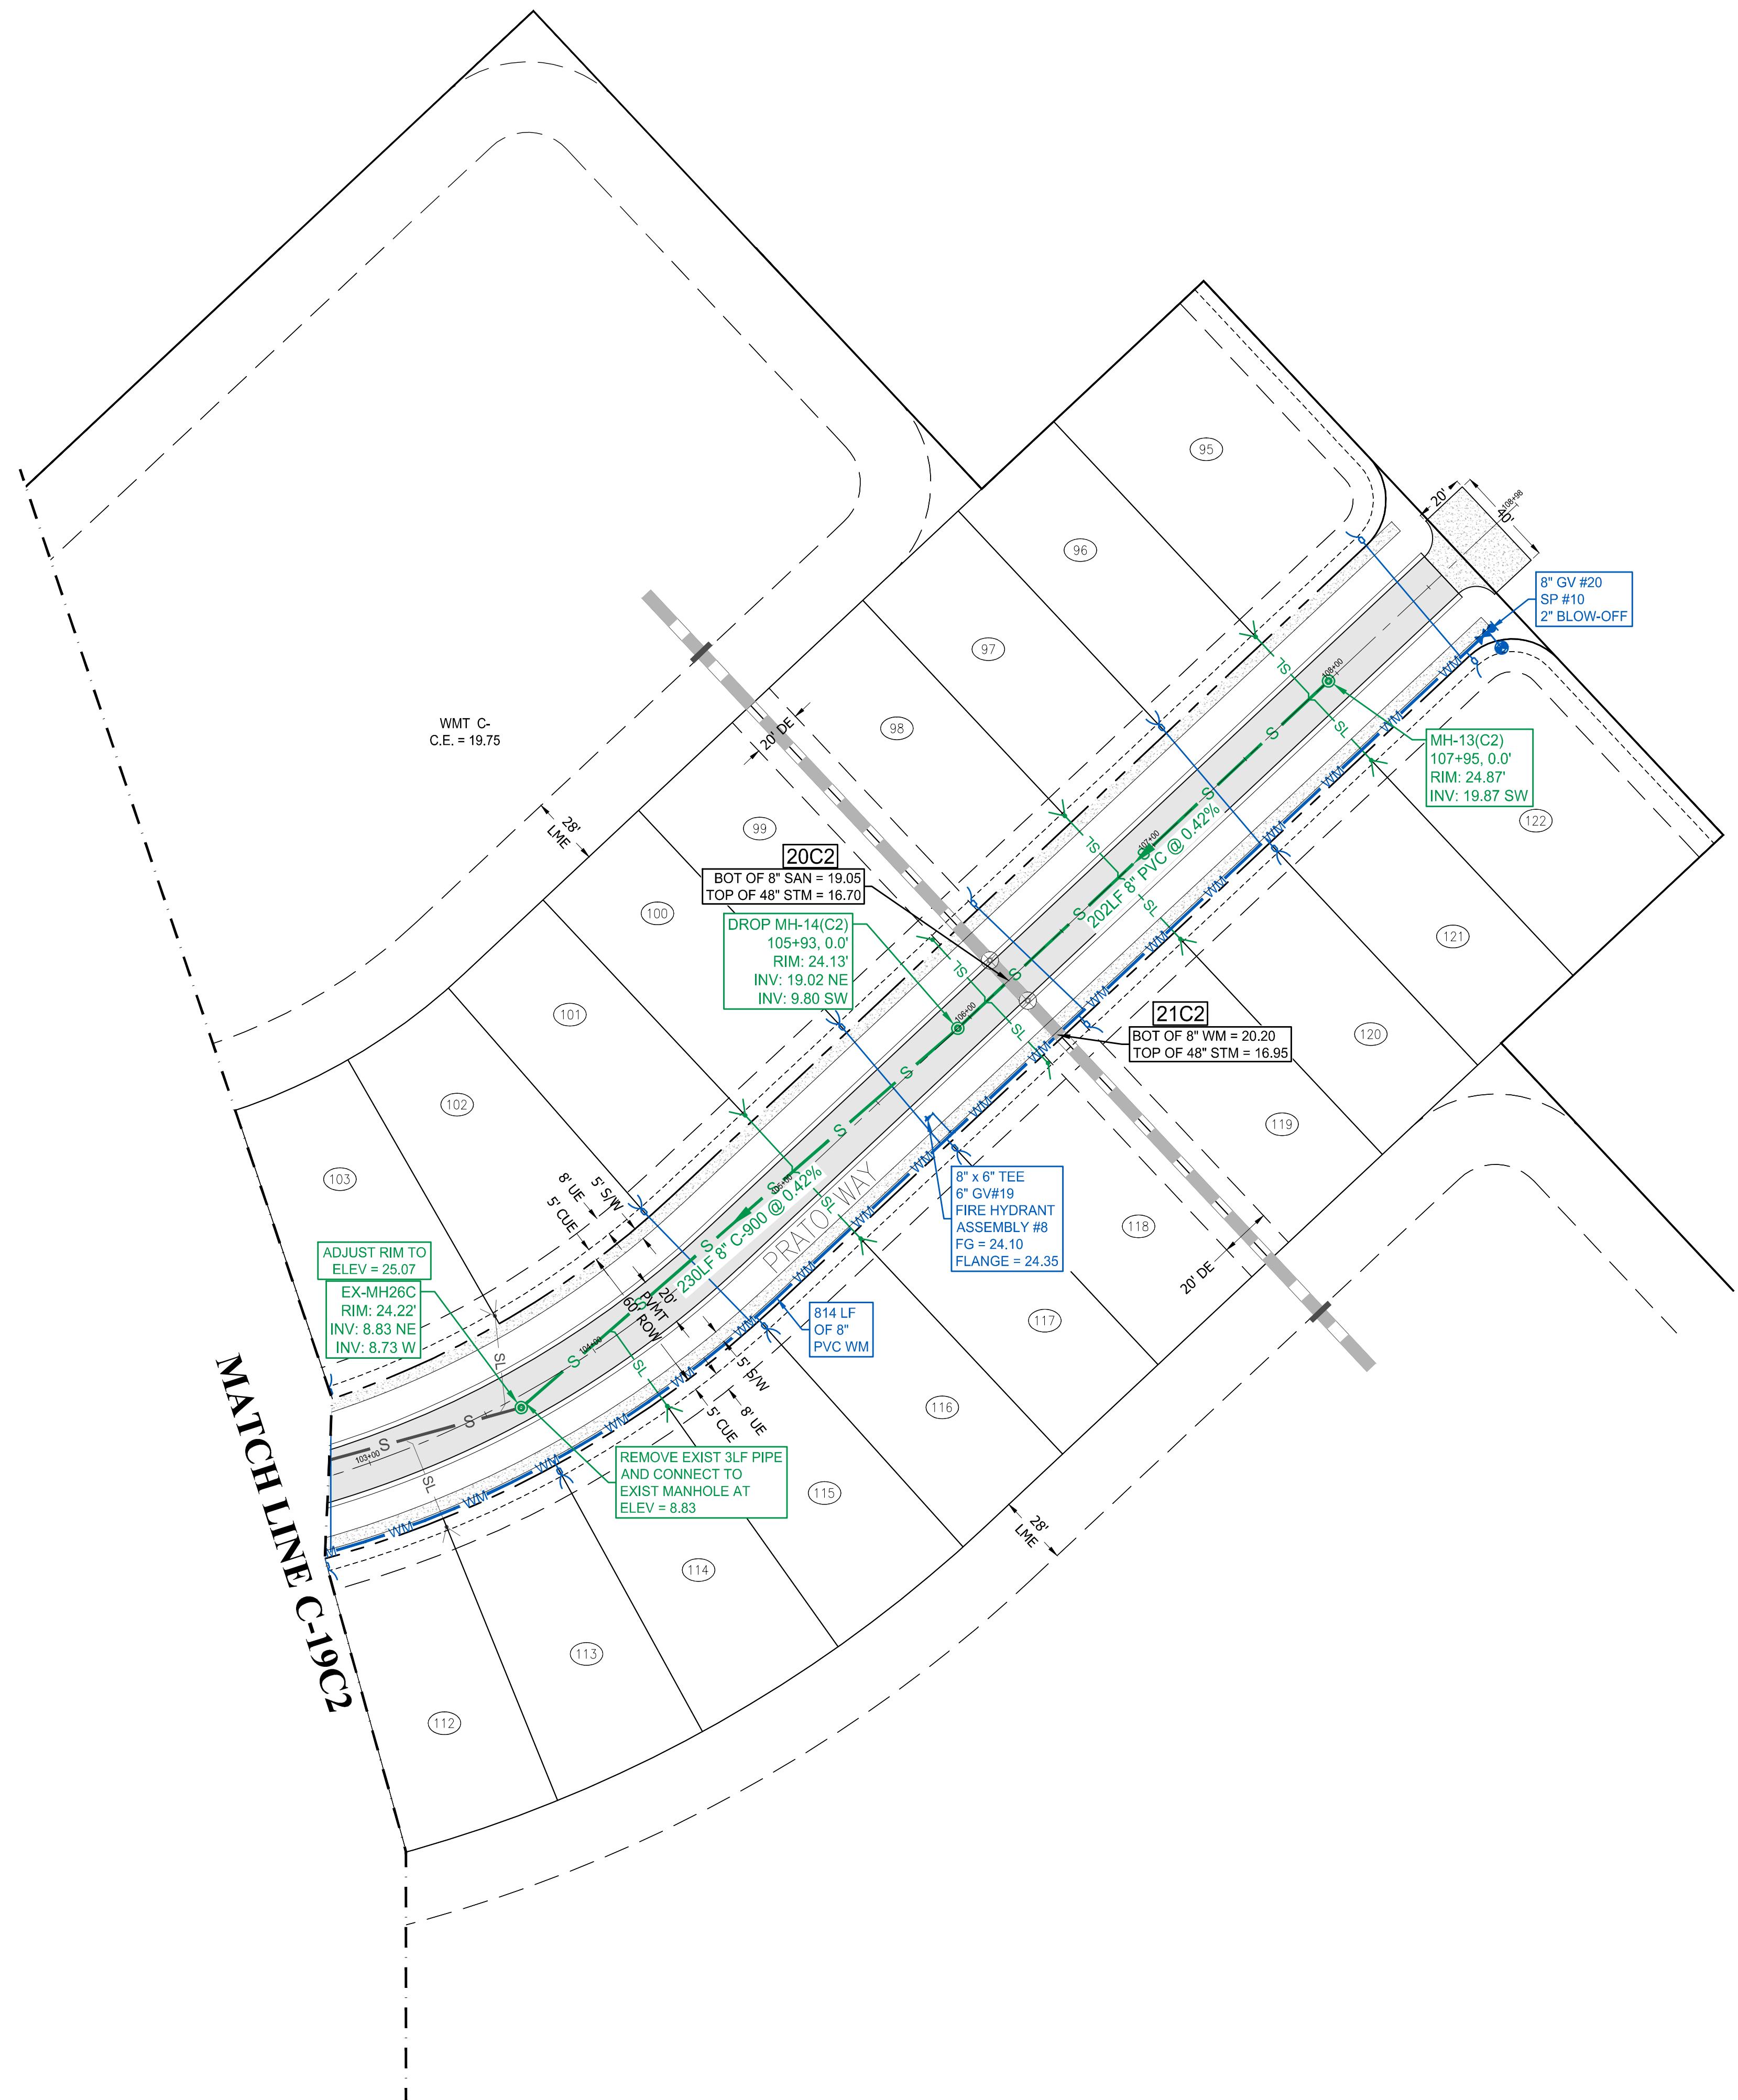


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PROJECT No.: FJ160006  
DRAWN BY: MJL  
CHECKED BY: BMU  
DATE: 9-1-18  
CAD I.D.: FJ160006-UTILITY-PLANS

## KEYMAP

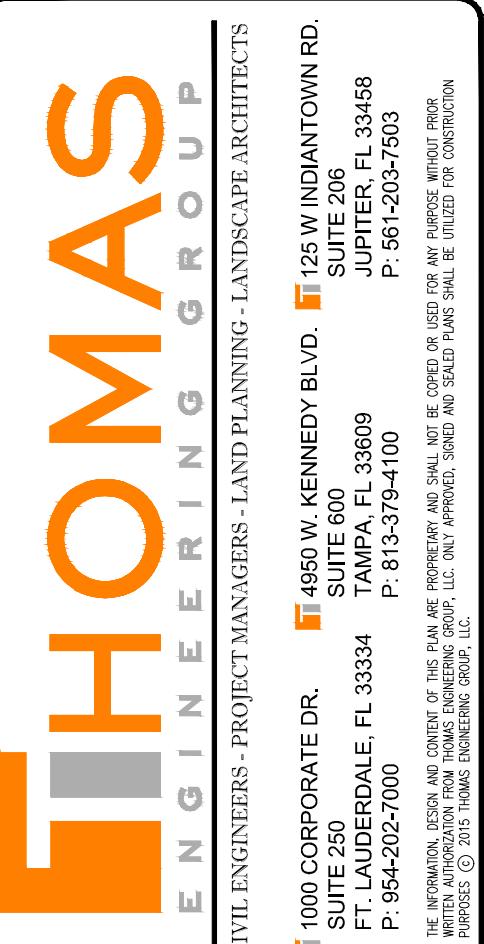

# VERANO SOUTH

## POD C, PLAT 2
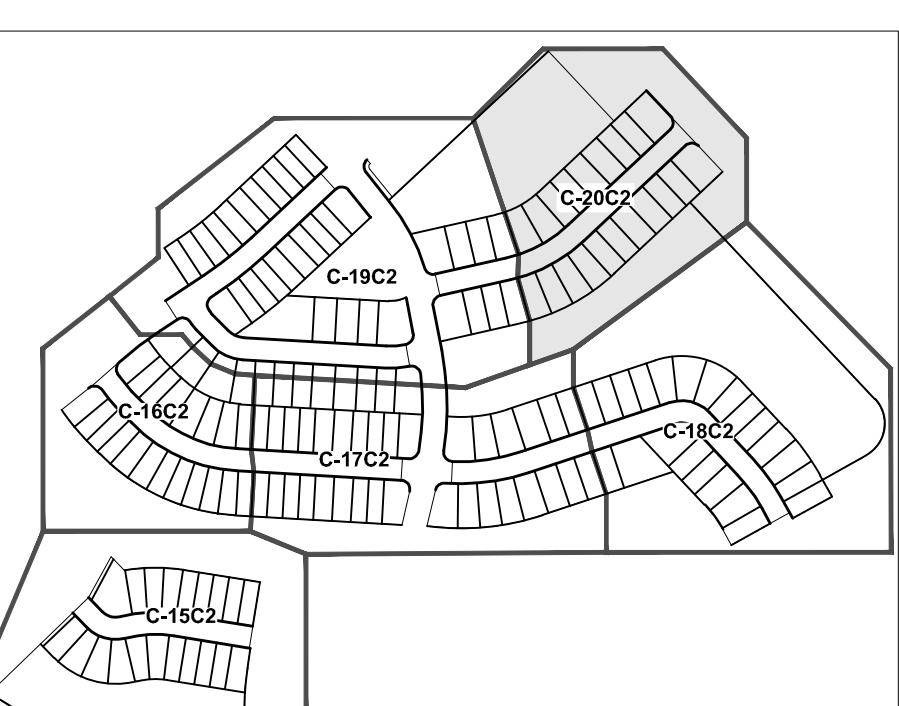
## PORT SAINT LUCIE






THOMAS  
ENGINEERING GROUP

PEBWORTH PROFESSIONAL PLAZA  
125 W. INDIANTOWN RD, SUITE 206  
JUPITER, FL 33458  
PH: (561) 203-7503  
FX: (561) 203-7721  
[www.ThomasEngineeringGroup.com](http://www.ThomasEngineeringGroup.com)

BRANDON UELMER  
No. 68345  
PROFESSIONAL ENGINEER  
April 24, 2019  
FLORIDA LICENSE No. 682245

# ENGINEERING LEGEND

WATER MAIN	
STORM SEWER	
SANITARY SEWER MAIN	
SANITARY SEWER LATERAL	
CATCH BASIN	
MANHOLE	
FIRE HYDRANT	
DECORATIVE LIGHTING	
RIGHT OF WAY	
UTILITY EASEMENT	
WATER SERVICE	 
SEWER SERVICE	 

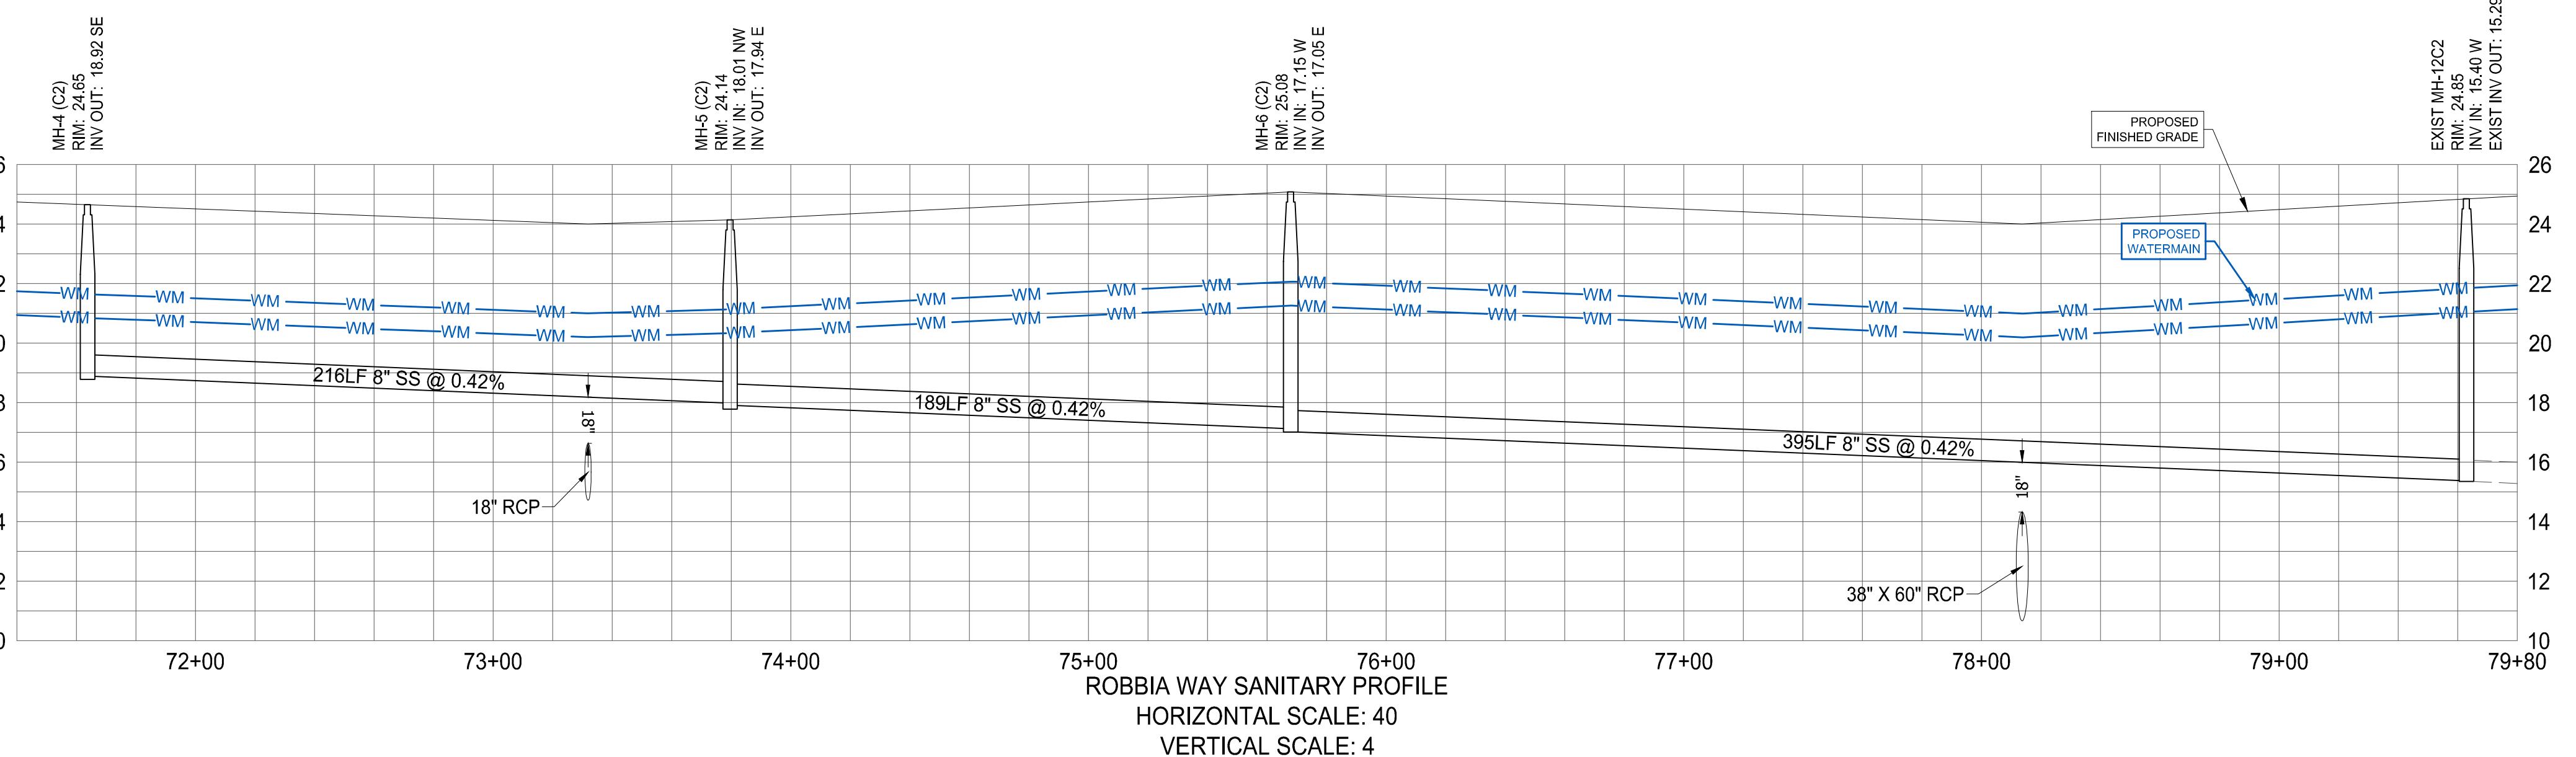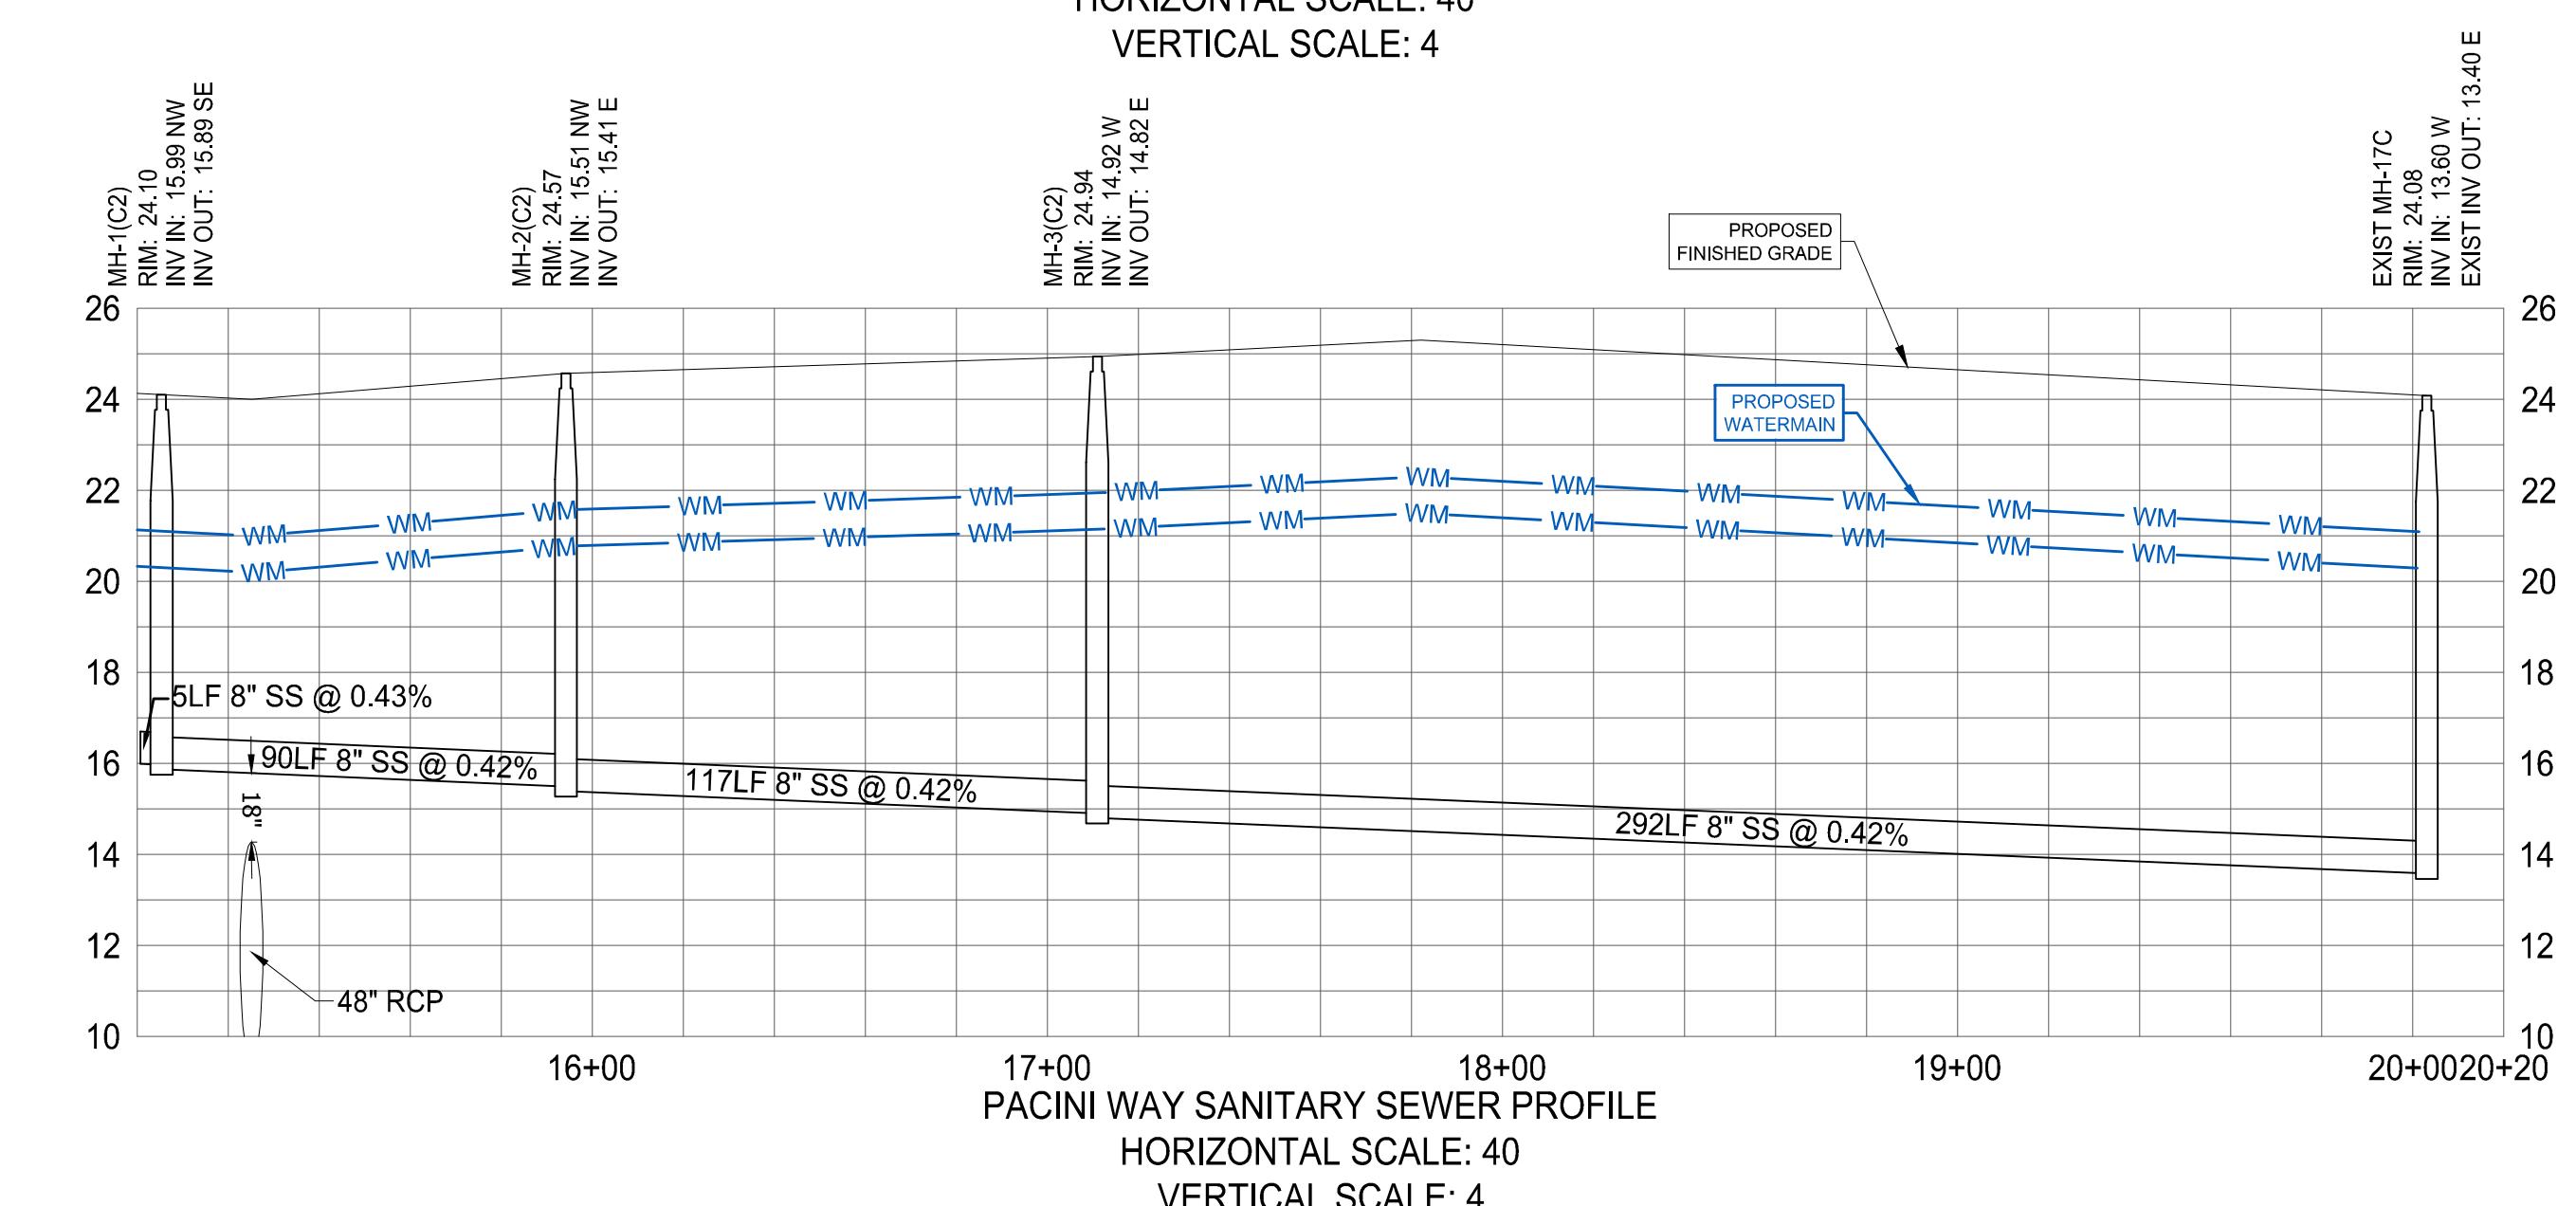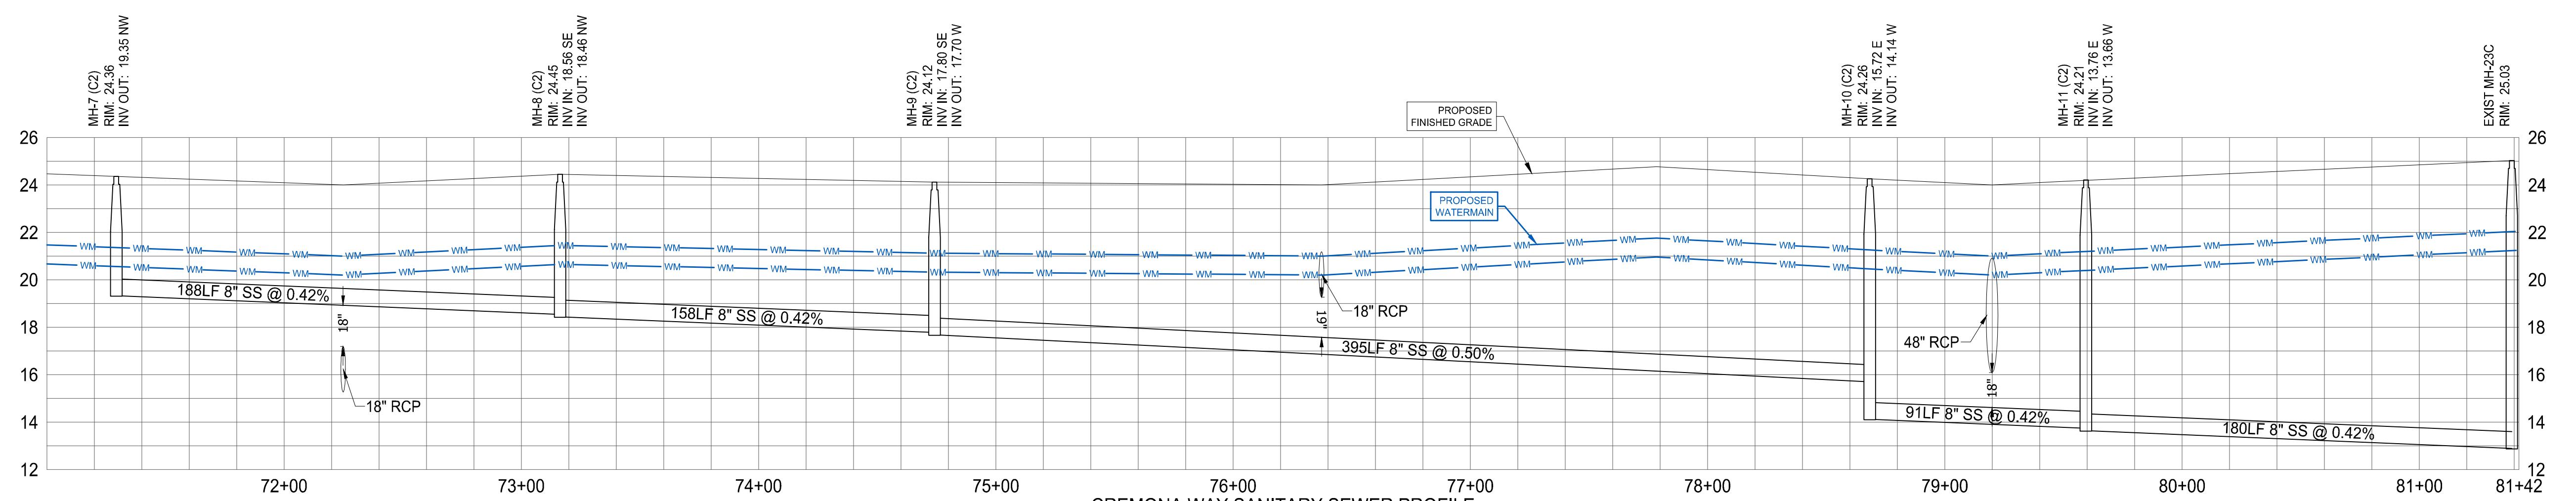

THOMAS  
ENGINEERING GROUP

CIVIL ENGINEERS - PROJECT MANAGERS - LAND PLANNING - LANDSCAPE ARCHITECTS

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PROJECT No.:	FJ160006
DRAWN BY:	MJL
CHECKED BY:	BMU
DATE:	9-1-18
CAD I.D.:	FJ160006-UTILITY-PROFILES

POD C, PLAT 2

---

FOR

VERANO DEVELOPMENT

## PORT SAIN TLUCIE FLORIDA

The logo for Thomas Engineering Group. It features the word "THOMAS" in large, bold, orange letters. To the left of "THOMAS" is a stylized "T" composed of two vertical bars: an orange one on the left and a grey one on the right. Below "THOMAS" is the word "ENGINEERING" in a smaller, grey, sans-serif font, followed by "GROUP" in a slightly larger, grey, sans-serif font.

BRANDON M. ULMER  
FLORIDA LICENSE NO. 68345  
No. 68345  
PROFESSIONAL ENGINEER  
April 24, 2019  
FLORIDA LICENSE No. 68345  
FLORIDA BUSINESS CERT. OF AUTH. No. 27528




SHEET TITLE: **UTILITY PROFILES**

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SHEET NUMBER: **C-21 (C2)**

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PORT ST. LUCIE PROJECT NO: P19-005



PROJECT No.: FJ16000  
DRAWN BY: MJ  
CHECKED BY: BMU  
DATE: 9-1-18  
SHEET I.D.: FJ160006-UTILITY-PROFILES

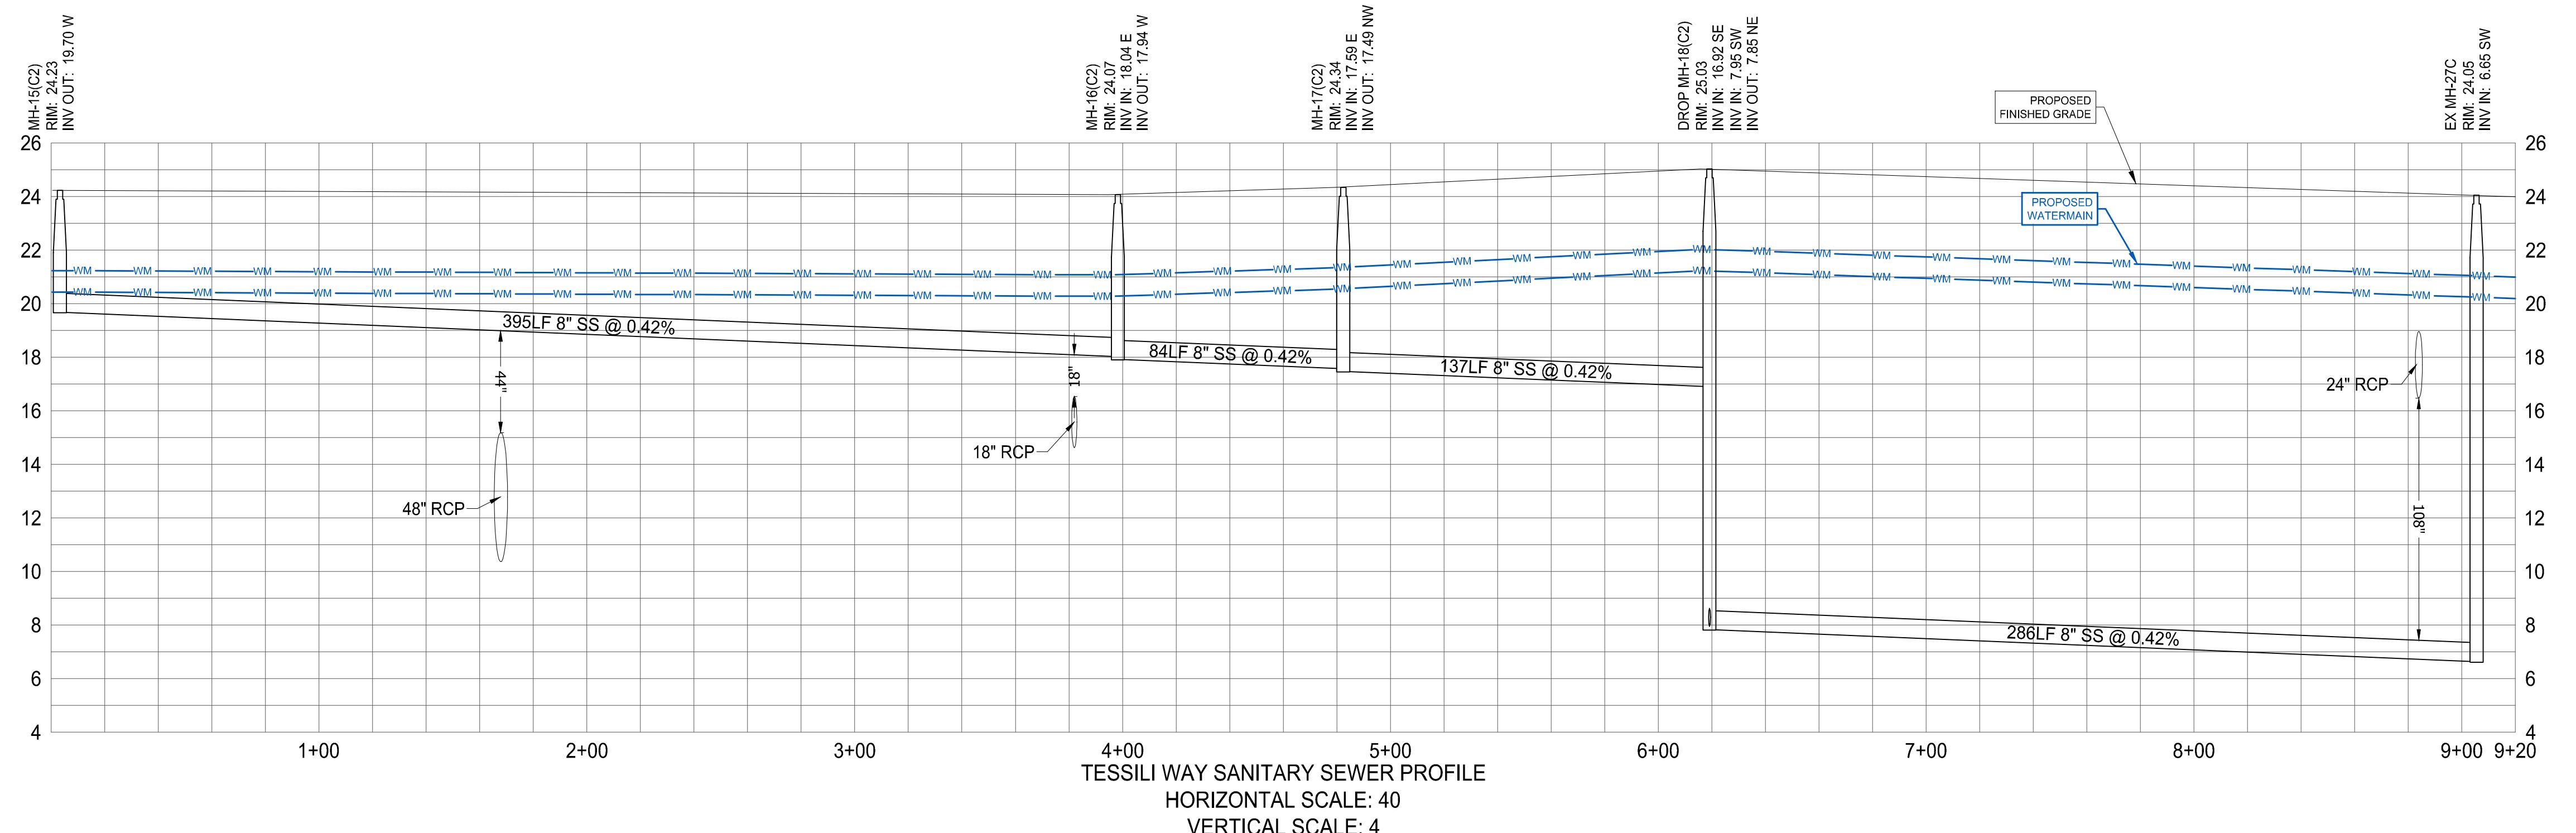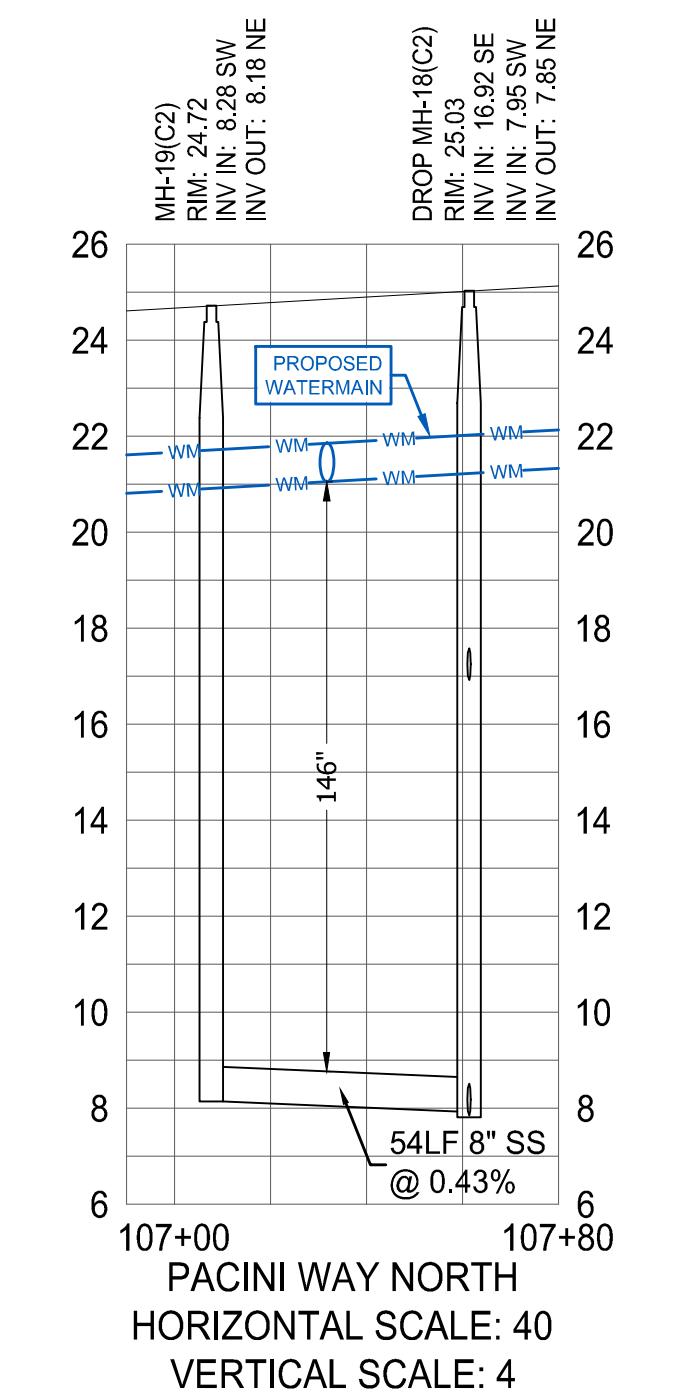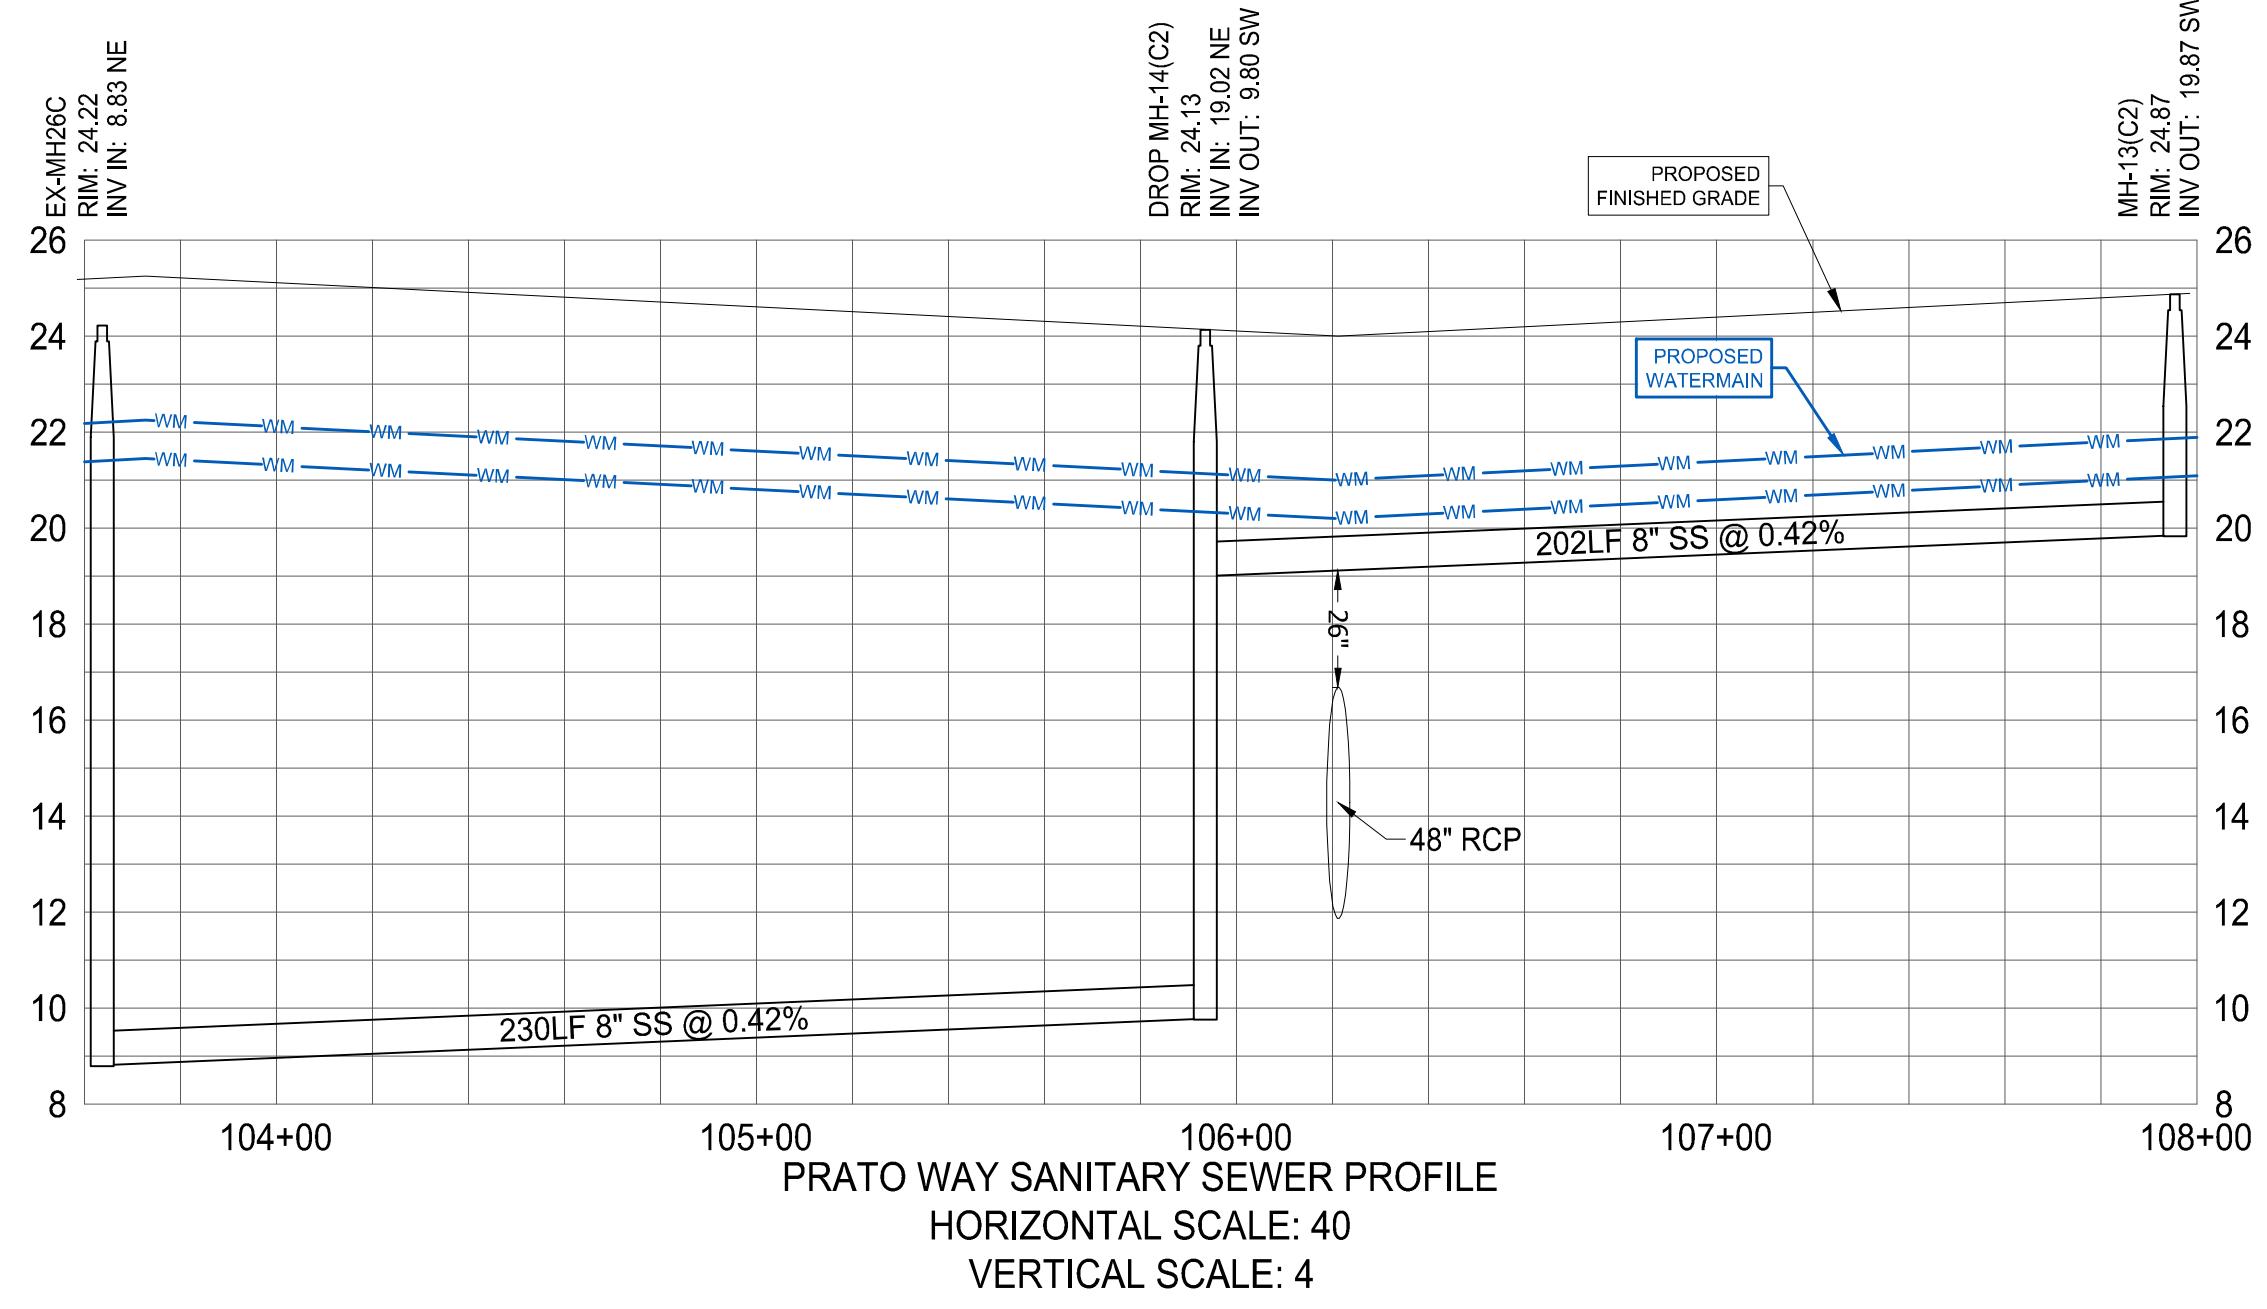PROJECT: **VERANO SOUTH**  
**POD C, PLAT 2**

---

## ERANO DEVELOPMENT

# PORT SAINT LUCIE FLORIDA

A circular seal for Brandon M. Ulmer, Professional Engineer. The outer ring contains the text "BRANDON M. ULMER" at the top and "PROFESSIONAL ENGINEER" at the bottom. The inner circle contains "No. 68345" in the center, surrounded by a decorative border. The seal is signed "P. E." at the bottom left and "APRIL 24, 2019" at the bottom right.

FLORIDA LICENSE NO. 68345  
 FLORIDA BUSINESS CERT. OF AUTH. No. 27528

---

HEET TITLE: **UTILITY PROFILES**

---

HEET NUMBER: **C-22 (C2)**

## GENERAL NOTES EROSION CONTROL

### 1. SITE DESCRIPTION

1.1. NATURE OF CONSTRUCTION ACTIVITIES:  
CONSTRUCTION ACTIVITIES CONSIST OF THE CONSTRUCTION OF A RESIDENTIAL SUBDIVISION ON 72.76 ACRES WITHIN THE CITY OF PORT ST LUCIE, ST LUCIE COUNTY, FLORIDA.

1.2. SEQUENCE OF MAJOR SOIL DISTURBING ACTIVITIES:  
THE FOLLOWING SEQUENCES OF MAJOR ACTIVITIES SHALL BE FOLLOWED UNLESS THE CONTRACTOR CAN PROPOSE AN ALTERNATIVE THAT IS EQUAL OR EXCEEDS THE EROSION AND SEDIMENT CONTROL PRACTICES DESCRIBED IN THIS DOCUMENT, AND IS APPROVED BY THE ENGINEER. THE DETAILED SEQUENCE FOR THE ENTIRE PROJECT CAN VERY SIGNIFICANTLY FARM CONTRACTOR TO CONTRACTOR. THE CONTRACTOR IS RESPONSIBLE FOR PROVIDING A DETAILED SEQUENCE OF CONSTRUCTION FOR ALL CONSTRUCTION ACTIVITIES.

1. PLACEMENT OF ALL EROSION CONTROL DEVICES.  
2. CLEARING AND GRADING, EARTHWORK, AND EXCAVATION OF THE DETENTION AREAS.  
3. STORM SEWER CONSTRUCTION. ALL STORM SEWER SHALL BE CONSTRUCTED IN THE UPSTREAM DIRECTION.  
4. WATER & WASTEWATER UTILITY CONSTRUCTION.  
5. EARTHWORK ASSOCIATED WITH ROADWAY, CURB, SUBGRADE, BASE AND PAVEMENT.  
6. FINAL SEED AND MULCH AND LANDSCAPING AND SODDING OF THE UNPAVED PROJECT AREA AS CALLED FOR IN PLANS.

1.3. AREA ESTIMATES:  
TOTAL SITE AREA: 45.593 ACRES  
TOTAL AREA TO BE DISTURBED: 45.593 ACRES

1.4. RUNOFF DATA:  
RUNOFF COEFFICIENTS: BEFORE: XXX  
DURING: XXX  
AFTER: XXX

SOILS DATA: THE SOILS ARE SILTY FINE SAND TO CLEAN SANDS. THE SMALL SAND PARTICLE SIZE WILL MAKE THE POTENTIAL FOR EROSION HIGH.

#### DRAINAGE AREAS FOR EACH OUTFALL:

1.5. SITE MAP:  
THE CONSTRUCTION PLANS WILL SUBSTITUTE AS SITE MAPS. LOCATIONS OF THE REQUIRED INFORMATION ARE DESCRIBED BELOW.

DRAINAGE PATTERNS:  
THE DRAINAGE FLOW DIRECTIONS ARE SHOWN ON THE PAVING AND DRAINAGE PLAN.

APPROXIMATE SLOPES:  
THE SLOPES OF THE SITE CAN BE SEEN ON THE PAVING AND DRAINAGE PLAN CROSS SECTION.

AREAS OF SOIL DISTURBANCE:  
THE AREAS TO BE DISTURBED ARE INDICATED ON THE PLAN. ANY AREAS WHERE PERMANENT FEATURES ARE SHOWN TO BE CONSTRUCTED ABOVE OR BELOW GROUND WILL BE DISTURBED.

AREAS NOT TO BE DISTURBED:  
THOSE AREAS SHOWN OUTSIDE OF THE LIMITS OF THE SILT FENCE WILL NOT BE DISTURBED.

LOCATION OF CONTROLS:  
THE EROSION CONTROL DEVICES AND LOCATIONS ARE SHOWN ON THE SEDIMENT & EROSION CONTROL PLAN.

AREAS TO BE STABILIZED:  
TEMPORARY STABILIZATION PRACTICES ARE ALSO SHOWN ON THE PLANS, IF APPLICABLE. AREAS OF PERMANENT STABILIZATION AREA SHOWN ON THE PAVING AND DRAINAGE PLAN.

SURFACE WATER:  
SURFACE WATER DISCHARGE IS SHOWN ON THE PAVING AND DRAINAGE PLAN.

1.6. RECEIVING WATERS:  
THE SURFACE WATERS OF THE PROJECT DISCHARGE DIRECTLY TO ON-SITE LAKES.

### 2. CONTROLS:

2.1. EROSION AND SEDIMENT CONTROLS:  
THE FOLLOWING DEFINES GENERAL QUANTITIES FOR THE SEQUENCE OF CONSTRUCTION AND THE USE OF STABILIZATION AND STRUCTURAL PRACTICES. THE CONTRACTOR IS ALSO RESPONSIBLE FOR DOCUMENTING THIS PORTION OF THE SWPPP. THE CONSTRUCTION OF THIS PROJECT IS EXPECTED TO LAST 12 MONTHS.  
INSTALL STABILIZED CONSTRUCTION ENTRANCE AT ALL COMMON AREAS WHERE CONSTRUCTION VEHICLES WILL BE ENTERING AND EXISTING THE CONSTRUCTION SITE. THE DRIVEWAYS SHALL BE CONSTRUCTED IN ACCORDANCE WITH THE FLORIDA SEDIMENT AND CONTROL MANUAL, LATEST EDITION. INSTALL SILT FENCES, TYPE III, AROUND ALL DITCH BOTTOM INLETS ON THE PROJECT, AND THE PROJECT PERIMETERS. FILTER CLOTH UNDER THE GRATES OR CATCH BASINS MAY BE USED IN LIEU OF A SILT FENCE.  
INSTALL STAKED TURBIDITY BARRIERS AT THE LOCATIONS AS INDICATED IN THE PAVING AND DRAINAGE PLAN (DISCHARGE POINTS).

#### 2.1.1. STABILIZED PRACTICES:

TEMPORARY SEEDING SHALL BE RYE GRASS OR OTHER APPROPRIATE GROUND COVERS DEPENDING UPON SEASON OF INSTALLATION THAT IS APPLIED AT MANUFACTURES RECOMMENDATIONS TO ANY DISTURBED AREAS THAT ARE INACTIVE FOR MORE THAN 7 DAYS.

#### 2.1.2. STRUCTURAL PRACTICES:

TEMPORARY:  
SILT FENCE IN ACCORDANCE WITH FLORIDA SEDIMENT AND EROSION CONTROL MANUAL, LATEST EDITION AND SPECIFICATIONS. STAKED TURBIDITY BARRIER IN ACCORDANCE WITH THE FLORIDA SEDIMENT AND EROSION CONTROL MANUAL, LATEST EDITION. SOIL TRACKING PREVENTION DEVICE OR A STABILIZED CONSTRUCTION ENTRANCE TO BE CONSTRUCTED IN ACCORDANCE WITH THE FLORIDA SEDIMENT AND EROSION CONTROL MANUAL, LATEST EDITION.  
ALL SEDIMENT CONTROLS SHALL BE IN PLACE PRIOR TO ANY SOIL DISTURBING ACTIVITY UPSTREAM OF THE CONTROL.

2.2. STORMWATER MANAGEMENT:  
STORMWATER WILL BE CONVEYED IN STORM SEWER SYSTEM, CROSS DRAINS, AND SWALES TO STORMWATER RETENTION/DETENTION LAKES.

#### 2.3. OTHER CONTROLS:

2.3.1. WASTE DISPOSAL:  
THE CONTRACTOR IS SOLELY RESPONSIBLE FOR DOCUMENTING THIS PORTION OF THE SWPPP.

2.3.2. OFF-SITE VEHICLE TRACKING:  
THE CONTRACTOR IS RESPONSIBLE FOR DOCUMENTING THIS PORTION OF THE SWPPP.

2.3.3. STATE AND LOCAL REGULATIONS (WASTE, SANITARY, AND SEPTIC):  
THE CONTRACTOR IS SOLELY RESPONSIBLE FOR DOCUMENTING THIS PORTION OF THE SWPPP.

2.4. STATE AND LOCAL PLANS:  
THIS PROJECT QUALIFIES FOR AN 'NO NOTICE PERMIT' FROM THE SOUTH FLORIDA WATER MANAGEMENT DISTRICT (SFWMD).

#### 3. MAINTENANCE

ITEM	Maintenance	Posted Replacement Interval
SILT FENCE	IN ACCORDANCE WITH SPECIFICATION SECTION 104	6 MONTHS
PONDS	REMOVE SEDIMENT WHEN IT BECOMES 6" DEEP.	AS REQUIRED
STRAW BALES	REMOVE SEDIMENT WHEN IT REACHES 1/2" HEIGHT OF BALES.	3 MONTHS

THE CONTRACTOR SHALL MAINTAIN RAIN GAUGES ON-SITE AND RECORD DAILY RAINFALL. THE CONTRACTOR IS ALSO RESPONSIBLE FOR DOCUMENTING THIS PORTION OF THE SWPPP IN THE SECTION 104 EROSION CONTROL PLAN.

4. INSPECTION:  
QUALIFIED PERSONNEL SHALL INSPECT THE FOLLOWING ITEMS AT LEAST ONCE EVERY SEVEN CALENDAR DAYS AND WITHIN 24 HOURS OF THE END OF A STORM THAT IS 0.50 INCHES GREATER, WHERE SITES HAVE BEEN FINALLY STABILIZED, INSPECTIONS SHALL BE CONDUCTED AT LEAST ONCE EVERY MONTH.

POINTS OF DISCHARGE TO MUNICIPAL SEPARATE STORM SYSTEM.  
DISTURBED AREAS OF THE SITE THAT NOT BEEN FINALLY STABILIZED.  
AREAS USED FOR STORAGE OF MATERIALS THAT ARE EXPOSED TO PRECIPITATION.  
STRUCTURAL CONTROLS.  
STORMWATER MANAGEMENT SYSTEM.  
LOCATIONS WHERE VEHICLES ENTER OR EXITS THE SITE.

### 5. NON-STORMWATER DISCHARGES

THE CONTRACTOR IS REQUIRED TO SUBMIT A DEWATERING PLAN TO SFWMD FOR APPROVAL PRIOR TO COMMENCEMENT OF ANY CONSTRUCTION ACTIVITIES THAT REQUIRE DEWATERING. THIS PLAN SHALL INCLUDE ANY STOCKPILE AREAS AND EXCAVATION AREAS.

### 6. RESPONSIBLE ENTITIES

THIS SWPP MUST CLEARLY IDENTIFY, FOR EACH MEASURE IDENTIFIED WITHIN THE SWPPP, THE CONTRACTOR(S) OR SUBCONTRACTOR(S) THAT WILL IMPLEMENT EACH MEASURE. ALL CONTRACTOR(S) AND SUBCONTRACTOR(S) THAT WILL BE RESPONSIBLE FOR THE IMPLEMENTATION AND MAINTENANCE OF THE MEASURES IDENTIFIED IN THE SWPPP MUST SIGN THE FOLLOWING CERTIFICATION:


"I CERTIFY UNDER PENALTY OF LAW THAT I UNDERSTAND, AND SHALL COMPLY WITH TERMS AND SMALL CONSTRUCTION ACTIVITIES AND THIS STORMWATER POLLUTION PREVENTION PLAN PREPARED THERE UNDER."

NAME AND TITLE	COMPANY NAME, ADDRESS, AND PHONE NUMBER	RESPONSIBLE ITEMS	DATE

"I CERTIFY UNDER PENALTY OF THE LAW THAT THIS DOCUMENT AND ALL ATTACHMENTS WERE PREPARED UNDER MY DIRECTION OR SUPERVISION IN ACCORDANCE WITH A SYSTEM DESIGNED TO ASSURE THAT QUALIFIED PERSONNEL PROPERLY GATHERED AND EVALUATED THE INFORMATION SUBMITTED, BASED ON MY INQUIRY OF THE PERSON OR PERSONS WHO MANAGE THE SYSTEM, TO THE BEST OF MY KNOWLEDGE AND BELIEF, TRUE, ACCURATE, AND COMPLETE. I AM AWARE THAT THAT THERE ARE SIGNIFICANT PENALTIES FOR SUBMITTING FALSE INFORMATION, INCLUDING THE POSSIBILITY OF FINE AND IMPRISONMENT FOR KNOWING VIOLATIONS."

NAME (OPERATOR AND/OR RESPONSIBLE AUTHORITY)

DATE

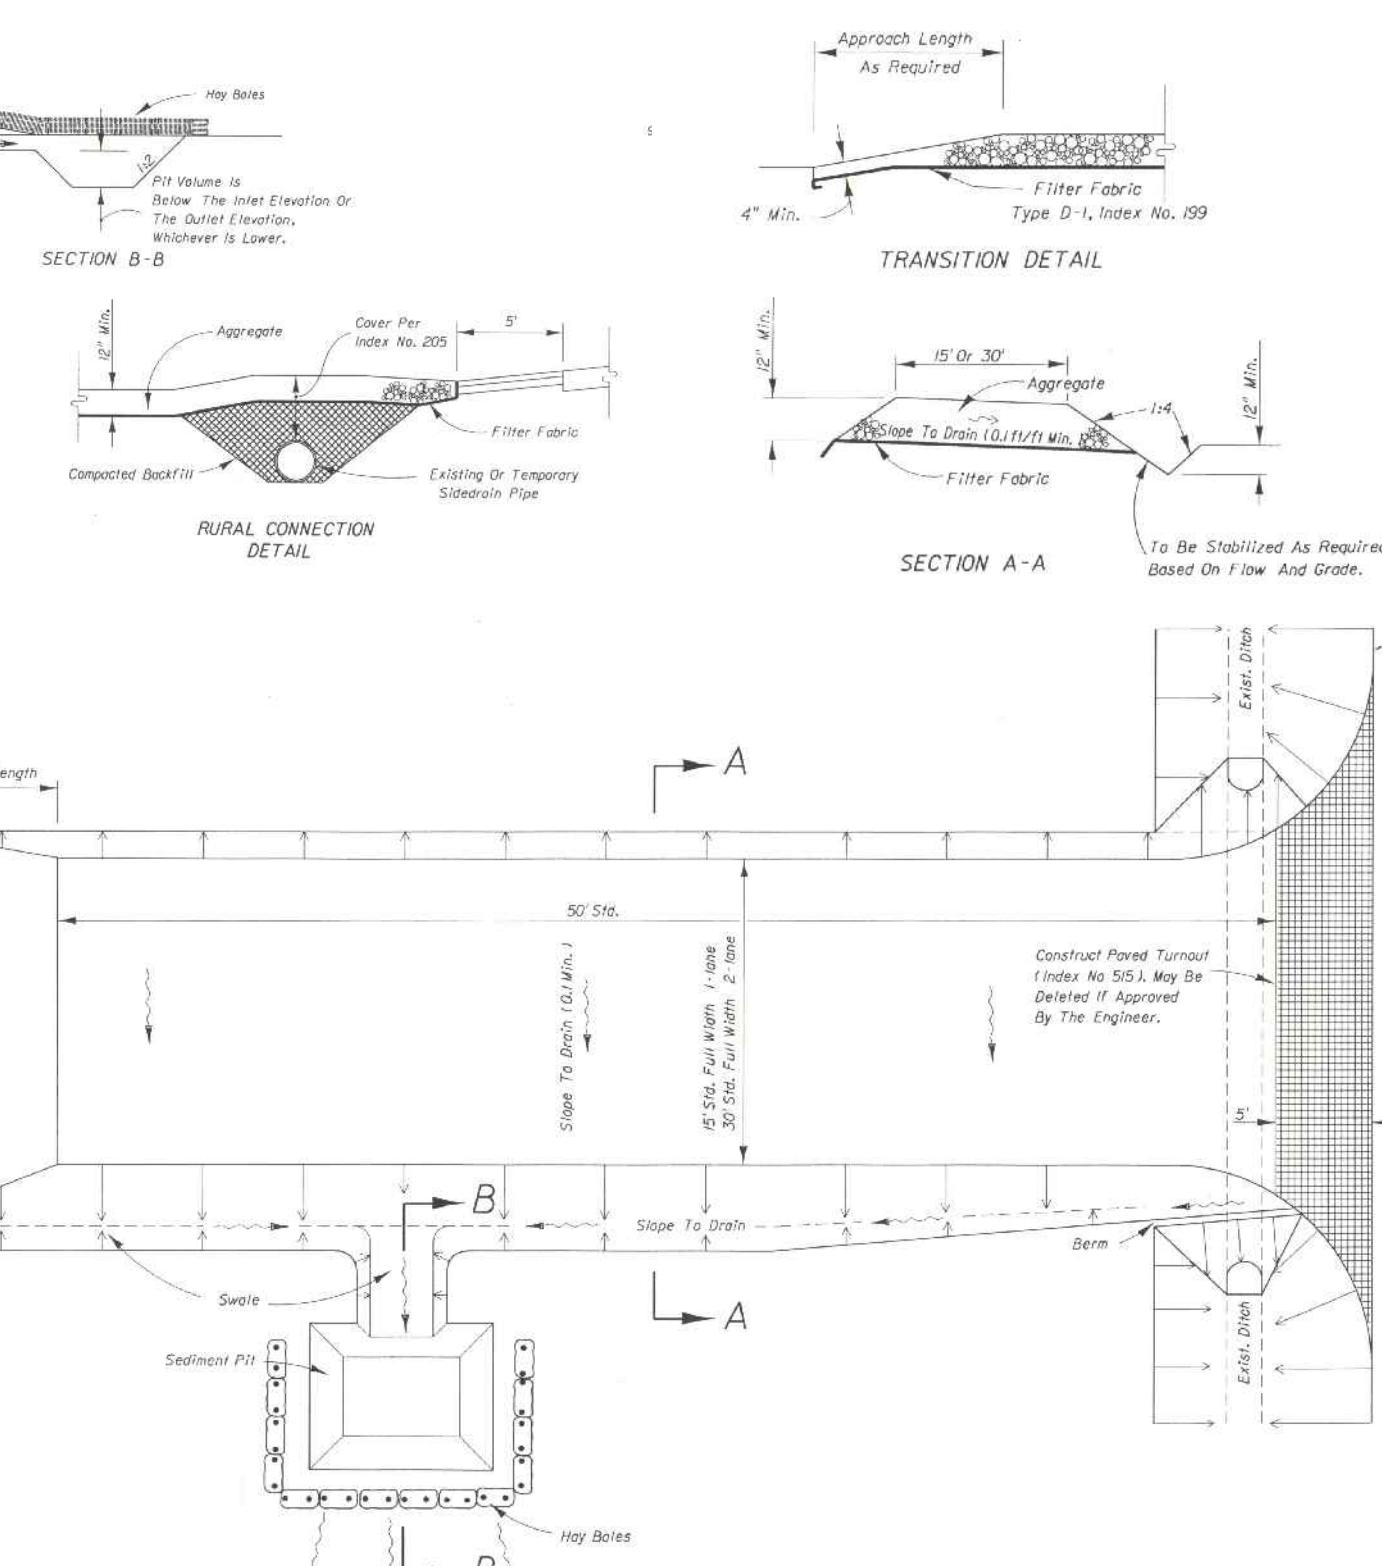


## SOIL TRACKING PREVENTION TYPE A

SCALE: NONE


## BARRIERS FOR FILL SLOPES

SCALE: NONE

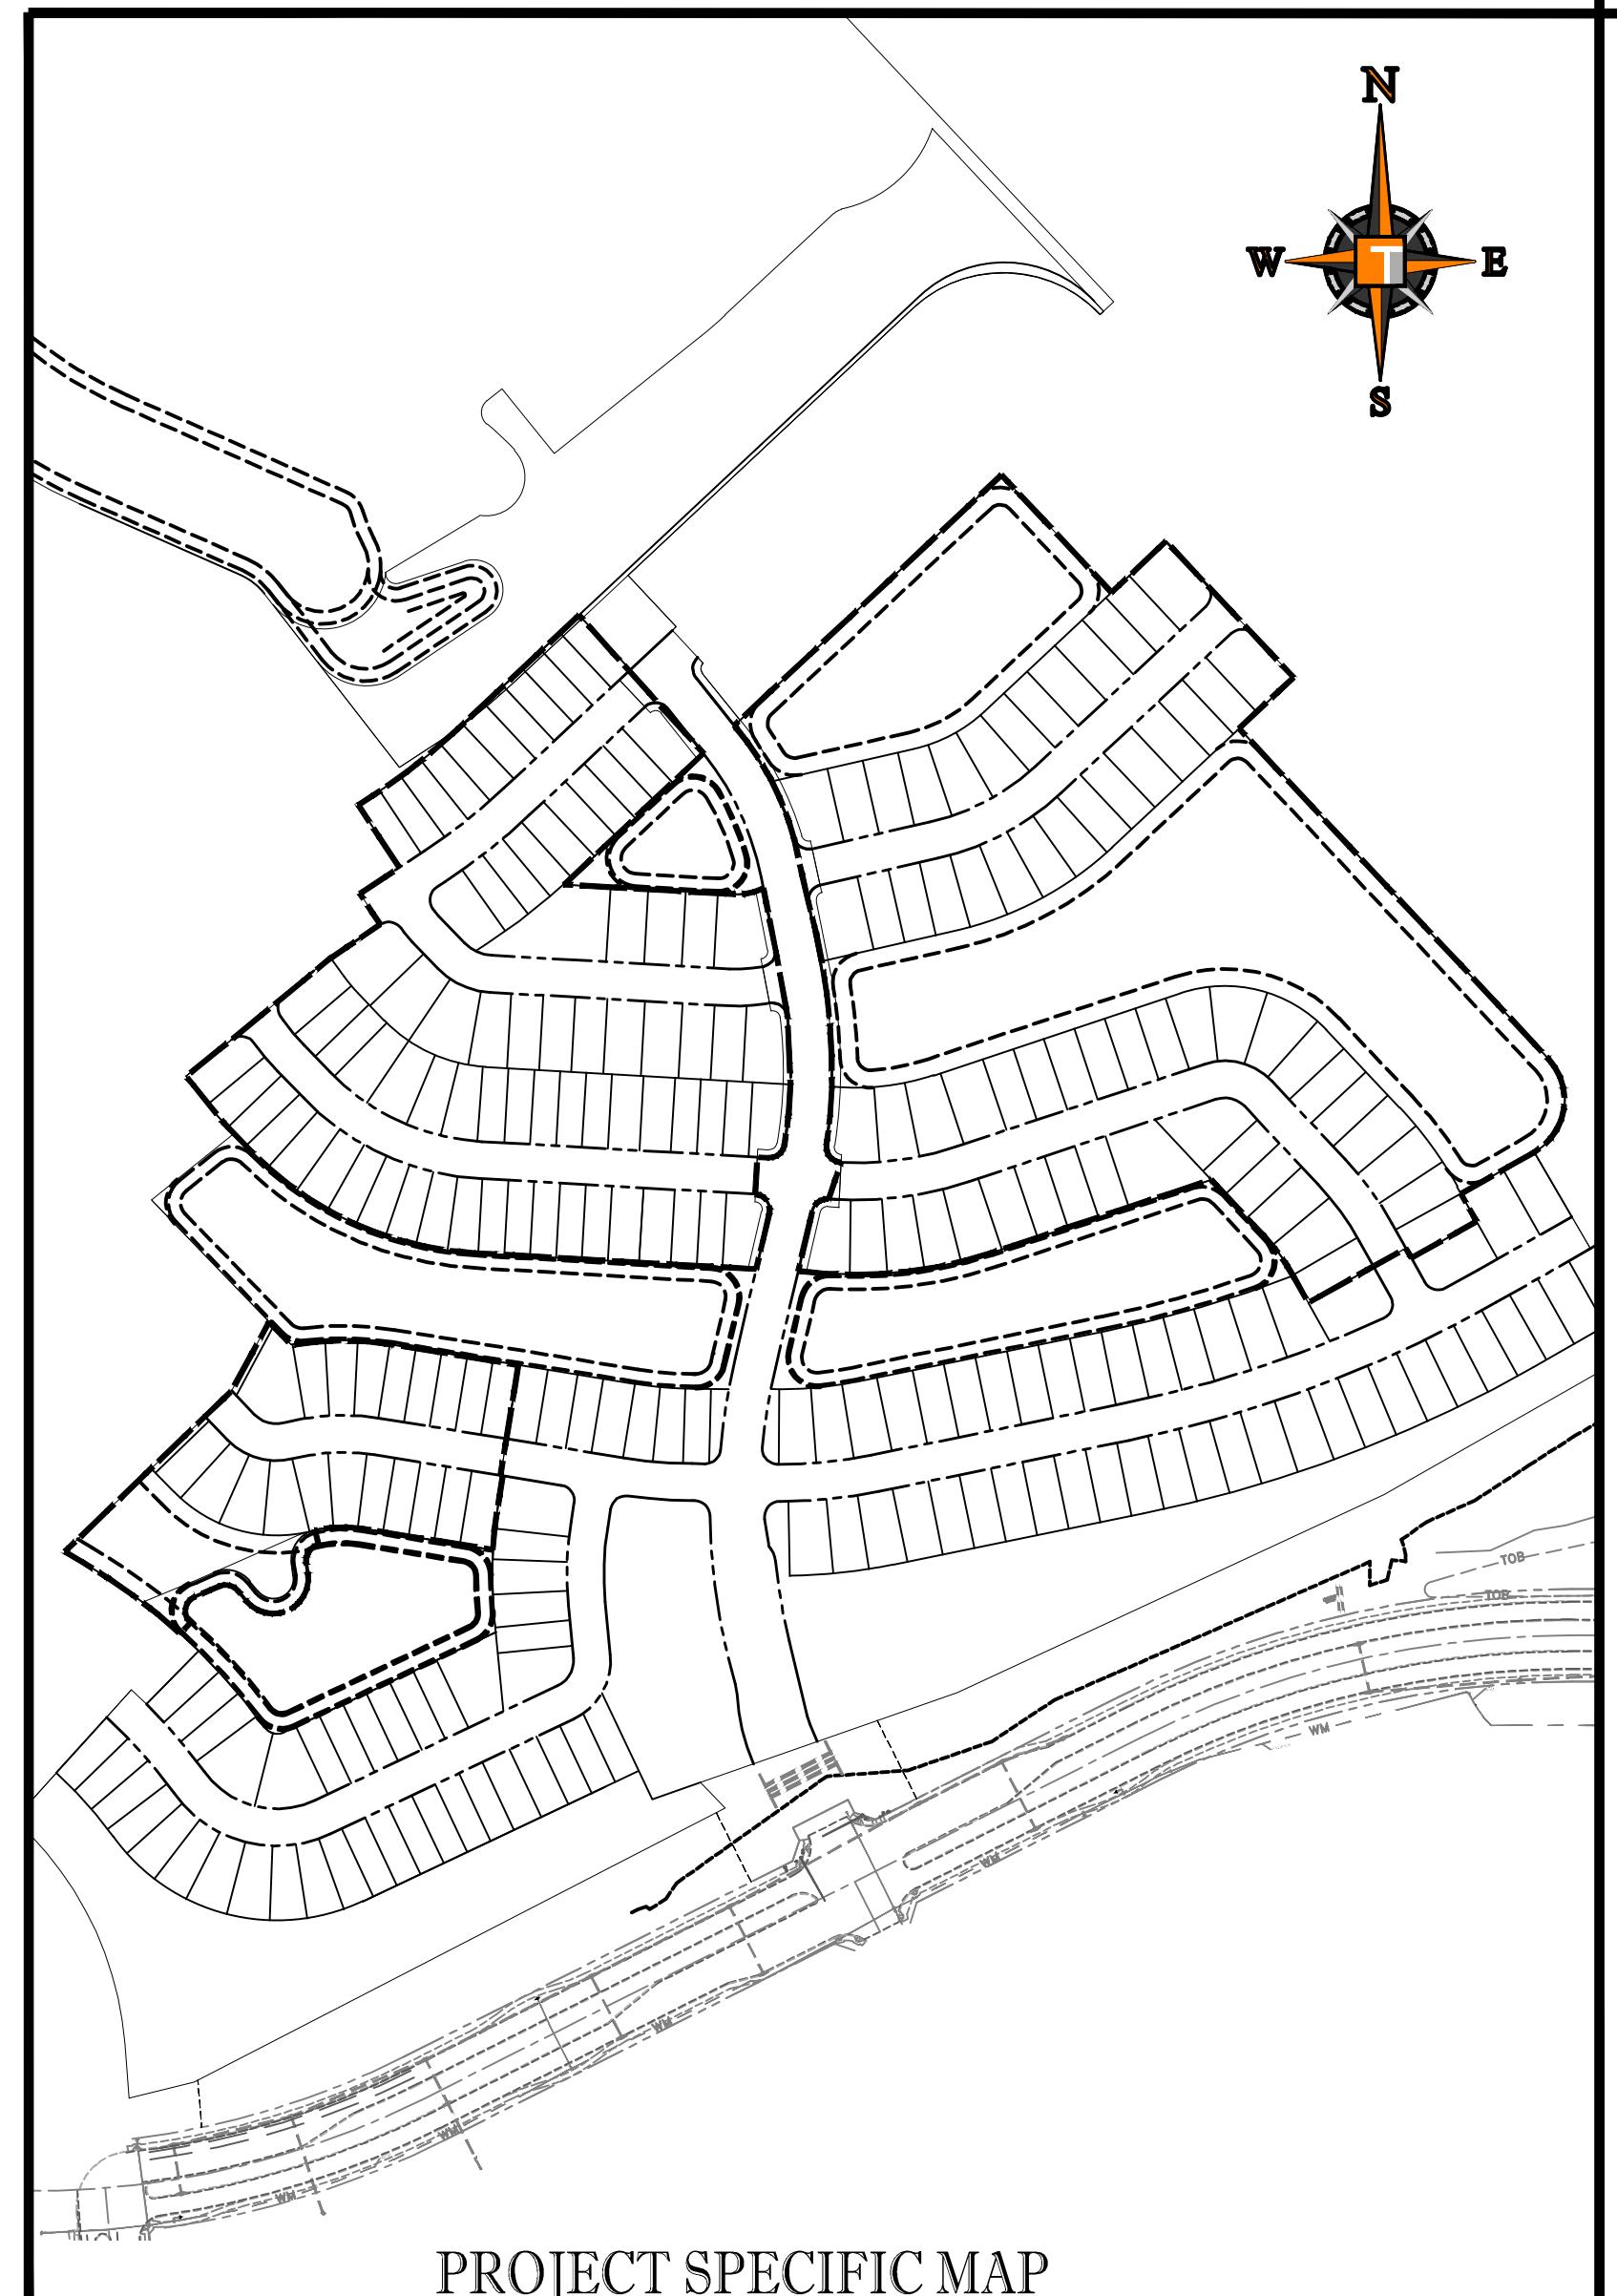


PROJECT SPECIFIC MAP




SCALE: NONE

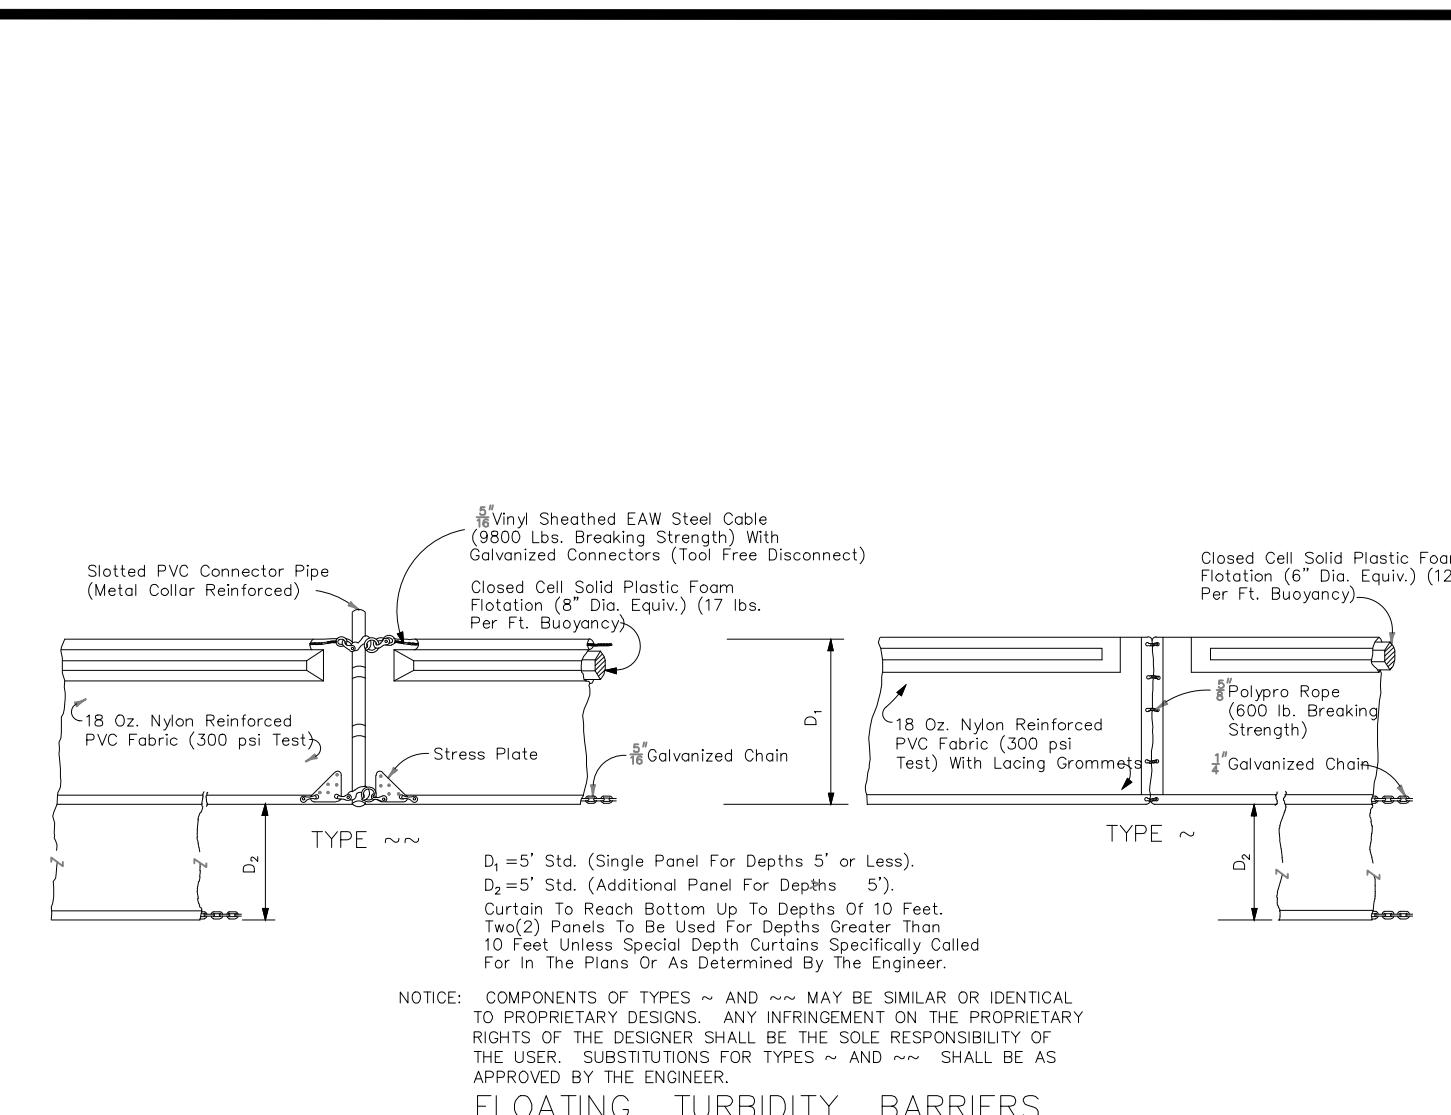

## FLOATING TURBIDITY BARRIERS

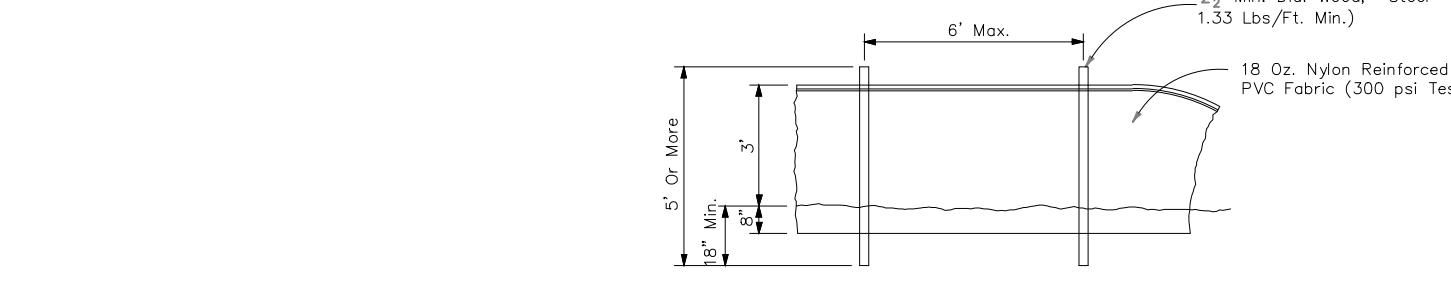

## STAKED TURBIDITY BARRIER

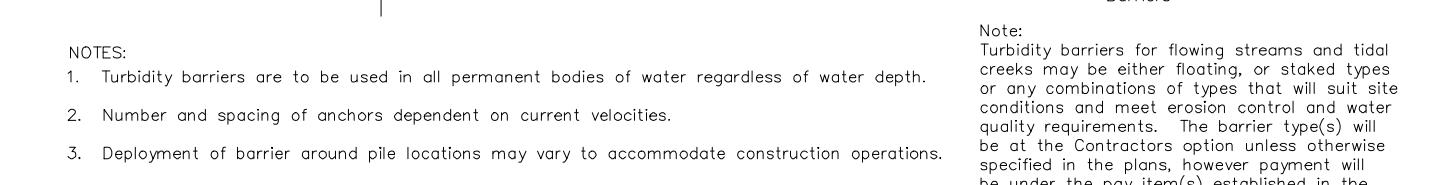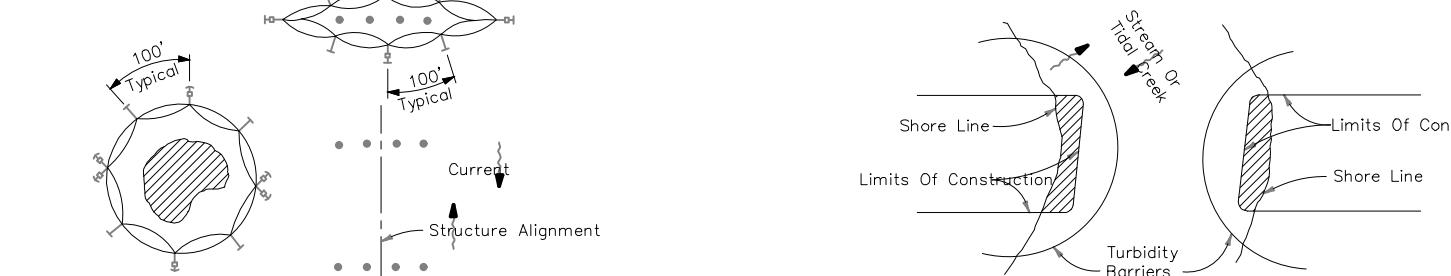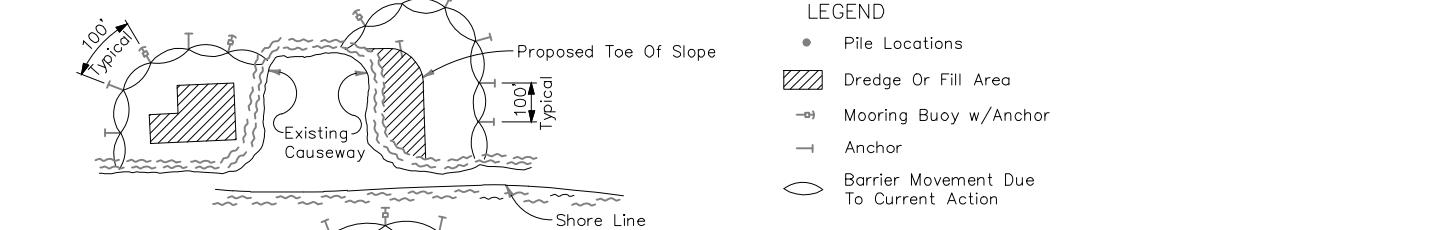


## TURBIDITY BARRIER APPLICATIONS

SCALE: NONE

## TURBIDITY BARRIERS

SCALE: NONE




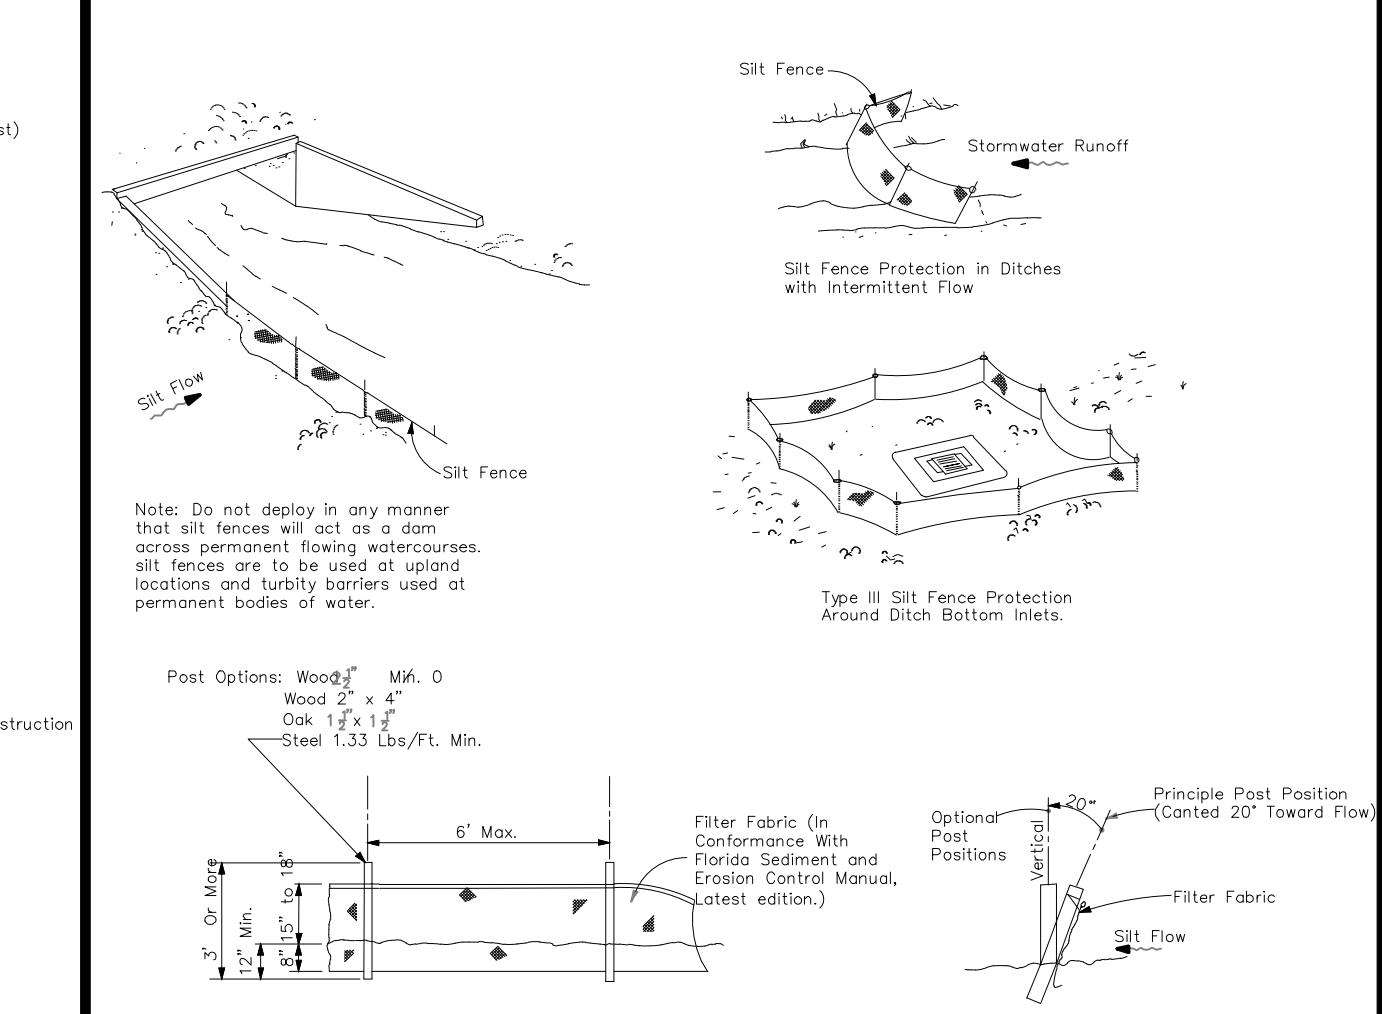


## TYPE III SILT FENCE

SCALE: NONE

## EROSION & SEDIMENT CONTROL DETAILS

SCALE: NONE

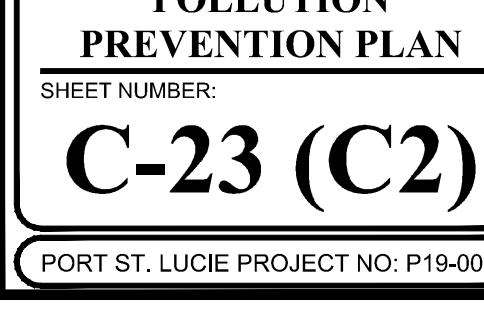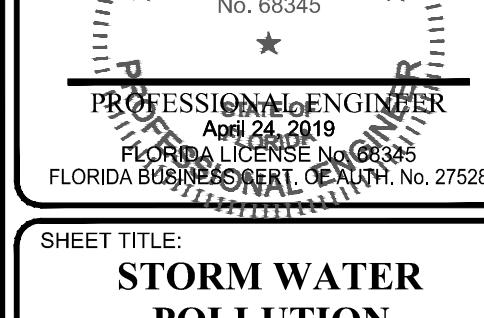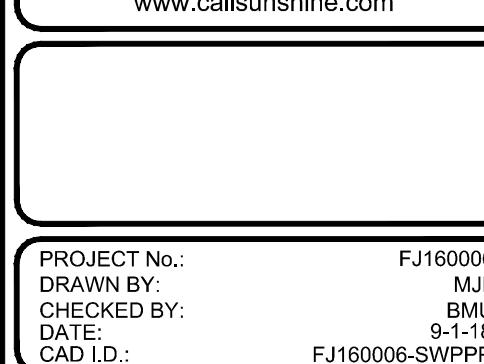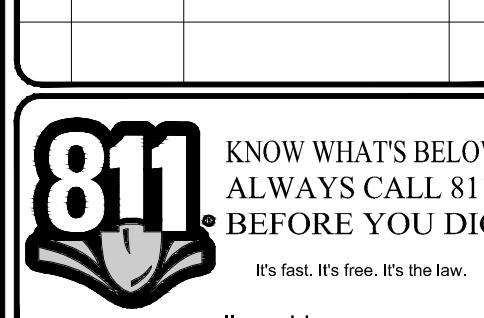

Sheet Number: C-23 (C2)

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