WILSON GROVES PARCEL A PLAT 1

City of Port St. Lucie

PAVING, GRADING, & DRAINAGE PLANS & DETAILS

REVISION INDEX				
REVISION No.	DATE	SHEET NUMBERS		

CITY OF PORT ST. LUCIE PUBLIC WORKS DEPARTMENT ENGINEERING STANDARDS FOR LAND DEVELOPMENT (MOST CURRENT EDITION). AS AMENDED BY CONTRACT

GOVERNING DESIGN STANDARDS:


FLORIDA DEPARTMENT OF TRANSPORTATION, FY2023-24 STANDARDS FOR ROAD AND BRIDGE CONSTRUCTION AND APPLICABLE INTERIM REVISIONS (IRs). STANDARD PLANS FOR ROAD CONSTRUCTION AND ASSOCIATED IRS ARE AVAILABLE AT THE FOLLOWING WEBSITE: HTTP://WWW.FDOT.GOV/DESIGN/STANDARDPLANS

GOVERNING STANDARD SPECIFICATIONS:

FLORIDA DEPARTMENT OF TRANSPORTATION, FY2023-24 STANDARDS FOR ROAD AND BRIDGE CONSTRUCTION AT THE FOLLOWING WEBSITE:

HTTP://WWW.DOT.STATE.FL.US/PROGRAMMANAGEMENT/IMPLEMENTED/SPECBOOKS

LOCATION MAP

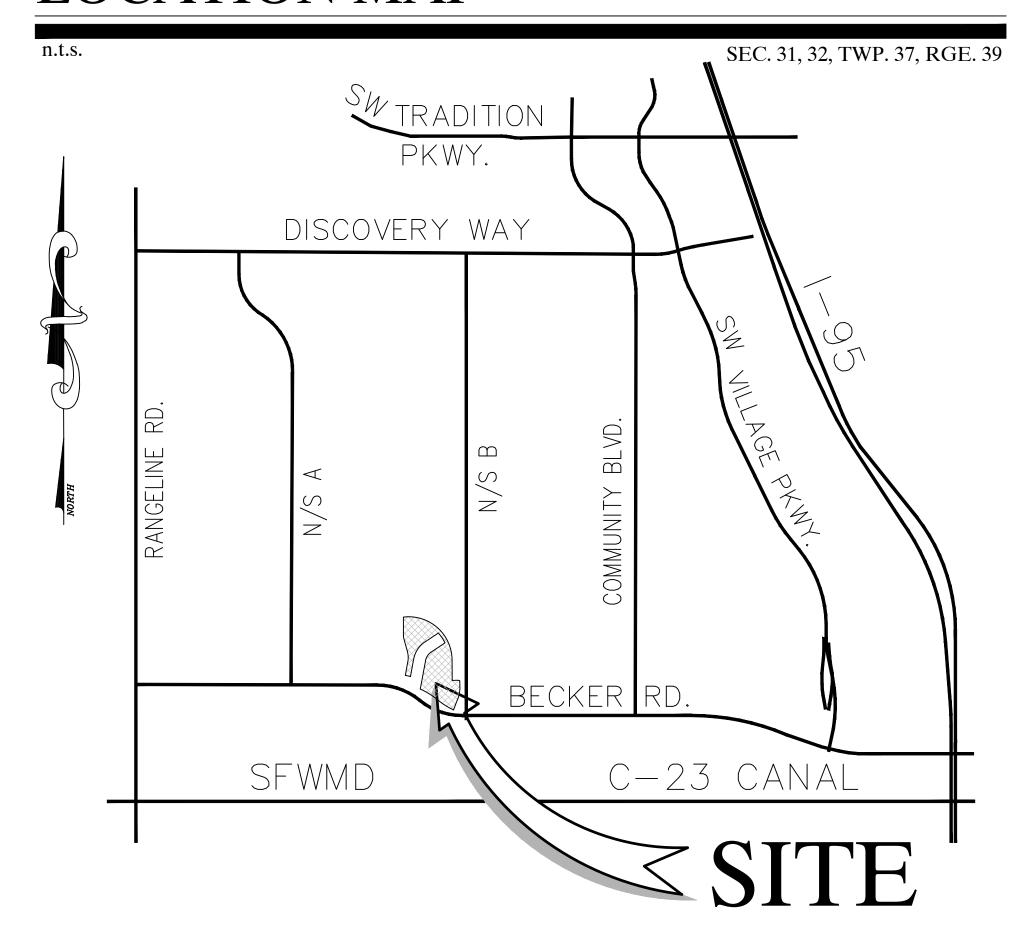

DEVELOPER:

ACR ACQUISTION, LLC 7111 FAIRWAY DRIVE, SUITE 210 PALM BEACH GARDENS, FL 33418

Description	Found (Yes/No)	Agency Contact Information	Management Plan (Yes/No)	Relocation Plan (Yes/No)
Wetlands	No	SFWMD/FDEP	No	No
Rare Habitat	Yes-Wood Stork Foraging	SFWMD/FWC	Yes - Littoral Plan	No
Threatened Species	No	SFWMD/FWC	NA	NA
Endangered Species	No	SFWMD/FWC	NA	NA
Species of Special Concern	No	SFWMD/FWC	NA	NA
Invasive/Exotic Vegetation	Yes	City/County	NA	NA

INDEX

PD-01	Cover Page
PD-02	Overall Stormwater Management Plan
PD-03 - PD-09	Paving, Grading, & Drainage Plans
PD-09A	Entry Grading Plan
PD-10	Typical Sections
PD-11 - PD-14	Paving, Grading, & Drainage Details
PD-15	Pollution Prevention Plan

LEGAL DESCRIPTION:

A PORTION OF A PORTION OF BLOCK 6 TRACT 3, BLOCK 3, BLOCK 8 AND BLOCK 9 OF THE PLAT OF THE ALAN WILSON GROVE, AS RECORDED IN PLAT BOOK 12, PAGES 50 AND 50A, OF THE PUBLIC RECORDS OF THE PUBLIC RECORDS OF ST. LUCIE COUNTY, FLORIDA. LYING IN SECTIONS 29 AND 32, TOWNSHIP 37 SOUTH, RANGE 39 EAST, CITY OF PORT ST. LUCIE, ST. LUCIE COUNTY, FLORIDA. BEING MORE PARTICULARLY DESCRIBED AS FOLLOWS:

COMMENCING AT THE NORTHWEST CORNER OF BLOCK 6, TRACT 1, AS SHOWN ON SAID PLAT; THENCE NORTH 87°55'45" EAST ALONG THE NORTH LINE OF BLOCK 6, TRACT 1, AS SHOWN ON SAID PLAT, A DISTANCE OF 2,921.00 FEET; THENCE NORTH 00°04'45" EAST, A DISTANCE OF 302.05 FEET TO THE POINT OF BEGINNING; THENCE NORTH 86°35'39" EAST, A DISTANCE OF 71.84 FEET TO A POINT OF CURVATURE OF A CURVE TO THE RIGHT HAVING A RADIUS OF 1,270.00 FEET AND A CENTRAL ANGLE OF 92°56'08"; THENCE SOUTHEASTERLY ALONG THE ARC A DISTANCE OF 2,059.98 FEET TO A POINT OF TANGENCY, THENCE SOUTH 00°28'13" EAST, A DISTANCE OF 583.12 FEET; THENCE NORTH 89°31'53" EAST, A DISTANCE OF 118.36 FEET TO A POINT OF CURVATURE OF A CURVE TO THE RIGHT HAVING A RADIUS OF 179.00 FEET AND A CENTRAL ANGLE OF 19°32'24"; THENCE SOUTHEASTERLY ALONG THE ARC A DISTANCE OF 61.05 FEET TO A POINT OF TANGENCY, THENCE SOUTH 70°55'43" EAST, A DISTANCE OF 8.25 FEET; THENCE SOUTH 00°28'12" EAST, A DISTANCE OF 194.59 FEET TO A POINT OF CURVATURE OF A CURVE TO THE RIGHT HAVING A RADIUS OF 875.00 FEET AND A CENTRAL ANGLE OF 21°49'36"; THENCE SOUTHERLY ALONG THE ARC A DISTANCE OF 333.33 FEET TO A POINT OF TANGENCY, THENCE SOUTH 21°21'24" WEST TO THE POINT OF INTERSECTION WITH THE NORTH LINE OF TRACT RW BECKER ROAD, AS SHOWN ON THE PLAT OF BECKER ROAD AT WILSON GROVE, AS RECORDED IN PLAT BOOK 121, PAGE 7, OF THE PUBLIC RECORDS OF ST. LUCIE COUNTY, FLORIDA, A DISTANCE OF 336.92 FEET BEING A POINT ON A CURVE OF A NON-TANGENT CURVE TO THE RIGHT, OF WHICH THE RADIUS POINT LIES NORTH 24°50'33" EAST, A RADIAL DISTANCE OF 2,056.00 FEET; THENCE WESTERLY ALONG THE ARC, THROUGH A CENTRAL ANGLE OF 14°46'31", A DISTANCE OF 530.20 FEET TO A POINT OF REVERSE CURVATURE TO THE LEFT HAVING A RADIUS OF 2,206.00 FEET AND A CENTRAL ANGLE OF 15°19'40"; THENCE WESTERLY ALONG THE ARC, A DISTANCE OF 590.15 FEET; THENCE DEPARTING SAID NORTH LINE, NORTH 10°25'11" EAST, A DISTANCE OF 816.28 FEET TO A POINT OF CURVATURE OF A CURVE TO THE RIGHT HAVING A RADIUS OF 402.00 FEET AND A CENTRAL ANGLE OF 45°48'21"; THENCE NORTHEASTERLY ALONG THE ARC A DISTANCE OF 321.38 FEET; THENCE NORTH 56°13'32" EAST, A DISTANCE OF 442.48 FEET TO A POINT ON A CURVE OF A NON-TANGENT CURVE TO THE LEFT, OF WHICH THE RADIUS POINT LIES SOUTH 64°34'14" WEST, A RADIAL DISTANCE OF 1,130.00 FEET; THENCE NORTHWESTERLY ALONG THE ARC, THROUGH A CENTRAL ANGLE OF 17"18'19", A DISTANCE OF 341.30 FEET; THENCE SOUTH 56"13'32" WEST, A DISTANCE OF 440.66 FEET TO A POINT OF CURVATURE OF A CURVE TO THE LEFT HAVING A RADIUS OF 742.00 FEET AND A CENTRAL ANGLE OF 45°48'21"; THENCE SOUTHERLY ALONG THE ARC A DISTANCE OF 593.20 FEET; THENCE SOUTH 10°25'11" WEST, A DISTANCE OF 514.24 FEET BEING A POINT ON A CURVE OF A NON-TANGENT CURVE TO THE LEFT, OF WHICH THE RADIUS POINT LIES SOUTH 14°50'18" WEST, A RADIAL DISTANCE OF 2,451.00 FEET; THENCE WESTERLY ALONG THE ARC, THROUGH A CENTRAL ANGLE OF 03°30'39", A DISTANCE OF 150.19 FEET; THENCE NORTH 10°25'11" EAST, A DISTANCE OF 392.37 FEET TO A POINT OF CURVATURE OF A CURVE TO THE LEFT HAVING A RADIUS OF 655.00 FEET AND A CENTRAL ANGLE OF 25°52'58"; THENCE NORTHERLY ALONG THE ARC A DISTANCE OF 295.89 FEET TO A POINT OF TANGENCY, THENCE NORTH 15°27'46" WEST, A DISTANCE OF 377.57 FEET TO A POINT OF CURVATURE OF A CURVE TO THE RIGHT HAVING A RADIUS OF 345.00 FEET AND A CENTRAL ANGLE OF 15°32'31"; THENCE NORTHERLY ALONG THE ARC A DISTANCE OF 93.58 FEET TO A POINT OF TANGENCY, THENCE NORTH 00°04'45" EAST, A DISTANCE OF 530.58 FEET TO THE POINT OF BEGINNING.

CONTAINING 51.833 ACRES, MORE OR LESS.


SAID LANDS SITUATE IN SECTIONS 29 AND 32, TOWNSHIP 37 SOUTH, RANGE 39 EAST, CITY OF PORT ST. LUCIE, ST. LUCIE

DRAWN BY RH F.B./ PG. ---

SCALE AS SHOW

RYAN D. WHEELER ||PROFESSIONAL ENGINEE LICENSE NO. 7147 STATE OF FLORIDA - FOR THE FIRM -ATEAug 20, 202

PSLUSD PROJECT NO. 11-681-A CITY OF PSL PROJECT NO. P24-008

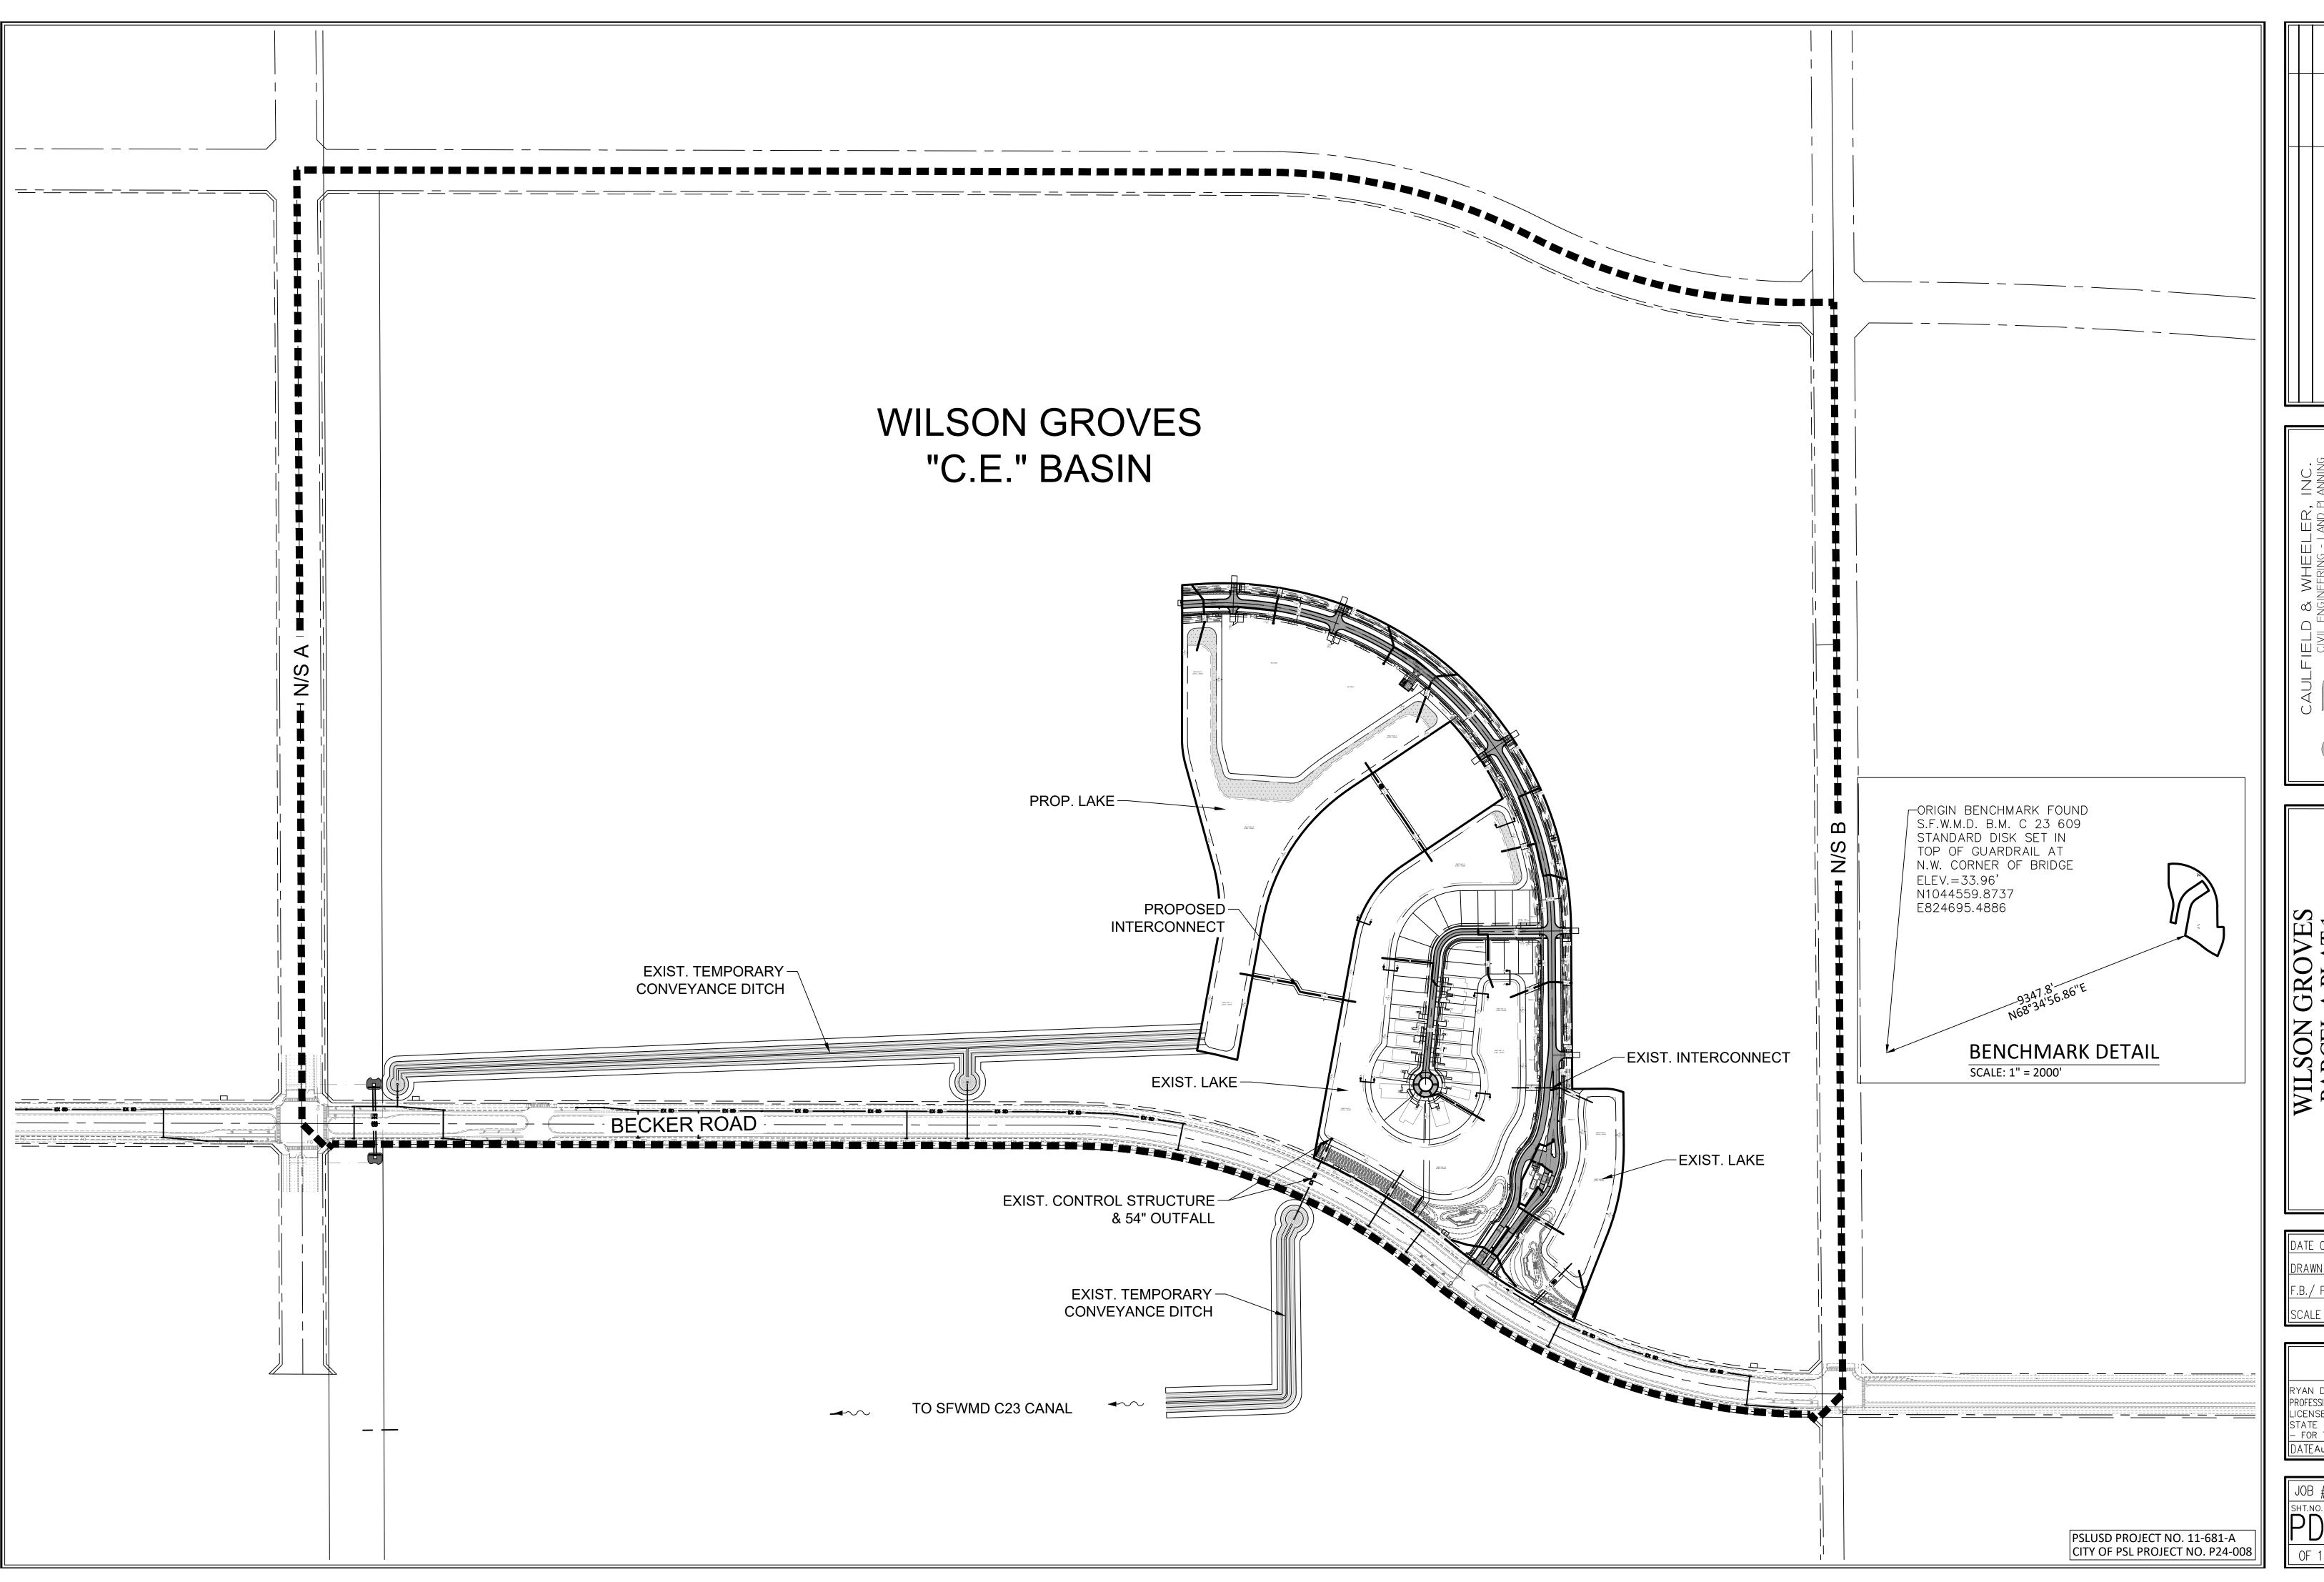

REVISIONS DAT

CAULFIELD & WHEELER, INC.
CIVIL ENGINEERING - LAND PLANNING
LANDSCAPE ARCHITECTURE - SURVEYING
7900 GLADES ROAD - SUITE 100
BOCA RATON, FLORIDA 33434
PHONE (561)-392-1991 / FAX (561)-750-1452

PARCEL A PLAT 1
FORMWATER MANAGEMENT PLAN


DATE 01/17/2024

DRAWN BY RHT

F.B./ PG. ----SCALE 1"=250'

RYAN D. WHEELER
PROFESSIONAL ENGINEER
LICENSE NO. 71477
STATE OF FLORIDA
– FOR THE FIRM –
DATEAug 20, 2024

JOB #4371-A01
SHT.NO.
PD-02
OF 15 SHEETS

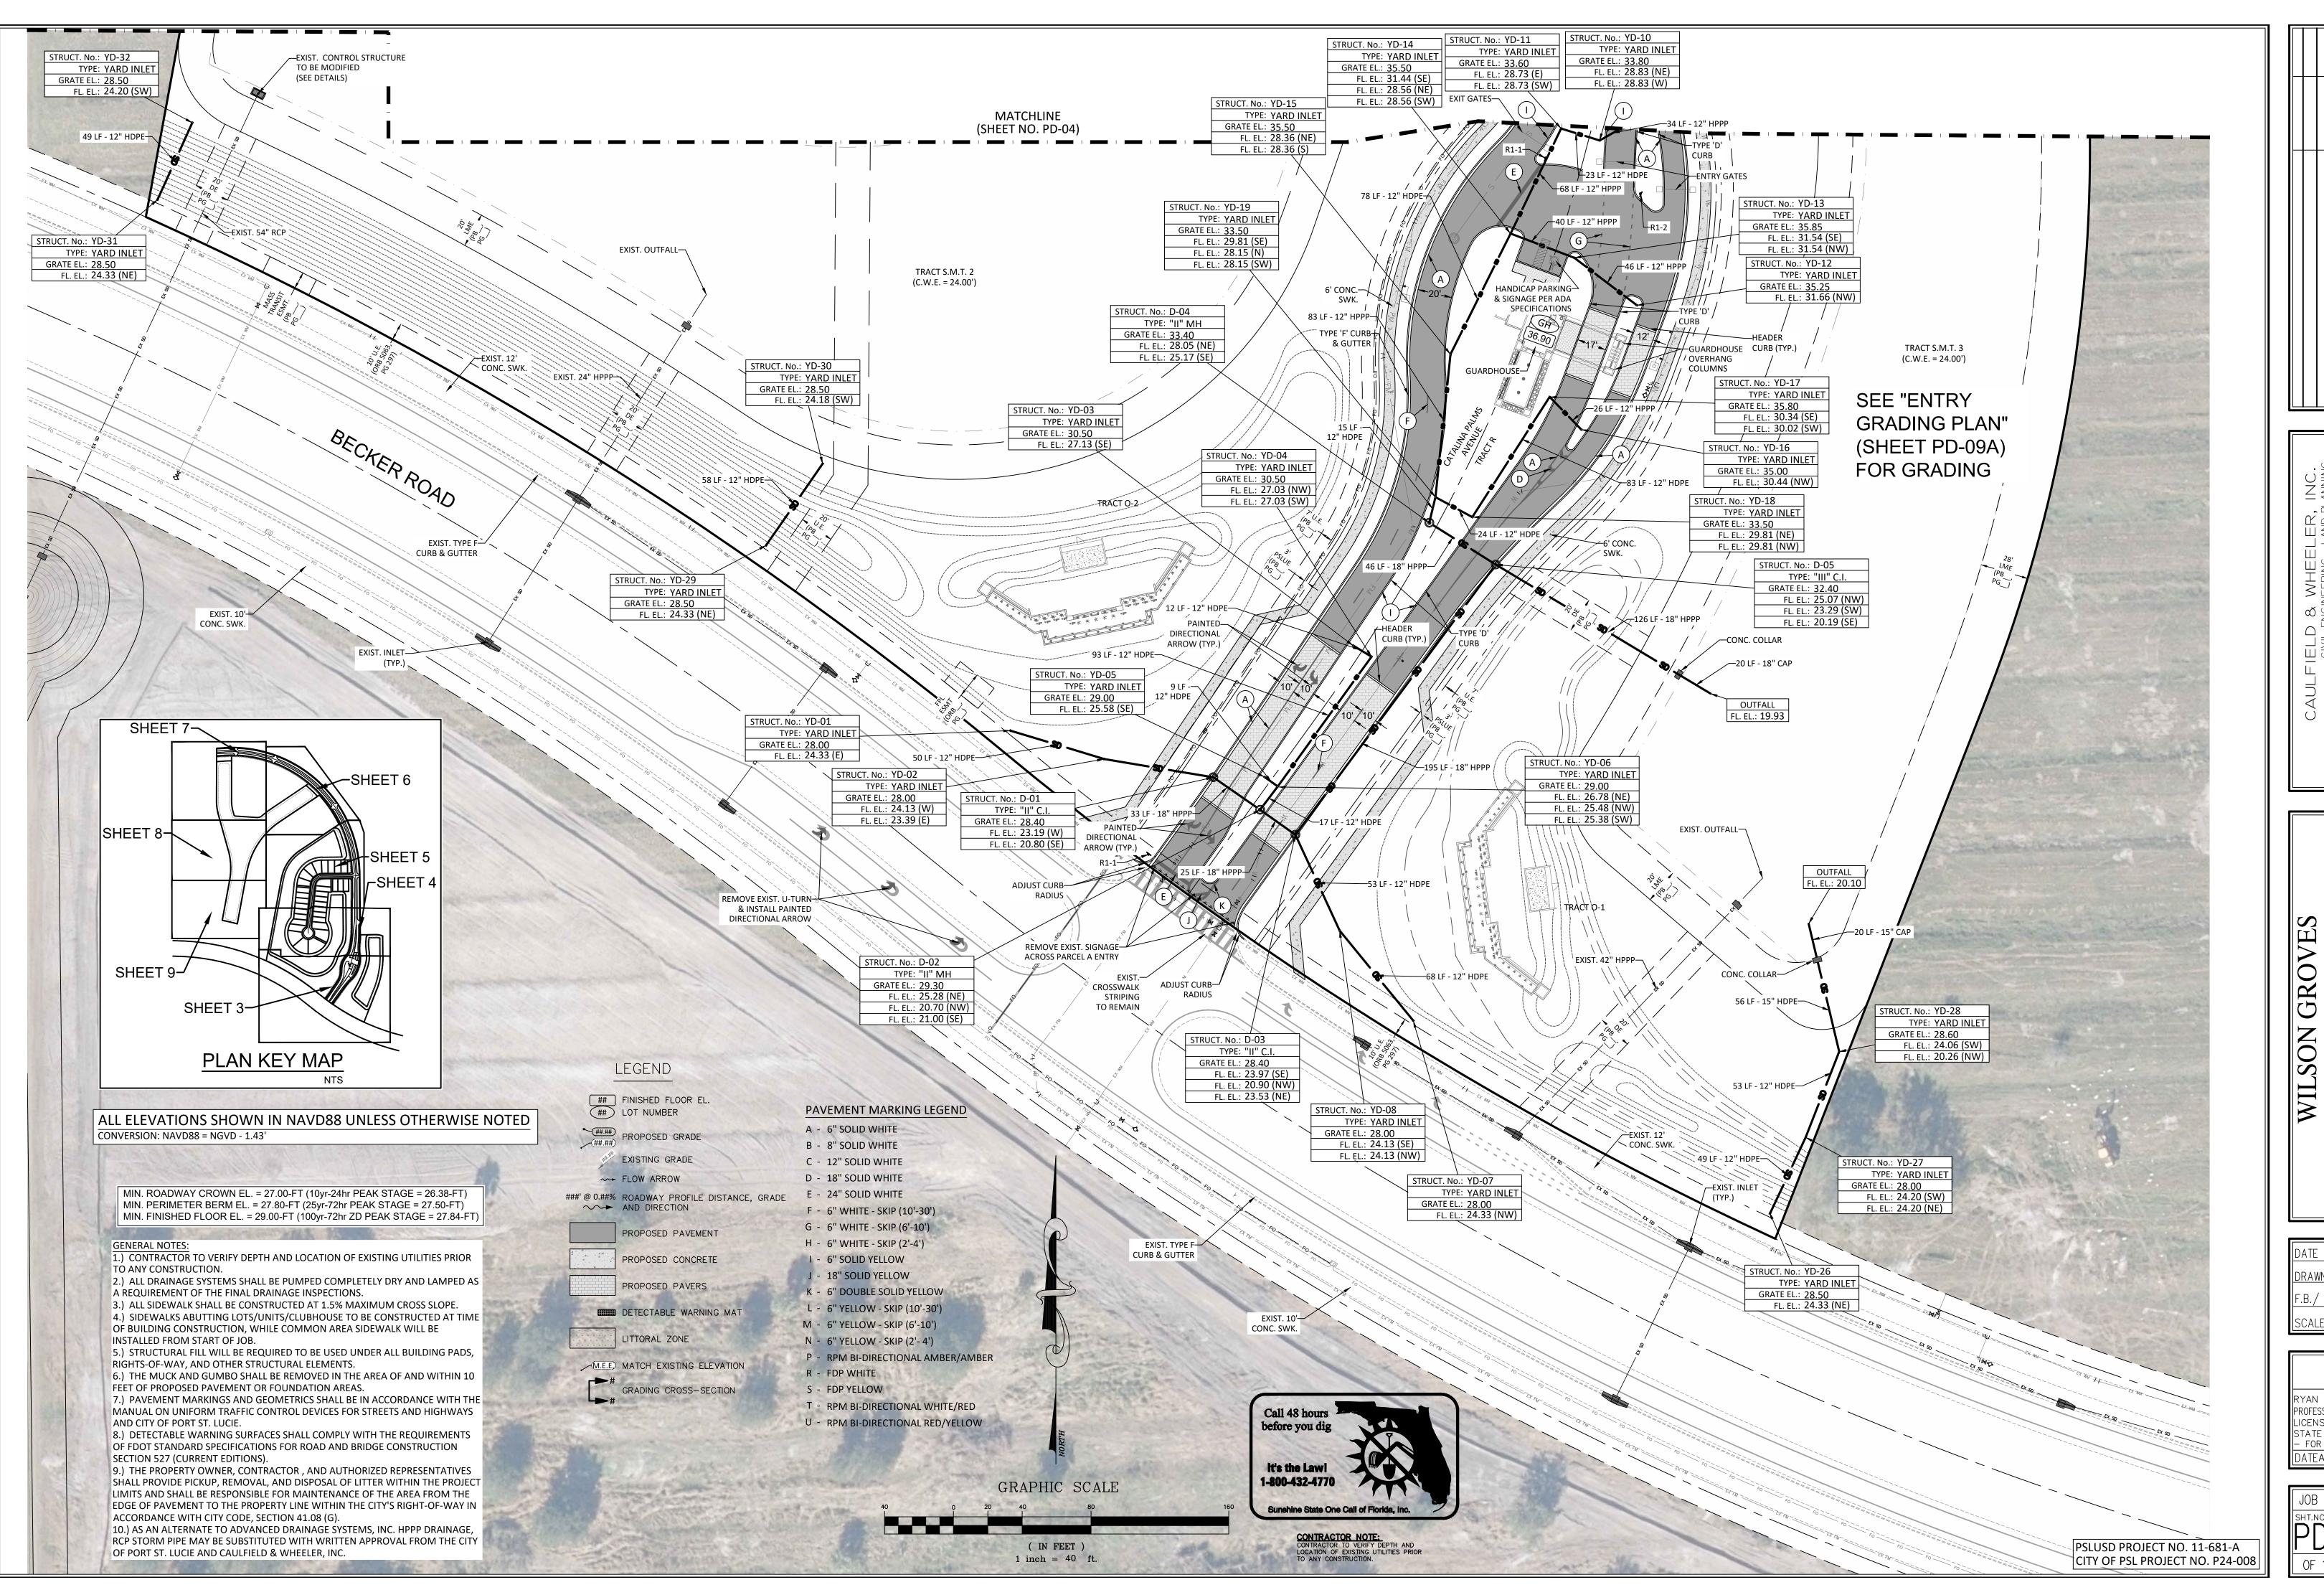

REVISIONS FILE NAME: 4371PD-A-01.dwg

FIELD & WHEELER, INC.
CIVIL ENGINEERING - LAND PLANNING
LANDSCAPE ARCHITECTURE - SURVEYING
7900 GLADES ROAD - SUITE 100
BOCA RATON, FLORIDA 33434
PHONE (561)-392-1991 / FAX (561)-750-145



WILSON GROVES
PARCEL A PLAT 1
PAVING, GRADING, & DRAINAGE PLAI

DATE 01/17/2024

DRAWN BY RHT

F.B./ PG. ----

F.B./ PG. ---SCALE 1"=40"

RYAN D. WHEELER
PROFESSIONAL ENGINEER
LICENSE NO. 71477
STATE OF FLORIDA
– FOR THE FIRM –
DATEAug 20, 2024

JOB #4371-A01 SHT.NO. PD-03

LITTORAL ZONE

M.E.E. MATCH EXISTING ELEVATION

GRADING CROSS-SECTION

GRAPHIC SCALE

(IN FEET)

1 inch = 40 ft.

P - RPM BI-DIRECTIONAL AMBER/AMBER

T - RPM BI-DIRECTIONAL WHITE/RED

U - RPM BI-DIRECTIONAL RED/YELLOW

ALL ELEVATIONS SHOWN IN NAVD88 UNLESS OTHERWISE NOTED

MIN. ROADWAY CROWN EL. = 27.00-FT (10yr-24hr PEAK STAGE = 26.38-FT)

MIN. FINISHED FLOOR EL. = 29.00-FT (100yr-72hr ZD PEAK STAGE = 27.84-FT)

MIN. PERIMETER BERM EL. = 27.80-FT (25yr-72hr PEAK STAGE = 27.50-FT)

CONVERSION: NAVD88 = NGVD - 1.43'

R - FDP WHITE

S - FDP YELLOW

AND CITY OF PORT ST. LUCIE.

SECTION 527 (CURRENT EDITIONS).

ACCORDANCE WITH CITY CODE, SECTION 41.08 (G).

OF PORT ST. LUCIE AND CAULFIELD & WHEELER, INC.

8.) DETECTABLE WARNING SURFACES SHALL COMPLY WITH THE REQUIREMENTS

9.) THE PROPERTY OWNER, CONTRACTOR, AND AUTHORIZED REPRESENTATIVES

SHALL PROVIDE PICKUP, REMOVAL, AND DISPOSAL OF LITTER WITHIN THE PROJECT

LIMITS AND SHALL BE RESPONSIBLE FOR MAINTENANCE OF THE AREA FROM THE

EDGE OF PAVEMENT TO THE PROPERTY LINE WITHIN THE CITY'S RIGHT-OF-WAY IN

10.) AS AN ALTERNATE TO ADVANCED DRAINAGE SYSTEMS, INC. HPPP DRAINAGE, RCP STORM PIPE MAY BE SUBSTITUTED WITH WRITTEN APPROVAL FROM THE CITY

OF FDOT STANDARD SPECIFICATIONS FOR ROAD AND BRIDGE CONSTRUCTION

DATE 01/17/2024

DRAWN BY RH F.B./ PG. ----

RYAN D. WHEELER PROFESSIONAL ENGINEER LICENSE NO. 71477 STATE OF FLORIDA - FOR THE FIRM -DATEAug 20, 202


JOB #4371-A01

CONTRACTOR NOTE:
CONTRACTOR TO VERIFY DEPTH AND
LOCATION OF EXISTING UTILITIES PRIOR
TO ANY CONSTRUCTION. PSLUSD PROJECT NO. 11-681-A CITY OF PSL PROJECT NO. P24-008

it's the Law!

1-800-432-4770

Sunshine State One Call of Florida, Inc.

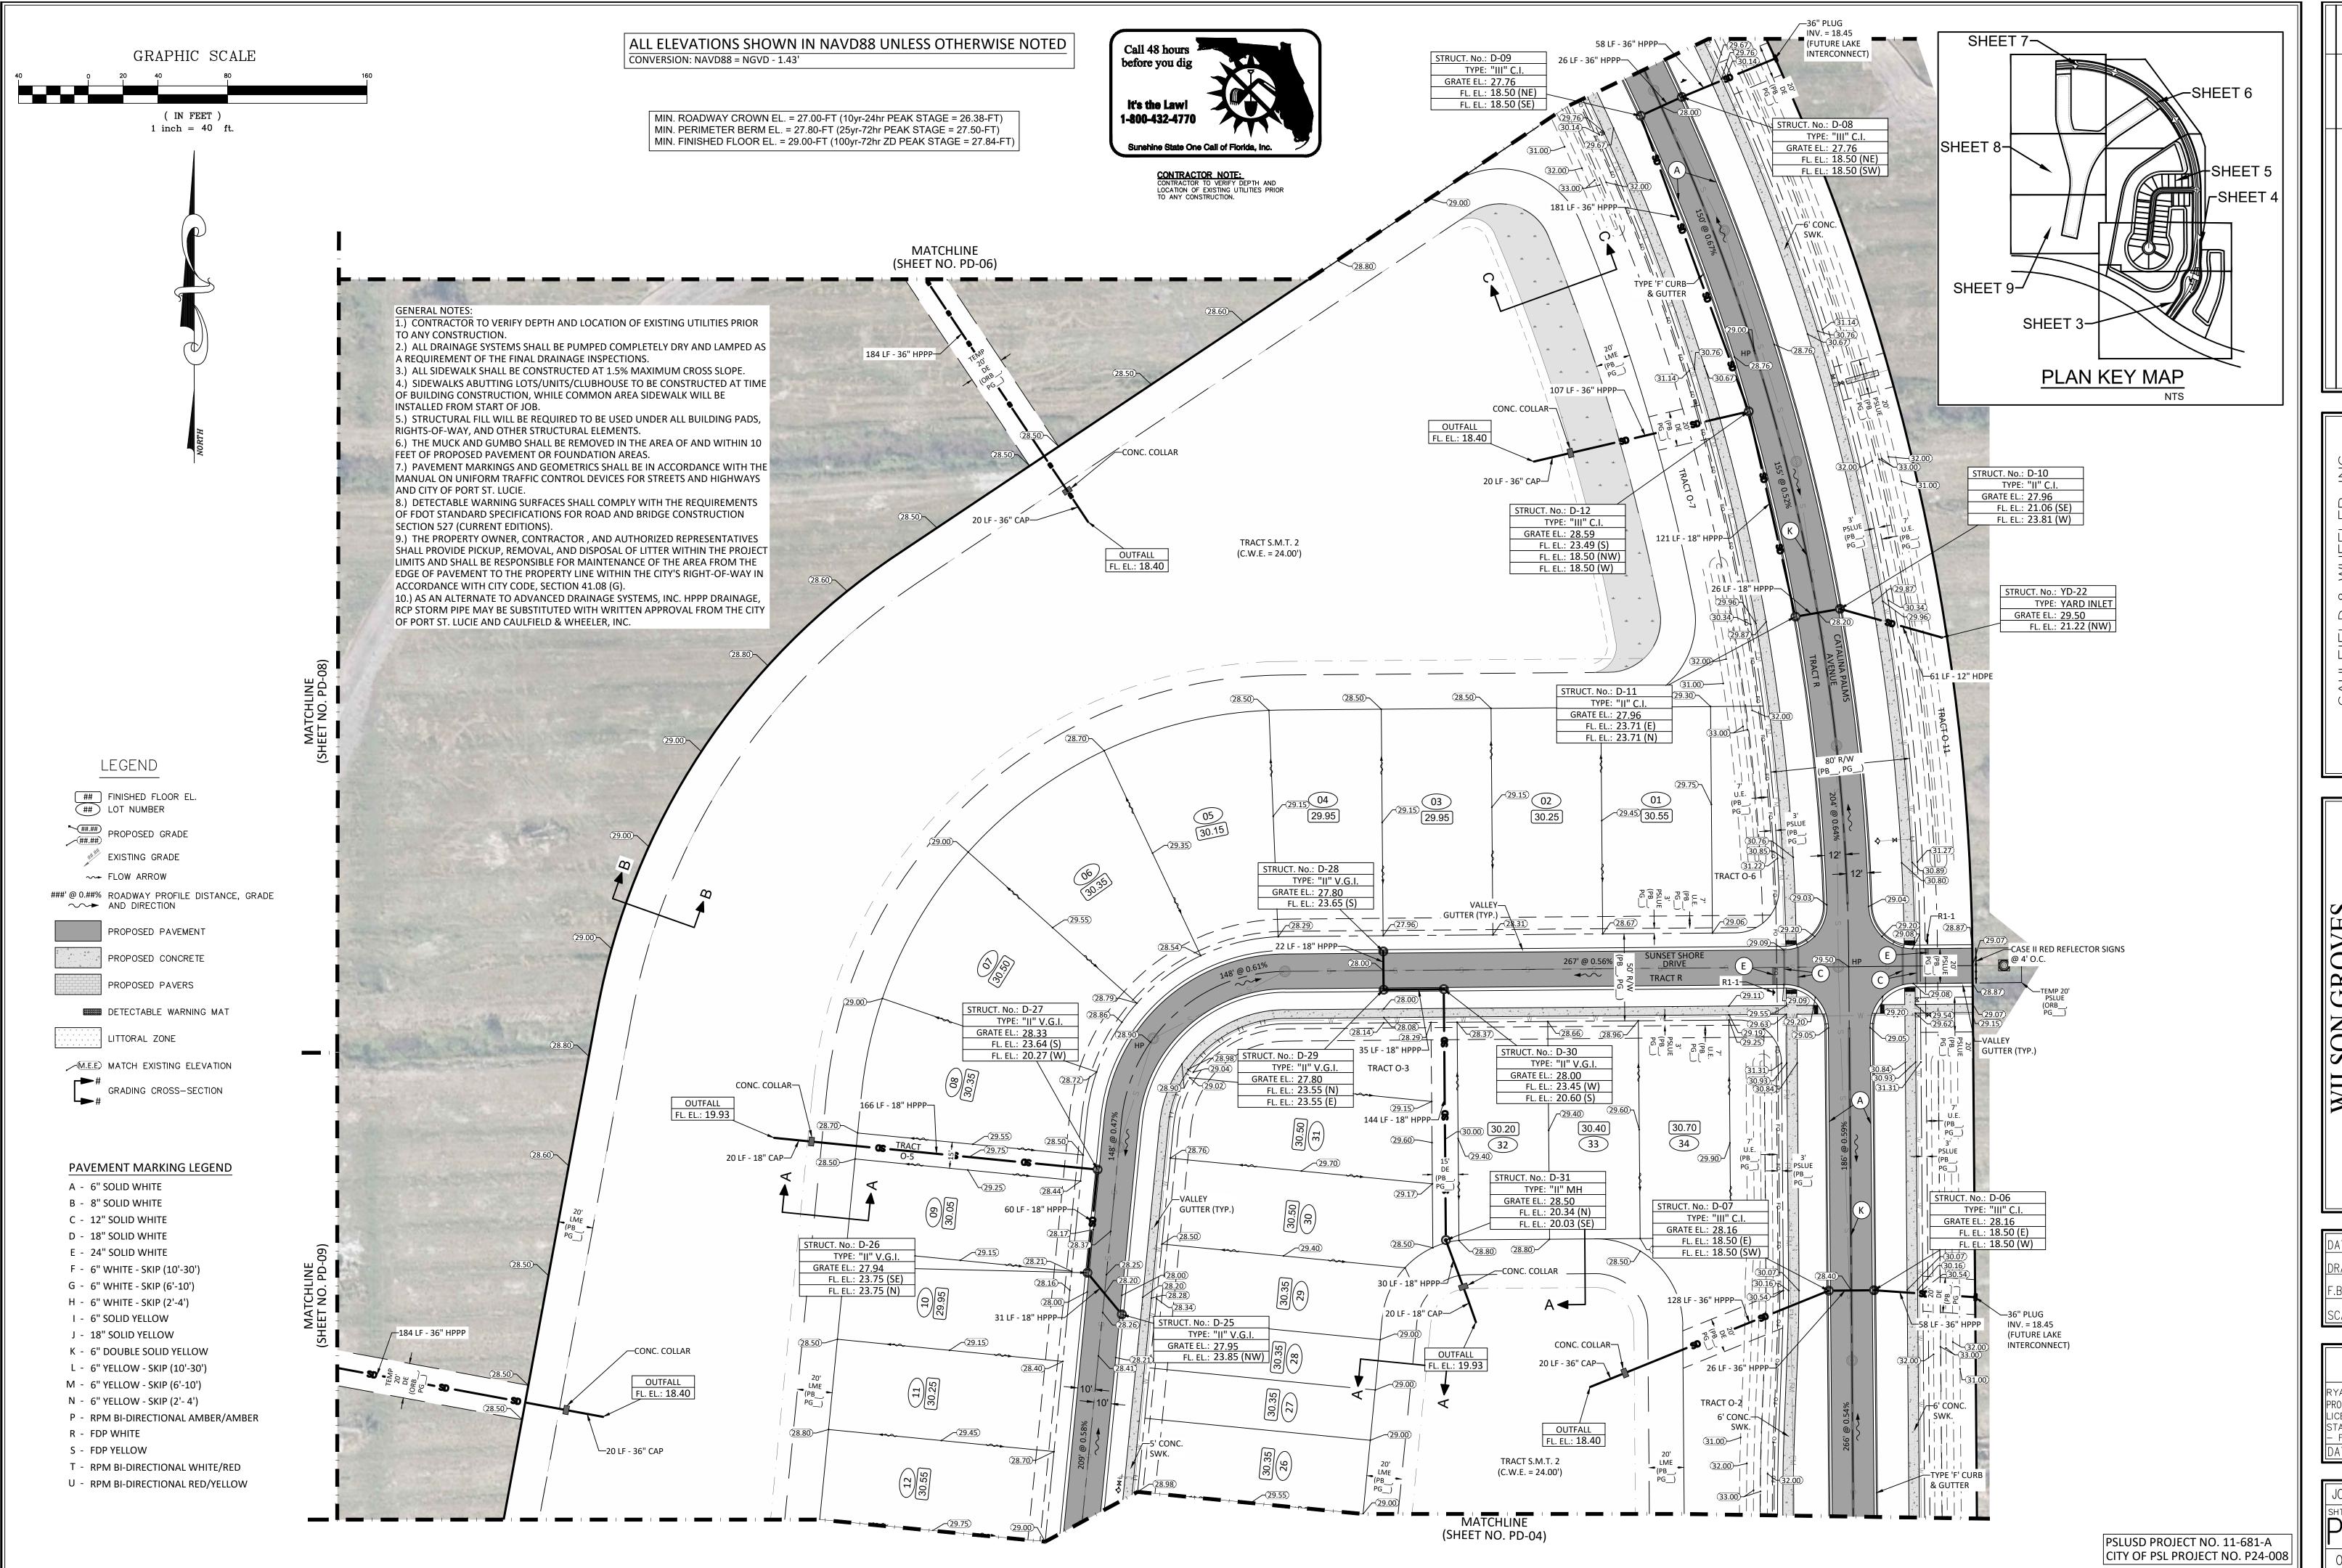


DATE 01/17/202

DRAWN BY RH F.B. / PG. ---

RYAN D. WHEELER PROFESSIONAL ENGINEE LICENSE NO. 7147 STATE OF FLORIDA - FOR THE FIRM -ATEAug 20, 202

JOB #4371-A01


OF 15 SHEETS

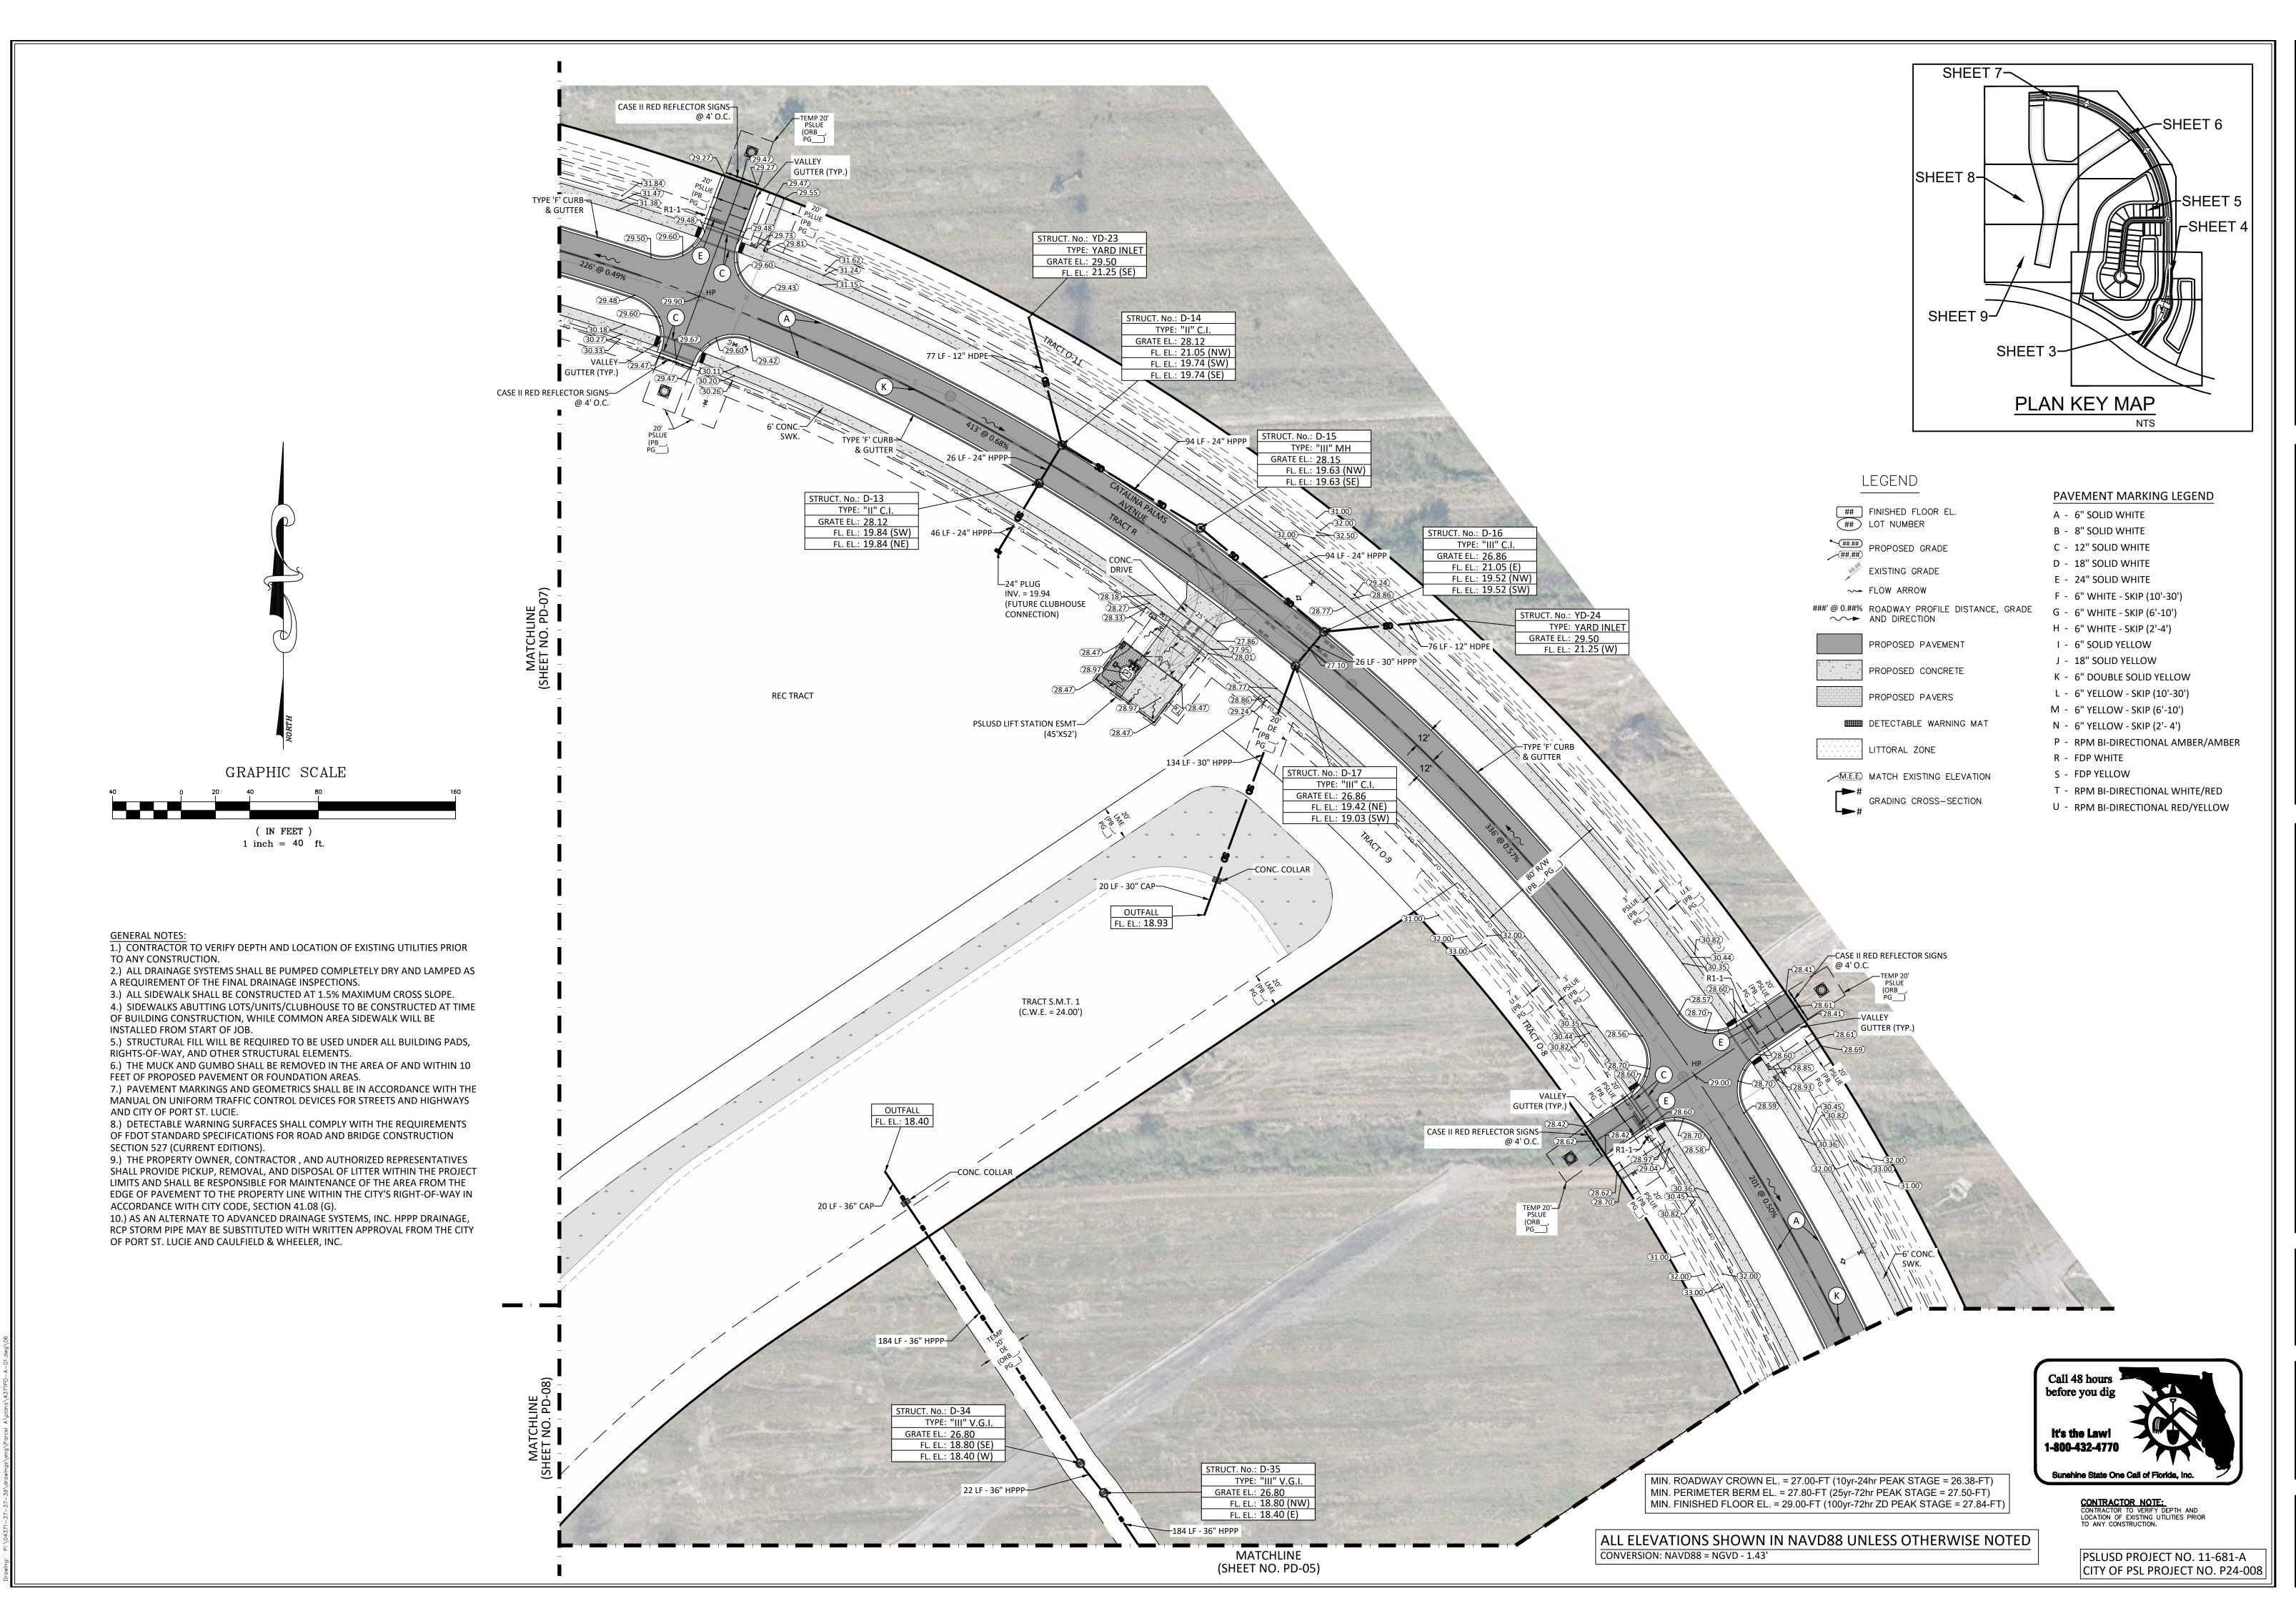

DATE 01/17/2024 DRAWN BY RH

F.B./ PG. ----

RYAN D. WHEELER PROFESSIONAL ENGINEER LICENSE NO. 71477 STATE OF FLORIDA - FOR THE FIRM -DATEAug 20, 202

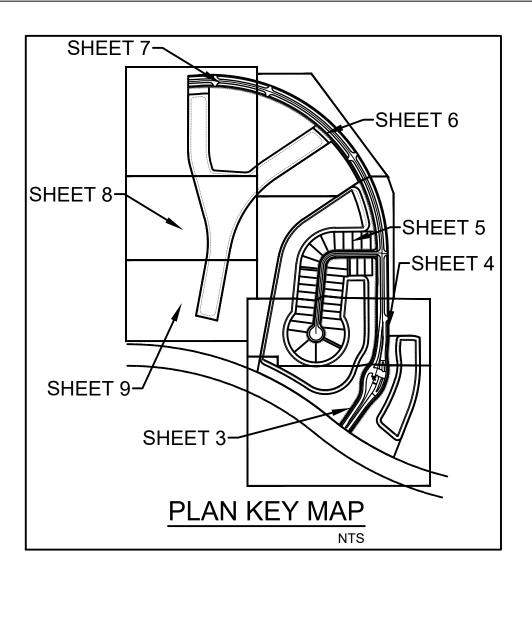

GENERAL NOTES:

1.) CONTRACTOR TO VERIFY DEPTH AND LOCATION OF EXISTING UTILITIES PRIOR TO ANY CONSTRUCTION.

2.) ALL DRAINAGE SYSTEMS SHALL BE PUMPED COMPLETELY DRY AND LAMPED AS A REQUIREMENT OF THE FINAL DRAINAGE INSPECTIONS.
3.) ALL SIDEWALK SHALL BE CONSTRUCTED AT 1.5% MAXIMUM CROSS SLOPE.
4.) SIDEWALKS ABUTTING LOTS/UNITS/CLUBHOUSE TO BE CONSTRUCTED AT TIME

OF BUILDING CONSTRUCTION, WHILE COMMON AREA SIDEWALK WILL BE INSTALLED FROM START OF JOB.

5.) STRUCTURAL FILL WILL BE REQUIRED TO BE USED UNDER ALL BUILDING PADS,

RIGHTS-OF-WAY, AND OTHER STRUCTURAL ELEMENTS.


6.) THE MUCK AND GUMBO SHALL BE REMOVED IN THE AREA OF AND WITHIN 10 FEET OF PROPOSED PAVEMENT OR FOUNDATION AREAS.

7.) PAVEMENT MARKINGS AND GEOMETRICS SHALL BE IN ACCORDANCE WITH THE MANUAL ON UNIFORM TRAFFIC CONTROL DEVICES FOR STREETS AND HIGHWAYS AND CITY OF PORT ST. LUCIE.

8.) DETECTABLE WARNING SURFACES SHALL COMPLY WITH THE REQUIREMENTS OF FDOT STANDARD SPECIFICATIONS FOR ROAD AND BRIDGE CONSTRUCTION SECTION 527 (CURRENT EDITIONS).


9.) THE PROPERTY OWNER, CONTRACTOR, AND AUTHORIZED REPRESENTATIVES SHALL PROVIDE PICKUP, REMOVAL, AND DISPOSAL OF LITTER WITHIN THE PROJECT LIMITS AND SHALL BE RESPONSIBLE FOR MAINTENANCE OF THE AREA FROM THE EDGE OF PAVEMENT TO THE PROPERTY LINE WITHIN THE CITY'S RIGHT-OF-WAY IN ACCORDANCE WITH CITY CODE, SECTION 41.08 (G).

10.) AS AN ALTERNATE TO ADVANCED DRAINAGE SYSTEMS, INC. HPPP DRAINAGE, RCP STORM PIPE MAY BE SUBSTITUTED WITH WRITTEN APPROVAL FROM THE CITY OF PORT ST. LUCIE AND CAULFIELD & WHEELER, INC.

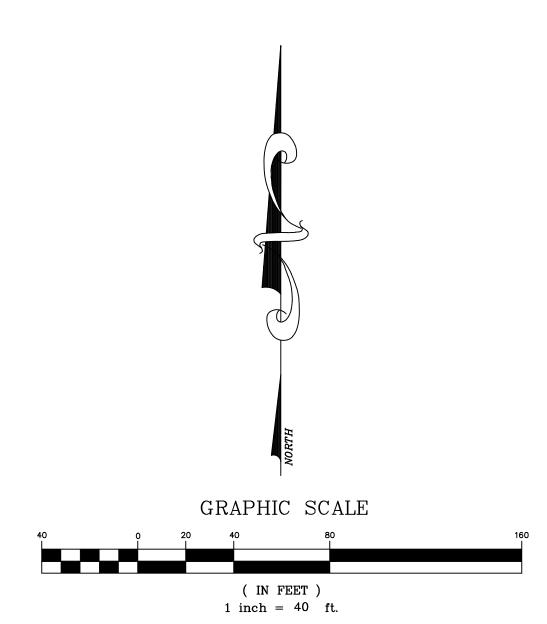

ALL ELEVATIONS SHOWN IN NAVD88 UNLESS OTHERWISE NOTED CONVERSION: NAVD88 = NGVD - 1.43'

MIN. ROADWAY CROWN EL. = 27.00-FT (10yr-24hr PEAK STAGE = 26.38-FT)
MIN. PERIMETER BERM EL. = 27.80-FT (25yr-72hr PEAK STAGE = 27.50-FT)

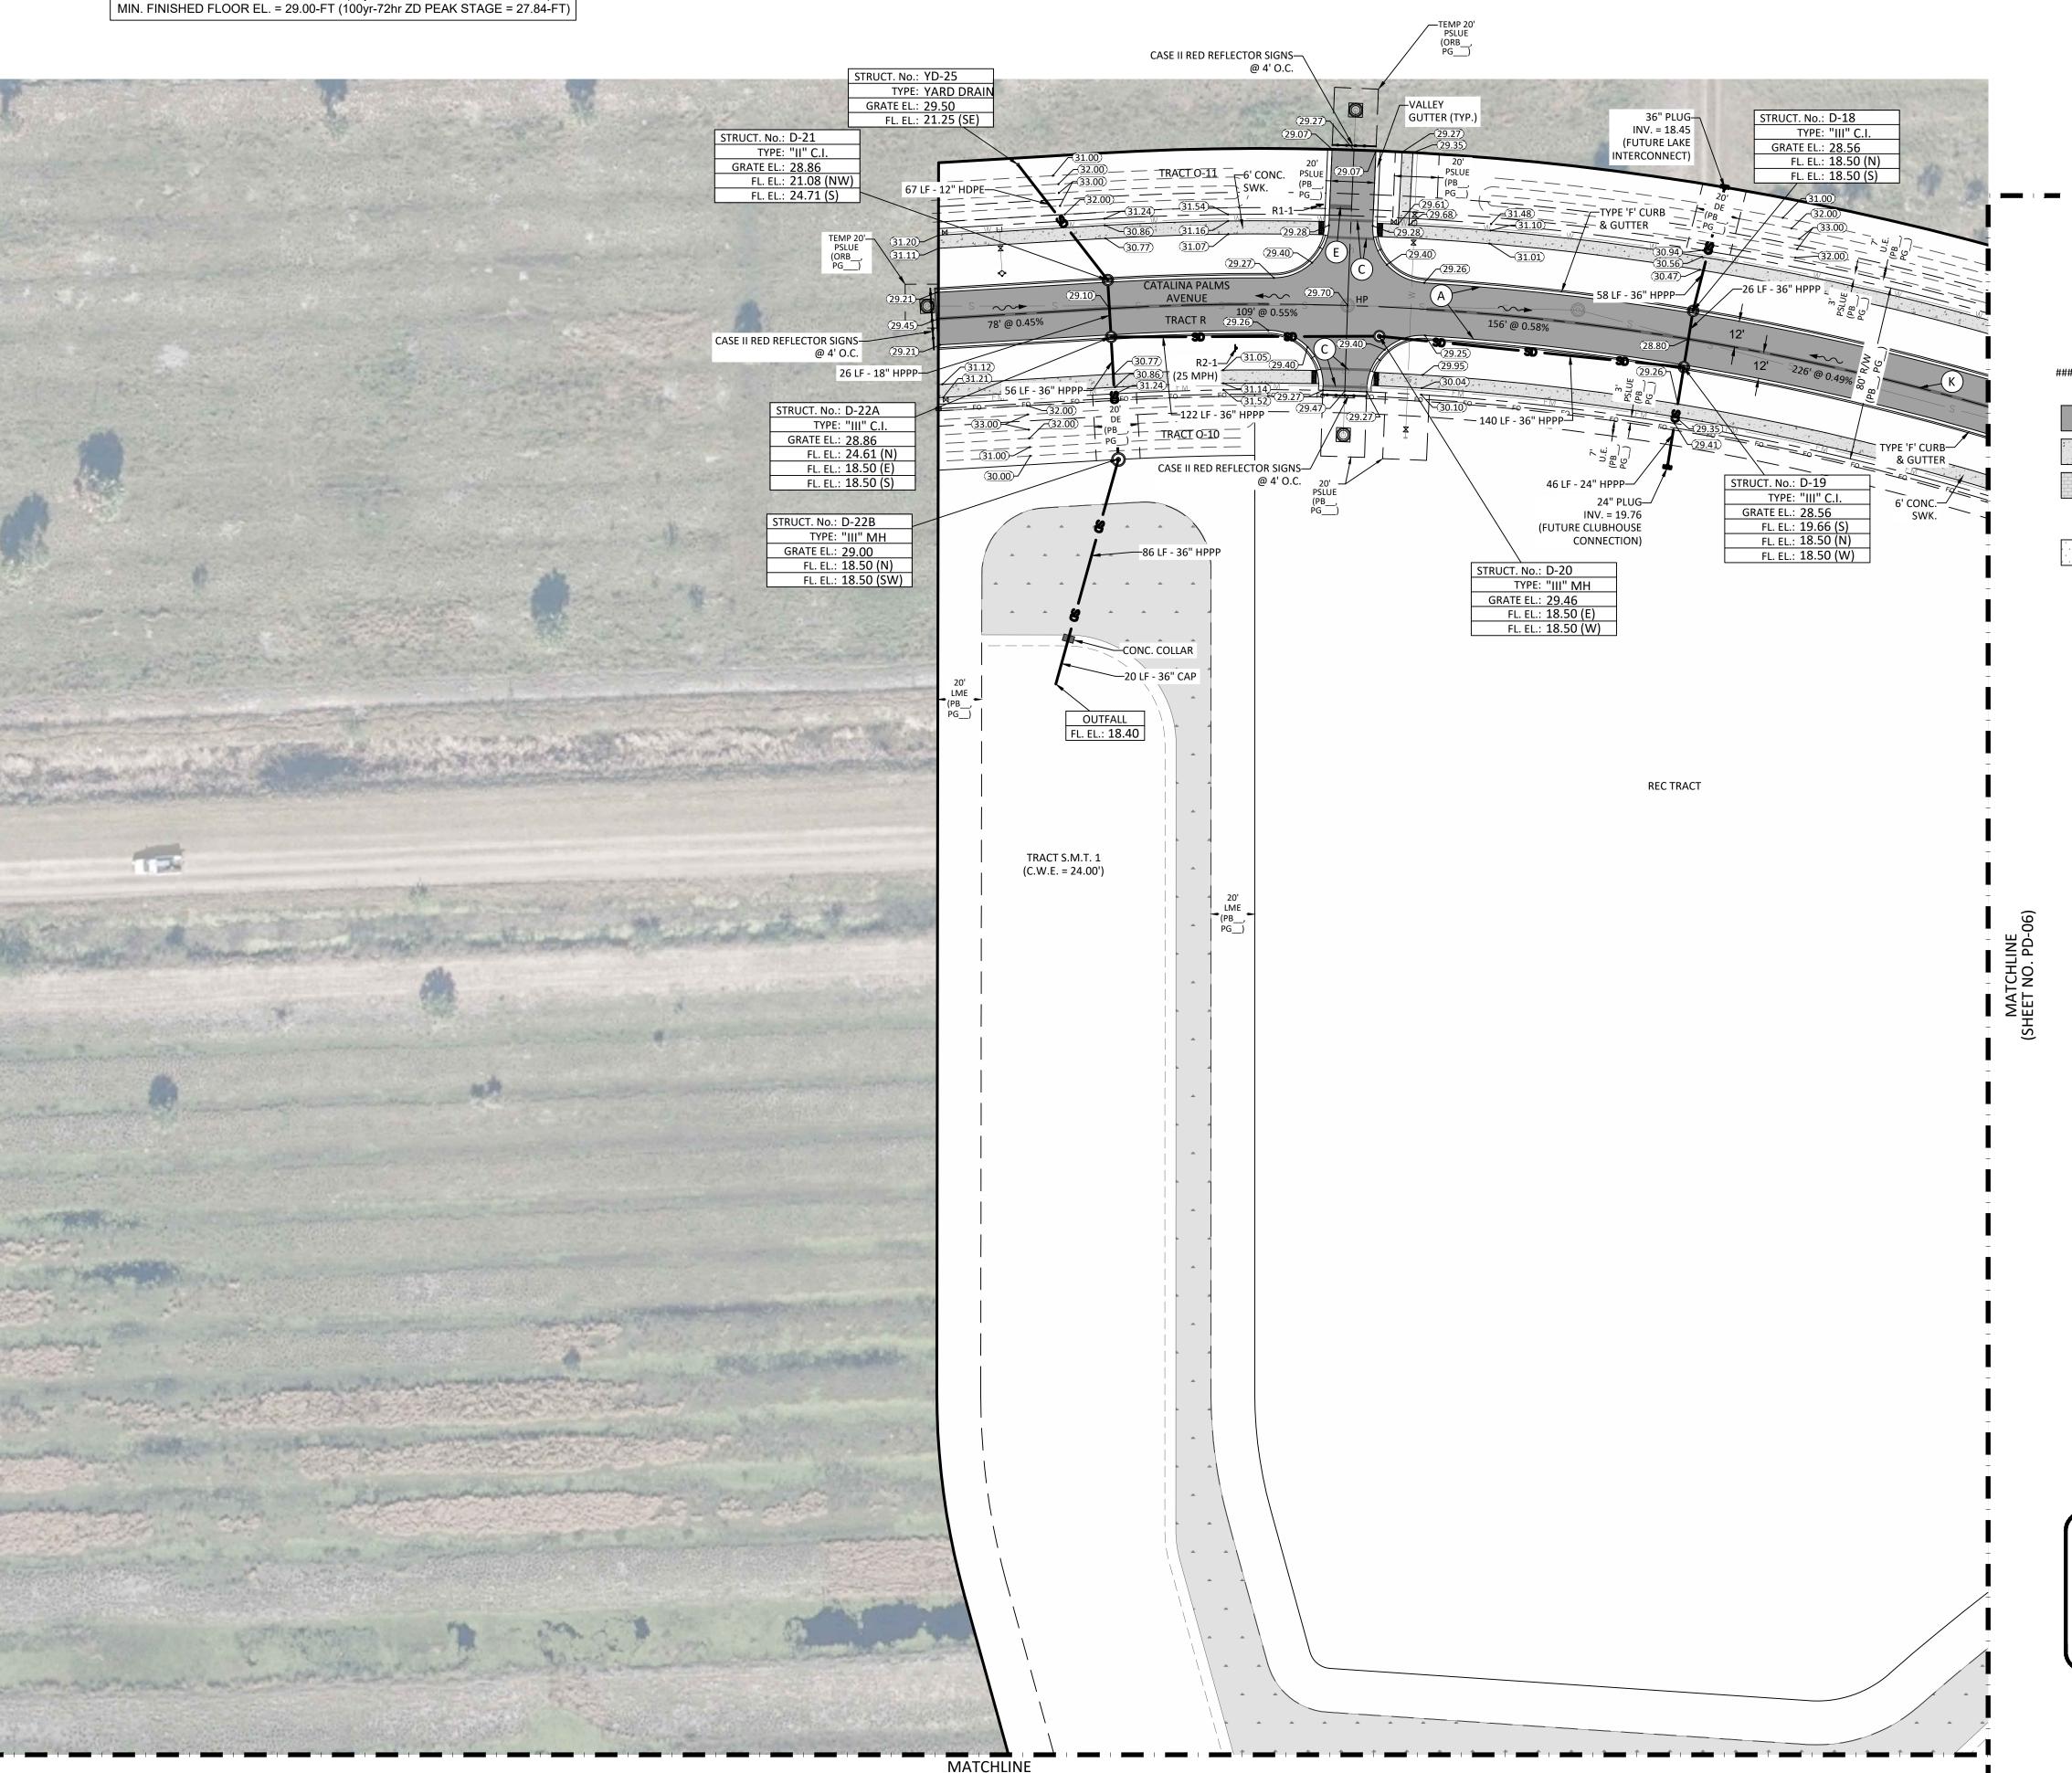

(SHEET NO. PD-08)

LEGEND

FINISHED FLOOR EL.
LOT NUMBER

PROPOSED GRADE

EXISTING GRADE

THOW ARROW

###'@0.##% ROADWAY PROFILE DISTANCE, GRADE

AND DIRECTION

PROPOSED PAVEMENT

PROPOSED CONCRETE

PROPOSED PAVERS

DETECTABLE WARNING MAT

LITTORAL ZONE

✓ M.E.E. MATCH EXISTING ELEVATION

GRADING CROSS-SECTION

PAVEMENT MARKING LEGEND

A - 6" SOLID WHITE B - 8" SOLID WHITE

C - 12" SOLID WHITE

D - 18" SOLID WHITE

E - 24" SOLID WHITE F - 6" WHITE - SKIP (10'-30')

G - 6" WHITE - SKIP (6'-10')

H - 6" WHITE - SKIP (2'-4')

I - 6" SOLID YELLOW

1 - 6" SOLID YELLOW

J - 18" SOLID YELLOW

K - 6" DOUBLE SOLID YELLOW

L - 6" YELLOW - SKIP (10'-30')
M - 6" YELLOW - SKIP (6'-10')

M - 6" YELLOW - SKIP (6'-10')

N - 6" YELLOW - SKIP (2'- 4')

P - RPM BI-DIRECTIONAL AMBER/AMBER

R - FDP WHITE

S - FDP YELLOW

T - RPM BI-DIRECTIONAL WHITE/RED

U - RPM BI-DIRECTIONAL RED/YELLOW

Call 48 hours before you dig

It's the Law!
1-800-432-4770

CONTRACTOR NOTE:
CONTRACTOR TO VERIFY DEPTH AND
LOCATION OF EXISTING UTILITIES PRIOR
TO ANY CONSTRUCTION.

PSLUSD PROJECT NO. 11-681-A CITY OF PSL PROJECT NO. P24-008 REVISIONS FILE NAME: 4371PD-A-01.dwa

IELD & WHEELER, INC.
CIVIL ENGINEERING - LAND PLANNING
LANDSCAPE ARCHITECTURE - SURVEYING
7900 GLADES ROAD - SUITE 100
BOCA RATON, FLORIDA 33434
HONE (561)-392-1991 / FAX (561)-750-1452

No. of the second secon

WILSON GROVES
PARCEL A PLAT 1
PAVING, GRADING, & DRAINAGE PLAN

DATE 01/17/2024

DRAWN BY RHT

F.B./ PG. ----

RYAN D. WHEELER
PROFESSIONAL ENGINEER
LICENSE NO. 71477
STATE OF FLORIDA
– FOR THE FIRM –
DATEAug 20, 2024

JOB #4371-A01 SHT.NO. PD-07

OF 15 SHEETS

LEGEND

FINISHED FLOOR EL.
LOT NUMBER

PROPOSED GRADE

EXISTING GRADE

###'@0.##% ROADWAY PROFILE DISTANCE, GRADE AND DIRECTION

PROPOSED PAVEMENT

PROPOSED CONCRETE PROPOSED PAVERS

DETECTABLE WARNING MAT

M.E.E. MATCH EXISTING ELEVATION

LITTORAL ZONE

GRADING CROSS-SECTION

PAVEMENT MARKING LEGEND

- A 6" SOLID WHITE
- B 8" SOLID WHITE
- C 12" SOLID WHITE
- D 18" SOLID WHITE E - 24" SOLID WHITE
- F 6" WHITE SKIP (10'-30')
- G 6" WHITE SKIP (6'-10')
- H 6" WHITE SKIP (2'-4')
- I 6" SOLID YELLOW
- J 18" SOLID YELLOW K - 6" DOUBLE SOLID YELLOW
- L 6" YELLOW SKIP (10'-30')
- M 6" YELLOW SKIP (6'-10') N - 6" YELLOW - SKIP (2'- 4')
- P RPM BI-DIRECTIONAL AMBER/AMBER
- R FDP WHITE S - FDP YELLOW
- T RPM BI-DIRECTIONAL WHITE/RED
- U RPM BI-DIRECTIONAL RED/YELLOW
- 1.) CONTRACTOR TO VERIFY DEPTH AND LOCATION OF EXISTING UTILITIES PRIOR TO ANY CONSTRUCTION.
- 2.) ALL DRAINAGE SYSTEMS SHALL BE PUMPED COMPLETELY DRY AND LAMPED AS A REQUIREMENT OF THE FINAL DRAINAGE INSPECTIONS.
- 3.) ALL SIDEWALK SHALL BE CONSTRUCTED AT 1.5% MAXIMUM CROSS SLOPE. 4.) SIDEWALKS ABUTTING LOTS/UNITS/CLUBHOUSE TO BE CONSTRUCTED AT TIME OF BUILDING CONSTRUCTION, WHILE COMMON AREA SIDEWALK WILL BE INSTALLED FROM START OF JOB.
- 5.) STRUCTURAL FILL WILL BE REQUIRED TO BE USED UNDER ALL BUILDING PADS, RIGHTS-OF-WAY, AND OTHER STRUCTURAL ELEMENTS.
- 6.) THE MUCK AND GUMBO SHALL BE REMOVED IN THE AREA OF AND WITHIN 10 FEET OF PROPOSED PAVEMENT OR FOUNDATION AREAS.
- 7.) PAVEMENT MARKINGS AND GEOMETRICS SHALL BE IN ACCORDANCE WITH THE MANUAL ON UNIFORM TRAFFIC CONTROL DEVICES FOR STREETS AND HIGHWAYS AND CITY OF PORT ST. LUCIE.
- 8.) DETECTABLE WARNING SURFACES SHALL COMPLY WITH THE REQUIREMENTS OF FDOT STANDARD SPECIFICATIONS FOR ROAD AND BRIDGE CONSTRUCTION SECTION 527 (CURRENT EDITIONS).
- 9.) THE PROPERTY OWNER, CONTRACTOR, AND AUTHORIZED REPRESENTATIVES SHALL PROVIDE PICKUP, REMOVAL, AND DISPOSAL OF LITTER WITHIN THE PROJECT LIMITS AND SHALL BE RESPONSIBLE FOR MAINTENANCE OF THE AREA FROM THE EDGE OF PAVEMENT TO THE PROPERTY LINE WITHIN THE CITY'S RIGHT-OF-WAY IN ACCORDANCE WITH CITY CODE, SECTION 41.08 (G).
- 10.) AS AN ALTERNATE TO ADVANCED DRAINAGE SYSTEMS, INC. HPPP DRAINAGE, RCP STORM PIPE MAY BE SUBSTITUTED WITH WRITTEN APPROVAL FROM THE CITY OF PORT ST. LUCIE AND CAULFIELD & WHEELER, INC.





CONTRACTOR NOTE:
CONTRACTOR TO VERIFY DEPTH AND
LOCATION OF EXISTING UTILITIES PRIOR
TO ANY CONSTRUCTION.

PSLUSD PROJECT NO. 11-681-A CITY OF PSL PROJECT NO. P24-008

PLAN

DATE 01/17/2024 DRAWN BY RH F.B. / PG. ----

RYAN D. WHEELER PROFESSIONAL ENGINEER LICENSE NO. 71477 STATE OF FLORIDA — FOR THE FIRM — DATEAug 20, 2024

JOB #4371-A01



FINISHED FLOOR EL.
LOT NUMBER

PROPOSED GRADE

**** EXISTING GRADE → FLOW ARROW

###'@0.##% ROADWAY PROFILE DISTANCE, GRADE AND DIRECTION

PROPOSED PAVEMENT

PROPOSED CONCRETE

PROPOSED PAVERS

LITTORAL ZONE

M.E.E. MATCH EXISTING ELEVATION

DETECTABLE WARNING MAT

GRADING CROSS-SECTION

PAVEMENT MARKING LEGEND

A - 6" SOLID WHITE

B - 8" SOLID WHITE

C - 12" SOLID WHITE

D - 18" SOLID WHITE E - 24" SOLID WHITE

F - 6" WHITE - SKIP (10'-30')

G - 6" WHITE - SKIP (6'-10')

H - 6" WHITE - SKIP (2'-4')

I - 6" SOLID YELLOW J - 18" SOLID YELLOW

K - 6" DOUBLE SOLID YELLOW

L - 6" YELLOW - SKIP (10'-30')

M - 6" YELLOW - SKIP (6'-10')

N - 6" YELLOW - SKIP (2'- 4') P - RPM BI-DIRECTIONAL AMBER/AMBER

R - FDP WHITE

S - FDP YELLOW T - RPM BI-DIRECTIONAL WHITE/RED

U - RPM BI-DIRECTIONAL RED/YELLOW

GENERAL NOTES:

1.) CONTRACTOR TO VERIFY DEPTH AND LOCATION OF EXISTING UTILITIES PRIOR TO ANY CONSTRUCTION.

2.) ALL DRAINAGE SYSTEMS SHALL BE PUMPED COMPLETELY DRY AND LAMPED AS A REQUIREMENT OF THE FINAL DRAINAGE INSPECTIONS. 3.) ALL SIDEWALK SHALL BE CONSTRUCTED AT 1.5% MAXIMUM CROSS SLOPE.

4.) SIDEWALKS ABUTTING LOTS/UNITS/CLUBHOUSE TO BE CONSTRUCTED AT TIME OF BUILDING CONSTRUCTION, WHILE COMMON AREA SIDEWALK WILL BE INSTALLED FROM START OF JOB.

5.) STRUCTURAL FILL WILL BE REQUIRED TO BE USED UNDER ALL BUILDING PADS, RIGHTS-OF-WAY, AND OTHER STRUCTURAL ELEMENTS. 6.) THE MUCK AND GUMBO SHALL BE REMOVED IN THE AREA OF AND WITHIN 10

FEET OF PROPOSED PAVEMENT OR FOUNDATION AREAS. 7.) PAVEMENT MARKINGS AND GEOMETRICS SHALL BE IN ACCORDANCE WITH THE MANUAL ON UNIFORM TRAFFIC CONTROL DEVICES FOR STREETS AND HIGHWAYS AND CITY OF PORT ST. LUCIE.

8.) DETECTABLE WARNING SURFACES SHALL COMPLY WITH THE REQUIREMENTS OF FDOT STANDARD SPECIFICATIONS FOR ROAD AND BRIDGE CONSTRUCTION SECTION 527 (CURRENT EDITIONS).

9.) THE PROPERTY OWNER, CONTRACTOR, AND AUTHORIZED REPRESENTATIVES SHALL PROVIDE PICKUP, REMOVAL, AND DISPOSAL OF LITTER WITHIN THE PROJECT LIMITS AND SHALL BE RESPONSIBLE FOR MAINTENANCE OF THE AREA FROM THE EDGE OF PAVEMENT TO THE PROPERTY LINE WITHIN THE CITY'S RIGHT-OF-WAY IN ACCORDANCE WITH CITY CODE, SECTION 41.08 (G).

10.) AS AN ALTERNATE TO ADVANCED DRAINAGE SYSTEMS, INC. HPPP DRAINAGE, RCP STORM PIPE MAY BE SUBSTITUTED WITH WRITTEN APPROVAL FROM THE CITY OF PORT ST. LUCIE AND CAULFIELD & WHEELER, INC.




ALL ELEVATIONS SHOWN IN NAVD88 UNLESS OTHERWISE NOTED CONVERSION: NAVD88 = NGVD - 1.43'

MIN. ROADWAY CROWN EL. = 27.00-FT (10yr-24hr PEAK STAGE = 26.38-FT)
MIN. PERIMETER BERM EL. = 27.80-FT (25yr-72hr PEAK STAGE = 27.50-FT)
MIN. FINISHED FLOOR EL. = 29.00-FT (100yr-72hr ZD PEAK STAGE = 27.84-FT)



CONTRACTOR NOTE:
CONTRACTOR TO VERIFY DEPTH AND
LOCATION OF EXISTING UTILITIES PRIOR
TO ANY CONSTRUCTION.


PSLUSD PROJECT NO. 11-681-A CITY OF PSL PROJECT NO. P24-008

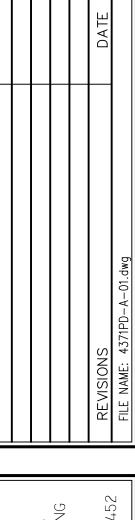

DATE 01/17/2024 DRAWN BY RH F.B./ PG. ----

RYAN D. WHEELER PROFESSIONAL ENGINEER LICENSE NO. 71477 STATE OF FLORIDA - FOR THE FIRM -DATEAug 20, 202

JOB #4371-A01

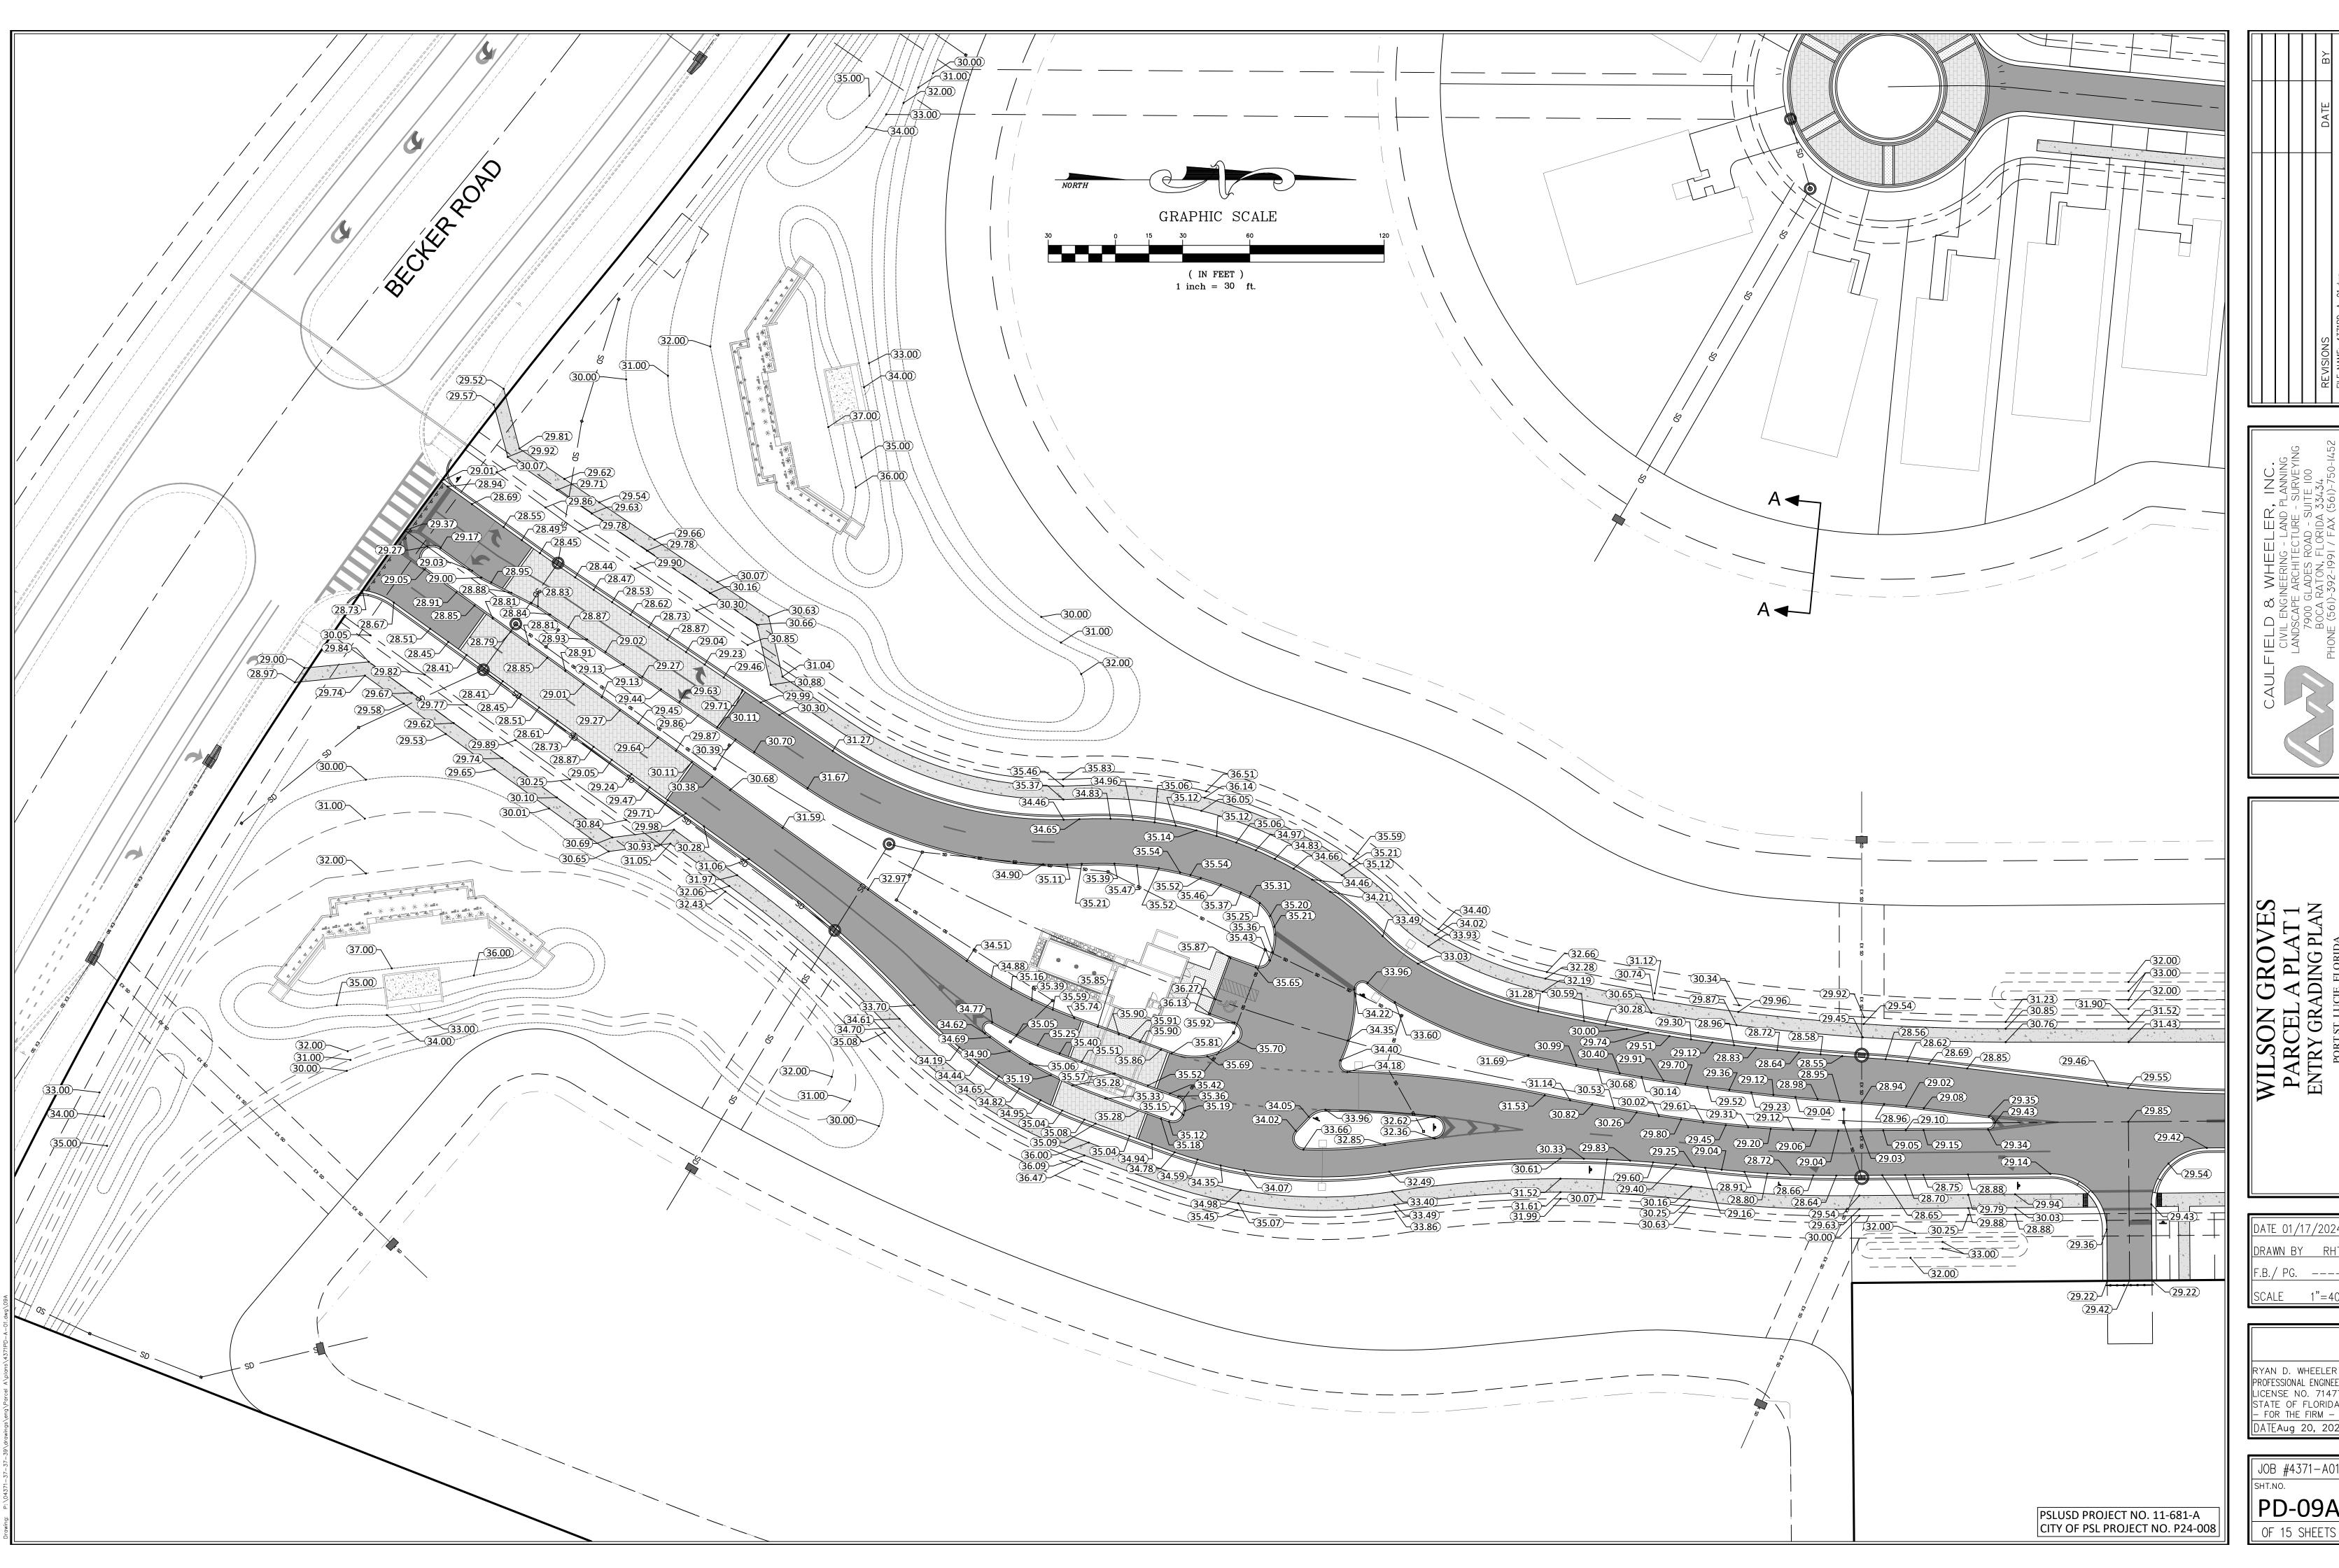

WILSON GROVES
PARCEL A PLAT 1
ENTRY GRADING PLAN

DATE 01/17/2024 DRAWN BY RH


F.B./ PG. ----

RYAN D. WHEELER PROFESSIONAL ENGINEER LICENSE NO. 71477 STATE OF FLORIDA - FOR THE FIRM -DATEAug 20, 202

JOB #4371-A01 PD-09A

- 1. 1.5" TYPE SP-9.5 STRUCTURAL COURSE (INSTALLED IN 2 3/4" LIFTS) [SN = 0.66]
- 2. FDOT OPTIONAL BASE GROUP 05 [SN = 1.26]
- 3. 12" TYPE "B" STABILIZATION (LBR 40) -OR-ADDITIONAL 5.5" LIMEROCK (MIN. LBR 100) [SN = 0.96]

TOTAL STRUCTURAL NUMBER, SN = 2.88

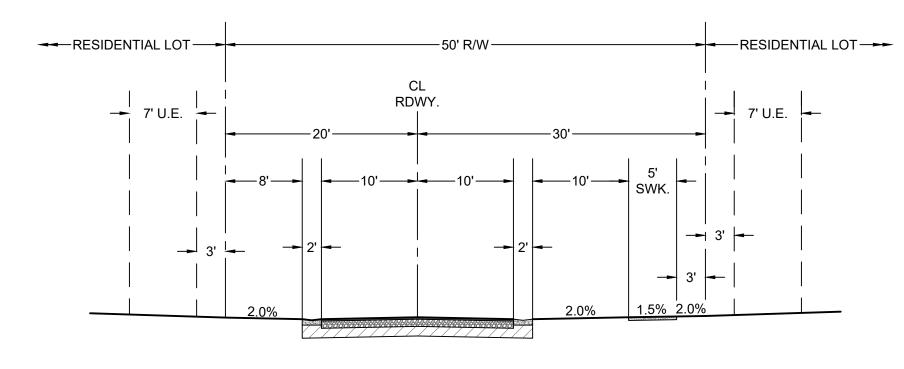

50' RIGHT-OF-WAY TYPICAL SECTION

80' ROAD RIGHT-OF-WAY ASPHALT PAVEMENT SECTION:


- 1. 1.5" TYPE SP-9.5 STRUCTURAL COURSE (INSTALLED IN 2 3/4" LIFTS) [SN = 0.66]
- 2. FDOT OPTIONAL BASE GROUP 06 [SN = 1.44]
- 3. 12" TYPE "B" STABILIZATION (LBR 40) -OR-ADDITIONAL 5.5" LIMEROCK (MIN. LBR 100) [SN = 0.96]

TOTAL STRUCTURAL NUMBER, SN = 3.06

80' ROAD RIGHT-OF-WAY PAVER-BRICK PAVEMENT SECTION:

- 1. 3-1/8" TRAFFIC-RATED PAVER BRICKS [SN = 0.72]
- 2. 1" MIN. SAND LEVELING COURSE
- 3. FDOT OPTIONAL BASE GROUP 08 [SN = 1.71]
- 4. 12" TYPE "B" STABILIZATION (LBR 40) -OR-ADDITIONAL 5.5" LIMEROCK (MIN. LBR 100) [SN = 0.96]

TOTAL STRUCTURAL NUMBER, SN = 3.39

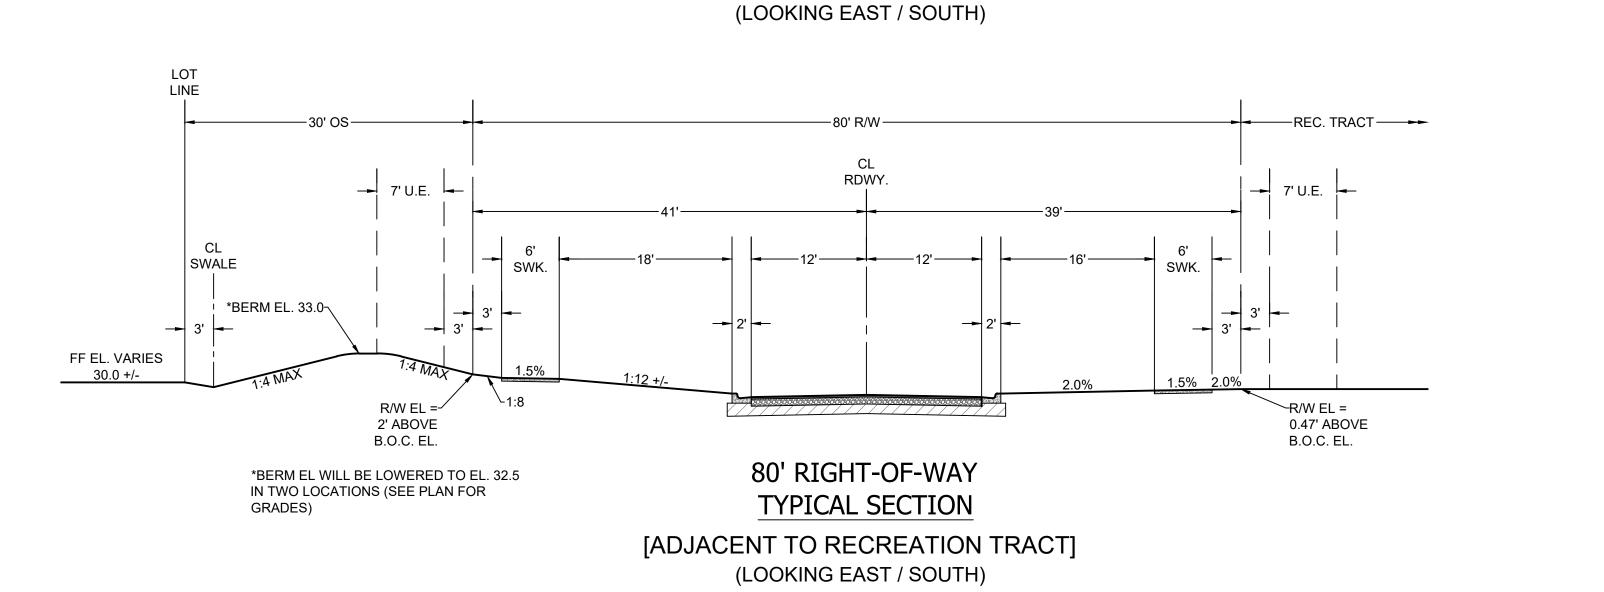

ALL ELEVATIONS SHOWN IN NAVD88 UNLESS OTHERWISE NOTED CONVERSION: NAVD88 = NGVD - 1.43'

PSLUSD PROJECT NO. 11-681-A CITY OF PSL PROJECT NO. P24-008 -EK, INC.
-AND PLANNING
URE - SURVEYING
) - SUITE 100
RIDA 33434
FAX (561)-750-1452
FILE NAME: 4371PD-A-01.dwg

CAULFIELD & WMEELER, IINC CIVIL ENGINEERING - LAND PLANNI LANDSCAPE ARCHITECTURE - SURVE 7900 GLADES ROAD - SUITE 100 BOCA RATON, FLORIDA 33434 PHONE (561)-392-1991 / FAX (561)-75

WILSOIN GROVES
PARCEL A PLAT 1
TYPICAL GRADING CROSS-SECTIONS

DATE 01/17/2024

DRAWN BY RHT

F.B./ PG. ----

SCALE AS SHOWN

RYAN D. WHEELER
PROFESSIONAL ENGINEER
LICENSE NO. 71477
STATE OF FLORIDA
– FOR THE FIRM –
DATEAug 20, 2024

JOB #4371-A01
SHT.NO.
PD-10
OF 15 SHEETS

GENERAL NOTES PAVING, GRADING & DRAINAGE

- 1. ALL DIMENSIONS SHOWN ON THESE DRAWINGS ARE SCALED DISTANCES. THE CONTRACTOR SHALL CONFIRM ALL MEASUREMENTS IN THE FIELD AND NOTIFY THE ENGINEER IN WRITING OF ANY DISCREPANCY PRIOR TO PERFORMING THE WORK. ALL QUANTITIES SHALL BE PAID ON THE BASIS OF FIELD MEASUREMENTS OF COMPLETED WORK.
- 2. REINFORCED CONCRETE PIPE (R.C.P.) SHALL BE IN ACCORDANCE WITH F.D.O.T. STANDARDS SPECIFICATIONS SEC. 941. CORRUGATED ALUMINUM PIPE (C.A.P.) SHALL BE IN ACCORDANCE WITH F.D.O.T. STANDARDS SPECIFICATIONS SEC. 945.
- 3. IT IS THE RESPONSIBILITY OF THE CONTRACTOR TO MAKE SUCH EXAMINATION OF THE SITE OF THE WORK, AND OF ANY MATERIAL SOURCES INDICATED IN THE PLANS, AS MAY BE NECESSARY TO INFORM HIMSELF OF THE CONDITIONS UNDER WHICH WORK IS TO BE PERFORMED.
- 4. PROPOSED GRADES SHOWN IN PAVED AREAS REFER TO FINISH PAVEMENT GRADES.
- 5. PAVEMENT MARKING AND GEOMETRICS SHALL BE IN ACCORDANCE WITH THE MANUAL ON UNIFORM TRAFFIC CONTROL DEVICES FOR STREETS AND HIGHWAYS AND CITY OF PORT ST. LUCIE TYPICAL NO. T-P-18.
- 6. ALL LOTS, ROADWAYS AND BORROW AREAS SHALL BE STRIPPED OF ALL DELETERIOUS (UNSUITABLE) MATERIALS AND MATERIALS SHALL BE DISPOSED WITHIN THE SITE.
- 7. ALL GRADING OF STREETS, INCLUDING THE REMOVAL OF ALL MATERIALS AND THE FINISHING OF ALL SHOULDERS, SUBGRADE PREPARATION, SWALES AND BACKSLOPES, IN ACCORDANCE WITH THE TYPICAL SECTIONS SHOWN HEREON SHALL BE INCLUDED IN THE BID PRICE FOR PAVING.
- 8. ANY EXISTING ROADWAY AND/OR UTILITY THAT IS DAMAGED BY THE CONTRACTOR SHALL BE CORRECTED AT THE CONTRACTOR'S EXPENSE TO THE SATISFACTION OF THE ENGINEER, AND
- 9. THE FULL DEPTH OF ALL EXISTING ORGANIC AND DELETERIOUS MATERIALS WITHIN THE RIGHT -OF- WAY AND UTILITIES AND DRAINAGE EASEMENT SHALL BE COMPLETE REMOVED. NO MATERIALS OF F.D.O.T. CLASS A-5, A-7, OR A-8 SHALL BE ALLOWED.
- 10. ANY MUCK POCKETS OR GUMBO ENCOUNTERED SHALL BE REMOVED WITHIN THE ROADWAY TO 1.0' BELOW SUBGRADE AND TO OUTSIDE EDGE OF BOTH SHOULDERS. THE MUCK AND GUMBO SHOULD BE REMOVED IN THE AREA OF AND WITHIN 10 FEET OF PROPOSED PAVEMENT OR FOUNDATION AREAS.
- 11. ALL PAVING AND DRAINAGE WORK TO BE CONSTRUCTED IN FULL ACCORDANCE WITH CITY OF PORT ST. LUCIE STANDARDS AND SPECIFICATIONS.
- 12. THE SEQUENCE OF CONSTRUCTION SHALL BE SUCH THAT ALL UNDERGROUND INSTALLATIONS OF EVERY KIND THAT WILL BE BENEATH THE PAVEMENT CURRENTLY TO BE CONSTRUCTED SHALL BE INSTALLED PRIOR TO THE COMPACTION OF SUBGRADE.
- 13. CONTRACTOR SHALL SUBMIT SHOP DRAWINGS TO ENGINEER AND CITY ON ALL PIPE, PIPE BANDS, DRAINAGE STRUCTURES, GRATES, FRAMES AND COVERS.
- 14. IT SHALL BE THE CONTRACTOR'S RESPONSIBILITY TO DETERMINE THE LOCATION OF EXISTING UTILITIES WHETHER SHOWN OR NOT SHOWN ON THESE DRAWINGS AND SHALL VERIFY ALL ELEVATIONS BEFORE STARTING CONSTRUCTION. ALL EXISTING UTILITIES DAMAGED BY THE CONTRACTOR SHALL BE RESTORED TO EXISTING OR BETTER CONDITIONS BY CONTRACTOR AT NO EXPENSE TO OWNER.
- 15. WHERE CONNECTIONS TO AN EXISTING DRAINAGE SYSTEM ARE PROPOSED, SAID EXISTING DRAINAGE STRUCTURES AND LINES SHALL BE PURGED OF ALL SILT AND DEBRIS PRIOR TO SAID CONNECTION, AND WHERE EXISTING DRAINAGE SYSTEM INCLUDES DITCHES, SAID DITCHES SHALL BE CLEARED AND REWORKED, AS NECESSARY, TO RESTORE THEM TO THEIR APPROVED DESIGN SECTION.
- 16. ALL PIPE JOINTS ARE TO BE INSPECTED BY A REPRESENTATIVE OF THE ENGINEER PRIOR TO BACKFILLING. ALL INSPECTIONS SHOULD BE ARRANGED NO LESS THAN 48 HOURS IN
- 17. ALL CATCH BASIN GRATES MUST HAVE LOCKING CHAINS IN ACCORDANCE WITH FDOT INDEX 201.

CLEARING AND GRUBBING:

- 18. WORK SHALL CONSIST OF THE COMPLETE REMOVAL AND DISPOSAL OF ALL BUILDINGS, TIMBER, BRUSH, STUMPS, ROOTS, RUBBISH, AND DEBRIS AND ALL OTHER OBSTRUCTIONS RESTING ON OR PROTRUDING THROUGH THE SURFACE OF THE EXISTING GROUND AND THE SURFACE OF EXCAVATED AREAS, AND OF ALL OTHER STRUCTURES AND OBSTRUCTIONS NECESSARY TO BE REMOVED, INCLUDING SEPTIC TANKS, BUILDING FOUNDATIONS, AND PIPES.
- 19. ROOTS AND OTHER DEBRIS SHALL BE REMOVED TO A DEPTH OF AT LEAST ONE FOOT BELOW THE GROUND SURFACE. ALL STUMPS WITHIN THE CONSTRUCTION AREA SHALL BE COMPLETELY REMOVED AND DISPOSED OF BY THE CONTRACTOR.
- 20. EXISTING TREES TO REMAIN WHERE SO DIRECTED BY THE ENGINEER, SHALL BE TRIMMED, PROTECTED AND LEFT STANDING.
- 21. PROPERTY OBSTRUCTIONS WHICH ARE TO REMAIN IN PLACE, SUCH AS BUILDINGS, SEWERS, DRAINS, WATER OR GAS PIPES, CONDUITS, POLES, WALLS, POSTS, BRIDGES, ETC. ARE TO BE CAREFULLY PROTECTED FROM INJURY AND ARE NOT TO BE DISPLACED.
- 22. CLEARING AND GRUBBING MATERIALS SHALL BE DISPOSED OF BY THE CONTRACTOR IN LOCATIONS AND BY METHODS APPROVED BY THE ENGINEER.

SUB-GRADE:

- 23. UTILIZATION OF MATERIAL IN SUBGRADE CONSTRUCTION SHALL BE IN ACCORDANCE WITH PLAN DETAILS OR AS DIRECTED BY THE ENGINEER.
- 24. A PROCTOR TEST SHALL BE PERFORMED ON THE PROPOSED SUBGRADE MATERIAL TO DETERMINE THE OPTIMUM MOISTURE CONTENT AND MAXIMUM DENSITY OF THE MATERIAL. IN-PLACE DENSITY TESTS OF THE FINISH SUBGRADE SHALL BE PERFORMED AT A FREQUENCY OF AT LEAST ONE TEST FOR EVERY 7,000 SQ.FT. OF PORPOSED PAVEMENT AREA TO DETERMINE COMPLIANCE WITH THE DESIGN SPECIFICATIONS OF 100% OF MAX. DENSITY PER AASHTO T-99 TESTING METHODS.
- 25. STABILIZED SUBGRADE SHALL HAVE A MINIMUM LIMEROCK BEARING RATIO (LBR) OF 40. THE COMPACTED SUBGRADE SHALL CONFORM TO THE LINES, GRADES, AND CROSS—SECTIONS SHOWN ON THE PLANS. ALL ROOTS, STUMPS, OR OBJECTIONABLE MATERIAL PRESENT ON, UNDER, OR PROTRUDING THROUGH THE SURFACE SHALL BE COMPLETELY REMOVED FROM THE SUBGRADE. THE FINISHED SURFACE OF THE SUBGRADE SHALL BE STRING—LINED PRIOR TO PLACEMENT OF ROCK BASE TO VERIFY THAT THE SUBGRADE HAS BEEN CONSTRUCTED TO THE PROPER LINES, CROSS—SECTIONS, AND ELEVATIONS WITHIN AN ALLOWABLE TOLERANCE OF 1/2" OF THE PROPOSED FINISH SUBGRADE ELEVATIONS.

BASE:

- 26. LIMEROCK COMPOSITION THE FOLLOWING TESTS ARE REQUIRED ON THE LIMEROCK MATERIAL: A. CHEMICAL COMPOSITION TEST TO DETERMINE THAT MATERIAL HAS A MINIMUM PERCENT CARBONATES OF 60%. B. LIMEROCK BEARING RATIO TEST TO DETERMINE THAT MATERIAL CAN ACHIEVE AN LBR OF 100. C. SIEVE ANALYSIS TO INSURE THAT AT LEAST 97% (BY WEIGHT) OF THE MATERIAL SHALL PASS A 3-1/2" SIEVE AND MATERIAL SHALL BE GRADED UNIFORMLY DOWN TO DUST. THE FINE MATERIAL SHALL CONSIST ENTIRELY OF DUST OF FRACTURE. ALL CRUSHING OR BREAKING-UP WHICH MIGHT BE NECESSARY IN ORDER TO MEET SUCH SIZE REQUIREMENTS SHALL BE DONE BEFORE THE MATERIAL IS PLACED ON THE ROAD.
- 27. A PROCTOR TEST SHALL BE PERFORMED ON THE PROPOSED LIMEROCK MATERIAL TO DETERMINE THE MAXIMUM DENSITY OF THE MATERIAL. IN-PLACE DENSITY TESTS SHALL BE TAKEN AT A FREQUENCY OF AT LEAST ONE TEST FOR EVERY 7,000 SQ.FT. OF PROPOSED PAVEMENT TO DETERMINE COMPLIANCE WITH THE DESIGN SPECIFICATIONS OF 98% OF MAX. DENSITY PER AASHTO T-180 TESTING METHODS.
- 28. THE COMPACTED BASE SHALL CONFORM TO THE LINES, GRADES, AND CROSS—SECTION SHOWN ON THE PLANS. THE FINISH BASE SURFACE SHALL BE STRINGLINED OR CHECKED WITH A TEMPLATE TO VERIFY CONFORMANCE WITH THE PLAN GRADES WITHIN AN ALLOWABLE TOLERANCE OF 1/4" OF THE PROPOSED BASE ELEVATIONS. PRIME COAT SHALL BE APPLIED AT A RATE OF 0.25 GALLONS PER SQUARE YARD.

ASPHALTIC CONCRETE SURFACE COURSE:

BE CORRECTED TO THE ENGINEER'S SATISFACTION.

REFERENCE MARKERS SHALL BE LOCATED AND NOTED ON THE PLAT.

- 29. TACK COAT A. PRIOR TO INSTALLATION OF THE OVERLAY, THE SURFACE OF THE EXISTING ASPHALT SHALL BE BROOMED TO REMOVE ALL LOOSE MATERIAL WHICH MIGHT INTERFERE WITH THE ADHESION OF THE EXISTING ASPHALT AND OVERLAY. B. A TACK COAT SHALL BE APPLIED TO THE TOP OF THE CLEAN ASPHALT SURFACE AT A RATE OF 0.10 GALLONS/SQ.FT. IN THE PRESENCE OF THE ENGINEER'S REPRESENTATIVE.
- 30. PRIME COAT SHALL BE APPLIED AT A RATE OF 0.25 GALLONS PER SQUARE YARD. PRIME AND TACK COAT FOR BASE SHALL CONFORM TO THE REQUIREMENTS AND SPECIFICATIONS OF SECTION 300-1 THROUGH 300-7 OF F.D.O.T. STANDARDS SPECIFICATIONS.
- 31. ASPHALTIC CONCRETE SHALL CONFORM TO FLORIDA D.O.T. REQUIREMENTS OF TYPE S-1 AND S-3. CERTIFICATIONS OF THE ASPHALT MIX SHALL BE SUBMITTED BY THE ASPHALT PLANT TO THE ENGINEER FOR APPROVAL PRIOR TO CONSTRUCTION.
- 32. THE TEMPERATURE OF THE ASPHALT SHALL BE AT LEAST 230 DEGREES F. DURING THE LAYING OPERATION.
- 33. THE THICKNESS OF THE FINISHED SURFACE COURSE SHALL BE CHECKED AT VARIOUS INTERVALS TO INSURE THE CONSTRUCTED SURFACE COURSE IS WITHIN 1/8" OF THE DESIGN THICKNESS
- (NO NEGATIVE TOLERANCE WILL BE ACCEPTABLE).

 34. THE FINISHED SURFACE OF THE ASPHALT SHALL BE CHECKED WITH A STRAIGHT EDGE TO INSURE THAT THE LINE, GRADE, AND CROSS—SECTION OF THE FINISHED PAVEMENT SECTION IS IN CONFORMANCE WITH THE DESIGN PLANS. THE FINISHED SURFACE SHALL BE OF UNIFORM TEXTURE AND COMPACTION. THE SURFACE SHALL HAVE NO PULLED, TORN, OR LOOSENED
- 35. ALL REPAIRS TO EXISTING PAVEMENT SHALL RECEIVE SAWCUT EDGE PRIOR TO RELAYING ASPHALT. UNDER PAVEMENT UTILITY PIPING OR WIRING LESS THAN FOUR (4) INCHES IN DIAMETER REQUIRES A SCHEDULE 40 PVC CASING PIPE WITH SAND BACKFILLS.

PORTIONS AND SHALL BE FREE OF SEGREGATION, SAND, STREAKS, SAND SPOTS, OR RIPPLES. ALL AREAS OF THE SURFACE WHICH DOES NOT MEET THE FOREGOING REQUIREMENTS SHALL

36. ALL PERMANENT CONTROL POINTS AND/OR REFERENCE MARKERS SHOWN ON PLAT SHALL BE RAISED TO FINAL GRADE IF LOCATED IN PAVEMENT OR CONCRETE. THESE POINTS AND

NOTIFICATION, TESTING

- 37. NOTIFICATION THE CONTRACTOR SHALL NOTIFY THE ENGINEER, THE CITY AND UTILITIES 48 HOURS PRIOR TO SCHEDULING FIELD OBSERVATIONS AND SHALL SUPPLY ALL EQUIPMENT NECESSARY TO TEST THE COMPLETED WORK. CALL U.N.C.L.E. PRIOR TO ANY EXCAVATION.
- 38. ALL DRAINAGE SYSTEMS SHALL BE PUMPED DOWN TO BELOW 1/3 OF THE DIAMETER OF THE PIPE (FROM THE INVERT) AND LAMPED AS A REQUIREMENT OF THE FINAL DRAINAGE INSPECTION.
- 39. GRATE AND RIM ELEVATION ARE BASED ON PROPOSED FINISHED GRADE. ADJUSTMENTS MAY BE NECESSARY DUE TO FIELD CONDITIONS. ADJUSTMENTS ARE TO BE MADE BY THE CONTRACTOR WHEN THE BASE COURSE IS IN PLACE OR SITE GRADING IS COMPLETE. COST OF ADJUSTING RIMS AND GRATES IS TO BE INCLUDED IN BASE BID.

SODDING:

- 40. WORK CONSISTS OF THE ESTABLISHING OF A STAND OF GRASS WITHIN THE AREAS CALLED FOR BY THE FURNISHING AND PLACING OF GRASS SOD AND FERTILIZING, WATERING, AND MAINTAINING SODDED AREAS SUCH AS TO ASSURE A HEALTHY STAND OF GRASS.
- 41. THE AREA OVER WHICH THE SOD IS TO BE PLACED SHALL BE SCARIFIED OR LOOSENED TO SUITABLE DEPTH. THE SOD SHALL BE PLACED ON THE PREPARED SURFACE WITH EDGES IN CLOSE CONTACT AND SHALL BE FIRMLY AND SMOOTHLY EMBEDDED BY LIGHT TAMPING WITH APPROPRIATE TOOLS. ON AREAS WHERE THE SOD MAY SLIDE DUE TO HEIGHT AND SLOPE, THE ENGINEER MAY DIRECT THAT THE SOD BE PEGGED WITH PEGS DRIVEN THROUGH THE SOD BLOCKS INTO FIRM EARTH AT SUITABLE INTERVALS.

Pavement marking and geometric shall be in accordance with the "Manual on Uniform Traffic Control Devices for Streets and Highways", and "CITY OF PORT ST. LUCIE" typical No. T-P-21 (Or latest version).

PERMANENT MARKINGS

Installation:

- All markings shall be installed by the extruded method.
 Markings shall be free of weaves, bows, drips, drags, and
- other degrading items.

 Chalk shall be used for all layout markings

Materials:

All materials shall be alkyd thermoplastic meeting all State specifications.

Thickness:

 All markings shall be installed to yield 90 mils of material measured above the pavement surface.

Bea

 Reflective beads are to be installed per FDOT specifications on all markings.

Layout:

Layout shall be made using marking chalk.

 It is recommended that marking layout be inspected by the City Engineer prior to the placement of final markings.

TEMPORARY MARKINGS

Temporary markings may be used only as specified in this section, or as approved or directed by the CITY OF PORT ST. LUCIE Engineer.

Final Pavement Surface:

Only foil backed marking tape is allowed.
 All tape shall be totally removed concurrent with permanent marking placement.

Other Pavement Surfaces:

Intermediate pavement surfaces may be marked with FDOT approved materials, designs, and specifications.

ALL PAVEMENT MARKINGS

All paved surfaces shall be properly marked prior to the hours of darkness.

RAISED PAVEMENT MARKERS

and epoxy on concrete.

- R.P.M.s shall be installed on all lane lines and centerlines,
- spaced at 20'or 40'.

 R.P.M.s shall be a 4 x 4 type class "B" marker meeting FDOT specifications and shall be approved by the Engineer prior to
- R.P.M.'s shall be installed using alkyd thermoplastic on asphalt

PAVEMENT MARKING SPECIFICATION

NOTES:

-ELEVATIONS SHOWN ARE IN NAVD 88 DATUM

-ALL DRAINAGE SYSTEMS SHALL BE PUMPED COMPLETELY DRY AND LAMPED AS A REQUIREMENT OF THE FINAL DRAINAGE INSPECTIONS.

CAULFIELD CIVIL LANDS

CAULFIE

VILSON GROVES
PARCEL A PLAT 1
RADING, & DRAINAGE DETAIL

DATE 01/17/2024 DRAWN BY RHT F.B./ PG. ----

RYAN D. WHEELER
PROFESSIONAL ENGINEE
LICENSE NO. 71477
STATE OF FLORIDA
– FOR THE FIRM –
DATEAug 20, 202

JOB #4371-A01
SHT.NO.
PD-11
OF 15 SHEETS

PSLUSD PROJECT NO. 11-681-A CITY OF PSL PROJECT NO. P24-008 SOLID CONCRETE INTERLOCKING PAVING STONE SPECIFICATIONS

I. DESCRIPTION

1.1. GENERAL:

A. Scope of Work:

Furnish and place sand bedding course.

- 2. Furnish and install concrete interlocking paving stones in the quality, shape, thickness and a color as specified.
- 3. Furnish and install all accessory items as required by the contract.

1. Furnish and install subgrade per Table 100.6 of the CITY OF PORT ST. LUCIE Land

Development Design Standards Manual. 2. Furnish and install base per Table 100.6 of the CITY OF PORT ST. LUCIE Land Development Design Standards Manual.

C. Product Handling:

1. Paving stones shall be delivered and unloaded at jobsite in such a manner that no damage occurs during shipping, handling and storage.

D. References:

1. Solid concrete interlocking paving stones shall meet or exceed the requirements in ASTM C-936 Standard Specifications for Solid Concrete Interlocking Paving Units.

II. MATERIALS:

2.1. SOLID CONCRETE INTERLOCKING PAVING STONES:

A. Thickness, Color and Pattern:

1. Paving stone thickness shall be between 3-1/8" min -4" max..

- 2. All paving stones shall be colored through the full depth of paver and not just the surface.
- 3. A multi-colored paving stone pattern shall be used.

B. Cementitious Materials:

1. Portland cements shall conform to ASTM C-150.

Aggregates shall conform to ASTM C-33 for normal weight concrete except that grading requirements shall not necessarily apply.

D. Other Materials:

1. Coloring pigments, air entraining agents, integral water repellents, finely ground silica, etc., shall conform to ASTM standard where applicable or shall be previously established as suitable for use in concrete.

E. Compressive Strength:

1. At the time of delivery to the work site, the average compressive strength shall not be less than 8,000 psi with no individual unit strength less than 7,200 psi, with testing procedures in accordance with ASTM C-140.

F. Absorption:

1. The average absorption shall not be greater than 5% with no individual unit absorption greater than 7%.

G. Proven Field Performance:

1. Satisfying field performance is indicated when paving stones similar in composition, and made with the same manufacturing equipment as those supplied to the purchaser, do not exhibit deterioration after one year.

H. Visual Inspection:

- 1. All paving stones shall be sound and free of defects that would interfere with the proper placement of the paving stone or impair the strength or permanence of
- 2. Minor cracks incidental to the usual methods of manufacture, or chipping resulting from customary methods of handling in shipment and delivery, shall not be deemed grounds for rejection.

I. Sampling and Testing:

- 1. The purchaser shall be accorded proper facilities to inspect and sample the paving stones at the place of manufacture from lots ready for delivery.
- 2. Paving stones will be sampled and tested in accordance with ASTM C-140.

J. Rejection:

1. If the shipment fails to conform to the specified requirements, the manufacturer may sort it, and new test paving stones shall be selected at random by the purchaser from the retained lot and tested at the expense of the manufacturer. If the second set of test paving stones fail to conform to the specified requirements, the entire lot shall be rejected.

A. The bedding course shall be a well graded, clean, washed sand with 100% passing a 3/8" sieve size and a maximum of 3% passing a No. 200 sieve size. The use of mason sand shall not be approved.

B. The bedding course shall be the responsibility of the paving stone installer.


2.3 EDGE RESTRAINT:

A. All edges of the installed paving stones shall be restrained. The type of edge restraint, shall be approved at locations and to details noted on plans.

- 3.1 PREPARATION OF THE BASE COURSE:
- A. A suitable base shall be prepared as specified in Section B.2. of this specification.
- B. The base course shall be shaped to grade and cross section with allowable tolerance of 14".
- 3.2 CONSTRUCTION OF THE BEDDING COURSE:
- bedding course.
- stones have been placed and vibrated.
- paving stone edges.
- D. The bedding course shall not be disturbed, once screeded and leveled to the

A. The paving stones shall be placed as shown on the drawings.

- B. The paving stones shall be placed in such a manner that the desired pattern is maintained and that no intentional space is left between the stones for maximum interlock.
- D. The gaps at the edge of the paving stone surface shall be filled with standard edge stone or with stones cut to fit. Cutting of concrete paving stone shall be accomplished to leave a clean edge to the traffic surface using a double—headed breaker or a masonry saw. Whenever possible, no cut should result with a paving stone less than 1/3 of original dimension.
- E. Paving stones shall be vibrated into the bedding course using a plat vibrator capable of 3000 to 5000 pounds compaction force with the surface clean and the joints open.
- Surplus material shall then be swept from the surface or left on the surface during construction to insure complete filling of joints during initial use.
- Road and Bridge Construction (latest edition) section 710-4.7
- 3. When header curb is used to outline a crosswalk the curb shall be white

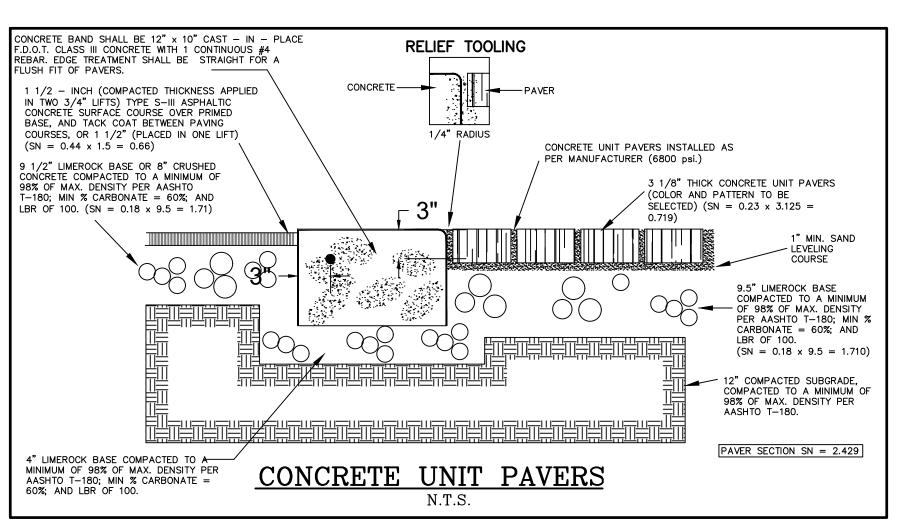

2.2 BEDDING COURSE:

III. CONSTRUCTION METHODS:

A. The finished base course shall be approved before the placement of the

- B. The sand bedding course shall be spread evenly over the area to receive the paving stones and the screeded level to produce a 1" thickness when the paving
- C. The final elevation of paying stones should be nominally $\frac{1}{4}$ to $\frac{3}{8}$ higher than the adjacent curb, gutter, etc., to allow for free drainage from chamfers on
- desired elevation.
- 3.3 INSTALLATION OF PAVING STONES:

- C. String lines should be used to hold all patterns true.

- F. After vibration, clean, sharp sand containing at least 30% of 1/8" particles shall be spread over the paving stone surface, allowed to dry and vibrated into the joints with additional plate vibrator passes and brushing so as to completely fill the
- all work areas by removing all debris, surplus material and equipment from the site. 1. Paver brick shall conform with CITY OF PORT ST. LUCIE Land Development Design Standards Manual with the following exceptions: A) Under II Material 2.1 # A.1, Paving stone thickness shall be 3 1/8" (min.) to 4" (max.) b) Under II Material 2.1 # A.3, The coloring shall be throughout the entire brick with the white and yellow conforming with F.D.O.T. Standard Specifications for

H. Upon completion of work covered in this section, the Contractor shall clean up

- 2. Glass spheres to meet the requirements of sections 971-1 and 971-14 with retroflectivity to be not less than 300 minicandles.
- concrete with glass beads in the white concrete.
- 4. The brick shall be pre-approved per project before installation by the CITY OF PORT ST. LUCIE Traffic Engineering Division.

NOTES:

-ELEVATIONS SHOWN ARE IN NAVD 88 DATUM


-ALL DRAINAGE SYSTEMS SHALL BE PUMPED COMPLETELY DRY AND LAMPED AS A REQUIREMENT OF THE FINAL DRAINAGE INSPECTIONS.


WILSON PARCEI GRADING,


DATE 01/17/2024 DRAWN BY RH

RYAN D. WHEELER PROFESSIONAL ENGINEER LICENSE NO. 7147 STATE OF FLORIDA - FOR THE FIRM -ATEAug 20, 202

JOB #4371-A0° PSLUSD PROJECT NO. 11-681-A CITY OF PSL PROJECT NO. P24-008 OF 15 SHEETS

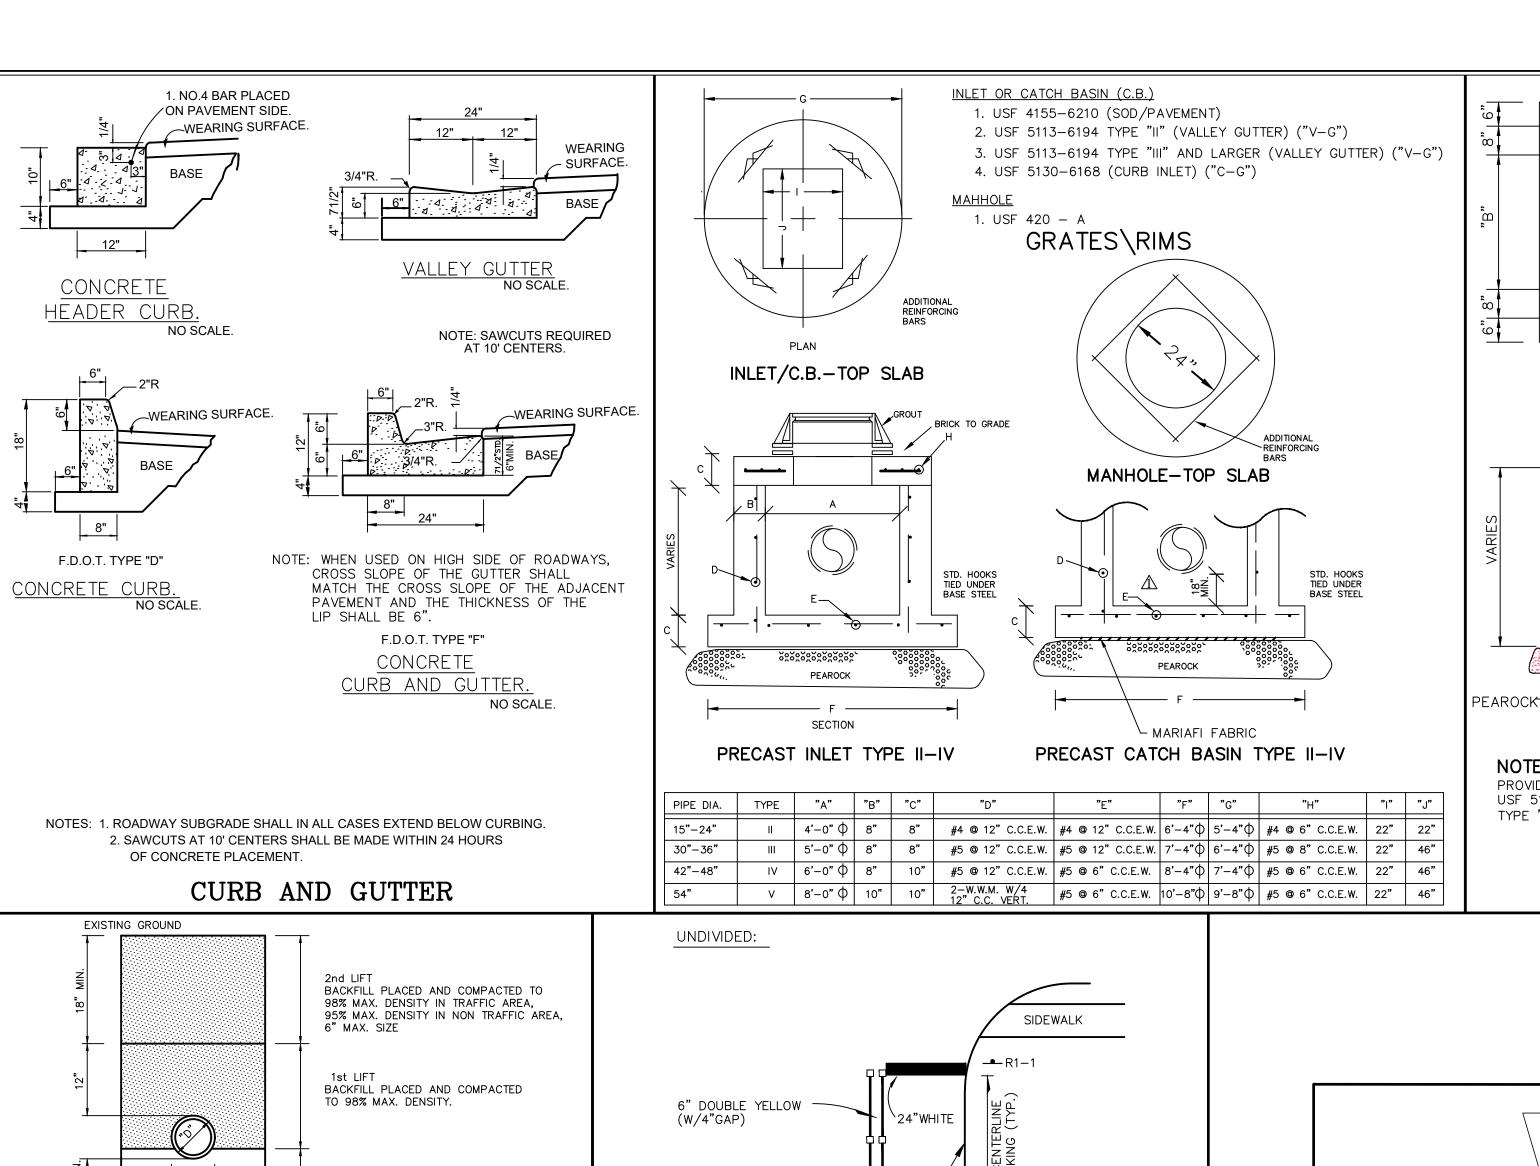


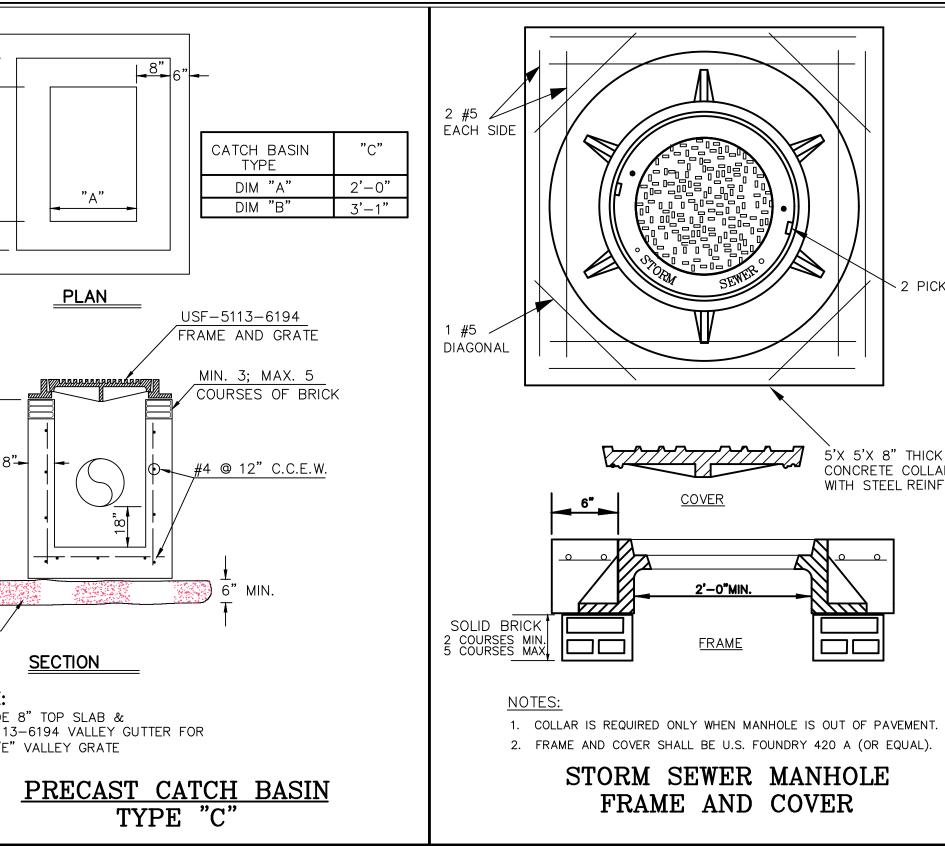

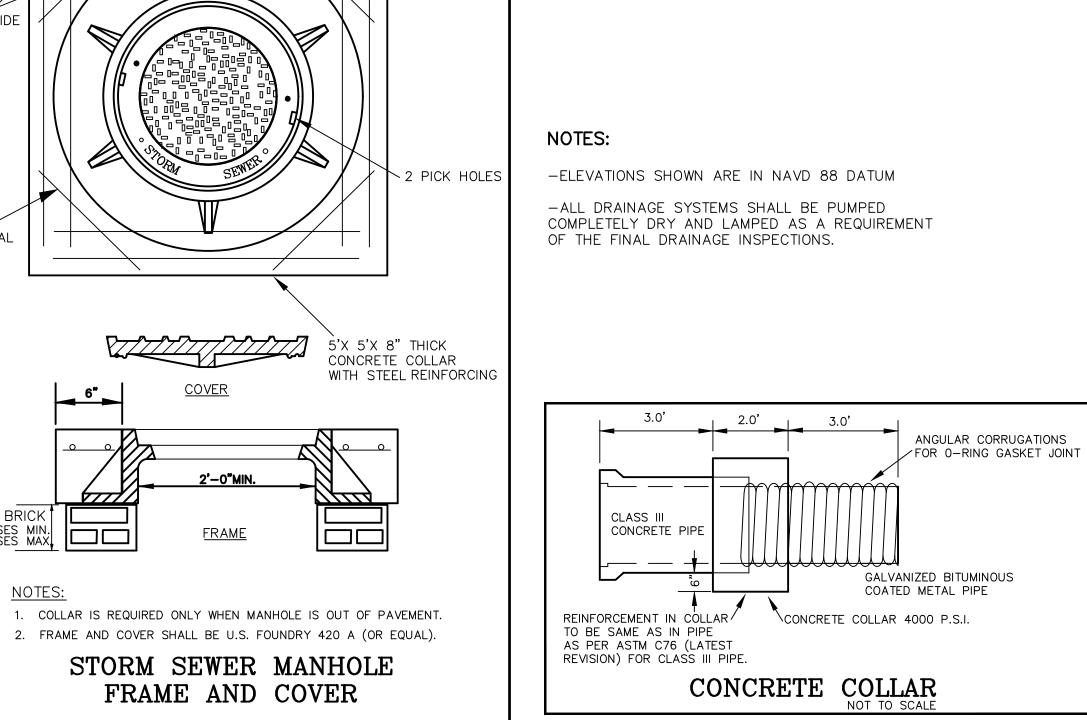

MIN. ROADWAY CROWN EL. = 27.00-FT (10yr-24hr PEAK STAGE = 26.38-FT) MIN. PERIMETER BERM EL. = 27.80-FT (25yr-72hr PEAK STAGE = 27.50-FT) MIN. FINISHED FLOOR EL. = 29.00-FT (100yr-72hr ZD PEAK STAGE = 27.84-FT)

—15" INLINE DRAIN NDS OR APPROVED \ EQUAL * SEE PLAN FOR ---PVC RISER * PIPE SIZES PVC (TYP.) * ─PVC TEE * YARD INLET DETAIL

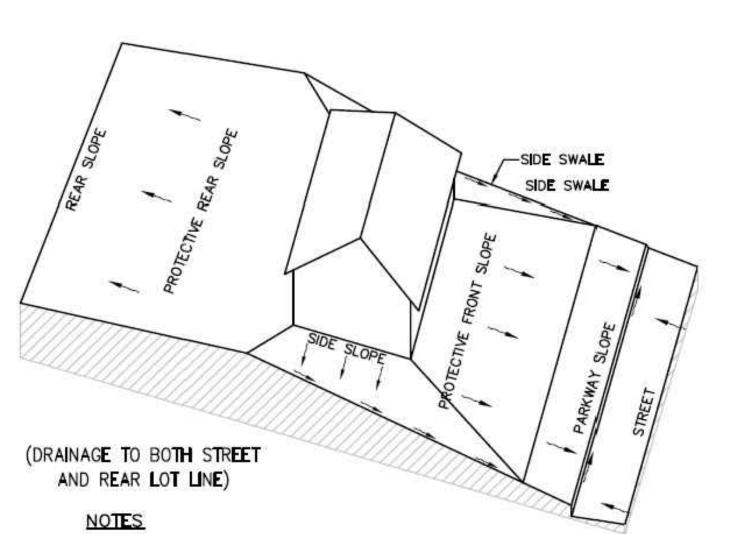

- ALL SLOPES GREATER THAN 6:1 SHALL BE SODDED.
- 2. ROOF RUNOFF FROM SIDES AND REAR OF HOUSES SHALL BE DIRECTED TOWARD SIDE AND REAR YARD SWALES ACCORDINGLY.


TYPE 'B' LOT GRADING DETAIL

DATE 01/17/2024 DRAWN BY RH

RYAN D. WHEELER PROFESSIONAL ENGINEE LICENSE NO. 7147 STATE OF FLORIDA - FOR THE FIRM -ATEAug 20, 202

JOB #4371-A01 OF 15 SHEETS

PSLUSD PROJECT NO. 11-681-A CITY OF PSL PROJECT NO. P24-008

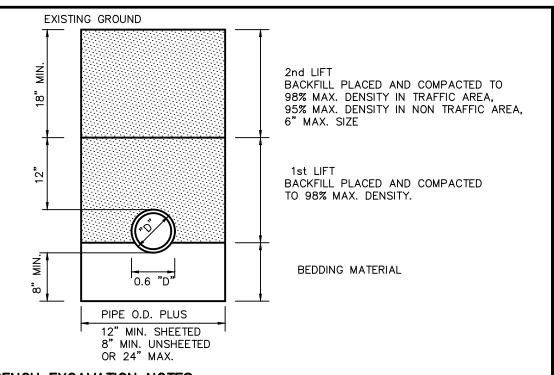

TRENCH EXCAVATION NOTES: 1. PIPE BEDDING

WHEN THE PIPE IS LAID IN THE PREPARED TRENCH, TRUE TO LINE AND GRADE, THE PIPE BARREL SHALL RECEIVE CONTINUOUS UNIFORM SUPPORT. WHERE NECESSARY, COURSE SAND, PEA ROCK OR 3/4-INCH LIMESTONE GRAVEL SHALL BE USED TO PROVIDE UNIFORM BEDDING.

2. BACKFILL MATERIAL

BACKFILL MATERIAL SHALL BE NON-COHESIVE AND NON-PLASTIC SOIL THAT IS FREE OF ALL DEBRIS, LUMPS, CLODS, WOOD, BROKEN PAVING OR ANY ORGANIC OR UNSUITABLE MATERIAL. BACKFILL MATERIAL PLACED WITHIN ONE (1.0) FOOT OF THE PIPE SHALL CONTAIN NO ROCKS OR STONES LARGER THAN TWO (2) INCHES IN DIAMETER. NO ROCKS OR STONES LARGER THAN SIX (6) INCHES IN DIAMETER WILL BE PERMITTED IN THE REMAINING BACKFILL UNLESS OTHERWISE SPECIFIED.

3. BACKFILL COMPACTION


TRENCH BACKFILL SHALL BE COMPACTED TO NOT LESS THAN 98 PERCENT OF THE MAXIMUM DRY DENSITY DETERMINED BY AASHTO T-180. WHERE THE BACKFILL LIES WITHIN THE ROADWAY EMBANKMENT OR SUBGRADE, IT SHALL BE COMPACTED TO DENSITIES SPECIFIED FOR THESE AREAS.

FIELD DENSITY TESTS SHALL BE PERFORMED IN EACH BACKFILL LIFT AND AT A FREQUENCY OF NOT LESS THAN ONE TEST PER 40 CUBIC YARDS OF BACKFILL PLACED, AND A MINIMUM OF ONE TEST LOCATION WITHIN 1.0' OF EACH INLET AND OR MANHOLE

5. WHERE REQUIRED, SHEETING AND SHORING SHALL BE IN ACCORDANCE WITH OSHA REGULATIONS.

6. MUCK OR OTHER SUITABLE MATERIAL BE COMPLETELY REMOVED.


TYPICAL TRENCH EXCAVATION
N.T.S.

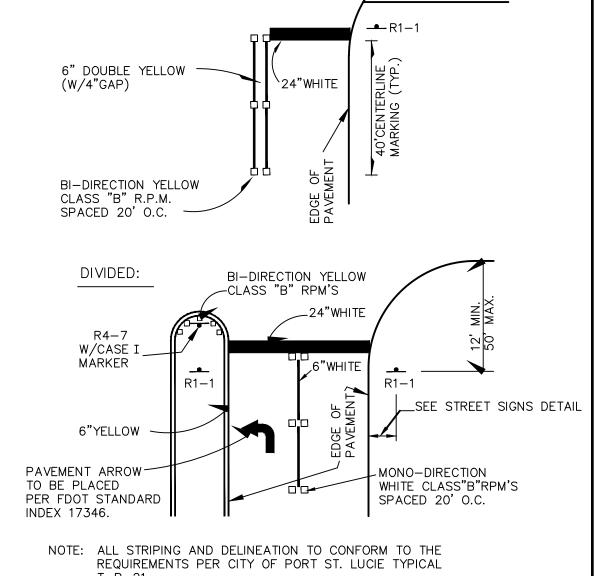

INTERSECTION TRAFFIC CONTROL STOP CONDITION

-12" WIDE x 8" THICK CONC. APRON AROUND INLET

NOTE: PROVIDE 8" TOP SLAB & USF 5113-6194 VALLEY GUTTER FOR TYPE "E" VALLEY GRATE

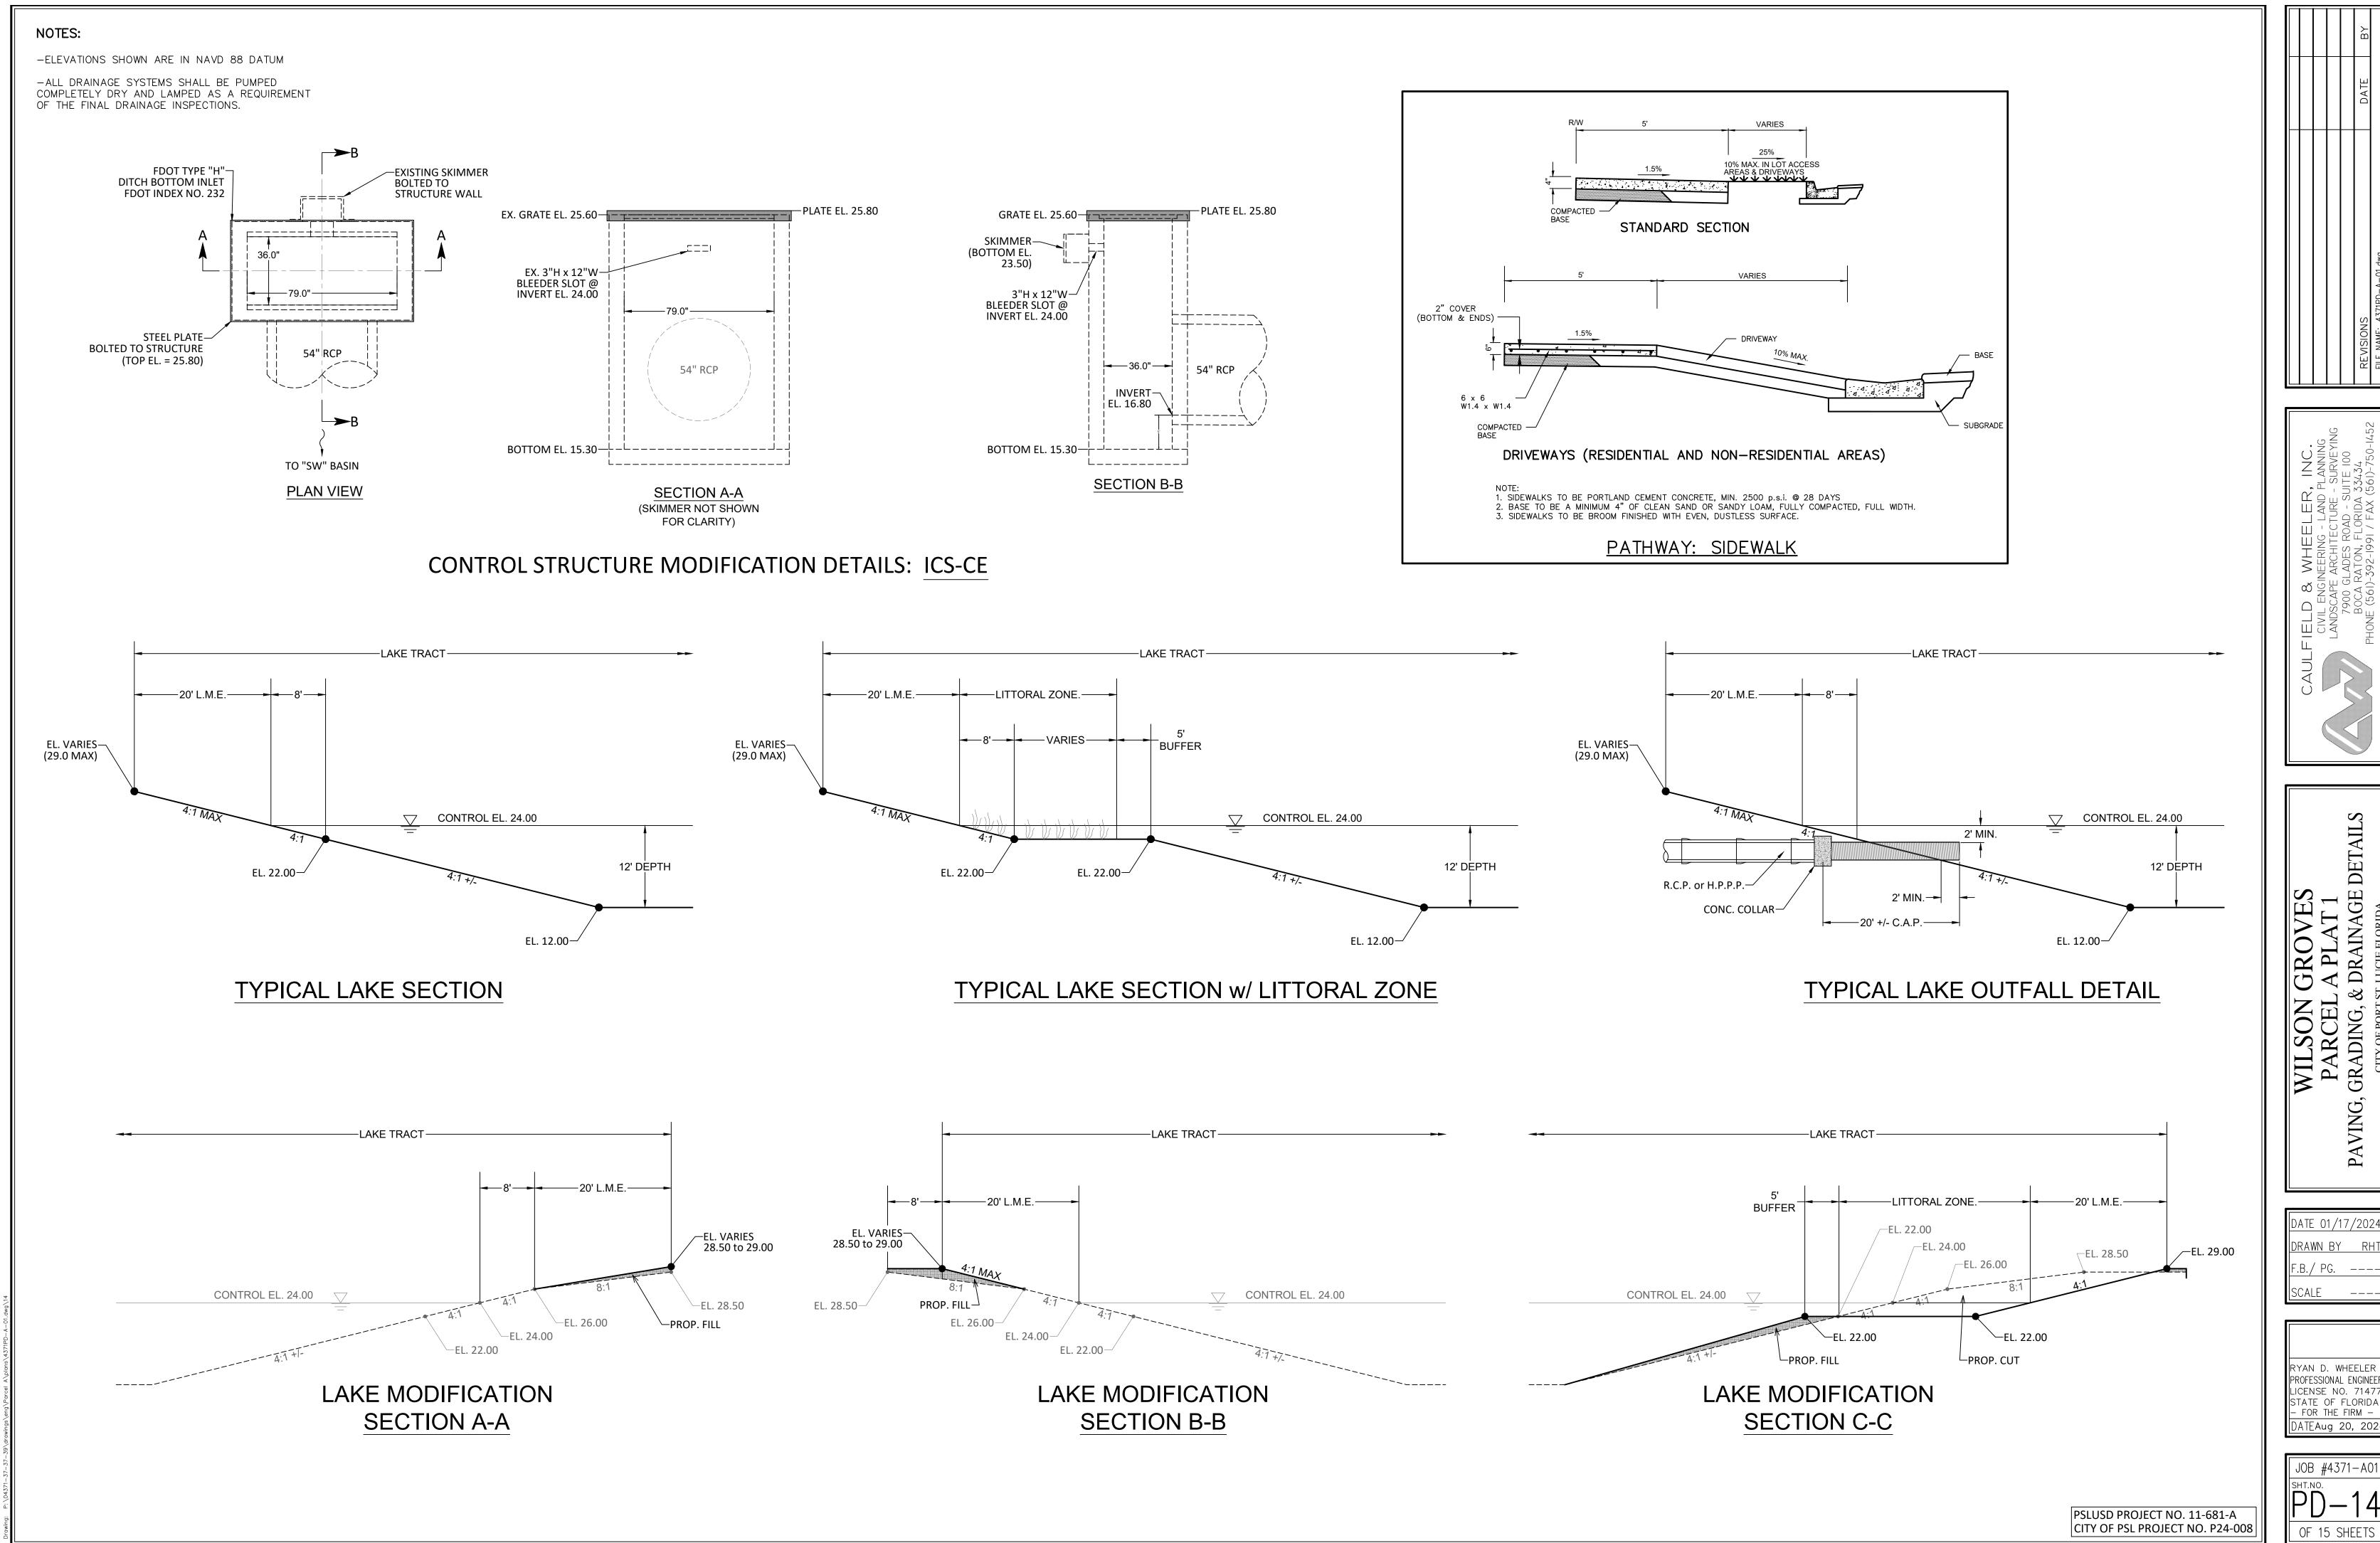

DATE 01/17/2024 DRAWN BY RH F.B./ PG. ----

RYAN D. WHEELER PROFESSIONAL ENGINEER LICENSE NO. 71477 STATE OF FLORIDA — FOR THE FIRM —

JOB #4371-A01 PD-14 OF 15 SHEETS


- 1. CITY CITY OF PORT ST. LUCIE
- 2. CONTRACTOR UTILITY CONTRACTOR AND ALL UTILITY SUBCONTRACTORS
- 3. ENGINEER ENGINEER RESPONSIBLE FOR INSPECTION AND CERTIFICATION


PROCEDURE

- 1. A PRE-CONSTRUCTION MEETING IS TO BE HELD PRIOR TO DELIVERY OF MATERIALS AND INITIATION OF ANY WATER AND SEWER CONSTRUCTION. THE MEETING SHALL BE ATTENDED BY THE CITY, CONTRACTOR, SUBCONTRACTORS, ENGINEER AND OTHER INTERESTED PARTIES.
- 2. ANY REVISIONS TO THE APPROVED PLANS MUST BE APPROVED BY THE CITY PRIOR TO THE PRE-CONSTRUCTION
- 3. A MINIMUM OF THREE (3) COPIES OF THE CURRENT APPROVED PRODUCT LIST AND ALL NECESSARY SHOP DRAWINGS SHALL BE SUBMITTED FOR APPROVAL PRIOR TO SCHEDULING THE PRE-CONSTRUCTION MEETING. ALL PIPE MANUFACTURERS SHALL SUBMIT THREE (3) COPIES OF AN AFFIDAVIT THAT THE PIPE AND COATINGS WERE MANUFACTURED IN ACCORDANCE WITH AWWA C151/A21.51-91.
- 4. ALL APPLICABLE PERMITS MUST BE OBTAINED WITH COPIES PROVIDED TO THE CITY PRIOR TO COMMENCEMENT OF CONSTRUCTION.
- 5. THE CONTRACTOR SHALL MAINTAIN A CURRENT APPROVED SET OF CONSTRUCTION DOCUMENTS ON SITE AT ALL
- 6. ALL MATERIALS SUPPLIED SHALL CONFORM TO PRODUCT LIST AND SHOP DRAWINGS AS APPROVED BY THE CITY PRIOR TO CONSTRUCTION. ALL REQUESTS FOR MATERIAL SUBSTITUTION SHALL BE APPROVED PRIOR TO DELIVERY OF THESE MATERIALS TO THE JOB SITE.
- 7. THE LOCATION OF THE EXISTING UTILITIES AS SHOWN ON THE PLANS ARE APPROXIMATE ONLY. THE EXACT LOCATIONS SHALL BE DETERMINED BY THE CONTRACTOR PRIOR TO CONSTRUCTION. IN ADDITION, THE CONTRACTOR SHALL BE RESPONSIBLE TO VERIFY IF OTHER UTILITIES (NOT SHOWN ON THE PLAN) EXIST WITHIN THE AREA OF CONSTRUCTION. SHOULD THERE BE UTILITY CONFLICTS, THE CONTRACTOR SHALL INFORM THE CITY AND NOTIFY THE RESPECTIVE UTILITY OWNER TO RESOLVE THE UTILITY CONFLICTS AND THE UTILITY ADJUSTMENTS AS
- 8. THE CONTRACTOR SHALL BE RESPONSIBLE AT ALL TIMES THROUGHOUT THE DURATION OF CONSTRUCTION FOR THE PROTECTION OF EXISTING AND NEWLY INSTALLED UTILITIES FROM DAMAGE OR DISRUPTION OF SERVICE. THE CONTRACTOR SHALL BE RESPONSIBLE FOR TAKING SUCH MEASURES AS NECESSARY TO PROTECT THE HEALTH, SAFETY, AND WELFARE OF THOSE PERSONS HAVING ACCESS TO THE WORK SITE.
- 9. THE CONTRACTOR SHALL BE RESPONSIBLE FOR OBTAINING LOCATIONS OF ALL OTHER UTILITY FACILITIES.
- 10. THE CONTRACTOR SHALL SCHEDULE INSPECTIONS AND TESTS WITH THE CITY A MINIMUM OF 24 HOURS IN
- INSPECTOR. CITY UTILITY SYSTEM VALVES AND APPURTENANCES MAY ONLY BE OPERATED BY CITY PERSONNEL.


11. CONTRACTOR SHALL NOT DISTURB EXISTING CITY MAINS OR STRUCTURES WITHOUT THE PRESENCE OF A CITY

- 12. FACILITIES PROPOSED HEREIN SHALL BE CONSTRUCTED IN ACCORDANCE WITH THE APPROVED PLANS. DEVIATIONS FROM THE APPROVED PLANS MUST BE APPROVED IN ADVANCE BY THE CITY.
- 13. UPON COMPLETION OF CONSTRUCTION AND PRIOR TO FINAL ACCEPTANCE OF THE WORK, A FINAL INSPECTION SHALL VERIFY PROPER ADHERENCE TO ALL FACETS OF THE PLANS AND SPECIFICATIONS.
- 14. PAVING, DRAINAGE AND TRAFFIC CONSTRUCTION SHALL CONFORM TO FLORIDA DEPARTMENT OF TRANSPORTATION ROADWAY AND DESIGN STANDARDS, STANDARD SPECIFICATIONS FOR ROAD AND BRIDGE CONSTRUCTION, MANUAL ON UNIFORM TRAFFIC CONTROL DEVICES (MUTCD) AND CITY OF PORT ST. LUCIE TYPICAL No. T-P-18 UNLESS
- 15. AS-BUILT DRAWINGS SHALL BE PREPARED BY A REGISTERED LAND SURVEYOR, REGISTERED IN THE STATE OF FLORIDA, AND SUBMITTED BY THE CONTRACTOR TO THE CITY.
- 16. PRIOR TO COMMENCEMENT OF ANY EXCAVATION, THE CONTRACTOR SHALL COMPLY WITH FLORIDA STATUTE 553-851 FOR PROTECTION OF UNDERGROUND GAS PIPE LINES.
- 17. CONTRACTOR SHALL NOTIFY SUNSHINE STATE ONE (1-800-432-4770) 48 HOURS IN ADVANCE OF CONSTRUCTION.
- 18. GRADES SHOWN ON PLANS ARE FINISHED GRADES. THE CONTRACTOR SHALL BE REQUIRED TO ADJUST EXISTING SANITARY SEWER MANHOLE TOPS AND VALVE BOX COVERS TO FINISHED GRADE.
- 19. CONTRACTOR SHALL MAINTAIN LOCAL TRAFFIC AT ALL TIMES DURING CONSTRUCTION AND SHALL BE REQUIRED TO PROVIDE ALL BARRICADES, LIGHTING, SIGNAGE AND FLAGMEN AS NECESSARY TO PROVIDE FOR THE SAFETY OF THE PUBLIC IN THE WORK AREA. THE CONTRACTOR SHALL SUBMIT A DETAILED TRAFFIC MAINTENANCE PLAN PRIOR TO CONSTRUCTION.
- 20. EXISTING BASE MATERIAL THAT IS REMOVED DURING CONSTRUCTION SHALL NOT BE USED IN THE CONSTRUCTION OF NEW LIMEROCK BASE.
- 21. ALL VEGETATION, DEBRIS, CONCRETE OR OTHER UNSUITABLE MATERIAL SHALL BE LEGALLY DISPOSED OF OFF-SITE
- 22. CONTRACTOR SHALL UTILIZE CONSTRUCTION METHODS AND DEVICES, SUCH AS TURBIDITY SCREENS, CURTAINS AND FLOATING SILT BARRIERS WHERE NECESSARY IN ORDER TO COMPLY WITH ALL STATE AND LOCAL WATER QUALITY
- 23. ALL REINFORCED CONCRETE STORM SEWER PIPE SHALL BE CLASS III, UNLESS OTHERWISE NOTED.
- 24. ALL PAVED SURFACES SHALL BE PROPERLY MARKED PRIOR TO HOURS OF DARKNESS. PERMANENT PAVEMENT MARKING STALLS SHALL BE LAID OUT USING MARKING CHALK. LAYOUT TO BE REVIEWED BY THE CITY PRIOR TO PLACEMENT OF FINAL MARKING.
- 25. EMBANKMENT (FILL) AND EXCESS MATERIAL REQUIRED FOR ROADWAY RECONSTRUCTION AND UTILITY INSTALLATIONS SHALL BE SUPPLIED AND/OR DISPOSED OF BY THE CONTRACTOR. ALL COSTS ASSOCIATED WITH EARTHWORK REQUIREMENTS TO COMPLETE THE ROADWAY RECONSTRUCTION AND UTILITY IMPROVEMENTS SHALL BE INCLUDED IN THE COSTS OF OTHER APPROPRIATE PAY ITEMS.
- 26. CONTINUITY OF WATER AND SEWER SERVICE TO CITY UTILITY CUSTOMERS SHALL BE MAINTAINED THROUGHOUT THE DURATION OF THIS PROJECT. IF A BREAK IN SERVICE IS UNAVOIDABLE TO ACCOMMODATE CONNECTION OF NEW FACILITIES, IT SHALL BE SCHEDULED FOR OFF PEAK HOURS WITH THE CITY. DETERMINATION OF SERVICE BREAK REQUIREMENT WILL BE MADE BY THE CITY.
- 27. SITE INFORMATION BASED ON A SURVEY PREPARED BY: CAULFIELD & WHEELER, INC.
- 28. RELOCATION OF UTILITY POLES AND GAS PIPE LINES SHALL BE COORDINATED BY THE CONTRACTOR WITH FLORIDA POWER AND LIGHT, AND FLORIDA PUBLIC UTILITIES, RESPECTIVELY. EACH UTILITY HAS BEEN NOTIFIED THAT THEY WILL BE REQUIRED TO RELOCATE THEIR UTILITIES.

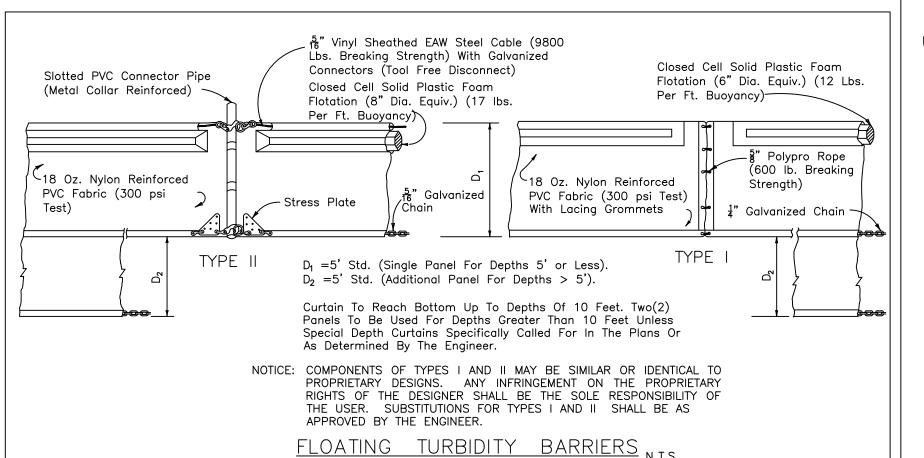

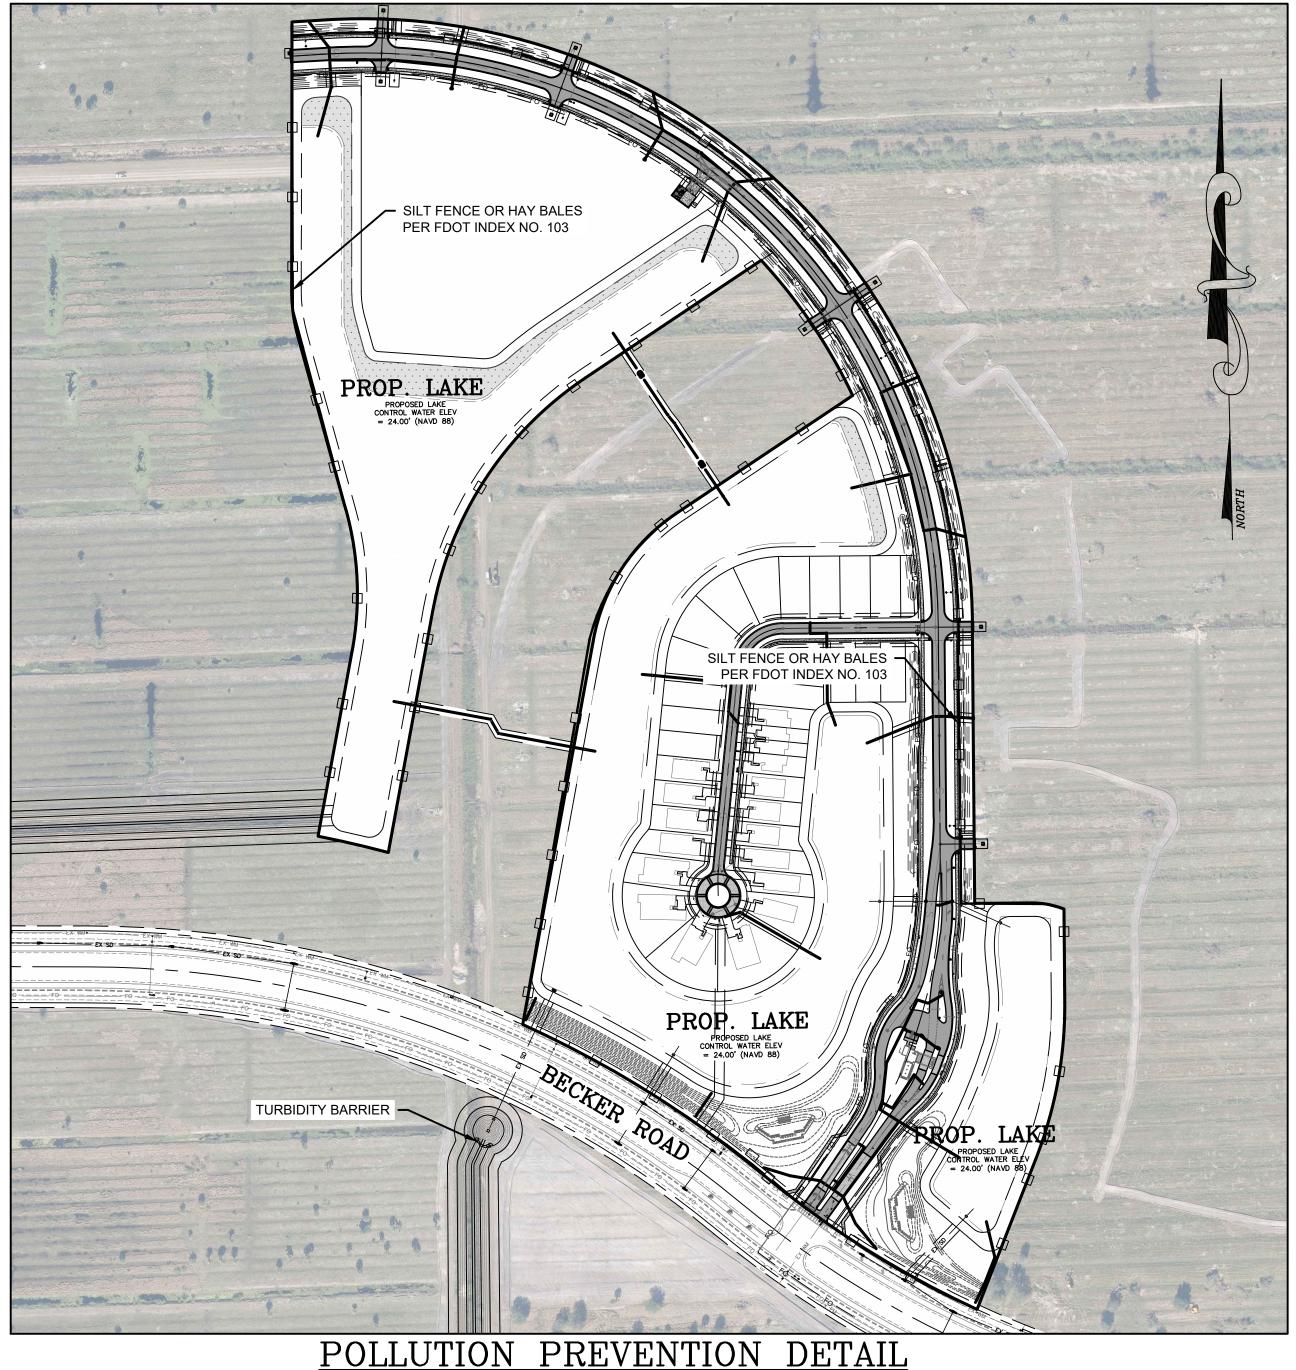

FENCE POST -

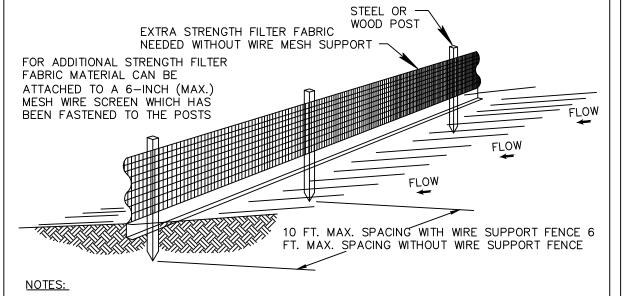


- 1. THE HEIGHT OF A SILT FENCE SHALL NOT EXCEED 36 INCHES (90 CM).
- 2. THE FILTER FABRIC SHALL BE PURCHASED IN A CONTINUOUS ROLL CUT TO THE LENGTH OF THE BARRIER TO AVOID THE USE OF JOINTS.
- POSTS SHALL BE SPACED A MAXIMUM OF 10 FEET (3 M) APART AT THE BARRIER LOCATION AND DRIVEN SECURELY INTO THE GROUND A MINIMUM OF 12 INCHES (30 CM). WHEN EXTRA STRENGTH FABRIC IS USED WITHOUT THE WIRE SUPPORT FENCE, POST SPACING SHALL NOT EXCEED 6 FEET (1.8 M).
- 4. A TRENCH SHALL BE EXCAVATED APPROXIMATELY 4 INCHES (10 CM) WIDE AND 4 INCHES (10 CM) DEEP ALONG THE LINE OF POSTS AND UPSLOPE FROM THE BARRIER.
- WHEN STANDARD STRENGTH FILTER FABRIC IS USED, A WIRE MESH SUPPORT FENCE SHALL BE FASTENED SECURELY TO THE UPSLOPE SIDE OF THE POSTS USING HEAVY DUTY WIRE STAPLES AT LEAST 1 INCH (25 MM) LONG, TIE WIRES, OR HOG RINGS. THE WIRE SHALL EXTEND INTO THE TRENCH A MINIMUM OF 2 INCHES (5 CM) AND SHALL NOT EXTEND MORE THAN 36 INCHES (90 CM) ABOVE THE ORIGINAL GROUND SURFACE.


6. THE STANDARD STRENGTH FILTER FABRIC SHALL BE STAPLED OR WIRED TO THE FENCE,

AND 8 INCHES (20 CM) OF THE FABRIC SHALL BE EXTENDED INTO THE TRENCH. THE

- FABRIC SHALL NOT EXTEND MORE THAN 36 INCHES (90 CM) ABOVE THE ORIGIONAL GROUND SURFACE. 7. THE TRENCH SHALL BE BACKFILLED AND THE SOIL COMPACTED OVER THE FILTER FABRIC.
 - SILT FENCE INSTALLATION DETAIL D 9.1a (Sheet 1 of 2)

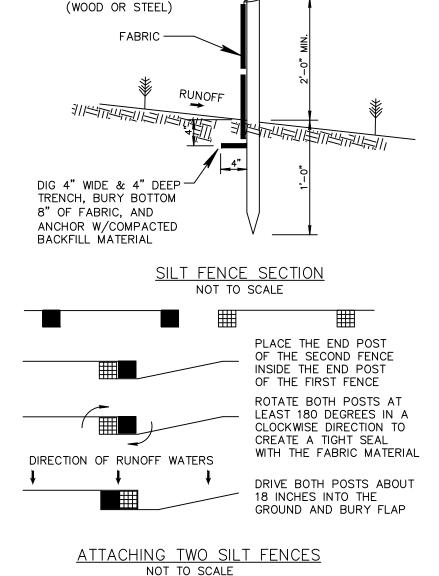

SILT FENCE INSTALLATION DETAIL D 9.1b N.T.S. (Sheet 2 of 2)

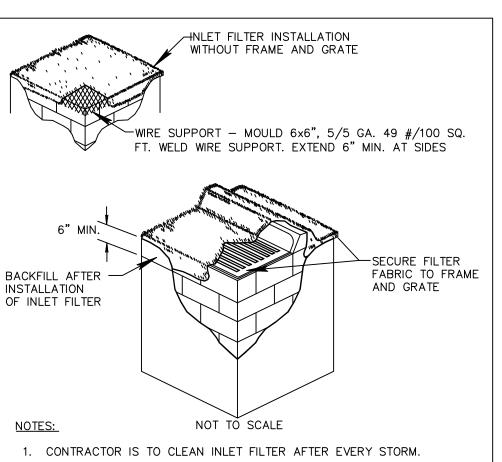

2. CONTRACTOR TO REMOVE FABRIC JUST PRIOR TO PAVING.

3. A SEDIMENT TRAP WILL BE EXCAVATED BEHIND THE CURB AT THE INLET. THE BASIN SHALL BE AT LEAST 12 TO 14 INCHES IN DEPTH, APPROXIMATELY 36 INCHES IN WIDTH, AND APPROXIMATELY TO 10 FEET IN LENGTH PARALLEL TO THE CURB. STORM WATER WILL REACH THE SEDIMENT TRAP VIA CURB CUTS ADJACENT TO EACH SIDE OF THE INLET STRUCTURE. THESE OPENINGS SHALL BE AT LEAST 12 INCHES IN LENGTH. STORM WATER MAY ALSO REACH THE BASIN VIA OVERLAND FLOW LAND AREA BEHIND THE CURB. THE CURB CUTS SHALL BE REPAIRED WHEN THE SEDIMENT TRAP IS REMOVED.

INLET FILTER DETAIL

LEGEND

BOUNDARY OF POLLUTION PREVENTION (SLIT FENCE OR HAY BALES PER F..D.O.T. INDEX 103)

FLOATING TURBIDITY BARRIERS PER F.D.O.T. INDEX 103

DWELLING UNITS CONSTRUCTION SIDEWALKS REQUIRED WITH //////// ROADWAY CONSTRUCTION

SIDEWALKS REQUIRED WITH

REQUIRED IN FRONT OF ALL COMMON AREAS TO PROVIDE CONTINUITY. THE CITY ENGINEER'S APPROVAL

NOTE: IN ALL CASES, SIDEWALKS ARE

MUST BE OBTAINED PRIOR TO ANY CONSTRUCTION OR INSTALLATION OF BERMS, PLANTINGS, TREES, LANDSCAPING, STREET LIGHTING, OR ANY OTHER ABOVE-GROUND STRUCTURES WITHIN THE DEDICATED RIGHT(S) OF WAY OR RECORDED DRAINAGE EASEMENTS.

ALL ELEVATIONS ARE IN "NORTH AMERICA VERTICAL DATUM 1988 (NAVD 88)

> PSLUSD PROJECT NO. 11-681-A CITY OF PSL PROJECT NO. P24-008

> > N.T.S.

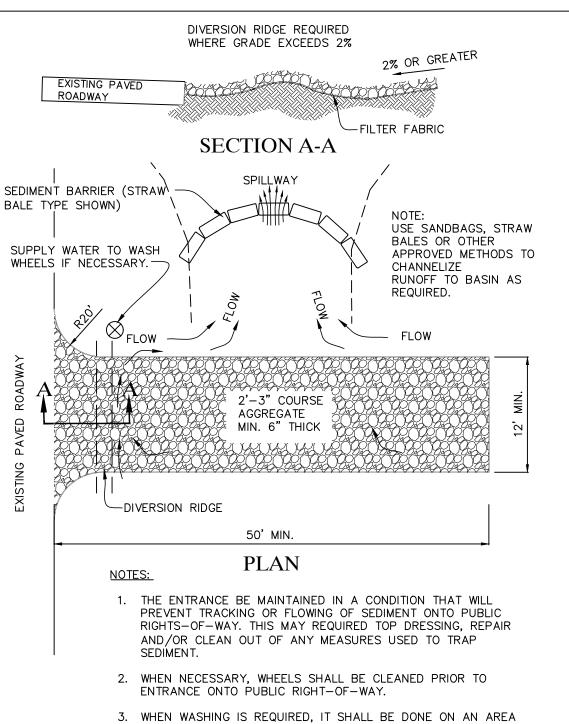


PLATE 4.03a

SOURCE: EROSION DRAW

STABILIZED WITH CRUSHED STONE THAT DRAINS INTO AN APPROVED SEDIMENT TRAP OR SEDIMENT BASIN. TEMPORARY GRAVEL CONSTRUCTION ENTRANCE

RYAN D. WHEELER PROFESSIONAL ENGINEE LICENSE NO. 7147 STATE OF FLORIDA - FOR THE FIRM -ATEAug 20, 202

ATE 01/17/202

DRAWN BY RH

F.B./ PG. ---

CALE AS SHOWN

WILSO PARCI