
# CIVIL CONSTRUCTION PLANS & SPECIFICATIONS

SECTION 21, TOWNSHIP 37 S, RANGE 39 E CITY OF PORT ST. LUCIE, FLORIDA

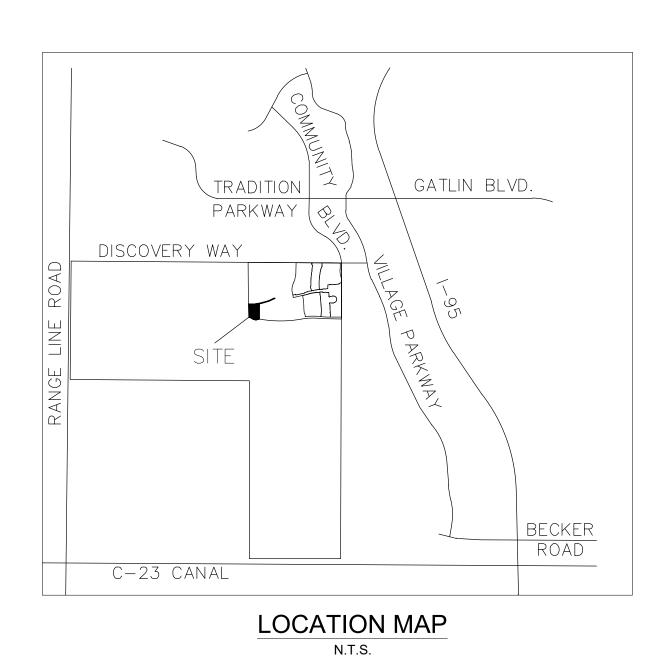



VICINITY \ AERIAL MAP

#### LEGAL DESCRIPTION

BEING A PARCEL OF LAND LYING WITHIN SECTION 21, TOWNSHIP 37 SOUTH, RANGE 39 EAST AND ALL OF TRACT "R4", RIVERLAND PARCEL A - PLAT NINE, AS RECORDED IN PLAT BOOK 80, PAGES 13 THROUGH 29, AND ALL OF RIVERLAND PARCEL A - PLAT THIRTEEN, AS RECORDED IN PLAT BOOK 85, PAGES 24 THROUGH 26, ALL OF THE PUBLIC RECORDS OF ST. LUCIE COUNTY, FLORIDA, ALL LYING WITHIN SECTION 21, TOWNSHIP 37 SOUTH, RANGE 39 EAST, ST. LUCIE COUNTY, FLORIDA, BEING MORE PARTICULARLY DESCRIBED AS FOLLOWS:

BEGIN AT THE NORTHWEST CORNER OF SAID TRACT "R4"; THENCE NORTH 89°31'18" EAST, ALONG THE NORTH LINE OF SAID TRACT "R4", A DISTANCE OF 50.00 FEET TO THE POINT OF NON-TANGENT INTERSECTION ON A CURVE, CONCAVE NORTHERLY, HAVING A RADIAL BEARING OF NORTH 00°31'24" EAST, A RADIUS OF 3356.00 FEET AND A CENTRAL ANGLE OF 11°20'38"; THENCE EASTERLY, ALONG SAID NORTH LINE AND ALONG THE ARC OF SAID CURVE TO THE LEFT, A DISTANCE OF 664.45 FEET TO THE POINT OF INTERSECTION WITH A NON-RADIAL LINE THENCE SOUTH 00°59'00" WEST, ALONG THE EAST LINE OF SAID TRACT "R4", A DISTANCE OF 975.81 FEET TO THE POINT OF NON-RADIAL INTERSECTION WITH A CURVE, CONCAVE NORTHERLY, HAVING A RADIAL BEARING OF NORTH 09°51'46" EAST, A RADIUS OF 6960.00 FEET ALONG THE ARC OF SAID CURVE TO THE LEFT, A DISTANCE OF 2075.99 FEET TO THE POINT OF INTERSECTION WITH A RADIAL LINE; THENCE SOUTH 07°13'37" EAST, ALONG THE EAST LINE OF SAID RIVERLAND PARCEL A - PLAT THIRTEEN, A DISTANCE OF 120.00 FEET TO THE POINT OF RADIAL INTERSECTION WITH A CURVE, CONCAVE NORTHERLY, HAVING A RADIUS OF 7080.00 FEET AND A CENTRAL ANGLE OF 16°56'03" THENCE WESTERLY, ALONG THE SOUTH LINE OF SAID RIVERLAND PARCEL A - PLAT THIRTEEN AND ALONG THE ARC OF SAID CURVE TO THE RIGHT, A DISTANCE OF 2092.53 FEET TO THE POINT OF NON-TANGENT INTERSECTION WITH A CURVE, CONCAVE SOUTHERLY, HAVING A RADIAL BEARING OF SOUTH 03°06'54" EAST, A RADIUS OF 425.00 FEET AND A CENTRAL ANGLE OF 12°00'58"; THENCE WESTERLY, ALONG THE ARC OF SAID CURVE TO THE LEFT, A DISTANCE OF 89.13 FEET TO A POINT OF REVERSE CURVATURE OF A CURVE, CONCAVE NORTHERLY HAVING A RADIUS OF 501.00 FEET AND A CENTRAL ANGLE OF 55°24'05"; THENCE WESTERLY, ALONG THE ARC OF SAID CURVE TO THE RIGHT A DISTANCE OF 484.44 FEET TO A POINT OF REVERSE CURVATURE OF A CURVE, CONCAVE SOUTHERLY, HAVING A RADIUS OF 160.00 FEET AND A CENTRAL ANGLE OF 40°44'55"; THENCE WESTERLY, ALONG THE ARC OF SAID CURVE TO THE LEFT, A DISTANCE OF 113.79 FEET TO A POINT OF TANGENCY; THENCE SOUTH 89°31'18" WEST, A DISTANCE OF 37.52 FEET; THENCE NORTH 00°28'42" WEST, ALONG THE EAST RIGHT-OF-WAY LINE OF N/S B, AS RECORDED IN OFFICIAL RECORDS BOOK 3902, PAGE 490, SAID PUBLIC RECORDS AND THE WEST LINE OF SAID TRACT "R4". A DISTANCE OF 912.39 FEET TO THE POINT OF BEGINNING.

PLAN FOR RIVERLAND ASSOCIATES I LLLP

# **ENGINEER & SURVEYOR**



ENGINEERING & SURVEYING, LLC.

1449 NW COMMERCE CENTRE DR PORT ST. LUCIE, FL 34986 PHONE: (772) 879-0477

ENGINEER'S PROJECT NO. 22-1037

## INDEX OF DRAWINGS

SHEET NO.	DESCRIPTION
01	COVER SHEET
02	OVERALL SITE PLAN
03 - 04	SITE PLAN
05 - 06	PAVING, GRADING & DRAINAGE PLANS
07	PAVING, GRADING & DRAINAGE DETAILS
08 - 09	WATER AND SEWER PLANS
10 - 11	WATER AND SEWER DETAILS
12	CLEARING AND SEDIMENT & EROSION CONTROL PLAN
13	STORMWATER POLLUTION PREVENTION PLAN

## NOTE:

#### PSLUSD STANDARDS AND DETAILS EFFECTIVE 2019

**GOVERNING DESIGN STANDARDS:** 

FLORIDA DEPARTMENT OF TRANSPORTATION, FY2023-24 STANDARDS PLANS FOR ROAD AND BRIDGE CONSTRUCTION AND APPLICABLE INTERIM REVISIONS (IRS).

STANDARD PLANS FOR ROAD CONSTRUCTION AND ASSOCIATED IRS ARE AVAILABLE AT THE FOLLOWING WEBSITE:

http://www.fdot.gov/design/standardplans

#### APPLICABLE IRS:

**GOVERNING STANDARD SPECIFICATIONS:** 

FLORIDA DEPARTMENT OF TRANSPORTATION, 2023-24 STANDARD SPECIFICATIONS FOR ROAD AND BRIDGE CONSTRUCTION AT THE FOLLOWING WEBSITE: http://www.dot.state.fl.us/programmanagement/Implemented/SpecBooks

#### **GOVERNING SPECIFICATIONS:**

CITY OF PORT ST. LUCIE PUBLIC WORKS DEPARTMENT ENGINEERING STANDARDS FOR LAND DEVELOPMENT (MOST CURRENT EDITION), AS AMENDED BY CONTRACT DOCUMENTS.

**ALWAYS CALL 81** 

CHECKED BY:

**COVER SHEET** 

SHEET NUMBER:

CITY OF PSL PROJECT NO. P20-068-A PSLUSD FILE NO. 5203I-4


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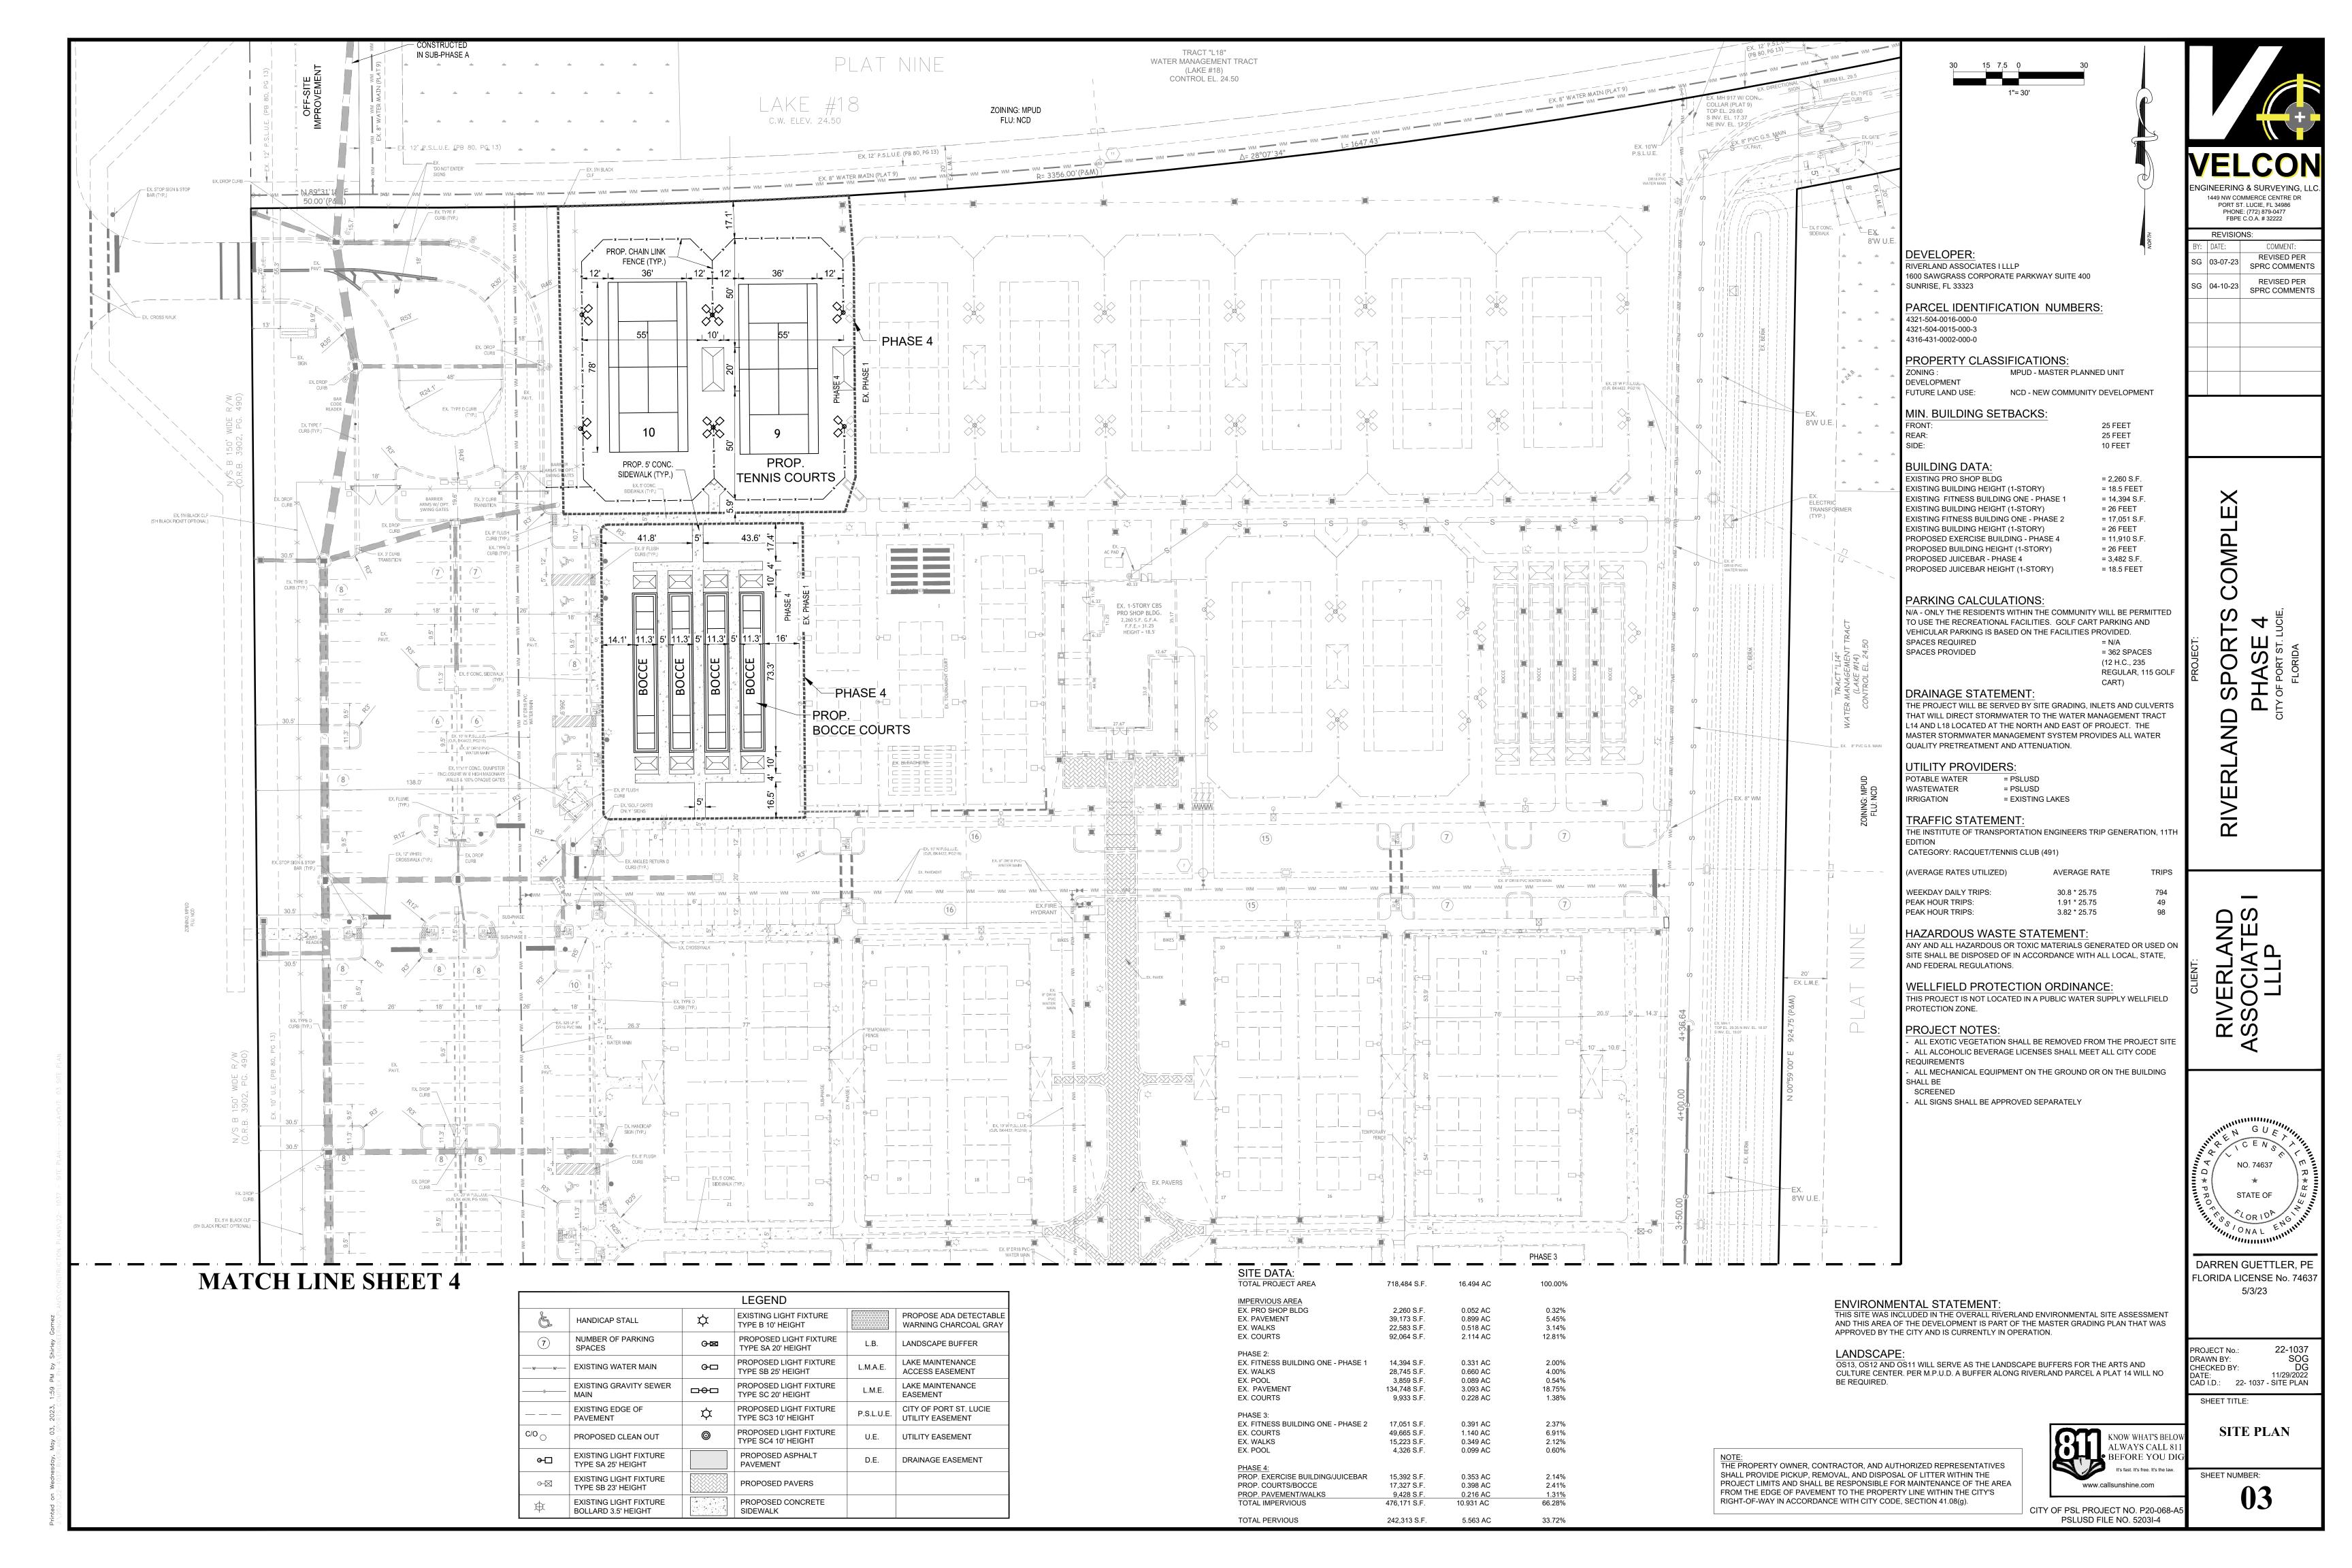
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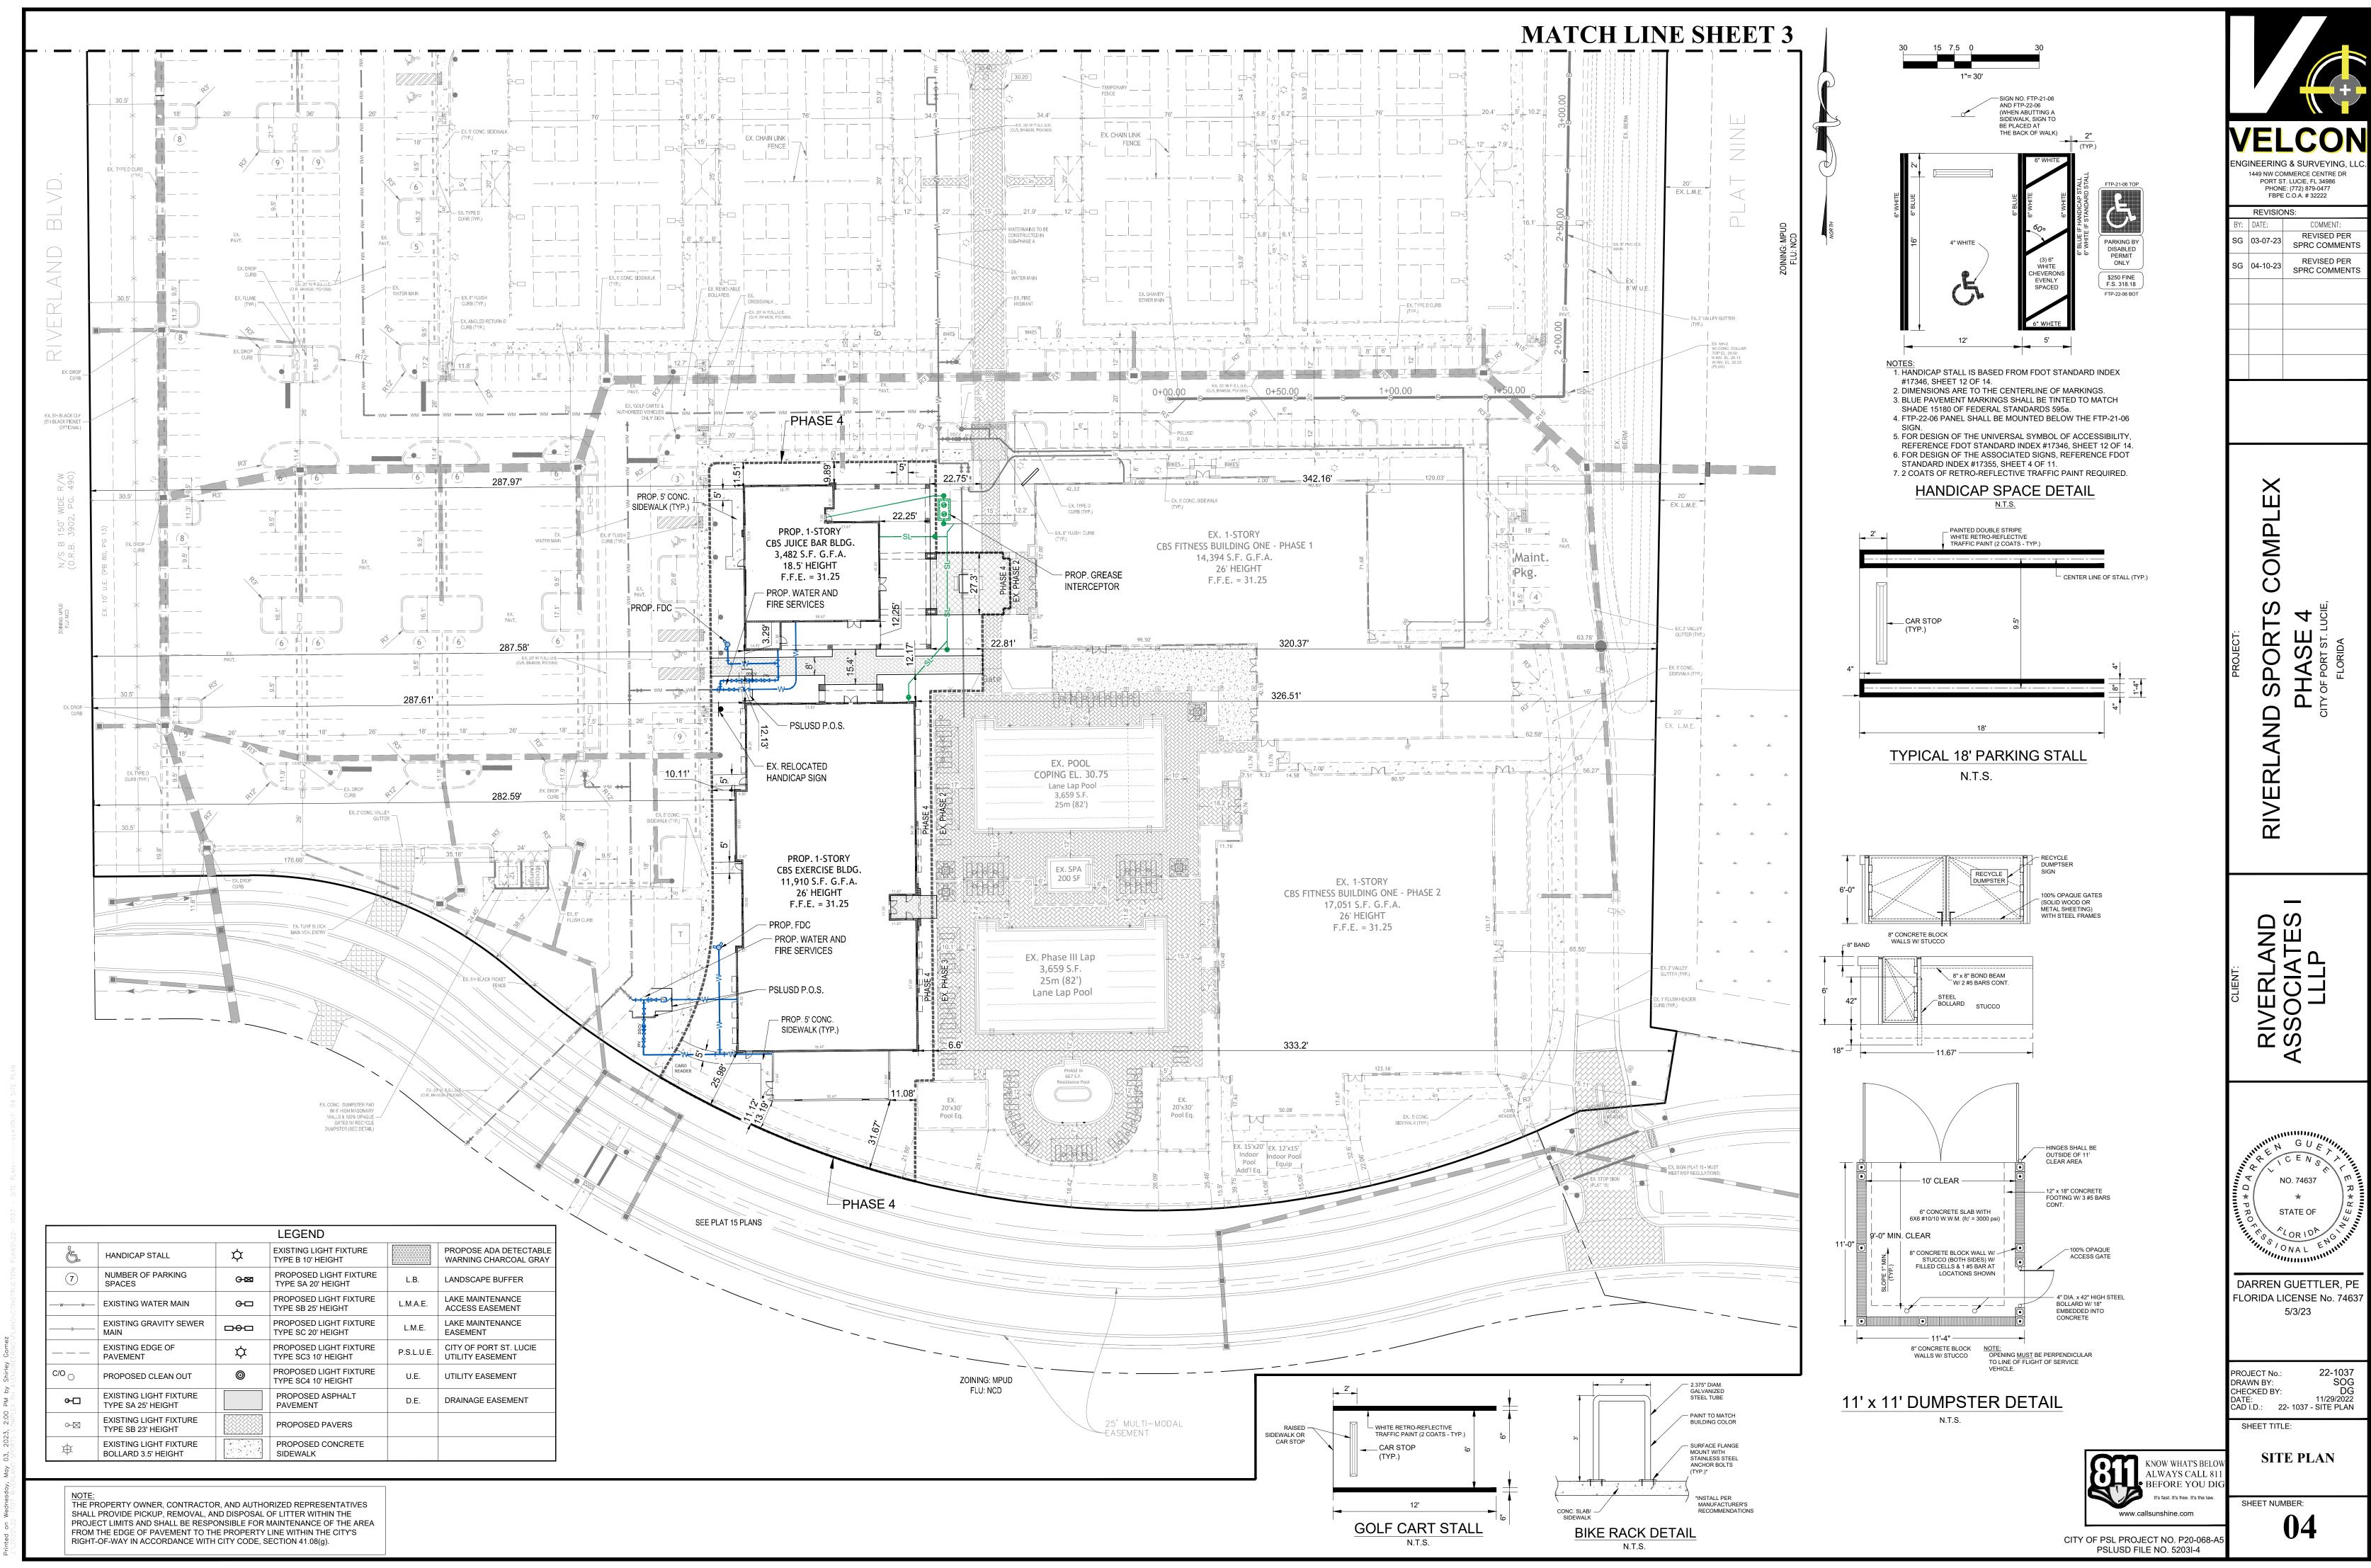
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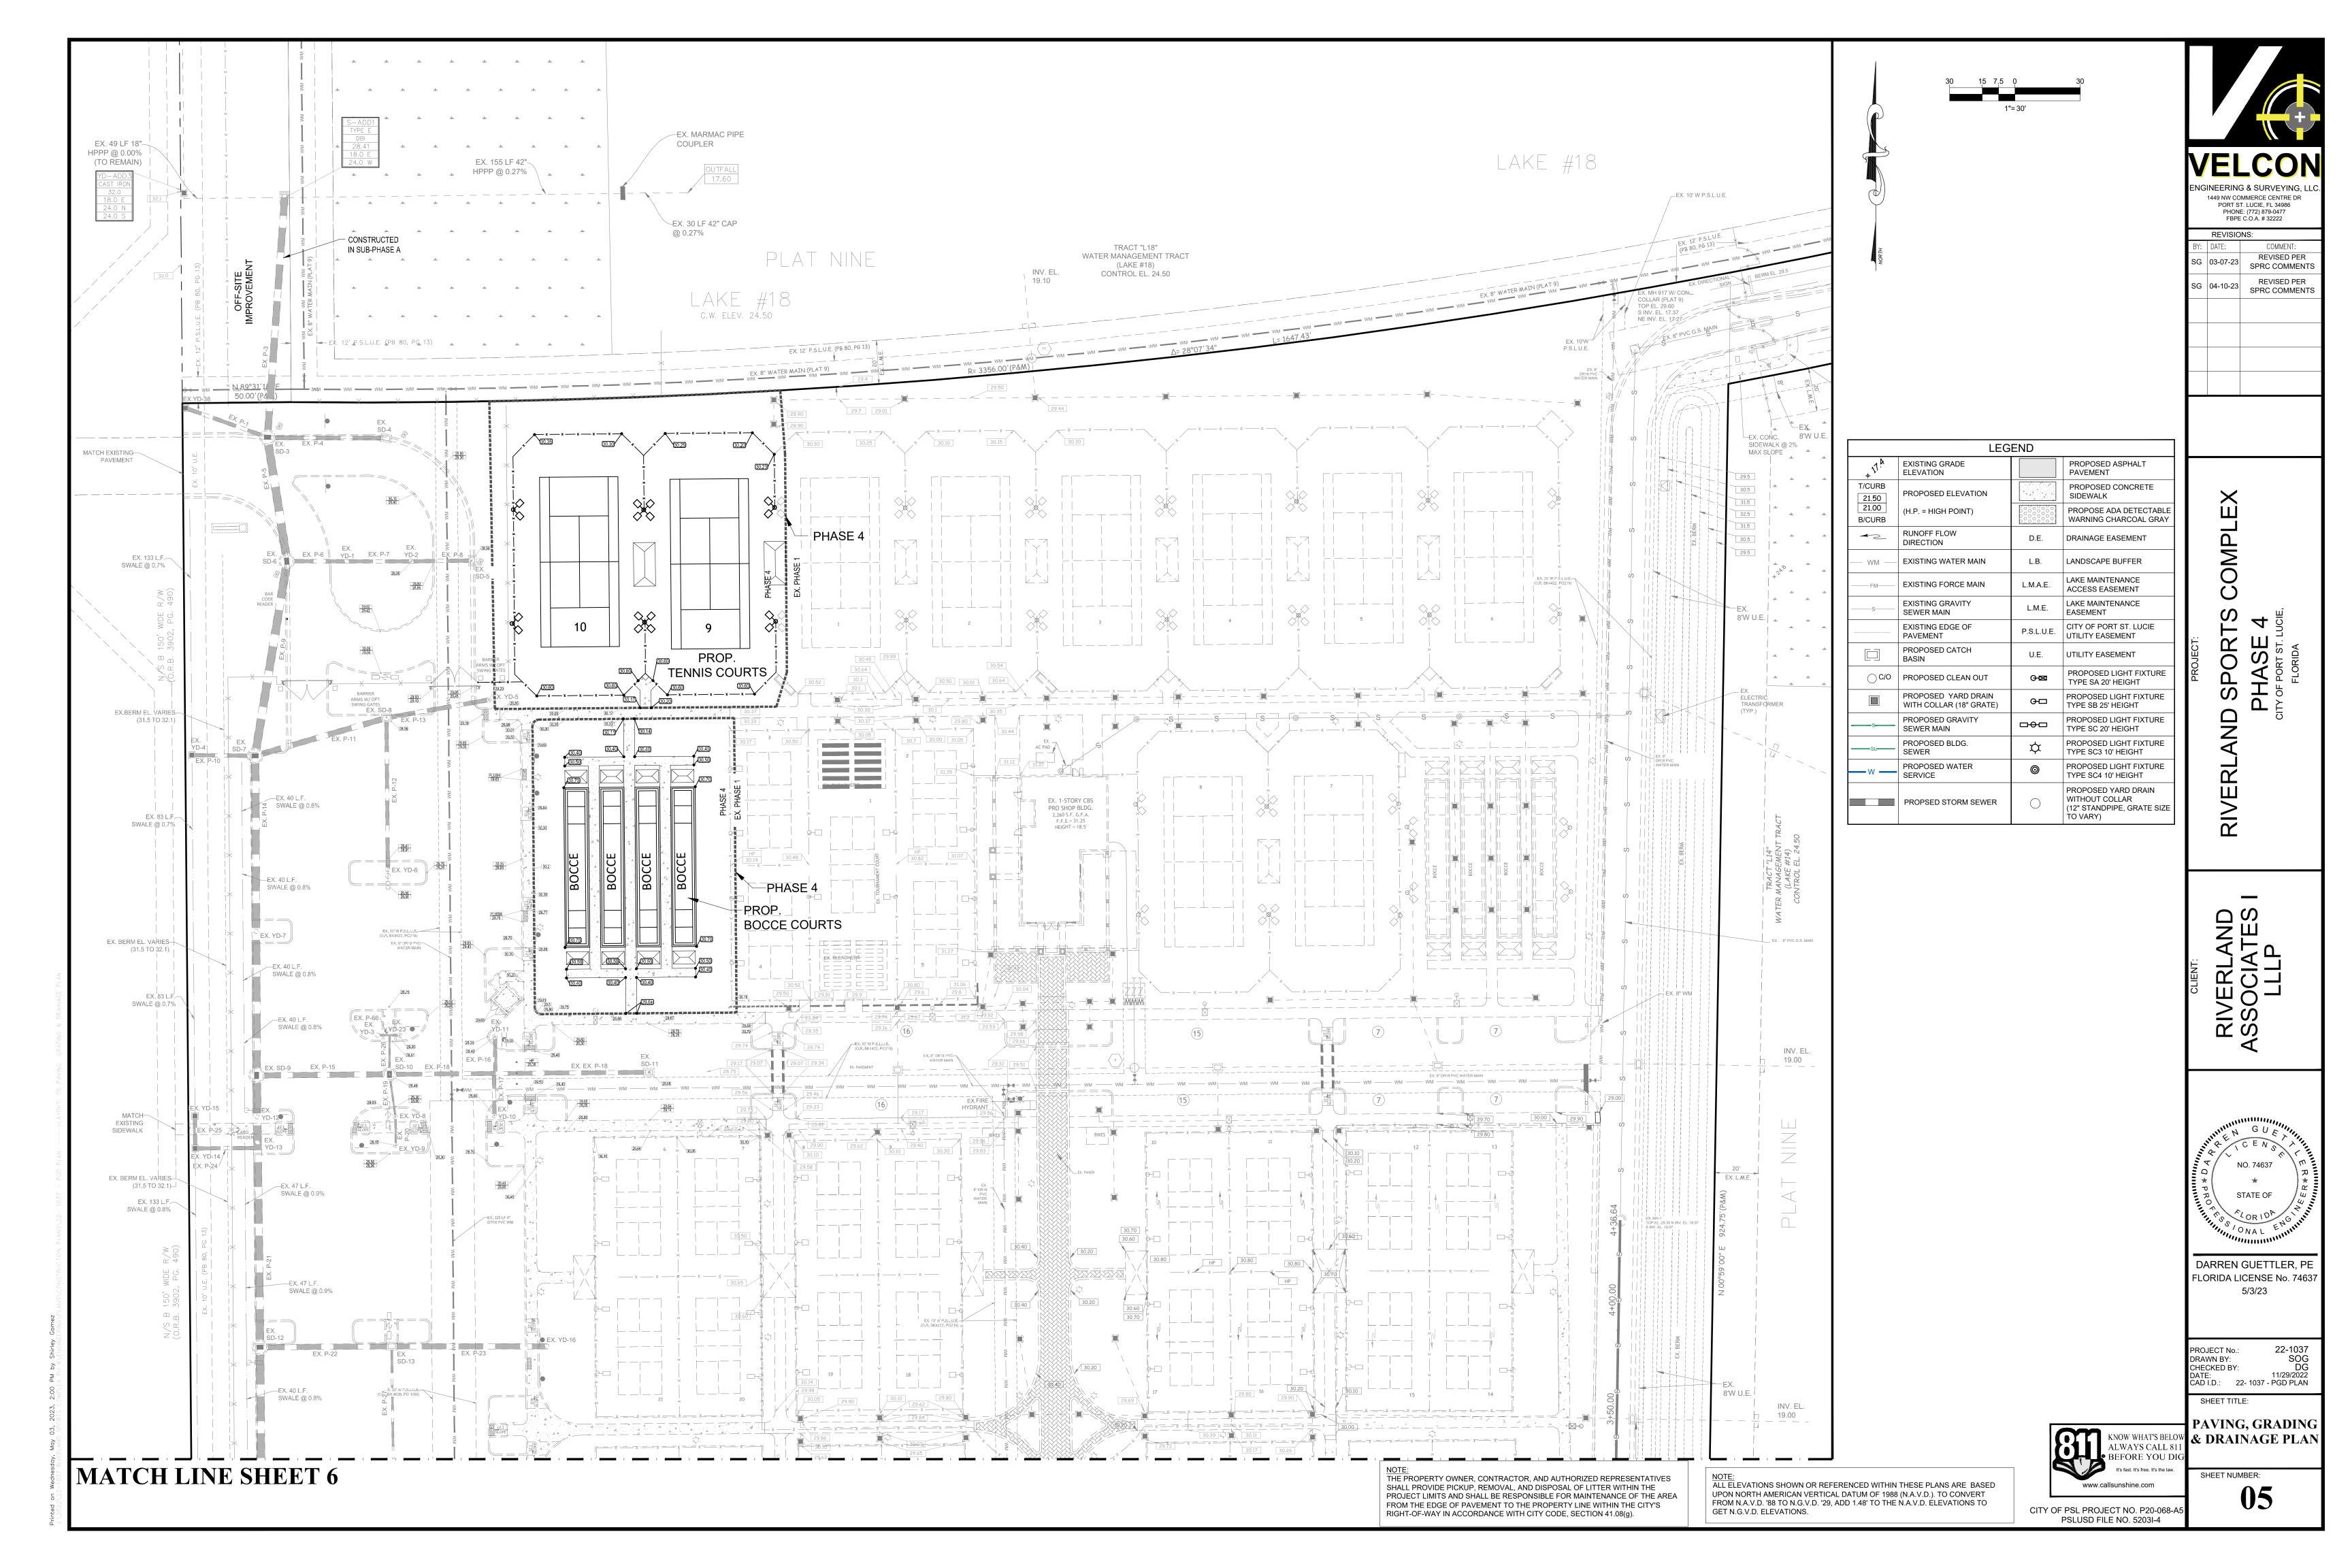
FLORIDA LICENSE No. 74637


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TO VARY)

- 1. THE CONTRACTOR SHALL BE RESPONSIBLE FOR INSPECTING THE SITE PRIOR TO BIDDING WORK AND SHALL TAKE INTO CONSIDERATION ANY OMISSIONS, UNDERGROUND UTILITIES, OR OTHER ITEMS AFFECTING THE INSTALLATION OF PAVING, DRAINAGE, AND UTILITIES. SHOULD UNCHARTED OR INCORRECTLY CHARTED UTILITIES OR OTHER ITEMS BE ENCOUNTERED DURING CONSTRUCTION. CONSULT ENGINEER OF RECORD IMMEDIATELY FOR DIRECTIONS. REPAIR DAMAGED UTILITIES OR OTHER ITEMS TO
- 2. ALL MATERIALS AND WORKMANSHIP SHALL BE IN ACCORDANCE WITH ALL APPLICABLE CITY, COUNTY, STATE, AND FEDERAL REGULATIONS, CODES, AND ORDINANCES, INCLUDING OSHA AND FDOT SPECIFICAIONS, LASTEST EDITION UNLESS OTHERWISE AUTHORIZED BY THE ENGINEER IN WRITING.
- 3. LOCATION AND SIZES OF ALL EX. UTILITIES ARE APPROXIMATE ONLY. CONTRACTOR IS RESPONSIBLE FOR EXACT FIELD LOCATION AND SIZES PRIOR TO COMMENCEMENT OF ANY CONSTRUCTION TO ALLOW FOR PIPE RECONFIGURATION IF NEEDED. THE CONTRACTOR SHALL CONTACT ALL AFFECTED UTILITIES AT LEAST 48 HOURS IN ADVANCE

1449 NW COMMERCE CENTRE DR

PORT ST. LUCIE, FL 34986

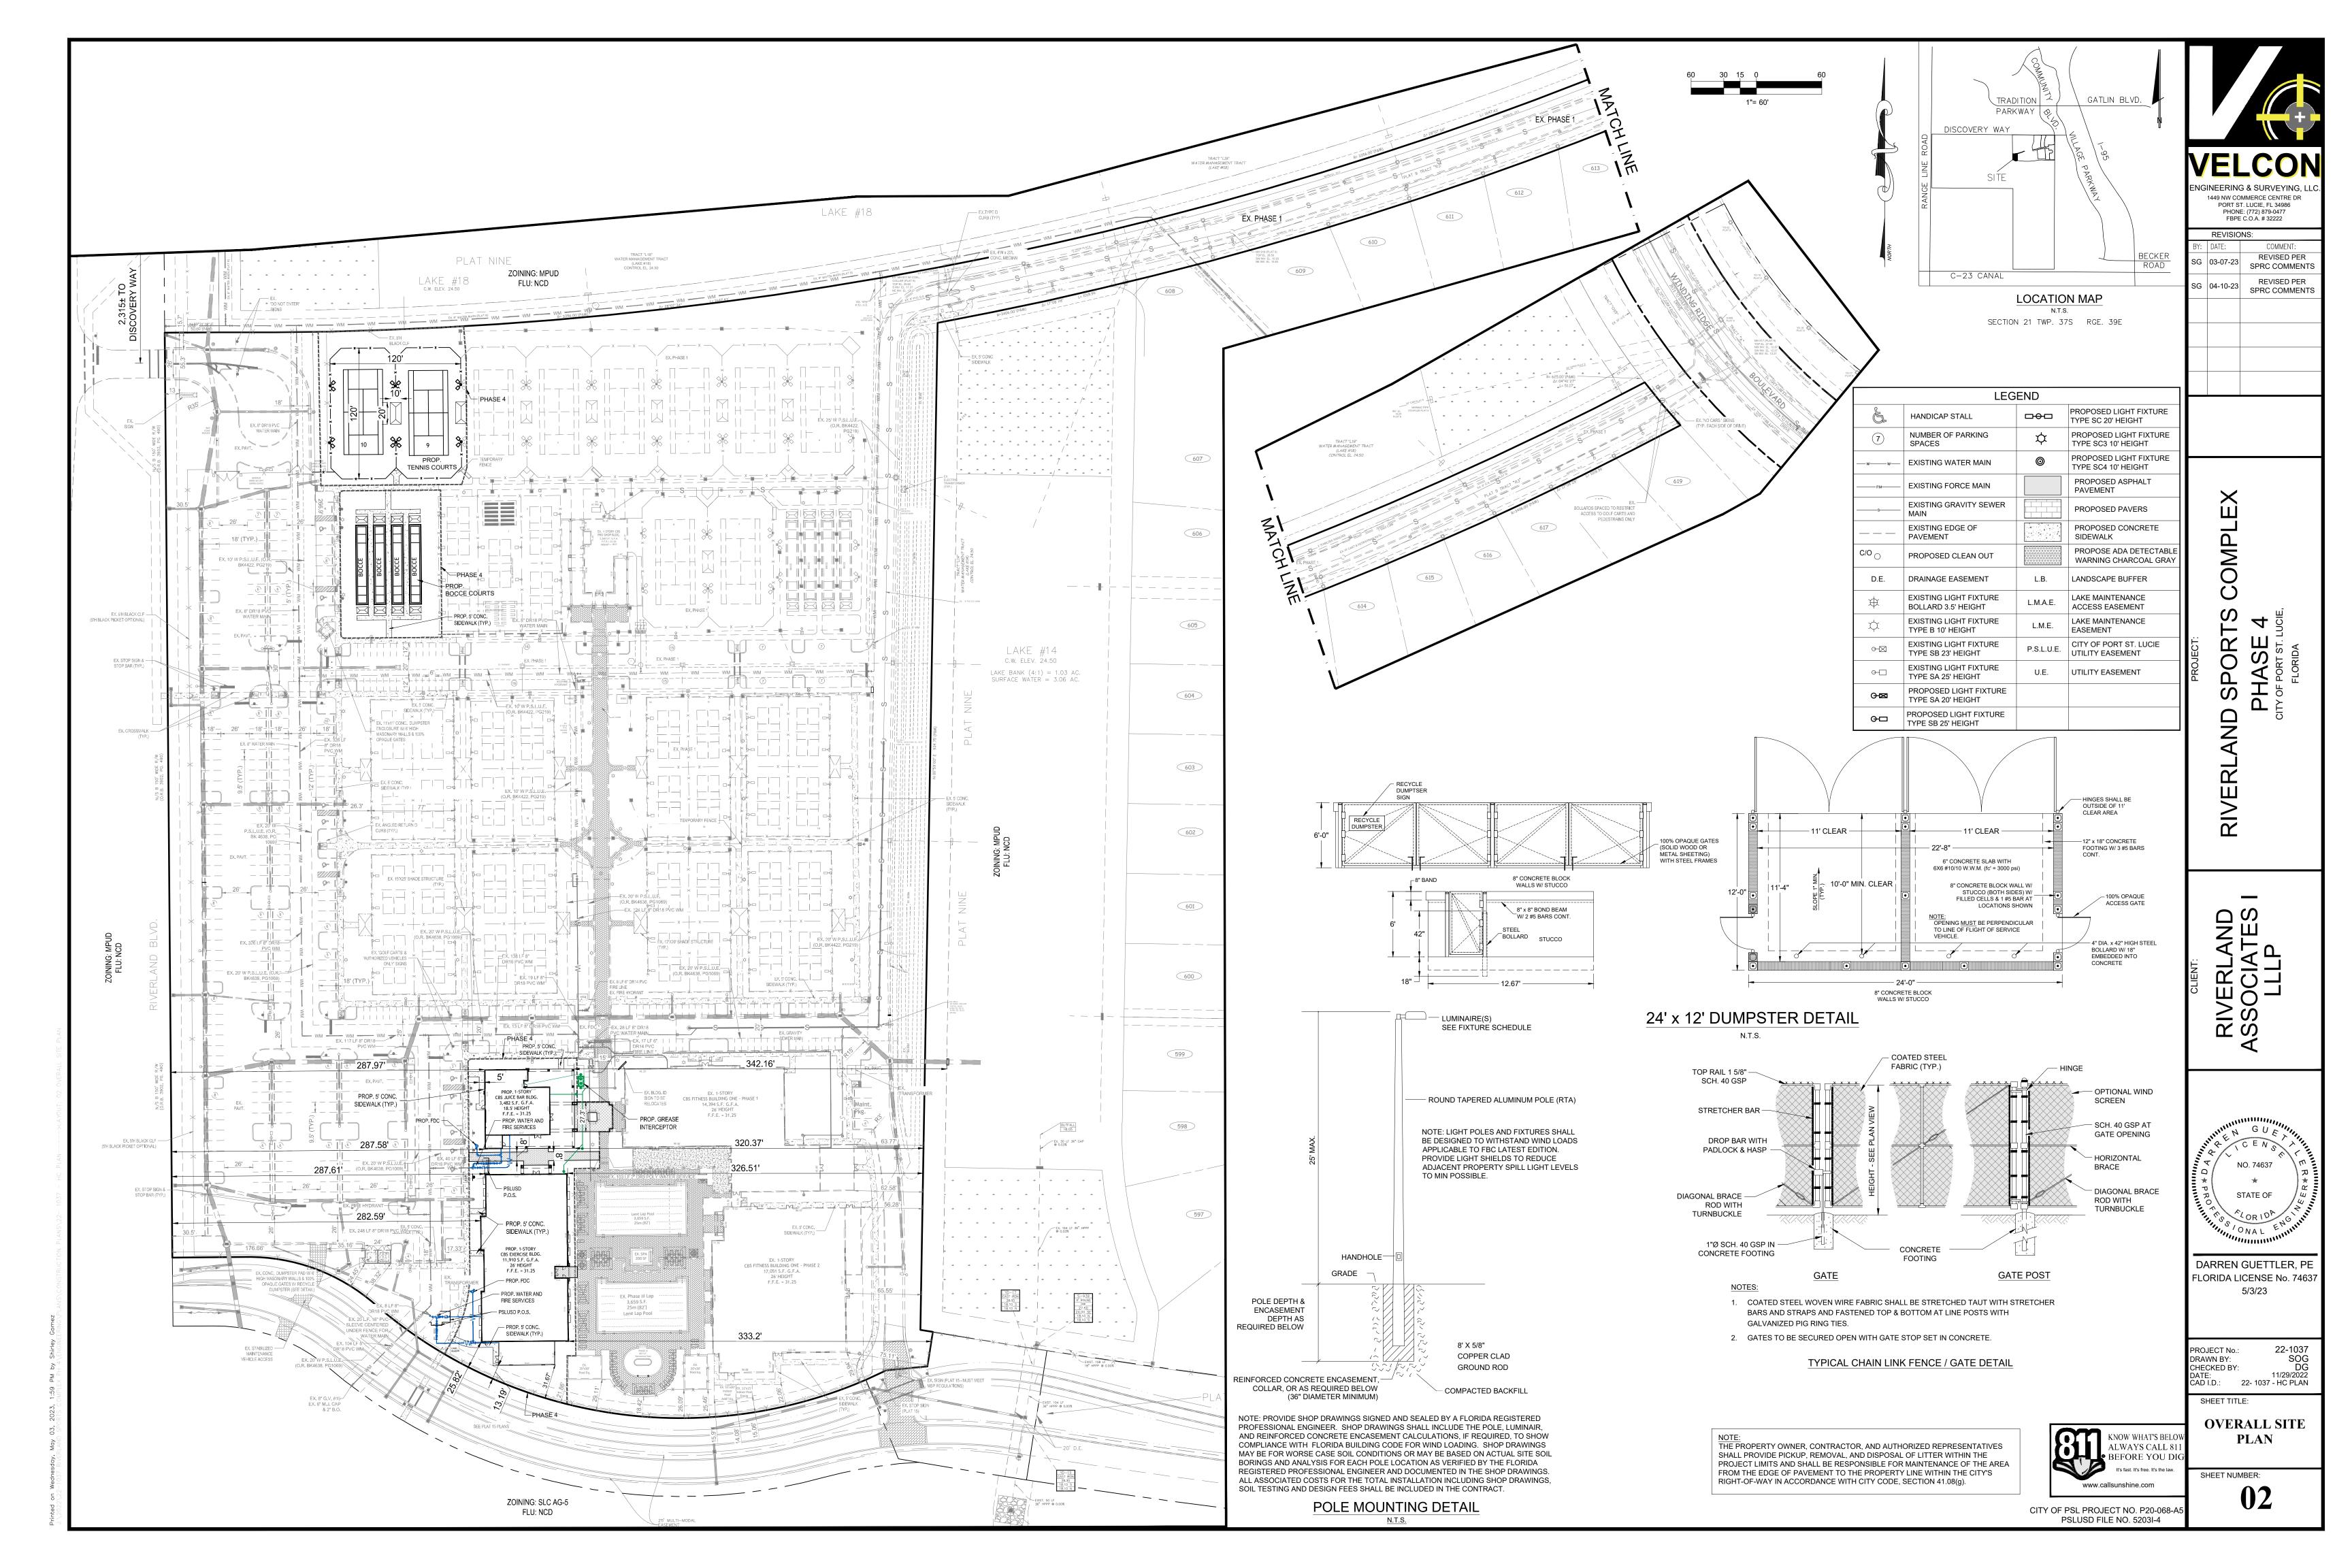COMMENT:

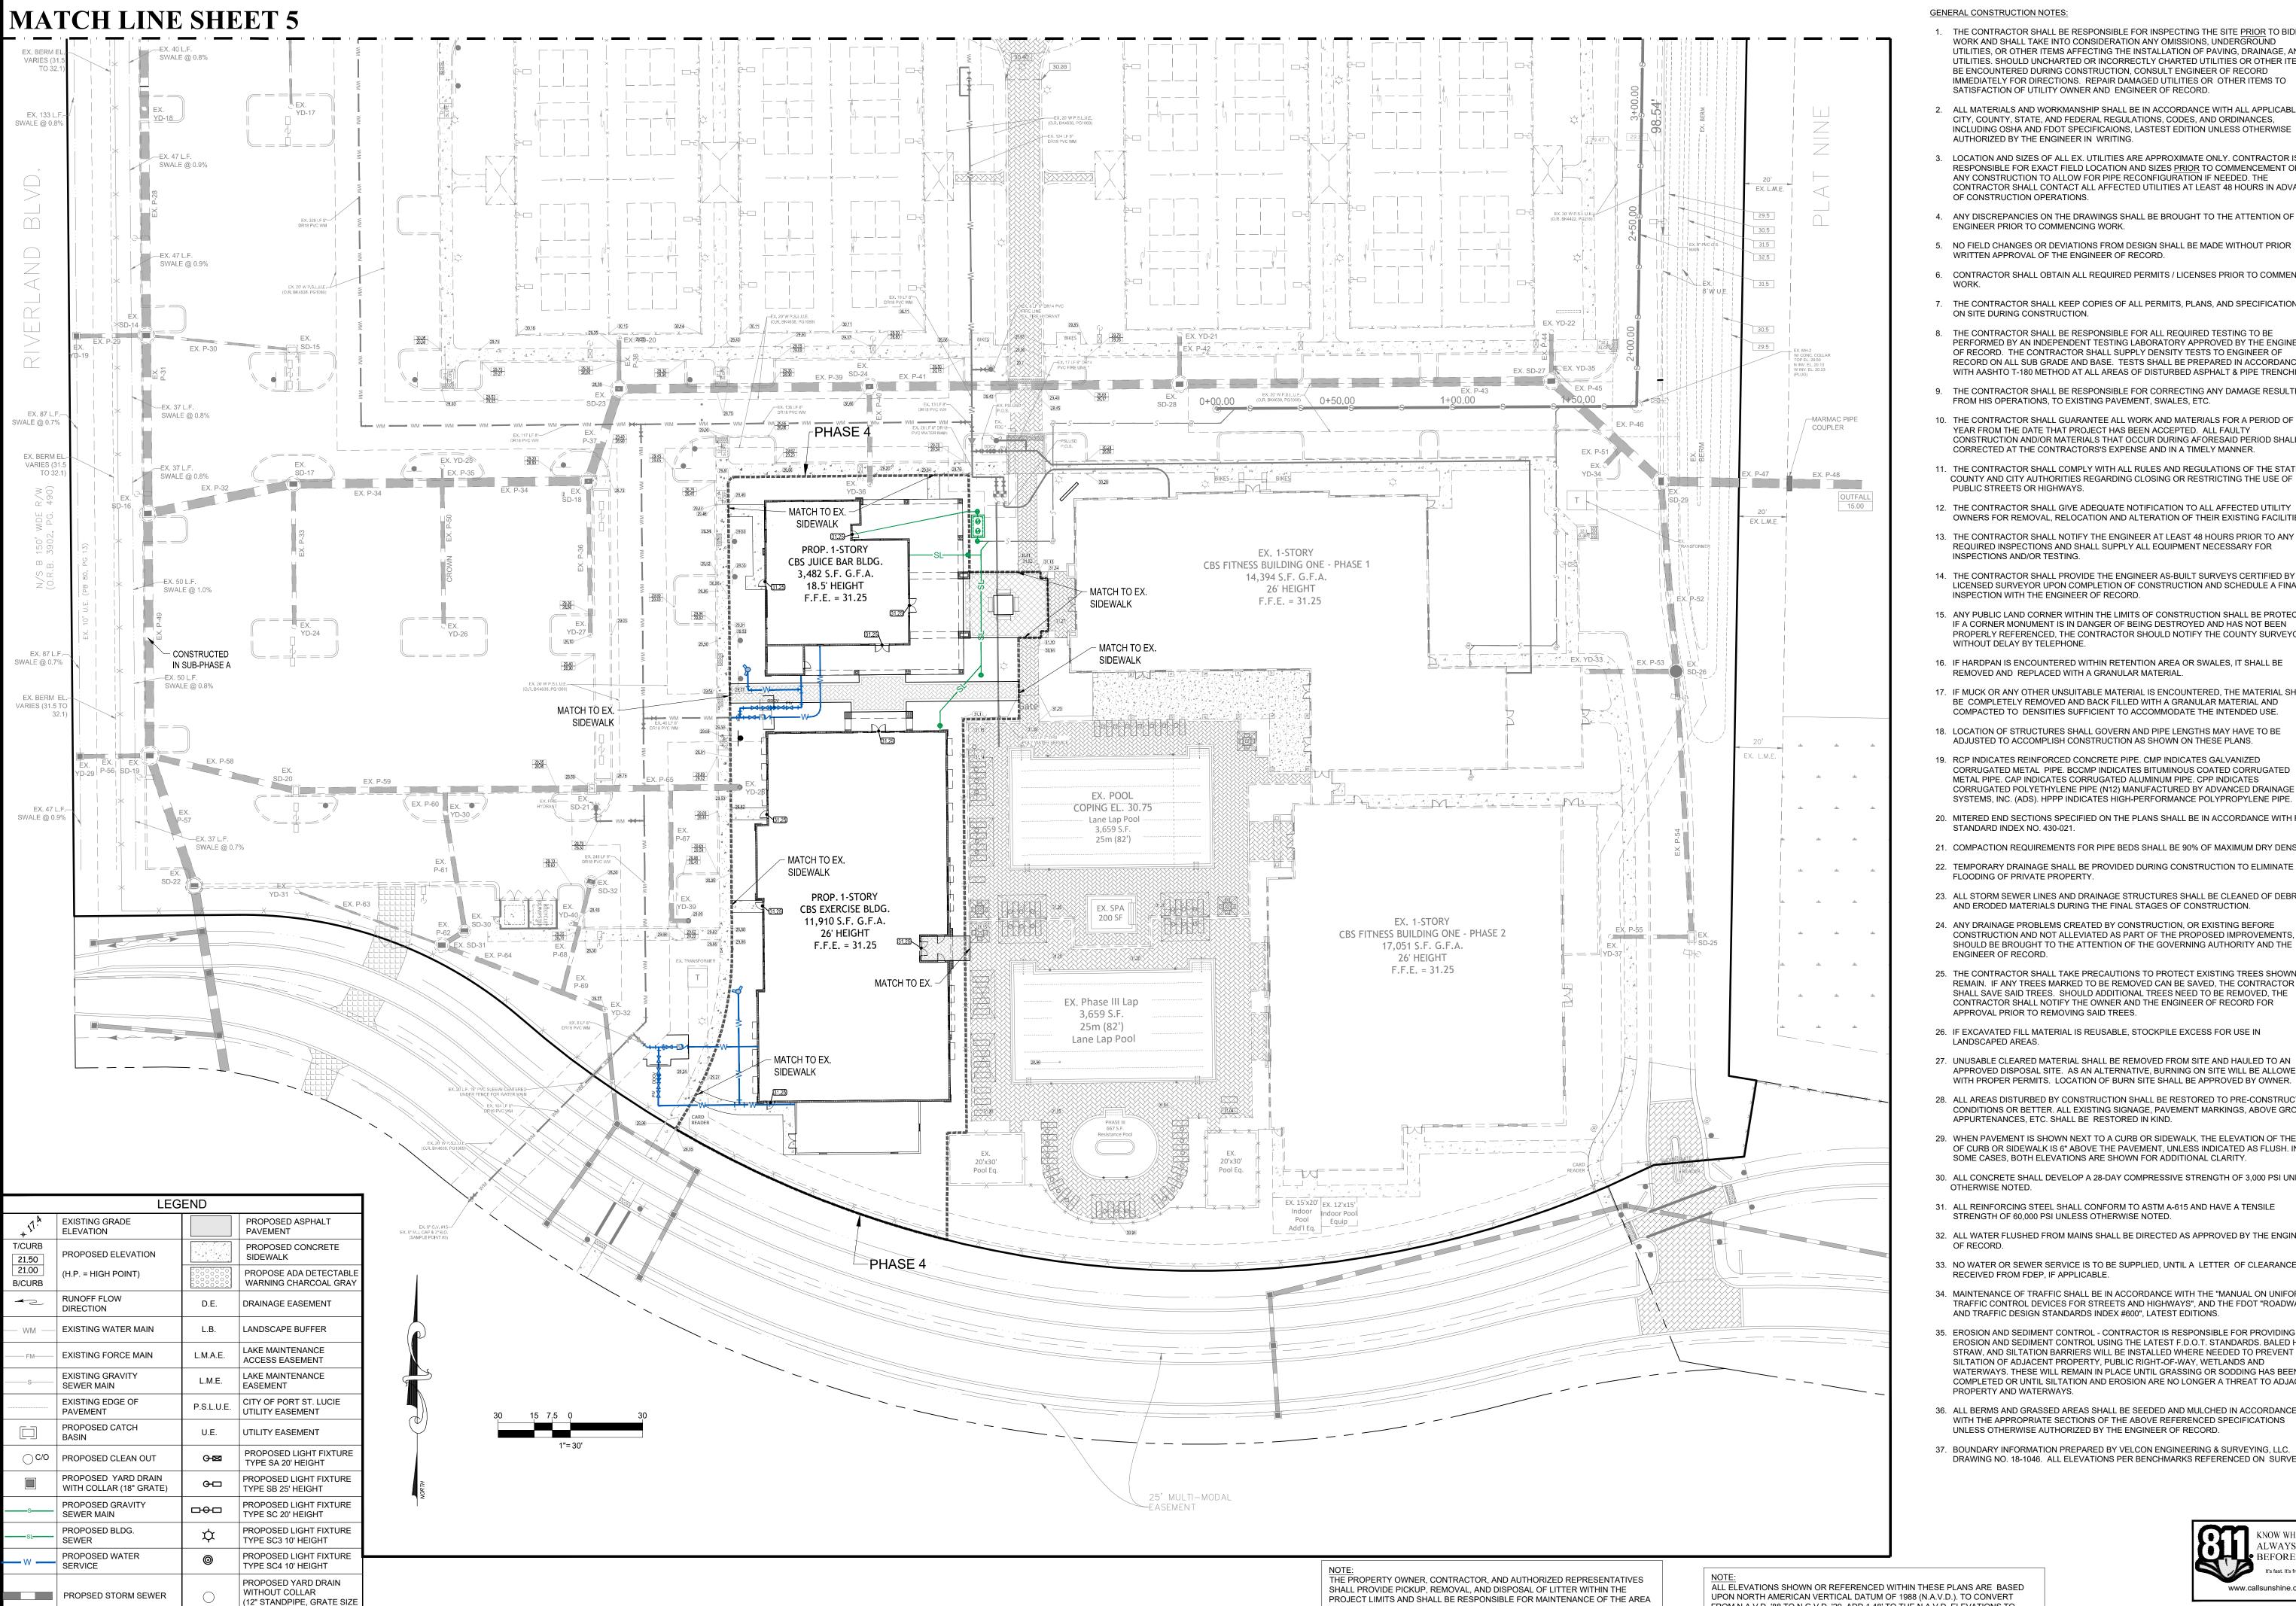REVISED PER

SPRC COMMENTS

REVISED PER

SPRC COMMENTS

PHONE: (772) 879-0477 FBPE C.O.A. # 32222

REVISIONS:

SG 03-07-23

SG 04-10-23

- 4. ANY DISCREPANCIES ON THE DRAWINGS SHALL BE BROUGHT TO THE ATTENTION OF THE ENGINEER PRIOR TO COMMENCING WORK.
- 5. NO FIELD CHANGES OR DEVIATIONS FROM DESIGN SHALL BE MADE WITHOUT PRIOR WRITTEN APPROVAL OF THE ENGINEER OF RECORD.
- 6. CONTRACTOR SHALL OBTAIN ALL REQUIRED PERMITS / LICENSES PRIOR TO COMMENCING
- 7. THE CONTRACTOR SHALL KEEP COPIES OF ALL PERMITS, PLANS, AND SPECIFICATIONS ON SITE DURING CONSTRUCTION.
- 8. THE CONTRACTOR SHALL BE RESPONSIBLE FOR ALL REQUIRED TESTING TO BE PERFORMED BY AN INDEPENDENT TESTING LABORATORY APPROVED BY THE ENGINEER OF RECORD. THE CONTRACTOR SHALL SUPPLY DENSITY TESTS TO ENGINEER OF RECORD ON ALL SUB GRADE AND BASE. TESTS SHALL BE PREPARED IN ACCORDANCE WITH AASHTO T-180 METHOD AT ALL AREAS OF DISTURBED ASPHALT & PIPE TRENCHING.
- 9. THE CONTRACTOR SHALL BE RESPONSIBLE FOR CORRECTING ANY DAMAGE RESULTING FROM HIS OPERATIONS, TO EXISTING PAVEMENT, SWALES, ETC.
- 10. THE CONTRACTOR SHALL GUARANTEE ALL WORK AND MATERIALS FOR A PERIOD OF ONE YEAR FROM THE DATE THAT PROJECT HAS BEEN ACCEPTED. ALL FAULTY CONSTRUCTION AND/OR MATERIALS THAT OCCUR DURING AFORESAID PERIOD SHALL BE
- 11. THE CONTRACTOR SHALL COMPLY WITH ALL RULES AND REGULATIONS OF THE STATE, COUNTY AND CITY AUTHORITIES REGARDING CLOSING OR RESTRICTING THE USE OF PUBLIC STREETS OR HIGHWAYS.
- 12. THE CONTRACTOR SHALL GIVE ADEQUATE NOTIFICATION TO ALL AFFECTED UTILITY OWNERS FOR REMOVAL, RELOCATION AND ALTERATION OF THEIR EXISTING FACILITIES.
- 13. THE CONTRACTOR SHALL NOTIFY THE ENGINEER AT LEAST 48 HOURS PRIOR TO ANY REQUIRED INSPECTIONS AND SHALL SUPPLY ALL EQUIPMENT NECESSARY FOR INSPECTIONS AND/OR TESTING.
- 14. THE CONTRACTOR SHALL PROVIDE THE ENGINEER AS-BUILT SURVEYS CERTIFIED BY A LICENSED SURVEYOR UPON COMPLETION OF CONSTRUCTION AND SCHEDULE A FINAL INSPECTION WITH THE ENGINEER OF RECORD.
- 15. ANY PUBLIC LAND CORNER WITHIN THE LIMITS OF CONSTRUCTION SHALL BE PROTECTED. IF A CORNER MONUMENT IS IN DANGER OF BEING DESTROYED AND HAS NOT BEEN PROPERLY REFERENCED, THE CONTRACTOR SHOULD NOTIFY THE COUNTY SURVEYOR WITHOUT DELAY BY TELEPHONE.
- 16. IF HARDPAN IS ENCOUNTERED WITHIN RETENTION AREA OR SWALES, IT SHALL BE REMOVED AND REPLACED WITH A GRANULAR MATERIAL
- 17. IF MUCK OR ANY OTHER UNSUITABLE MATERIAL IS ENCOUNTERED, THE MATERIAL SHALL BE COMPLETELY REMOVED AND BACK FILLED WITH A GRANULAR MATERIAL AND COMPACTED TO DENSITIES SUFFICIENT TO ACCOMMODATE THE INTENDED USE.
- 18. LOCATION OF STRUCTURES SHALL GOVERN AND PIPE LENGTHS MAY HAVE TO BE ADJUSTED TO ACCOMPLISH CONSTRUCTION AS SHOWN ON THESE PLANS.
- 19. RCP INDICATES REINFORCED CONCRETE PIPE. CMP INDICATES GALVANIZED CORRUGATED METAL PIPE. BCCMP INDICATES BITUMINOUS COATED CORRUGATED METAL PIPE. CAP INDICATES CORRUGATED ALUMINUM PIPE. CPP INDICATES CORRUGATED POLYETHYLENE PIPE (N12) MANUFACTURED BY ADVANCED DRAINAGE SYSTEMS, INC. (ADS), HPPP INDICATES HIGH-PERFORMANCE POLYPROPYLENE PIPE.
- 20. MITERED END SECTIONS SPECIFIED ON THE PLANS SHALL BE IN ACCORDANCE WITH FDOT STANDARD INDEX NO. 430-021.
- 21. COMPACTION REQUIREMENTS FOR PIPE BEDS SHALL BE 90% OF MAXIMUM DRY DENSITY
- 22. TEMPORARY DRAINAGE SHALL BE PROVIDED DURING CONSTRUCTION TO ELIMINATE ANY FLOODING OF PRIVATE PROPERTY.
- 23. ALL STORM SEWER LINES AND DRAINAGE STRUCTURES SHALL BE CLEANED OF DEBRIS AND ERODED MATERIALS DURING THE FINAL STAGES OF CONSTRUCTION.
- 24. ANY DRAINAGE PROBLEMS CREATED BY CONSTRUCTION, OR EXISTING BEFORE CONSTRUCTION AND NOT ALLEVIATED AS PART OF THE PROPOSED IMPROVEMENTS, SHOULD BE BROUGHT TO THE ATTENTION OF THE GOVERNING AUTHORITY AND THE
- 25. THE CONTRACTOR SHALL TAKE PRECAUTIONS TO PROTECT EXISTING TREES SHOWN TO REMAIN. IF ANY TREES MARKED TO BE REMOVED CAN BE SAVED. THE CONTRACTOR SHALL SAVE SAID TREES. SHOULD ADDITIONAL TREES NEED TO BE REMOVED, THE CONTRACTOR SHALL NOTIFY THE OWNER AND THE ENGINEER OF RECORD FOR
- 26. IF EXCAVATED FILL MATERIAL IS REUSABLE, STOCKPILE EXCESS FOR USE IN
- 27. UNUSABLE CLEARED MATERIAL SHALL BE REMOVED FROM SITE AND HAULED TO AN APPROVED DISPOSAL SITE. AS AN ALTERNATIVE, BURNING ON SITE WILL BE ALLOWED
- 28. ALL AREAS DISTURBED BY CONSTRUCTION SHALL BE RESTORED TO PRE-CONSTRUCTION CONDITIONS OR BETTER. ALL EXISTING SIGNAGE, PAVEMENT MARKINGS, ABOVE GROUND APPURTENANCES, ETC. SHALL BE RESTORED IN KIND.
- 29. WHEN PAVEMENT IS SHOWN NEXT TO A CURB OR SIDEWALK, THE ELEVATION OF THE TOP OF CURB OR SIDEWALK IS 6" ABOVE THE PAVEMENT, UNLESS INDICATED AS FLUSH. IN
- 30. ALL CONCRETE SHALL DEVELOP A 28-DAY COMPRESSIVE STRENGTH OF 3,000 PSI UNLESS
- 31. ALL REINFORCING STEEL SHALL CONFORM TO ASTM A-615 AND HAVE A TENSILE STRENGTH OF 60,000 PSI UNLESS OTHERWISE NOTED.
- 32. ALL WATER FLUSHED FROM MAINS SHALL BE DIRECTED AS APPROVED BY THE ENGINEER
- 33. NO WATER OR SEWER SERVICE IS TO BE SUPPLIED, UNTIL A LETTER OF CLEARANCE IS RECEIVED FROM FDEP, IF APPLICABLE.
- 34. MAINTENANCE OF TRAFFIC SHALL BE IN ACCORDANCE WITH THE "MANUAL ON UNIFORM TRAFFIC CONTROL DEVICES FOR STREETS AND HIGHWAYS", AND THE FDOT "ROADWAY AND TRAFFIC DESIGN STANDARDS INDEX #600", LATEST EDITIONS.
- 35. EROSION AND SEDIMENT CONTROL CONTRACTOR IS RESPONSIBLE FOR PROVIDING EROSION AND SEDIMENT CONTROL USING THE LATEST F.D.O.T. STANDARDS. BALED HAY, STRAW, AND SILTATION BARRIERS WILL BE INSTALLED WHERE NEEDED TO PREVENT SILTATION OF ADJACENT PROPERTY, PUBLIC RIGHT-OF-WAY, WETLANDS AND WATERWAYS. THESE WILL REMAIN IN PLACE UNTIL GRASSING OR SODDING HAS BEEN COMPLETED OR UNTIL SILTATION AND EROSION ARE NO LONGER A THREAT TO ADJACENT
- 36. ALL BERMS AND GRASSED AREAS SHALL BE SEEDED AND MULCHED IN ACCORDANCE WITH THE APPROPRIATE SECTIONS OF THE ABOVE REFERENCED SPECIFICATIONS UNLESS OTHERWISE AUTHORIZED BY THE ENGINEER OF RECORD.
- 37. BOUNDARY INFORMATION PREPARED BY VELCON ENGINEERING & SURVEYING, LLC. DRAWING NO. 18-1046. ALL ELEVATIONS PER BENCHMARKS REFERENCED ON SURVEY.

FROM N.A.V.D. '88 TO N.G.V.D. '29, ADD 1.48' TO THE N.A.V.D. ELEVATIONS TO

GET N.G.V.D. ELEVATIONS.

FROM THE EDGE OF PAVEMENT TO THE PROPERTY LINE WITHIN THE CITY'S

RIGHT-OF-WAY IN ACCORDANCE WITH CITY CODE, SECTION 41.08(g).

ALWAYS CALL 8 BEFORE YOU DI

CITY OF PSL PROJECT NO. P20-068-A PSLUSD FILE NO. 5203I-4

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RAWN BY:

CHECKED BY:

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STATE OF

DARREN GUETTLER, PE

FLORIDA LICENSE No. 74637

5/3/23

CAD I.D.: 22- 1037 - PGD PLAN

PAVING, GRADING


& DRAINAGE PLAN


22-1037

www.callsunshine.com

#### **GENERAL NOTES**

- 1. MINIMUM FINISH FLOOR ELEVATION FOR ANY STRUCTURE SHALL BE ELEVATION 30.50' NAVD88, WHICH IS ABOVE THE 100-YEAR, 3-DAY STORM STAGE ELEVATION.
- 2. MINIMUM PERIMETER ELEVATION SHALL BE ELEVATION 29.5' NAVD88. WHICH IS ABOVE THE 25-YEAR. 3-DAY STORM STAGE ELEVATION.
- 3. MINIMUM ROAD CROWN ELEVATION SHALL BE ELEVATION 28.0' NAVD88, WHICH IS ABOVE THE 10-YEAR, 1-DAY STORM STAGE ELEVATION.
- 4. ALL ELEVATIONS SHOWN ON THESE PLANS ARE IN THE NORTH AMERICAN VERTICAL DATUM OF 1988 (NAVD88). TO CONVERT ELEVATIONS TO THE NATIONAL GEODETIC VERTICAL DATUM OF 1929 (NGVD29), ADD 1.475 FEET TO THE NAVD88 ELEVATION. FOR EXAMPLE, NAVD88 + 1.475' = NGVD29.
- 5. ALL WORK SHALL BE DONE IN A WORKMANLIKE MANNER AND SHALL CONFORM TO ALL APPLICABLE CITY, COUNTY, STATE OR FEDERAL REGULATIONS AND/OR CODES. THE CONTRACTOR SHALL BE RESPONSIBLE FOR OBTAINING ALL PERMITS AND LICENSES REQUIRED PRIOR TO INITIATING THE WORK.
- 6. THE CONTRACTOR SHALL CALL SUNSHINE (1-800-432-4770), 48 HOURS BEFORE DIGGING FOR FIELD LOCATIONS OF UNDERGROUND UTILITIES.
- 7. UTILITIES -IT IS THE CONTRACTOR'S RESPONSIBILITY TO ASCERTAIN THE EXACT LOCATIONS OF ALL EXISTING UNDERGROUND UTILITIES, WHETHER SHOWN OR NOT, PRIOR TO CONSTRUCTION. CONTRACTOR SHALL NOTIFY ALL UTILITY COMPANIES PRIOR TO CONSTRUCTION. NOTIFY ENGINEER PRIOR TO CONSTRUCTION OF ANY DEVIATION
- 8. AS-BUILTS THE CONTRACTOR SHALL SUBMIT "AS-BUILT" INFORMATION OBTAINED BY A FLORIDA REGISTERED LAND SURVEYOR. INFORMATION SHALL BE IN A FORMAT SPECIFIED BY THE GOVERNING AGENCIES.
- 9. GUARANTY ALL MATERIAL AND EQUIPMENT TO BE FURNISHED AND/OR INSTALLED BY THE CONTRACTOR UNDER THIS CONTRACT SHALL BE GUARANTEED FOR A PERIOD OF ONE YEAR FROM THE DATE OF FINAL ACCEPTANCE THEREOF, AGAINST DEFECTIVE MATERIALS, INSTALLATION AND WORKMANSHIP. UPON RECEIPT OF NOTICE FROM THE OWNER OF FAILURE OF ANY PART FOR THE GUARANTEED EQUIPMENT OR MATERIALS, DURING THE GUARANTY PERIOD, THE AFFECTED PART, PARTS OR MATERIALS SHALL BE REPAIRED OR REPLACED BY THE CONTRACTOR AT NO EXPENSE TO THE OWNER.
- 10. SEQUENCE OF CONSTRUCTION -THE SEQUENCE OF CONSTRUCTION SHALL BE SUCH THAT ALL UNDERGROUND INSTALLATIONS OF EVERY KIND THAT ARE BENEATH THE PAVEMENT, SHALL BE IN PLACE AND HAVE PROPER DENSITY PRIOR TO THE CONSTRUCTION AND COMPACTION OF THE SUBGRADE
- 11. CLEARING AND GRUBBING -WITHIN THE LIMITS OF CONSTRUCTION, ALL VEGETATION AND ROOT MATERIAL SHALL BE REMOVED.
- 12. GUMBO -WHERE GUMBO OR OTHER PLASTIC CLAYS ARE ENCOUNTERED, THEY SHALL BE REMOVED WITHIN THE ROADWAY AND PARKING AREAS ONE FOOT BELOW THE SUBGRADE EXTENDING HORIZONTALLY TO THE OUTSIDE EDGE OF THE SHOULDER AREA.
- 13. MUCK AND PEAT -IF MUCK AND/OR PEAT ARE ENCOUNTERED IN THE ROAD, PARKING OR BUILDING AREA, THEY SHALL BE REMOVED COMPLETELY TO A WIDTH OF TEN FEET BEYOND THE EDGE OF PAVEMENT OR FOUNDATION AND SHALL BE BACKFILLED WITH GRANULAR MATERIAL.
- 14. SOD WHERE SOD IS SHOWN, LOWER THE GROUND 2 INCHES BELOW THE FINISHED GRADE TO ALLOW FOR THE THICKNESS OF THE SOD.
- 15. SUBGRADE -SHALL BE COMPACTED AS NOTED ON THE PLANS AND MEET THE DENSITY REQUIREMENTS AS DETERMINED BY THE A.A.S.H.T.O. T-180 SPECIFICATIONS. SUBGRADE SHALL BE 12" THICK AND EXTEND 12" BEYOND THE PROPOSED EDGE OF PAVEMENT AND/OR 6" BEYOND VALLEY GUTTER. TYPE "F" CURB & GUTTER OR TYPE "D" CURB. IF SUBGRADE IS REQUIRED TO BE STABILIZED, THE REQUIRED BEARING VALUE DETERMINATIONS SHALL BE MADE PER FLORIDA DEPARTMENT OF TRANSPORTATION SPECIFICATIONS, LATEST EDITION. WHEN FILLING IS REQUIRED, SUBGRADE SHALL BE COMPACTED IN 6" LIFTS.
- 16. BASE MATERIAL -APPROVED BASE MATERIAL, MINIMUM L.B.R. 100, SHALL BE COMPACTED TO NOT LESS THAN 98% MAXIMUM DENSITY AS DETERMINED BY A.A.S.H.T.O. T-180 SPECIFICATIONS AND MEET THE CRITERIA SET FORTH IN THE PLANS AND SPECIFICATIONS AND AS CALLED FOR IN BOTH FLORIDA D.O.T. INDEX 514 AND FLORIDA D.O.T. SPECIFICATIONS, LATEST EDITION. CONTRACTOR SHALL NOTIFY BOTH THE OWNER AND OWNER'S GEOTECHNICAL ENGINEER A MINIMUM OF 48 HOURS PRIOR TO BASE MATERIAL DELIVERY TO THE PROJECT TO SCHEDULE MATERIAL TESTING. TEST RESULTS THAT DO NOT MEET THE SPECIFIED CRITERIA, SHALL CAUSE THE CONTRACTOR, AT HIS SOLE EXPENSE, TO REMOVE ANY AND ALL OF SAME MATERIAL THAT IS EITHER ALREADY PLACED IN ROADWAYS OR IN STOCKPILES AND NOT USE IT IN AREAS REQUIRING BASE MATERIAL. CONTRACTOR SHALL NOTIFY OWNER AND OWNER'S GEOTECHNICAL ENGINEER 48 HOURS PRIOR TO DELIVERY OF BASE MATERIAL THAT IS FROM A NEW SOURCE TO SCHEDULE MATERIAL TESTING. CONTRACTOR SHALL PROVIDE THE OWNER AND OWNER'S GEOTECHNICAL ENGINEER A SCHEMATIC INDICATING WHERE ON THE PROJECT THE CHANGE IN MATERIAL SOURCE HAS OCCURRED. AT MINIMUM, ALL BASE MATERIAL SHALL BE TESTED PRIOR TO THE START OF EACH NEW PHASE OF THE WORK AND AS THE OWNER OR OWNER'S GEOTECHNICAL ENGINEER DEEMS AS NECESSARY DURING FIELD INSPECTIONS TO ENSURE ALL BASE MATERIAL THROUGHOUT THE PROJECT MEETS ALL MINIMUM CRITERIA.
- 17. PRIME COAT -BITUMINOUS PRIME COAT SHALL CONFORM WITH THE REQUIREMENTS OF THE FLORIDA D.O.T. SPECIFICATIONS, LATEST EDITION AND SHALL BE APPLIED AT A RATE OF 0.25 GALLONS PER SQUARE YARD, UNLESS A DIFFERENT RATE IS DIRECTED BY THE ENGINEER. PRIME COAT IS TO BE APPLIED AT LEAST 24 HOURS PRIOR TO PLACEMENT OF PAVEMENT WITH AN ABSOLUTE MINIMUM APPLICATION LEAD TIME OF 12 HOURS PERMITTED ONLY WITH THE WRITTEN APPROVAL FROM THE ENGINEER.
- 18. TACK COAT -BITUMINOUS TACK COAT SHALL CONFORM WITH THE REQUIREMENTS OF THE FLORIDA D.O.T. SPECIFICATIONS, LATEST EDITION AND SHALL BE APPLIED AT THE RATE OF 0.08 GALLONS PER SQUARE YARD, UNLESS A VARIATION IS APPROVED BY THE ENGINEER.
- 19. SURFACE COURSE -ASPHALTIC CONCRETE SURFACE COURSE SHALL CONFORM WITH THE REQUIREMENTS OF THE FLORIDA D.O.T. SPECIFICATIONS, LATEST EDITION. THE MINIMUM COMPACTED THICKNESS TO BE AS NOTED ON PLANS.
- 20. PAVEMENT MARKINGS AND GEOMETRICS SHALL BE IN ACCORDANCE WITH THE MANUAL ON UNIFORM TRAFFIC CONTROL DEVICES FOR STREETS AND HIGHWAYS, LATEST EDITION.
- 21. CONCRETE -ALL CONCRETE SHALL DEVELOP 2500 P.S.I. (MINIMUM) 28 DAY COMPRESSIVE STRENGTH OR GREATER WHERE NOTED ON PLANS. CLASS I CONCRETE SHALL CONFORM WITH THE FLORIDA D.O.T. SPECIFICATIONS, LATEST EDITION. CLASS I CONCRETE USED AS PAVING SHALL DEVELOP 3000 P.S.I. (MINIMUM) 28 DAYS COMPRESSIVE
- 22. ANY EXISTING ROADWAY AND/OR UTILITY THAT IS DAMAGED BY THE CONTRACTOR SHALL BE CORRECTED AT THE CONTRACTOR'S EXPENSE TO THE SATISFACTION OF THE OWNER'S ENGINEER
- 23. PIPE BACKFILL -REQUIREMENTS FOR PIPE BACKFILL CROSSING ROADS OR PARKING AREAS SHALL BE DEFINED IN THE FLORIDA D.O.T. SPECIFICATIONS, LATEST EDITION. PIPELINE BACKFILL SHALL BE PLACED IN SIX INCH LIFTS AND COMPACTED TO 100% OF THE STANDARD PROCTOR (A.A.S.H.T.O.) T-99 SPECIFICATIONS.
- 24. ALL PIPE LENGTHS AND CENTERLINE SLOPE LENGTHS SHOWN ON THESE DRAWINGS ARE SCALED DISTANCES. THE CONTRACTOR SHALL CONFIRM ALL MEASUREMENTS IN THE FIELD AND NOTIFY THE ENGINEER IN WRITING OF ANY DISCREPANCY WITH THE DRAWINGS PRIOR TO PERFORMING THE WORK, ALL CONCRETE PIPES SHALL HAVE
- 25. THE PROPERTY OWNER, CONTRACTOR AND AUTHORIZED REPRESENTATIVES SHALL PROVIDE PICKUP, REMOVAL AND DISPOSAL OF LITTER WITHIN THE PROJECT LIMITS AND SHALL BE RESPONSIBLE FOR MAINTENANCE OF THE AREA FROM THE EDGE OF PAVEMENT TO THE PROPERTY LINE WITHIN THE CITY'S RIGHT-OF-WAY IN ACCORDANCE WITH CITY CODE, SECTION 41.08 (G).

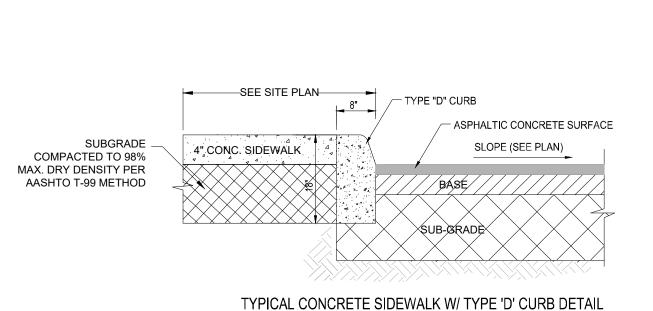


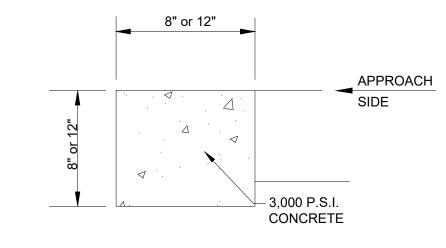

. CONTRACTOR SHALL EXCAVATE 2' ON EITHER SIDE OF FORMS WHEN INSTALLING HEADER CURB. EXCAVATED AREA SHALL BE BACKFILLED WITH BASE MATERIAL AND COMPACTED IN 6" MAXIMUM LIFTS. WORK SHALL BE INSPECTED BY ENGINEER 2. 1/2" EXPANSION JOINT SHALL BE INSTALLED WHERE HEADER


> 8" OR 1' FLUSH EDGE CURB N.T.S.

CURB ADJOINS OTHER CONCRETE CURB.

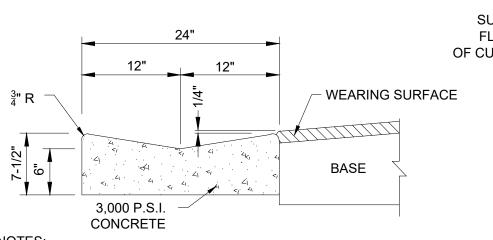

SAWCUTS REQUIRED AT 5' CENTERS. 2. CURB SHALL BE PLACED ON SPECIFIED SUBGRADE COURSE.


2' VALLEY GUTTER

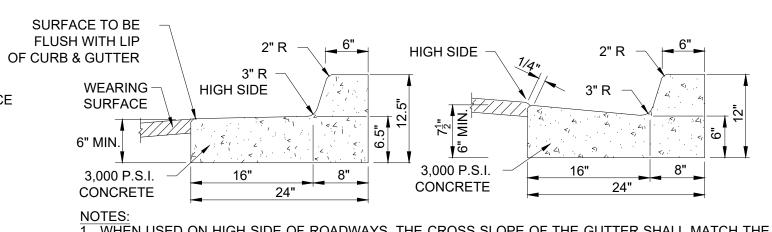

. WHEN USED ON HIGH SIDE OF ROADWAYS, THE CROSS SLOPE OF THE GUTTER SHALL MATCH THE SLOPE OF ADJACENT PAVEMENT AND THICKNESS OF THE LIP SHALL BE 6 INCHES. SAWCUTS REQUIRED AT 10' CENTERS.


3. CURB SHALL BE PLACED ON SPECIFIED SUBGRADE COURSE

TYPE "F" CURB & GUTTER

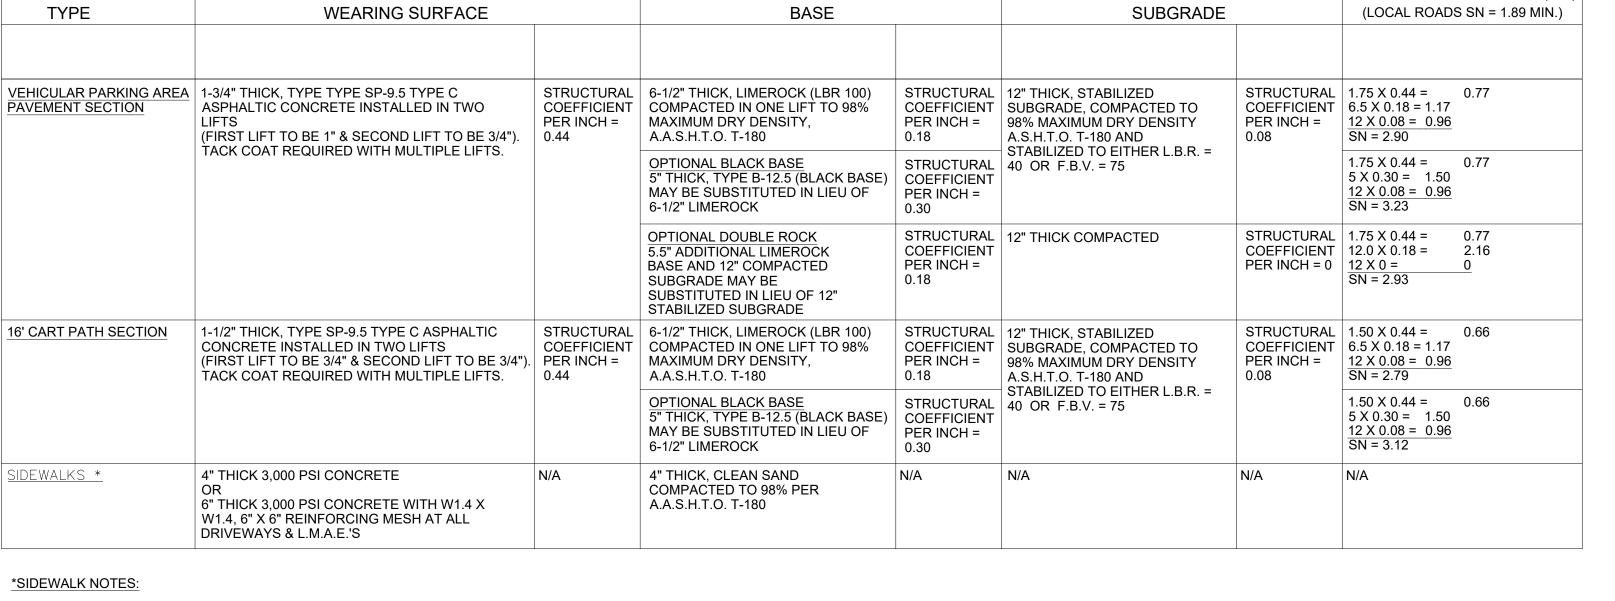

PAVING / SIDEWALK SPECIFICATIONS

- 1. SIDEWALKS ADJACENT TO RESIDENTIAL UNITS WILL BE CONSTRUCTED WITH RESPECTIVE UNIT.
- 2. SIDEWALK TO BE 4" THICK, PORTLAND CEMENT CONCRETE, MINIMUM 3,000 P.S.I. @ 28 DAYS.
- 3. SIDEWALK TO BE BROOM FINISHED WITH EVEN DUSTLESS SURFACE. COMPACTED BASE TO BE A MINIMUM 4" OF CLEAN SAND OR SANDY LOAM, COMPACTED
- TO 98% PER A.A.S.H.T.O. T-180, FULL WIDTH. AT DRIVEWAYS, SIDEWALKS SHALL BE THICKENED TO 6" WITH 6"X6" W1.4 X W1.4 MESH.
- TYPE "A" EXPANSION JOINTS (2" WITH PREFORMED JOINT FILLER PER F.D.O.T. STANDARD INDEX #310) SHALL BE LOCATED WHERE NEW CONCRETE MEETS EXISTING CONCRETE. TYPE "B" (1 TOOLED JOINTS) OR TYPE "D" (1 SAWCUT JOINTS) PER F.D.O.T. STANDARD INDEX #310 SHALL BE LOCATED AT 5' O.C. SAW-CUT JOINTS AVOIDED WHENEVER POSSIBLE.

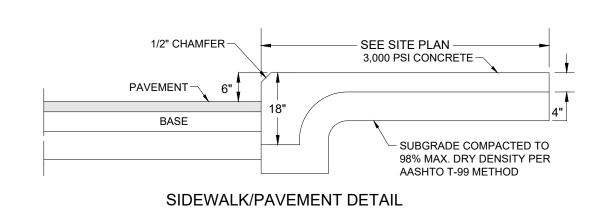


N.T.S.

- CONSTRUCT 6" LIMEROCK OR COQUINA BASE COMPACTED TO 98% MAX. DRY DENSITY PER AASHTO T-180 METHOD, LBR 100 -STABILIZED SUBGRADE MIN. DEPTH OF 8",

> COMPACTED TO 98% MAX. DRY DENSITY PER AASHTO T-180 METHOD, MIN. LBR40, MIXED AND

TYPICAL STABILIZED ACCESS/ 2' STABILIZED SHOULDER DETAIL N.T.S.

HOMOGENEOUS MATERIAL

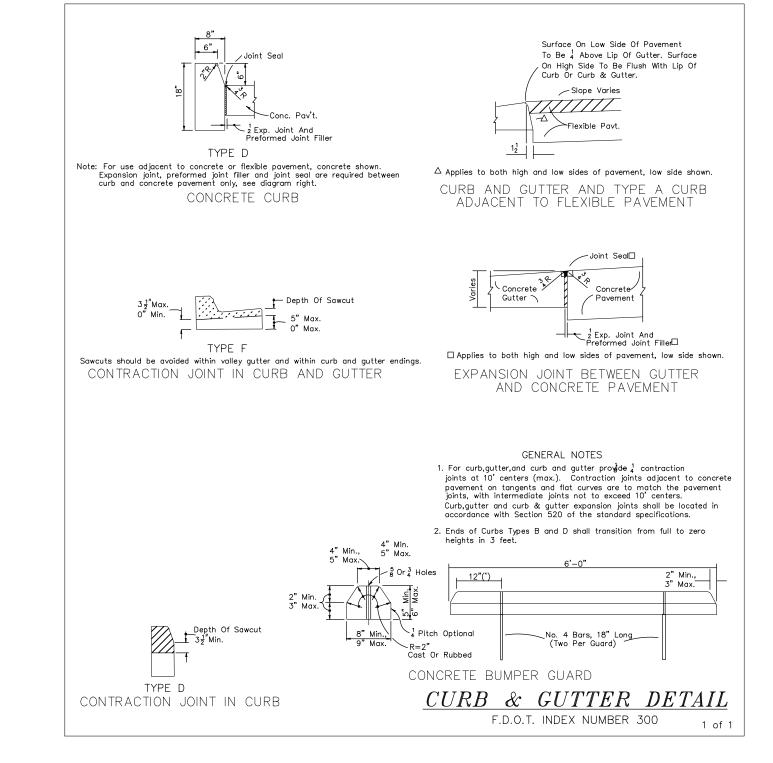

STRUCTURAL NUMBER (SN)

1449 NW COMMERCE CENTRE DR

PORT ST. LUCIE, FL 34986

FBPE C.O.A. # 32222

COMMENT

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SPRC COMMENTS

PHONE: (772) 879-047

REVISIONS

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STATE OF

DARREN GUETTLER, PI

FLORIDA LICENSE No. 74637

5/3/23

CAD I.D.: 22- 1037 - PGD DETAILS


PAVING, GRADING

DRAWN BY:

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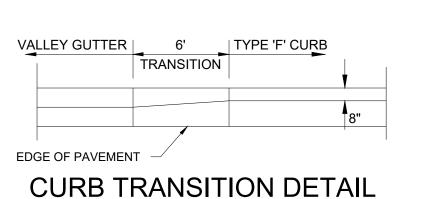
SHEET TITLE:

G 03-07-23

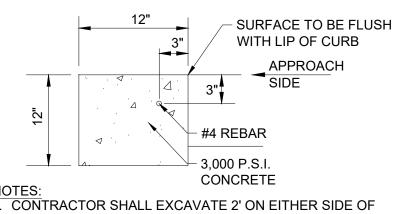

FORMS WHEN INSTALLING HEADER CURB. EXCAVATED AREA SHALL BE BACKFILLED WITH BASE MATERIAL AND COMPACTED IN 6" MAXIMUM LIFTS. WORK SHALL BE INSPECTED BY ENGINEER. 2. 1/2" EXPANSION JOINT SHALL BE INSTALLED WHERE HEADER CURB ADJOINS OTHER CONCRETE CURB.

12" FLUSH HEADER CURB




DETAILS LEGEND: -CENTERLINE CONC -CONCRETE -ELEVATION -LOT LINE LME -LAKE MAINTENANCE EASEMENT -MAXIMUM MIN. -MINIMUM P.S.L.U.E. -CITY OF PORT ST. LUCIE UTILITY EASEMENT R/W -RIGHT-OF-WAY S/W -SIDEWALK TYP. -TYPICAL -UTILITY EASEMENT -UTILITY EASEMENT - RESTRICTED AREA


NOTE: ALL GRADES SHOWN ARE IN NAVD88



CITY OF PSL PROJECT NO. P20-068-A PSLUSD FILE NO. 5203I-4

& DRAINAGE **DETAILS** SHEET NUMBER:

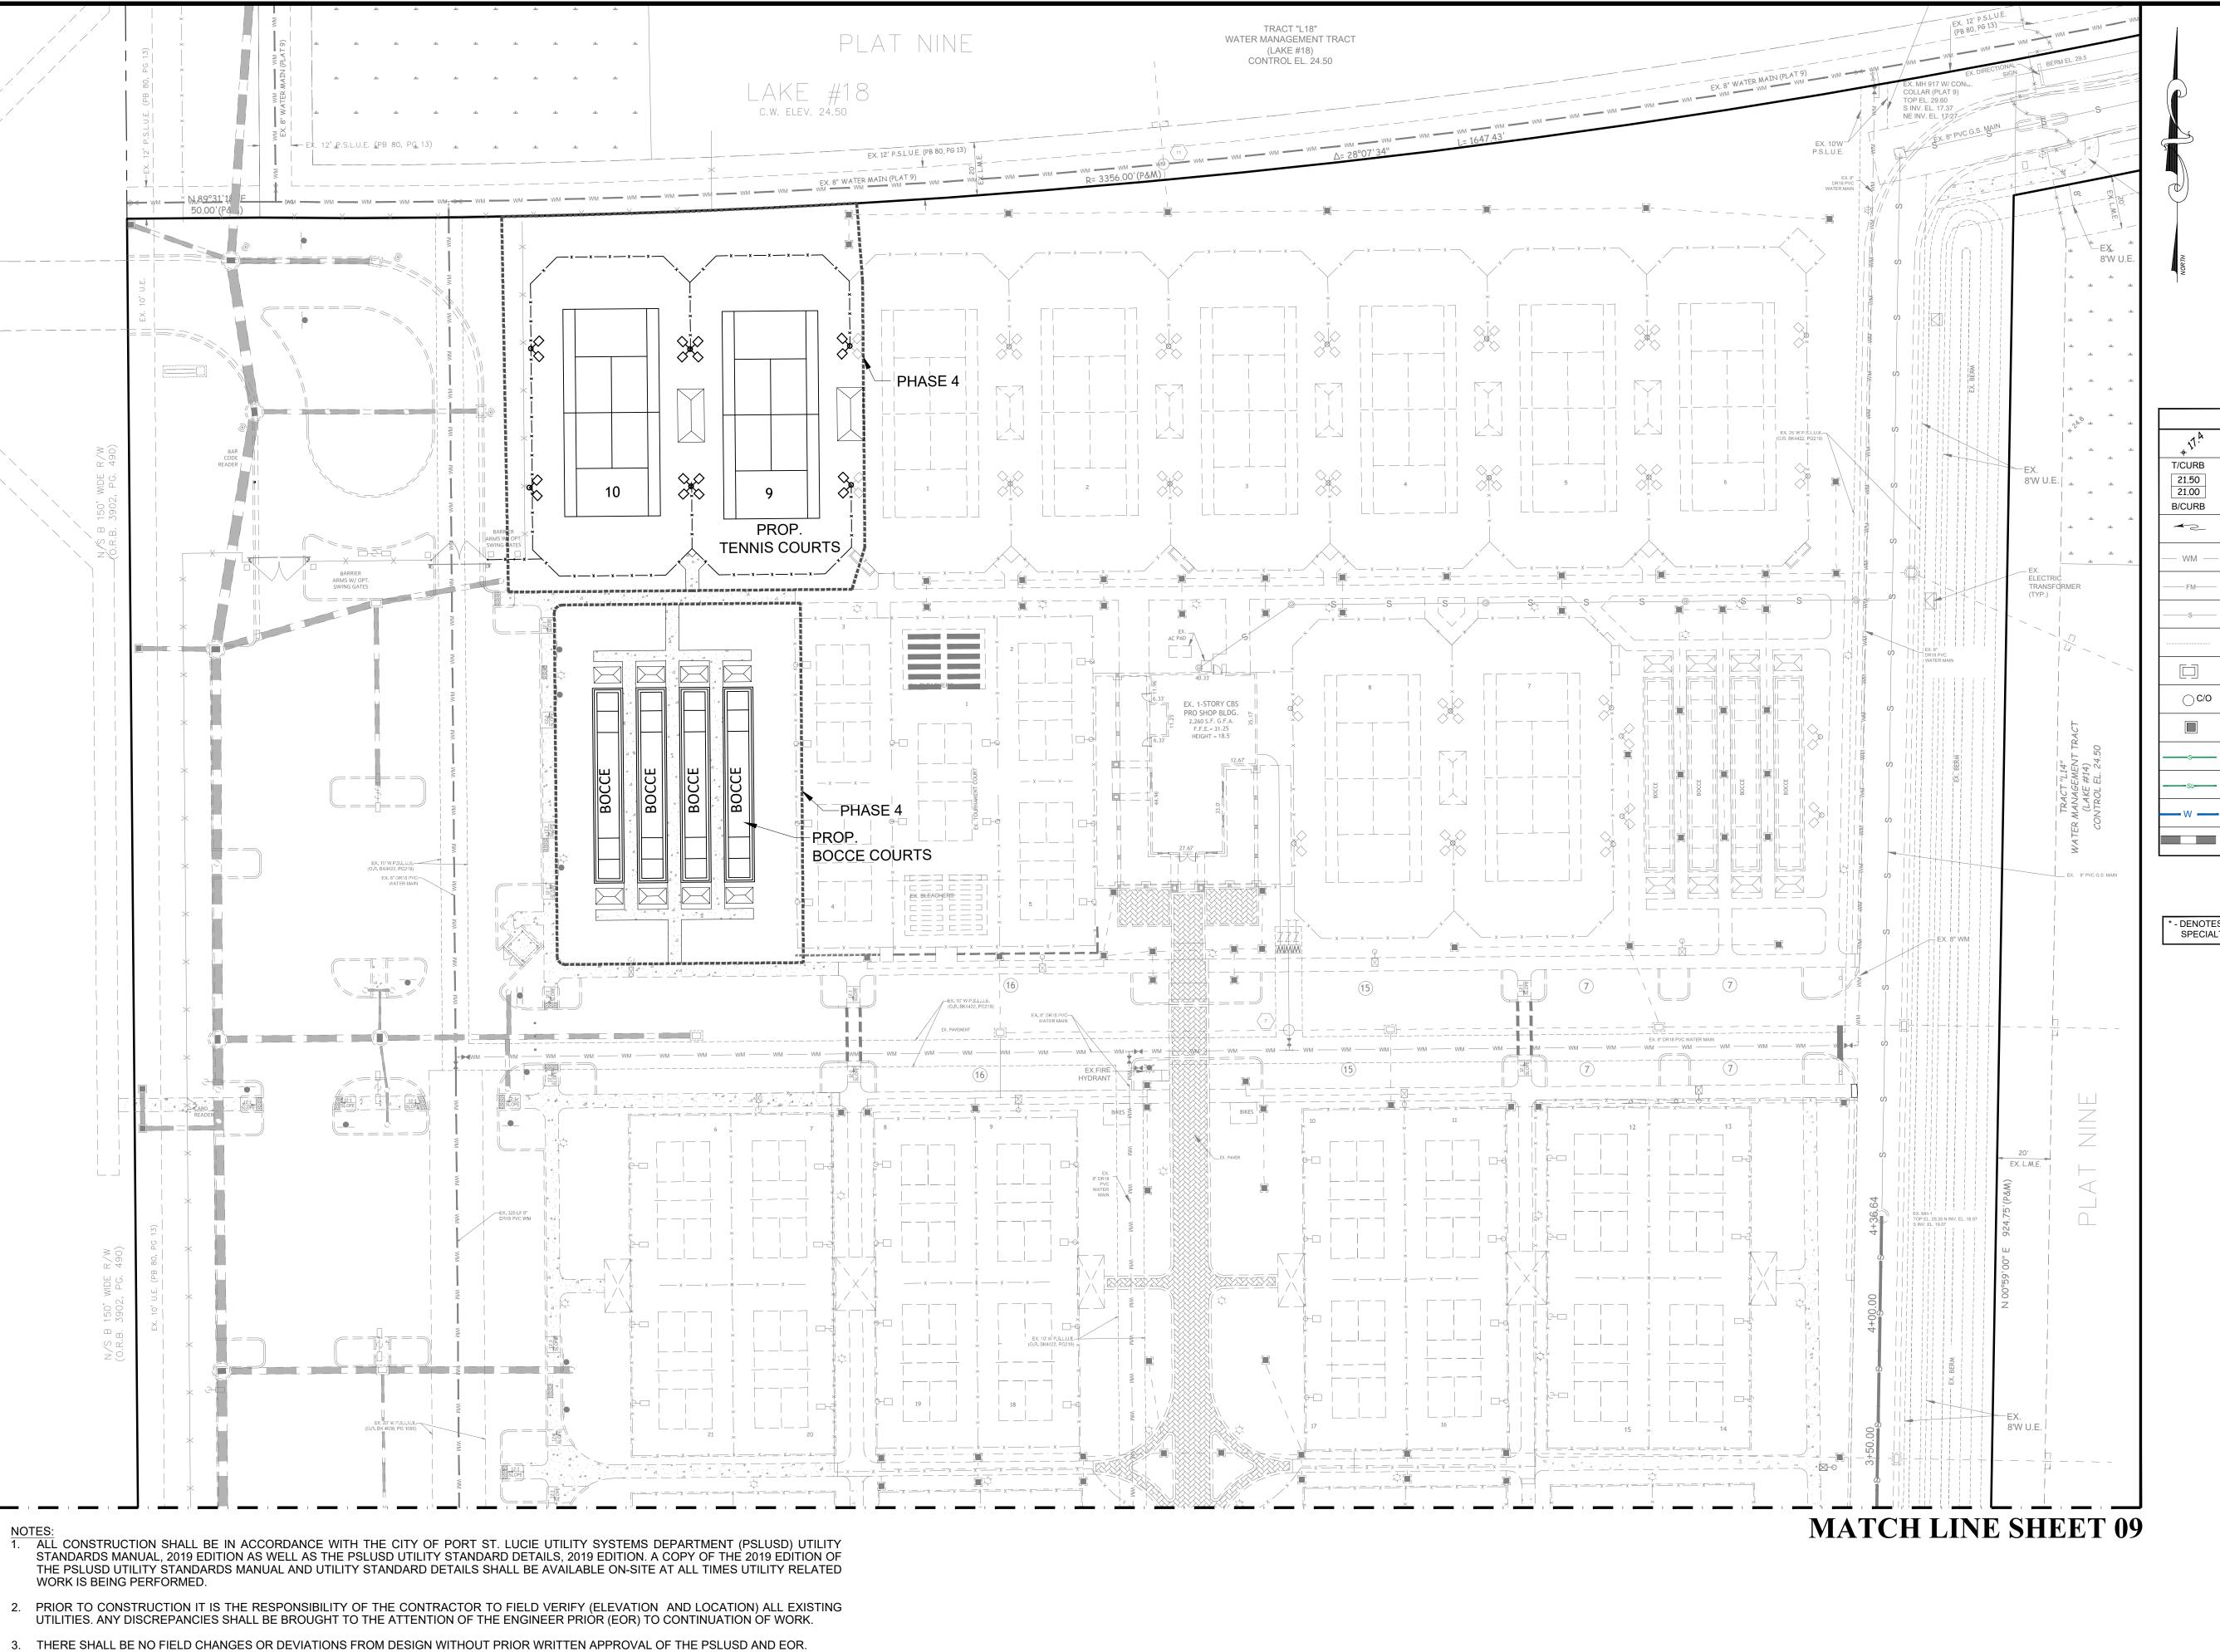

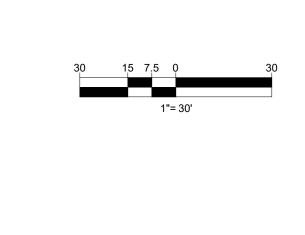

LEGEND EXISTING GRADE PROPOSED ASPHALT ELEVATION PAVEMENT PROPOSED CONCRETE PROPOSED ELEVATION SIDEWALK PROPOSE ADA DETECTABLE (H.P. = HIGH POINT) WARNING CHARCOAL GRAY DRAINAGE EASEMENT DIRECTION EXISTING WATER MAIN LANDSCAPE BUFFER LAKE MAINTENANCE EXISTING FORCE MAIN ACCESS EASEMENT EXISTING GRAVITY LAKE MAINTENANCE SEWER MAIN EASEMENT P.S.L.U.E. CITY OF PORT ST. LUCIE UTILITY EASEMENT EXISTING EDGE OF PAVEMENT PROPOSED CATCH UTILITY EASEMENT PROPOSED LIGHT FIXTURE ○ C/O | PROPOSED CLEAN OUT TYPE SA 20' HEIGHT PROPOSED LIGHT FIXTURE PROPOSED YARD DRAIN TYPE SB 25' HEIGHT PROPOSED GRAVITY PROPOSED LIGHT FIXTURE  $\Box$ SEWER MAIN TYPE SC 20' HEIGHT PROPOSED BLDG. PROPOSED LIGHT FIXTURE SEWER TYPE SC3 10' HEIGHT PROPOSED LIGHT FIXTURE PROPOSED WATER SERVICE TYPE SC4 10' HEIGHT PROPSED STORM SEWER

\* - DENOTES INSTALLATION BY SPECIALTY CONTRACTOR

1449 NW COMMERCE CENTRE DR PORT ST. LUCIE, FL 34986 PHONE: (772) 879-0477 FBPE C.O.A. # 32222

SG 03-07-23

COMMENT:

REVISED PER

SPRC COMMENTS REVISED PER SPRC COMMENTS

DARREN GUETTLER, PE FLORIDA LICENSE No. 74637

DRAWN BY: CHECKED BY: 22- 1037 - WS PLAN

WATER AND


**SEWER PLAN** 


CITY OF PSL PROJECT NO. P20-068-A5 PSLUSD FILE NO. 5203I-4

KNOW WHAT'S BELOW ALWAYS CALL 811 BEFORE YOU DIG It's fast. It's free. It's the law.

www.callsunshine.com

- 4. ELEVATIONS ALL ELEVATIONS REFER TO NORTH AMERICAN VERTICAL DATUM OF 1988 (NAVD88).
- 5. ALL WATER AND WASTEWATER PRESSURE MAINS SHALL BE PVC, C-900, DR18 (PRESSURE CLASS 235).
- 6. ALL GRAVITY SEWER PIPE, FITTINGS AND SERVICE LINES SHALL BE PVC, SDR 26 AND, AS A MINIMUM, CONFORM TO ASTM D-3034. FOR DEPTHS GREATER THAN 15', THE PIPE, JOINTS AND FITTINGS SHALL MEET THE SPECIFICATIONS FOR PRESSURE MAINS.
- VALVES SHALL NOT BE PLACED IN CURBS, GUTTERS, SIDEWALKS, PARKING SPACES AND HANDICAP RAMPS. WHERE CONCRETE VALVE PADS TO BE OWNED BY PSLUSD ARE ADJACENT TO SIDEWALKS, THE PADS SHALL BE POURED AS PART OF THE SIDEWALK POUR WITH NO JOINTS.
- PRIOR TO FINAL CERTIFICATION AND THE ASSURANCE OF FINAL WATER METERS FOR THIS PLAT, THE WATER MAIN SHALL BE LOOPED.

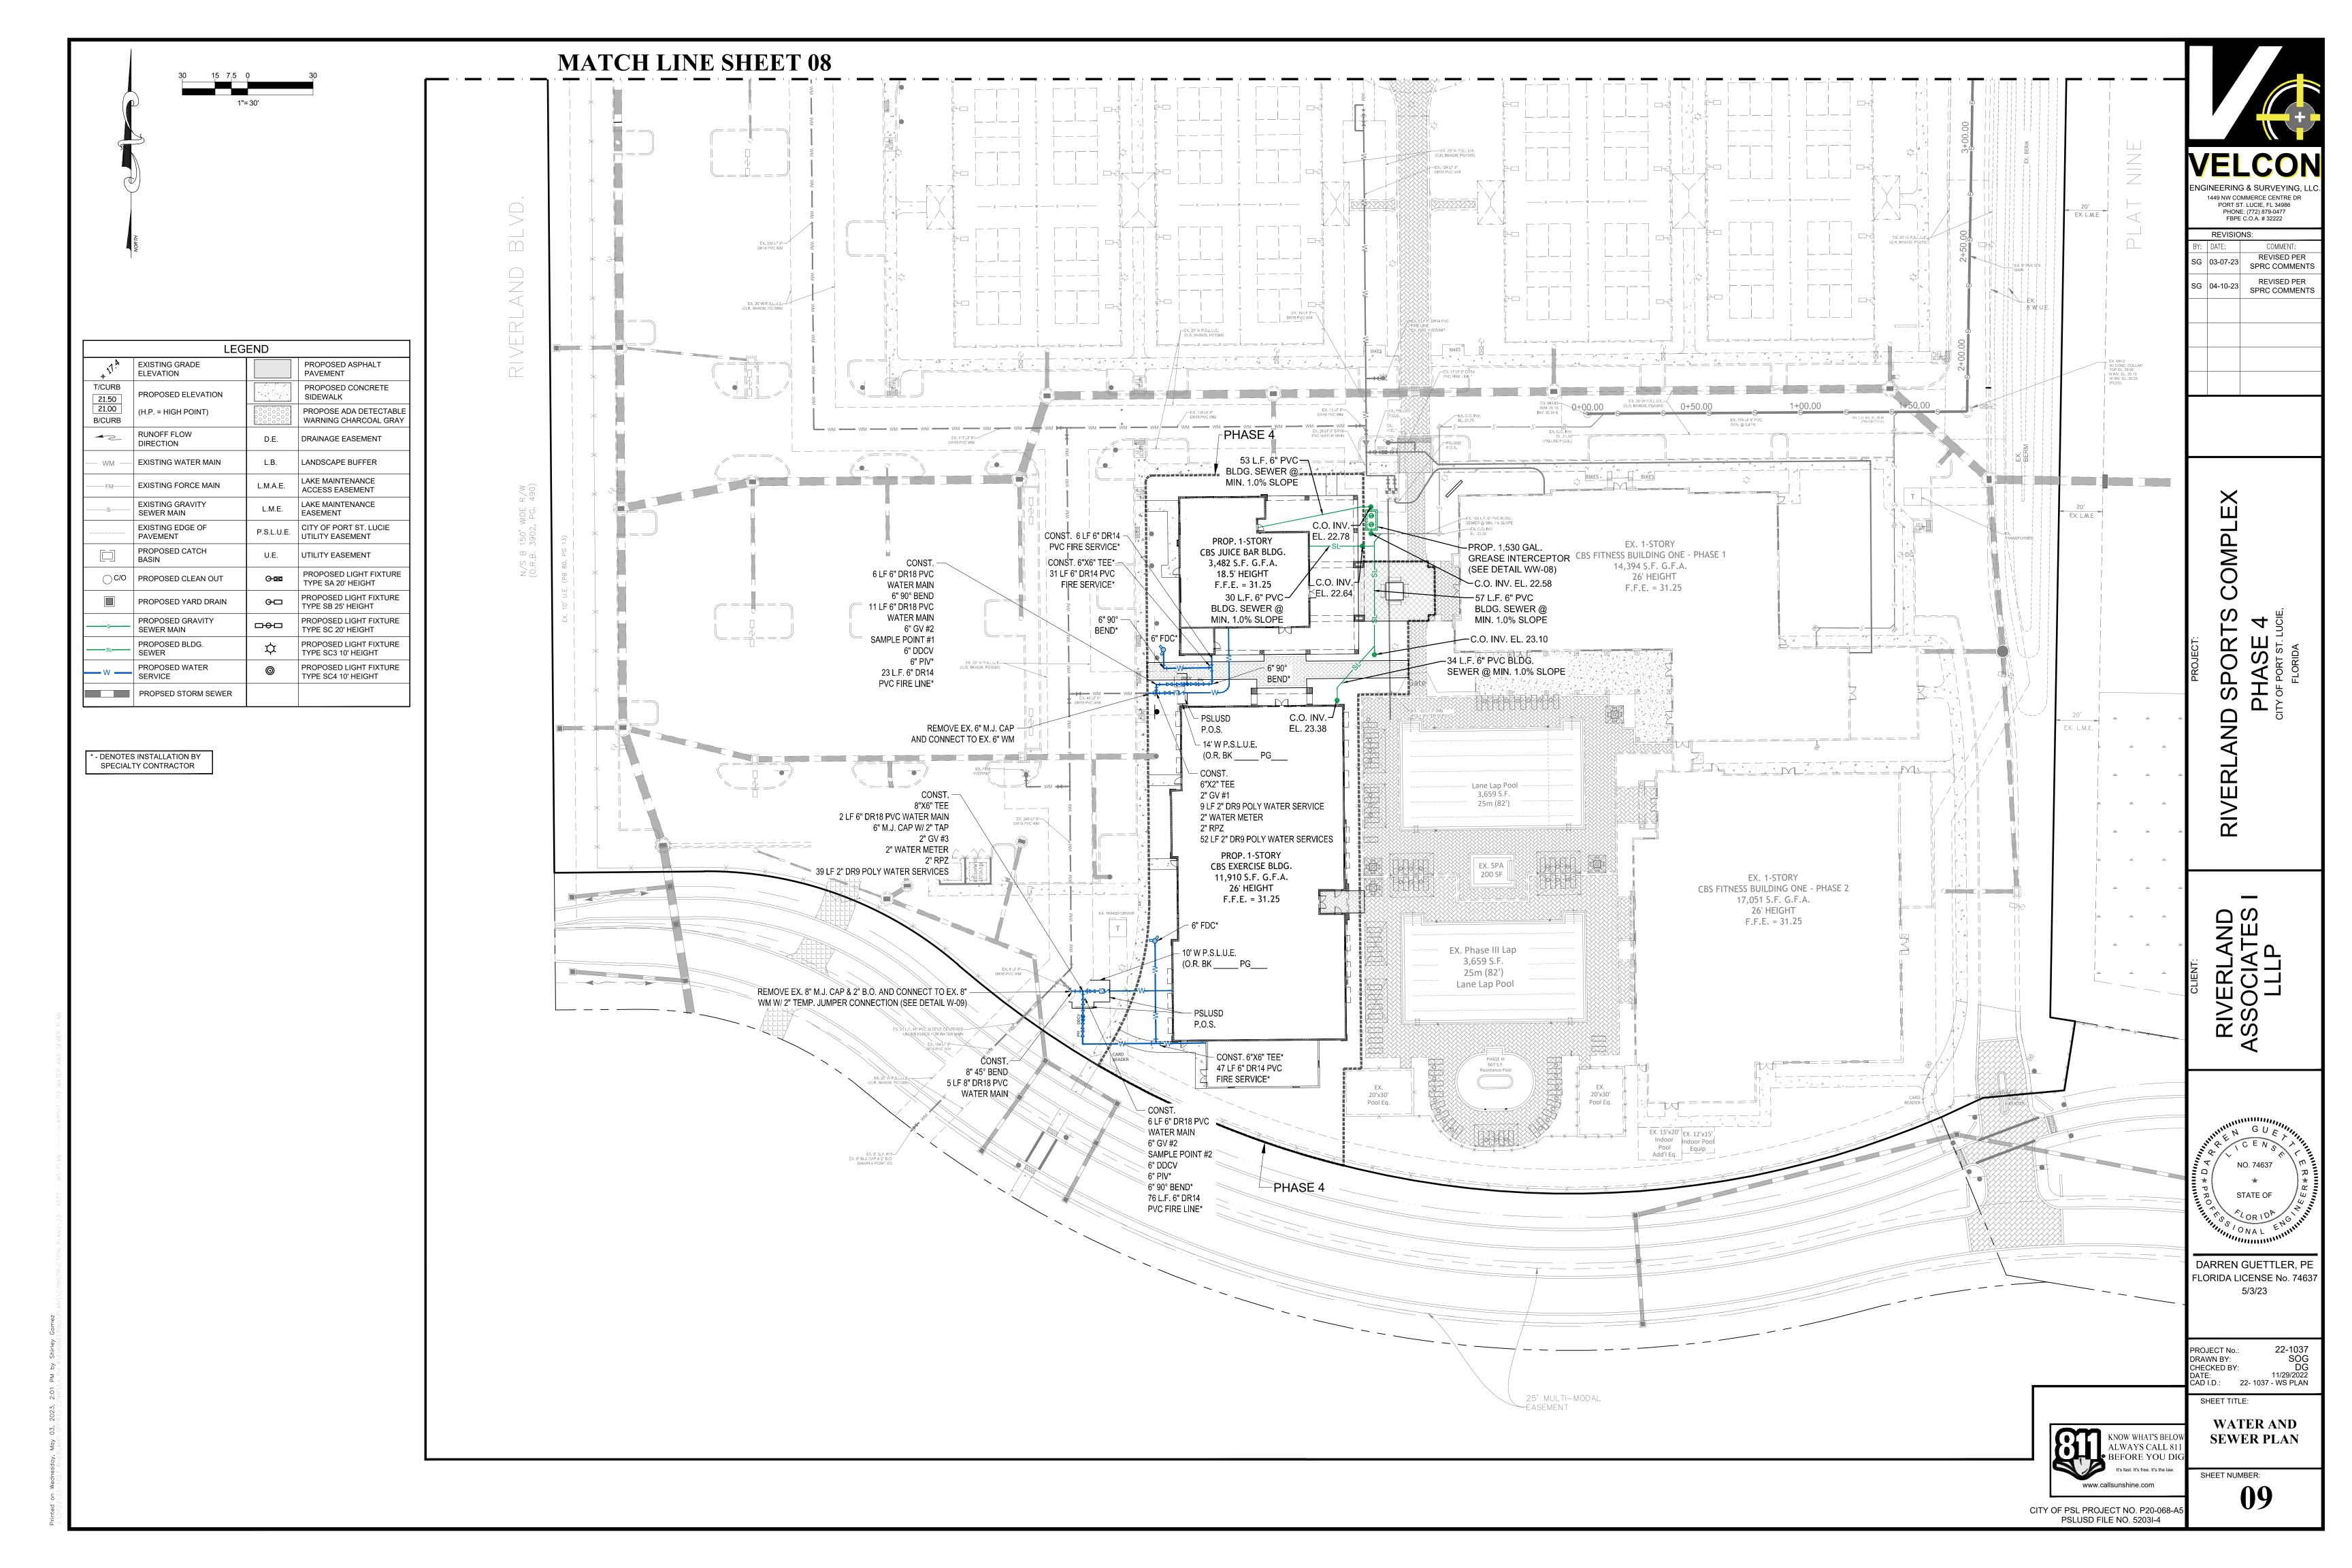

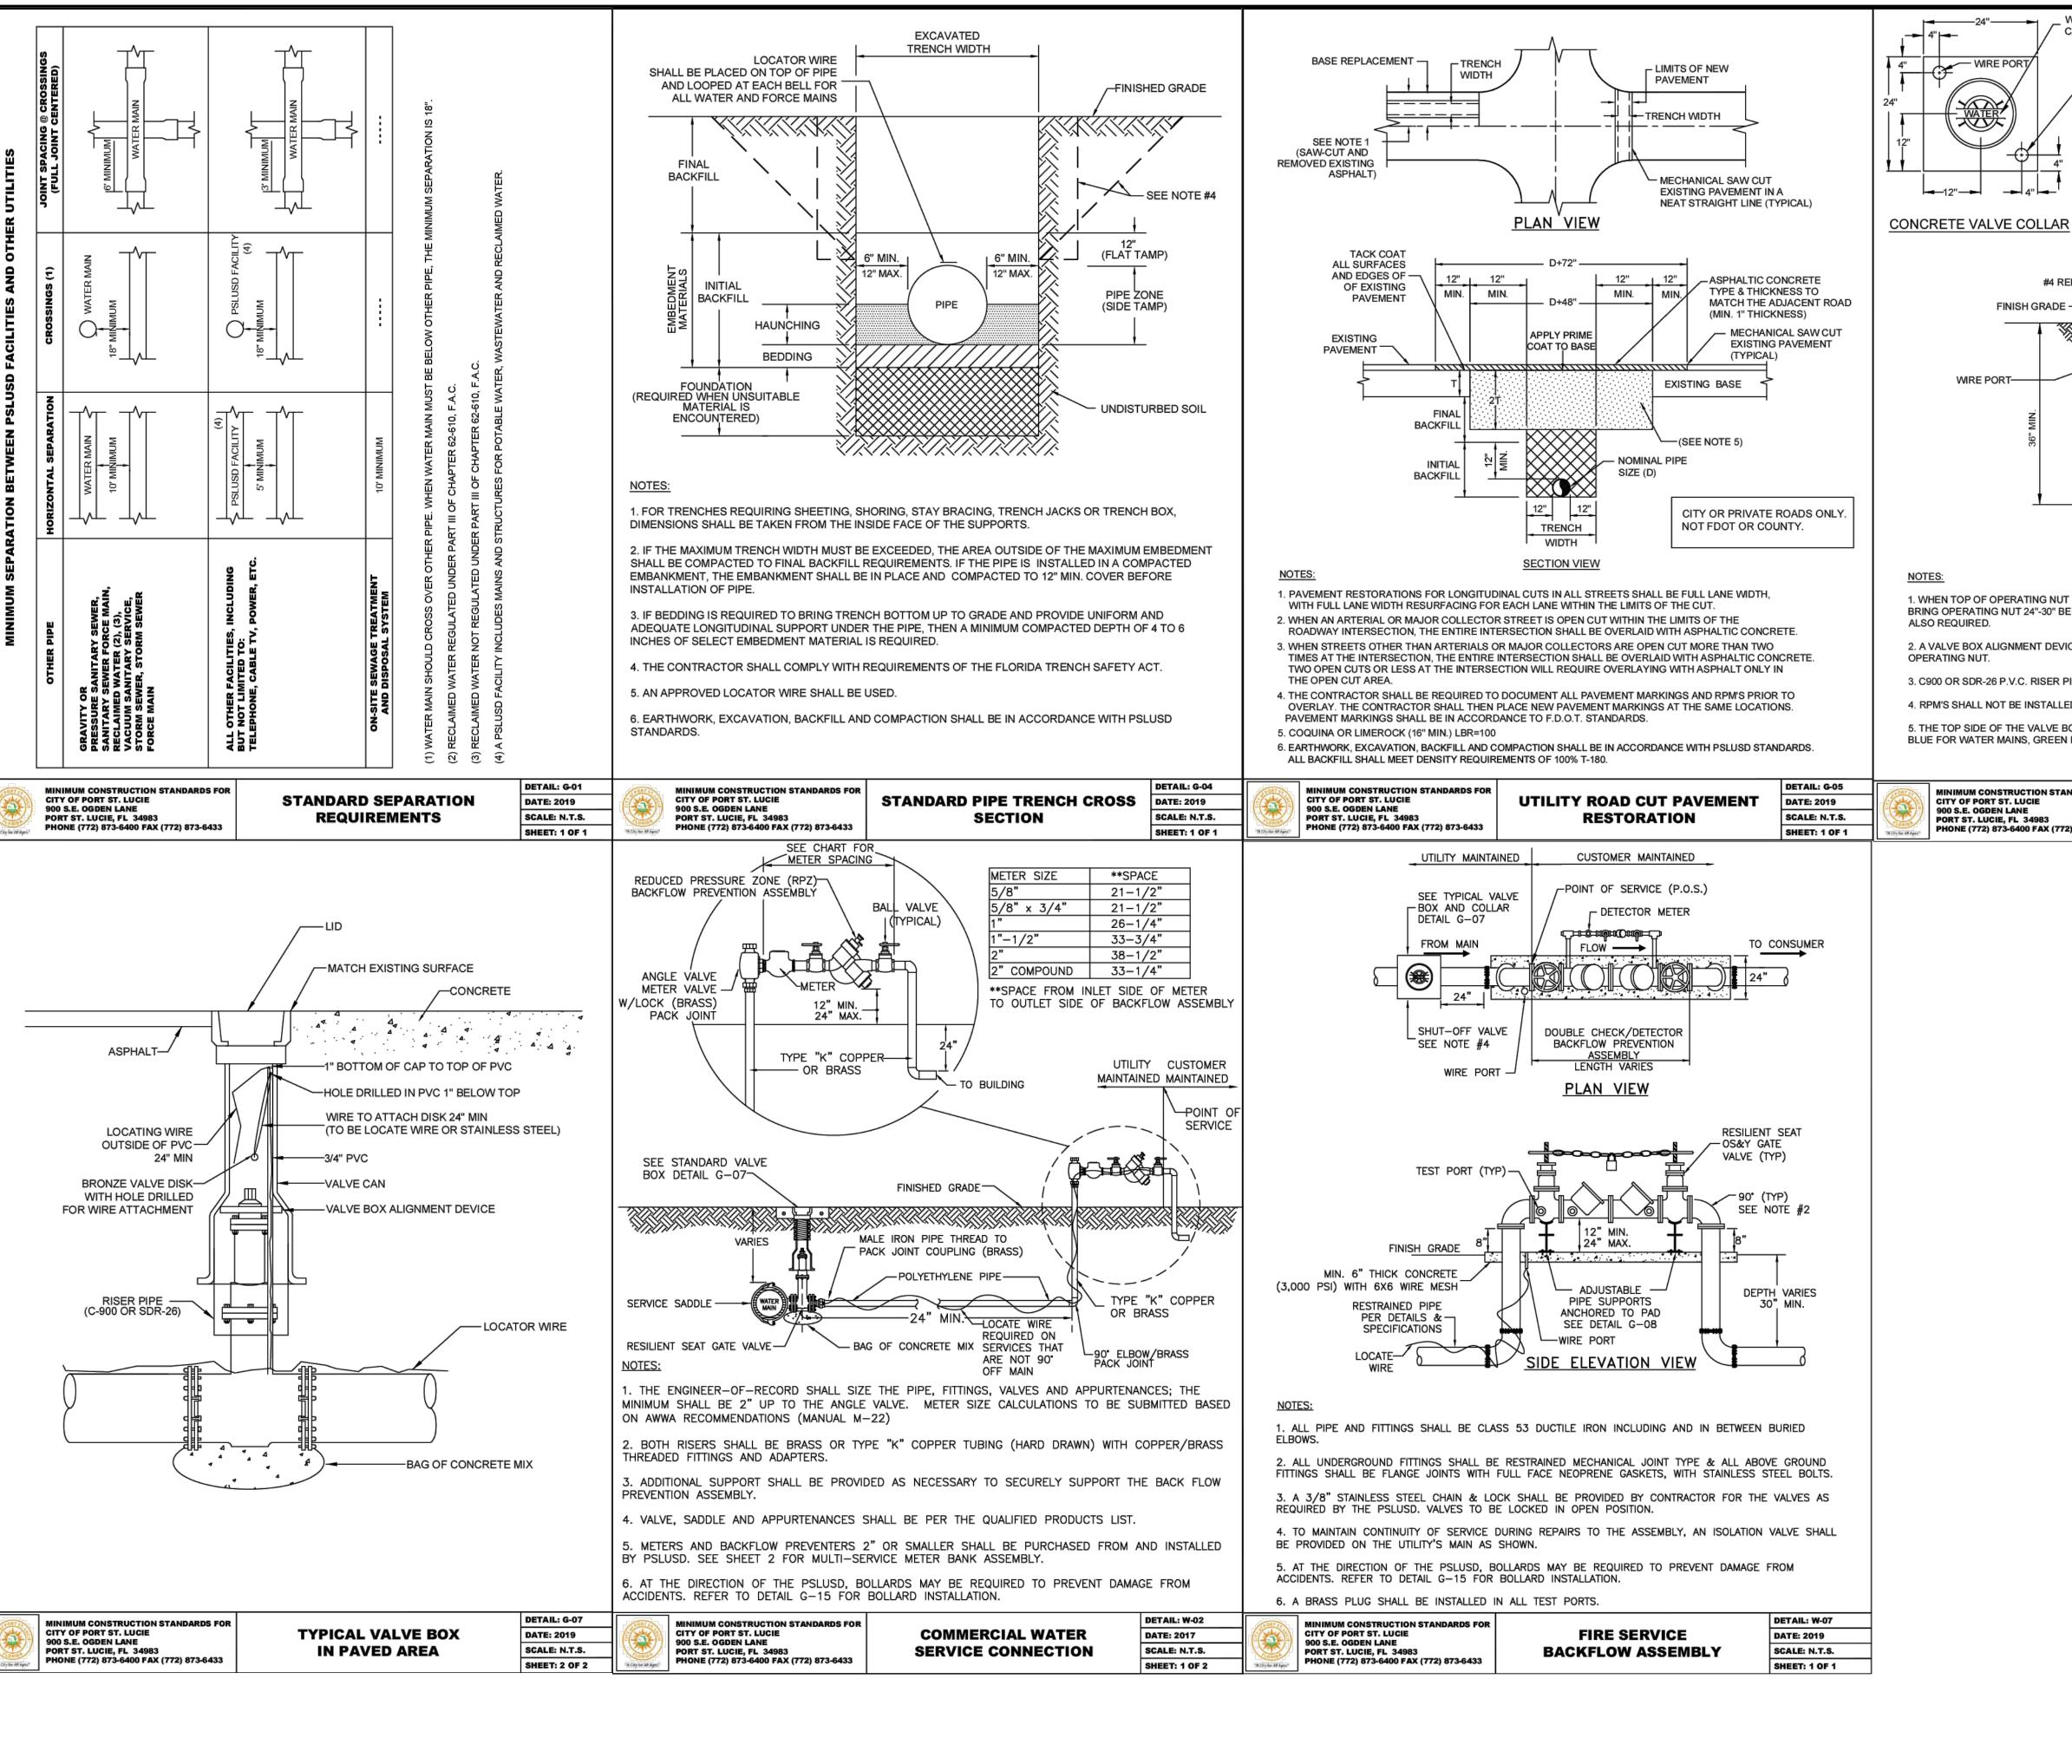

CAST IN COVER AS APPLICABLE 3"Ø X 4" THICK BRONZE DISC ANCHORED IN CONCRETE PAD WITH ANCHOR DISPLAYING 16" DEEP LETTERS CAST INTO DISC STATING NUMBER OF TURNS TO OPERATE & **SCHEMATICALLY IDENTIFIED MAIN & VALVE LOCATION** ALL LETTERS AND NUMBERS MUST BE LEGIBLE UTILIZING ARIAL FONT -LETTERS - SQUARE CUT, LEGIBLE PIN FOR ANCHOR CAST IRON VALVE BOX VALVE BOX ALIGNMENT DEVICE (SEE NOTE #2) BAG OF CONCRETE MIX

- 1. WHEN TOP OF OPERATING NUT IS DEEPER THAN 30", A HIGH STRENGTH STEEL EXTENSION WILL BE REQUIRED TO BRING OPERATING NUT 24"-30" BELOW FINISHED GRADE. A STEEL CENTERING PLATE, WELDED TO THE EXTENSION, IS
- 2. A VALVE BOX ALIGNMENT DEVICE SHALL BE PROVIDED TO ELIMINATE SHIFTING OF THE VALVE BOX AGAINST THE
- 3. C900 OR SDR-26 P.V.C. RISER PIPE SHALL BE ADDED TO EXTEND THE VALVE BOX IF NEEDED.

WATER, SEWER OR REUSE

-WM, FM, IQ, WHICH

24" X 24" X 6" THICK

- CONCRETE COLLAR

**EVER APPLIES** 

#4 REBAR -

4. RPM'S SHALL NOT BE INSTALLED IN CROSSWALKS OR PEDESTRIAN WALKWAYS.

LOCATOR-

RISER PIPE

5. THE TOP SIDE OF THE VALVE BOX COVER AND THE INSIDE OF TOP SECTION OF THE VALVE BOX SHALL BE PAINTED BLUE FOR WATER MAINS, GREEN FOR SEWER MAINS AND PURPLE FOR RECLAIMED WATER MAINS.

MINIMUM CONSTRUCTION STANDARDS FOR CITY OF PORT ST. LUCIE 900 S.E. OGDEN LANE PORT ST. LUCIE, FL 34983 PHONE (772) 873-6400 FAX (772) 873-643

TYPICAL VALVE BOX AND COLLAR IN UN-PAVED AREA

DETAIL: G-07 DATE: 2019 SCALE: N.T.S. SHEET: 1 OF 2

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1449 NW COMMERCE CENTRE DR

PORT ST. LUCIE, FL 34986

FBPE C.O.A. # 32222

COMMENT:

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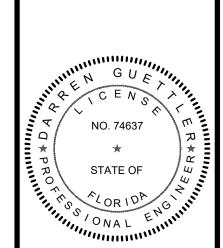
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PHONE: (772) 879-0477

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DARREN GUETTLER, PI FLORIDA LICENSE No. 74637 5/3/23

PROJECT No. DRAWN BY:

CHECKED BY:

CAD I.D.: 22- 1037 - WS DETAILS SHEET TITLE:

WATER AND

SEWER DETAILS

SHEET NUMBER:


CITY OF PSL PROJECT NO. P20-068-A

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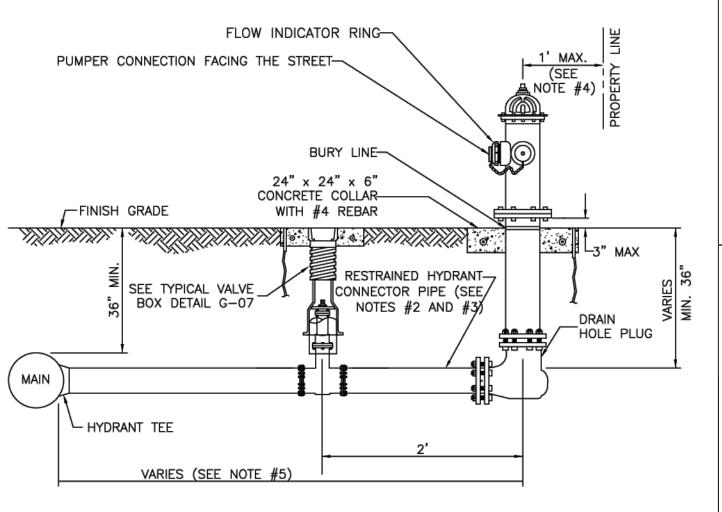
**DETAIL: W-05** 

**DATE: 2019** 

- SAMPLING POINTS SHALL BE LOCATED AS SHOWN ON PLANS APPROVED BY PSLUSD AND AS REQUIRED BY FLORIDA DEPARTMENT OF ENVIRONMENTAL PROTECTION. A SAMPLE POINT MAP (SINGLE SHEET PDF) SHALL BE SUBMITTED TO PSLUSD FOR REVIEW PRIOR TO DISINFECTION.
- 2. THE EXCAVATED HOLE FOR THIS INSTALLATION SHALL BE BACKFILLED TO FINISHED GRADE PRIOR TO DISCHARGING ANY WATER ON THE GROUND.
- AFTER BACTERIOLOGICAL CLEARANCE IS RECEIVED, THE CONTRACTOR SHALL TURN CORPORATION STOP OFF, REMOVE TUBING AND PLUG CORPORATION STOP WITH BRASS PLUG/CAP.
- NO DIRECT TAPS SHALL BE PERMITTED.

CITY OF PORT ST. LUCIE

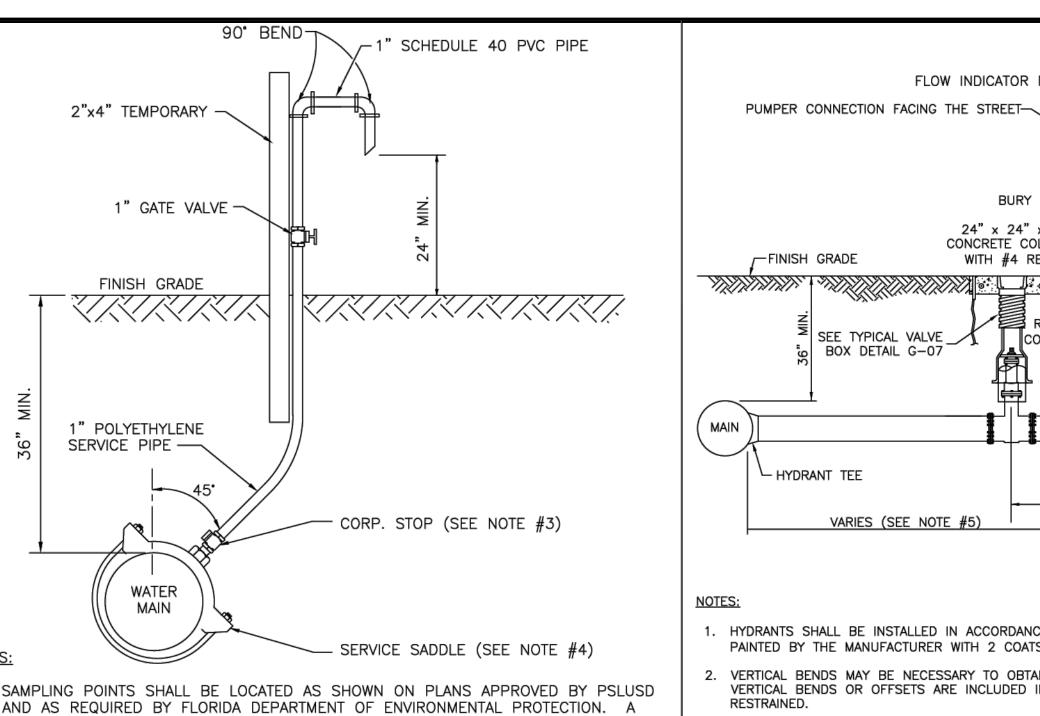900 S.E. OGDEN LANE



- 1. HYDRANTS SHALL BE INSTALLED IN ACCORDANCE WITH ANSI/AWWA C600. THE HYDRANTS SHALL BE PAINTED BY THE MANUFACTURER WITH 2 COATS (MIN.).
- 3. CONNECTOR PIPE AND ANY REQUIRED VERTICAL BENDS SHALL HAVE AN ANCHORING FEATURE ON BOTH ENDS SO THAT WHEN USED WITH M.J. SPLIT GLANDS, A RESTRAINED JOINT IS PROVIDED.
- 4. WHEN INSTALLED WITH SIDEWALK OR CURB, PROVIDE MIN. 2 FOOT CLEARANCE TO ANY PORTION OF
- 5. A GATE VALVE SHALL BE INSTALLED WITHIN 2 FEET OF THE FIRE HYDRANT. IF DISTANCE FROM THE WATER MAIN TO THE FIRE HYDRANT IS GREATER THAN 20 FEET, A SECOND GATE VALVE SHALL

#### **TEMPORARY JUMPER** MINIMUM CONSTRUCTION STANDARDS FOR CITY OF PORT ST. LUCIE CONNECTION 900 S.E. OGDEN LANE PORT ST. LUCIE, FL 34983 PHONE (772) 873-6400 FAX (772) 873-6433

- JUMPER ASSEMBLY

- EXISTING MAIN

SEE NOTE #1 NEW MAIN

CONTRACTOR

REDUCED PRESSURE

THREADED NIPPLE (TYP)-

PRESSURE GAUGE

GRADE \

POLYETHYLENE TO THE POLYETHYLENE

2" DOUBLE STRAP \_


SERVICE SADDLE

EXISTING WATER MAIN

ZONE ASSEMBLY-

2" ANGLE VALVE

2" METER—

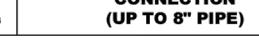

EXISTING MAIN -

CONTRACTOR

-BALL VALVE (TYP)

r2" ANGLE VALVE

-UNISTRUT

ALL PIPES AND APPURTENANCES TO BE 2" FOR NEW MAINS UP TO 8"

FOR MAINS OVER 8". ALL PIPES AND APPURTENANCES TO BE SIZED

AND DESIGNED BY THE ENGINEER OF RECORD.

INSTALLED

DETAIL: W-09 DATE: 2019 SCALE: N.T.S. SHEET: 1 OF 2

---POLYETHYLENE

2" DOUBLE STRAP


SERVICE SADDLE

2" BRASS CORP. STOP

- NEW WATER MAIN

CONNECTION


DATE: 2019 SCALE: N.T.S. SHEET: 2 OF 2

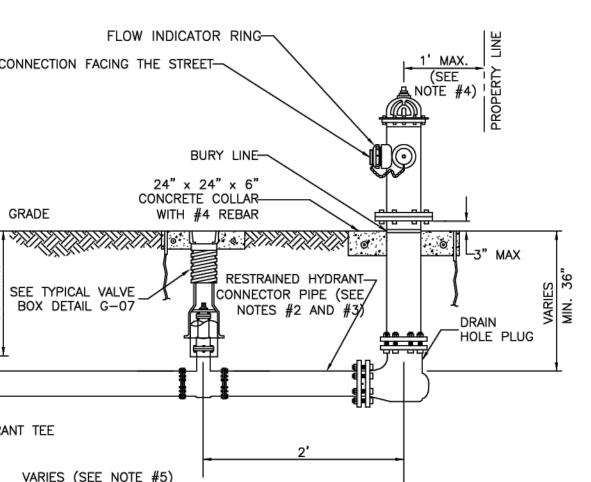

- VERTICAL BENDS MAY BE NECESSARY TO OBTAIN COVER UNDER SWALES OR AT HYDRANT LOCATION. VERTICAL BENDS OR OFFSETS ARE INCLUDED IN HYDRANT ASSEMBLY. ALL BENDS MUST BE
- THE HYDRANT, UTILIZING THE SIDE LOT EASEMENT IF NECESSARY
- BE INSTALLED WITHIN 2 FEET OF THE MAIN.
- 6. ANY DEVIATIONS FROM THE CRITERIA ABOVE REQUIRE A WRITTEN RECOMMENDATION FROM THE ENGINEER-OF-RECORD AND WRITTEN APPROVAL BY PSLUSD.

TOP VIEW

FIRE HYDRANT ASSEMBLY

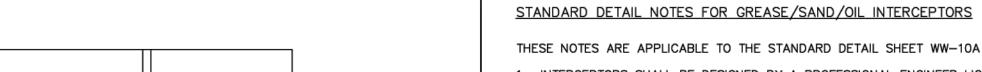

**DETAIL: W-06** 

SCALE: N.T.S.

SHEET: 1 OF 1

DATE: 2019

1. INTERCEPTORS SHALL BE DESIGNED BY A PROFESSIONAL ENGINEER LICENSED IN FLORIDA, IN ACCORDANCE WITH PSLUSD GREASE/OIL/SAND INTERCEPTOR POLICY, APPLICABLE BUILDING CODES AND STATE REGULATIONS. AN APPROVAL MUST BE OBTAINED FROM PSLUSD PRIOR TO INSTALLATION. DEVIATIONS SHALL NOT BE MADE WITHOUT PRIOR APPROVAL.

PHYSICAL

SEPARATION

SEE NOTE

**ELEVATION VIEW** 

2. THE INTERCEPTOR SHALL BE BUILT OF PRE-CAST CONCRETE WITH A MINIMUM OF 4" THICK WALLS AND WITH PRE-CAST HOLES FOR THE INLET/OUTLET PIPES. SHOP DRAWINGS SHALL BE SUBMITTED TO THE PSLUSD FOR APPROVAL IF THE TANK IS NOT ON THE APPROVED QUALIFIED PRODUCTS LIST (QPL).

ALL PIPING SHALL BE A MINIMUM OF 4" PVC.

4. THE INLET AND OUTLET TEES SHALL BE LOCATED NO MORE THAN 4" FROM END OF THE TANK AND SHALL BE IN ACCORDANCE WITH ASTM C923-98, LATEST REVISION. THE INLET INVERT LEVEL SHALL BE A MINIMUM OF 21/2" ABOVE THE WATER LEVEL. THE INLET TEE IS NOT REQUIRED FOR SAND/OIL INTERCEPTORS, HOWEVER, IF USED IT SHALL NOT EXTEND MORE THAN 12" BELOW THE WATER LEVEL. THE OUTLET TEE SHALL EXTEND TO WITHIN 8" OF THE TANK BOTTOM. THE TEES SHALL BE SECURED TO THE TANK WALL AS PER DETAIL SUBMITTED BY THE ENGINEER-OF-RECORD AND APPROVED

THE LIQUID DEPTH SHALL BE AT LEAST 42".

6. INSPECTION PORTS (TWO-WAY CLEAN-OUTS) SHALL BE INSTALLED ON EACH END OF THE INTERCEPTOR, WHICH ARE EASILY ACCESSIBLE FOR INSPECTION/SAMPLING.

7. A BAFFLE SHALL BE INSTALLED ½ (ONE-HALF) TO ¾ (TWO-THIRDS) 'D' FROM THE INLET SIDE. THE FLOW BETWEEN THE TWO COMPARTMENTS SHALL BE THROUGH AN 8" DIAMETER HOLE IN THE BAFFLE; THE HOLE SHALL BE LOCATED 12" FROM THE TANK BOTTOM FOR A GREASE INTERCEPTOR AND 16" TO 20" FOR A SAND/OIL INTERCEPTOR. A BAFFLE IS NOT REQUIRED IF MULTIPLE INTERCEPTORS ARE INSTALLED IN SERIES, HOWEVER, INSPECTION PORTS SHALL BE INSTALLED ON EACH END OF THE INTERCEPTORS.

8. THE MINIMUM EFFECTIVE CAPACITY OF THE TANK SHALL BE AS REQUIRED BY THE PSLUSD. INSTALLATION OF MULTIPLE TANKS SHALL BE IN SERIES. WHEN MULTIPLE TANKS ARE USED THERE SHALL BE A MINIMUM 4' SEPARATION BETWEEN TANKS WITH THE REQUIRED INSPECTION PORT INSTALLED IN THE CENTER.

9. THE LID SHALL BE AT LEAST 8" THICK. TRAFFIC LIDS SHALL BE DESIGNED IN ACCORDANCE WITH ASTM C890-91, LATEST REVISION.

10. INTERCEPTOR SHALL BE PROVIDED WITH A MANHOLE OVER EACH COMPARTMENT FOR ACCESS. THE MANHOLES SHALL BE BROUGHT TO GRADE AND FITTED WITH COVERS AS SPECIFIED IN THE DETAIL.

11. A CONCRETE COLLAR SHALL BE PROVIDED AROUND THE COVERS AND SANITARY SEWER CLEANOUT BOX WHEN THE INTERCEPTOR IS LOCATED IN AN UNPAVED AREA. GROUND SHALL BE SLOPED AWAY FROM THE INTERCEPTOR TO PREVENT PONDING OF STORM WATER.

12. ALL JOINTS, INCLUDING MID-SEAMS, RISERS AND LIDS SHALL BE SEALED JOINTS AROUND THE RISER AND THE TANK SHALL BE SEALED AND MADE WATERTIGHT.

13. INSTALLATION OF THE INTERCEPTOR AND ITS COMPONENTS SHALL BE PERFORMED BY A LICENSED PLUMBER OR SEPTIC TANK CONTRACTOR REGISTERED WITH THE FLORIDA DEPARTMENT OF HEALTH.

14. INSPECTIONS ARE REQUIRED BY PSLUSD AS PER THE UTILITY STANDARDS. AN INITIAL INSPECTION IS REQUIRED WITH THE TANK ABOVE GROUND.

NOTES: SEE SHEET 2 MINIMUM CONSTRUCTION STANDARDS FOR CITY OF PORT ST. LUCIE

(SEE NOTE #4)

SECTION VIEW

**DETAIL: WW-10** MINIMUM CONSTRUCTION STANDARDS FOR CITY OF PORT ST. LUCIE DATE: 2019 SCALE: N.T.S. PORT ST. LUCIE, FL 34983 PHONE (772) 873-6400 FAX (772) 873-6433 SHEET: 1 OF 2

**GREASE, OIL, AND SAND** INTERCEPTOR

r JUMPER ASSEMBLY

ALTERNATE

\* FLANGED FITTINGS

(TYP)

NOTES:

- 1. A TEMPORARY JUMPER CONNECTION IS REQUIRED AT ALL CONNECTIONS BETWEEN EXISTING ACTIVE PSLUSD WATER MAINS AND PROPOSED NEW WATER MAINS. A PHYSICAL SEPARATION SHALL BE MAINTAINED, EXCEPT AS NOTED IN #5 BELOW. THE PROCEDURES ARE APPLICABLE WHEN CONNECTING TO AN EXISTING PSLUSD WATER MAIN, WHETHER BY TAPPING TEE AND VALVE OR BY CONTINUATION OF A PLUGGED STUB OUT WITH AN EXISTING GATE
- 2. THE CONTRACTOR SHALL CONTACT THE PSLUSD REGARDING SCHEDULING OF REQUIRED INSPECTIONS RELATING WATER MAINS, JUMPER INSTALLATION, FLUSHING, PRESSURE TESTING, DISINFECTION, SAMPLING, PLUGGING OF SAMPLING POINTS AND PERMANENT CONNECTION OF THE NEW WATER MAIN. THE CONTRACTOR SHALL FOLLOW
- ALL PROCEDURES STRICTLY IN ACCORDANCE WITH THE PSLUSD UTILITY STANDARDS MANUAL. . THE TEMPORARY JUMPER ASSEMBLY (FLANGE TO FLANGE) WILL BE SUPPLIED, INSTALLED AND TESTED BY THE PSLUSD, IN COORDINATION WITH THE ENGINEER OF RECORD AND CONTRACTOR. OTHER MATERIALS AND UNDERGROUND FITTINGS SHALL BE RESTRAINED MECHANICAL JOINT TYPE, ALL MATERIALS SHALL BE PER THE

PSLUSD APPROVED QUALIFIED PRODUCTS LIST. THE JUMPER CONNECTION SHALL BE MAINTAINED BY THE


- CONTRACTOR UNTIL THE ASSEMBLY IS REMOVED BY THE PSLUSD. 4. ALL NEW WATER MAINS SHALL BE DOUBLE-PIGGED, FLUSHED, PRESSURE TESTED AND DISINFECTED. NEW MAIN SHALL NOT BE PLACED INTO SERVICE UNTIL THE BACTERIOLOGICAL TEST RESULTS ARE SATISFACTORY AND A
- . A PHYSICAL SEPARATION SHALL BE MAINTAINED BETWEEN THE EXISTING MAIN AND NEW MAIN, EXCEPT AS NOTED HEREIN. IF THE NEW MAIN IS OF A SIZE OR LENGTH THAT PIGGING/FLUSHING CANNOT BE EFFECTIVELY ACCOMPLISHED WITH THE JUMPER CONNECTION, MORE THAN ONE JUMPER MAY BE USED AS DETERMNED BY THE
- EOR OR, THE PSLUSD MAY ALLOW A PHYSICAL CONNECTION UNDER CONTROLLED CONDITIONS AS FOLLOWS: a, THE PROCEDURE WILL BE CONDUCTED BY THE CONTRACTOR IN THE PRESENCE OF A PSLUSD INSPECTOR AND
- THE ENGINEER-OF-RECORD (EOR) OR REPRESENTATIVE. b. THE NEW VALVE(S) SHOWN IN THIS DETAIL SHALL BE PRESSURE/LEAKAGE TESTED AND REPLACED IF LEAKAGE IS OBSERVED, THE VALVES WILL BE KEPT CLOSED BY THE PSLUSD AND SHALL NOT BE OPERATED BY ANY ONE
- c. THE JUMPER CONNECTION SHALL BE USED TO FILL THE NEW MAIN. d. THE CONTRACTOR SHALL DISINFECT THE PIPE AND FITTINGS USED TO MAKE THE CONNECTION BY SPRAYING
- AND SWABBING WITH CHLORINE e. ALL VALVES IN THE NEW SYSTEM DOWNSTREAM OF THE JUMPER SHALL BE OPENED BY THE CONTRACTOR PRIOR TO FLUSHING. THE VALVES SHOWN IN THIS DETAIL SHALL BE OPENED BY PSLUSD PERSONNEL ONLY.
- f. THE PIGGING AND FLUSHING SHALL BE PERFORMED BY THE CONTRACTOR IN THE PRESENCE OF A PSLUSD INSPECTOR, THE VALVES WILL BE CLOSED BY PSLUSD PERSONNEL AFTER THE MAIN HAS BEEN FLUSHED. 5. THE WATER MAINS SHALL BE PRESSURE TESTED AFTER FLUSHING AND PRIOR TO DISINFECTION. ALL VALVES SHALL
- REMAIN CLOSED DURING THE PRESSURE TEST AND WILL NOT BE OPENED UNTIL THE RESULTS OF PRESSURE TESTING AND BACTERIOLOGICAL TESTING ARE SATISFACTORY AND THE SYSTEM HAS BEEN ACCEPTED FOR OPERATION BY THE PSLUSD.
- . DISINFECTION SHALL BE CONDUCTED IN ACCORDANCE WITH AWWA C651, A MINIMUM PRESSURE OF 20 PSI SHALL BE MAINTAINED IN THE NEW MAIN AFTER DISINFECTION.
- 8. CONNECTION TO EXISTING MAINS SHALL NOT BE MADE PRIOR TO BACTERIOLOGICAL CLEARANCE AND UNTIL APPROVED BY THE PSLUSD.
- D. UPON WRITTEN ACCEPTANCE OF BACTERIOLOGICAL CLEARANCE BY THE PSLUSD, THE SAMPLING POINTS CAN BE REMOVED AND PLUGGED BY THE CONTRACTOR, THE CONTRACTOR SHALL MAKE THE PERMANENT CONNECTION IN THE PRESENCE OF A PSILUSD INSPECTOR. UNLESS THE CONNECTION WAS PREVIOUSLY MADE AS INDICATED IN NOTE. 5D; THE PIPE AND FITTINGS FOR CONNECTION SHALL BE DISINFECTED BY SPRAYING AND SWABBING WITH CHLORINE, ONCE APPROVAL TO PLACE THE WATER SYSTEM INTO OPERATION HAS BEEN RECEIVED, THE JUMPER ASSEMBLY (FLANGE TO FLANGE) WILL BE REMOVED BY THE PSLUSD IN COORDINATION WITH THE CONTRACTOR. THE CONTRACTOR SHALL REMOVE THE REST OF THE JUMPER CONNECTION PIPING AND PLUG THE CORPORATION STOP VALVES.
- 10. ABANDONED TAP LOCATIONS TO BE SHOWN ON THE AS-BUILTS.

WRITTEN APPROVAL HAS BEEN OBTAINED FROM THE PSLUSD.

MINIMUM CONSTRUCTION STANDARDS FO CITY OF PORT ST. LUCIE 900 S.E. OGDEN LANE PORT ST. LUCIE, FL 34983 PHONE (772) 873-6400 FAX (772) 873-6433

**TEMPORARY JUMPER** 

**DETAIL: W-09** 

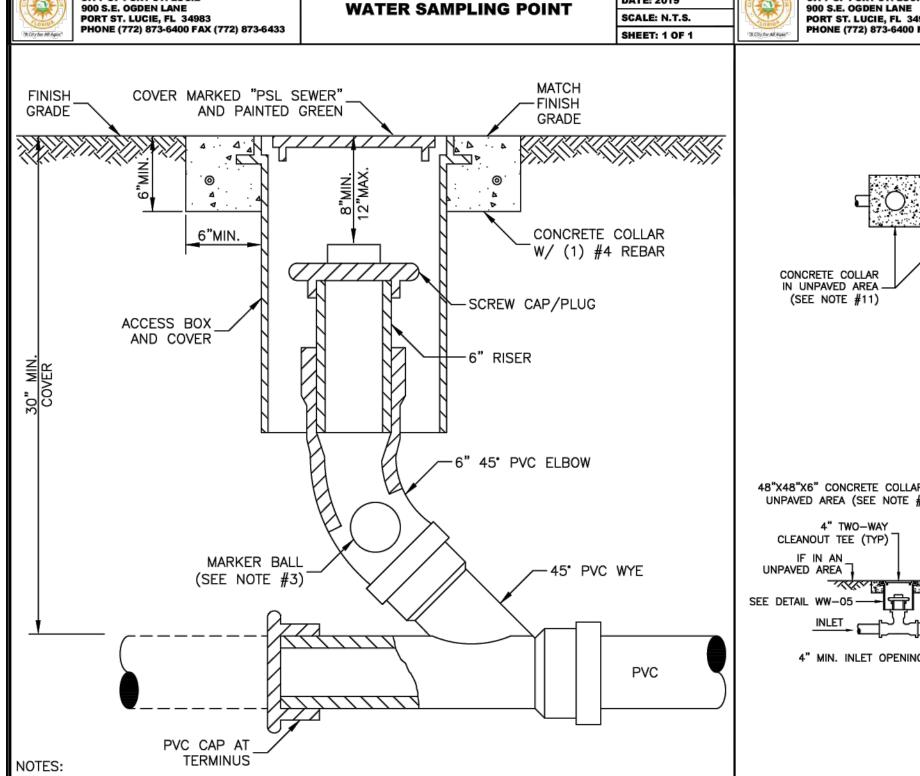

. AN ACCESS BOX AND COVER SHALL BE USED.

2. CLEANOUT ASSEMBLY SHALL BE INSTALLED AT A MAXIMUM 75' INTERVALS AND AT TERMINAL POINT OF THE PSLUSD RESPONSIBILTY. THE LOCATION SHALL BE IN ACCORDANCE WITH THE PSLUSD UTILITY STANDARDS.

3. MARKER BALL SHALL BE STRAPPED TO THE ELBOW.

MINIMUM CONSTRUCTION STANDARDS FOR CITY OF PORT ST. LUCIE 900 S.E. OGDEN LANE PORT ST. LUCIE, FL 34983 PHONE (772) 873-6400 FAX (772) 873-6433

SANITARY SEWER CLEANOUT

**DETAIL: WW-05** DATE: 2019 SCALE: N.T.S. SHEET: 1 OF 1

900 S.E. OGDEN LANE PORT ST. LUCIE, FL 34983 PHONE (772) 873-6400 FAX (772) 873-6433

CITY OF PORT ST. LUCIE

900 S.E. OGDEN LANE PORT ST. LUCIE, FL 34983

CONCRETE COLLAR

(SEE NOTE #11)

IN UNPAVED AREA

48"X48"X6" CONCRETE COLLAR IN

CLEANOUT TEE (TYP)

UNPAVED AREA

UNPAVED AREA (SEE NOTE #11)

4" MIN. INLET OPENING -

PHONE (772) 873-6400 FAX (772) 873-6433

**GREASE, OIL, AND SAND** INTERCEPTOR

12"MAX.

24" COVER IDENTIFIED WITH

SOLID CONCRETE OR

BRICK AS NECCESSARY

LID (SEE NOTE #9)

F IN A PAVED AREA

4" MIN. INLET OPENING

AND PREFABRICATED

PIPE BOOT WITH S.S.

CLAMP OR GASKET

STAINLESS STEEL

NUTS AND BOLTS

(TYPICAL)

BRACES, BRACKETS,

-ACCESS BOX / COVER


WORD "GREASE" (TYP)

/ WATER

LEVEL

DETAIL: WW-10 DATE: 2019 SCALE: N.T.S. SHEET: 2 OF 2

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1449 NW COMMERCE CENTRE DR

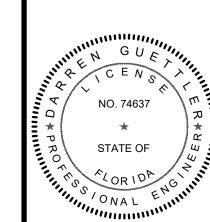PORT ST. LUCIE, FL 34986

PHONE: (772) 879-0477

FBPE C.O.A. # 32222

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G 03-07-23

DARREN GUETTLER, PI FLORIDA LICENSE No. 74637 5/3/23

PROJECT No. DRAWN BY: CHECKED BY: CAD I.D.: 22- 1037 - WS DETAILS

SHEET TITLE:

WATER AND


**SEWER DETAILS** 

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KNOW WHAT'S BELO

CITY OF PSL PROJECT NO. P20-068-A

PSLUSD FILE NO. 5203I-4

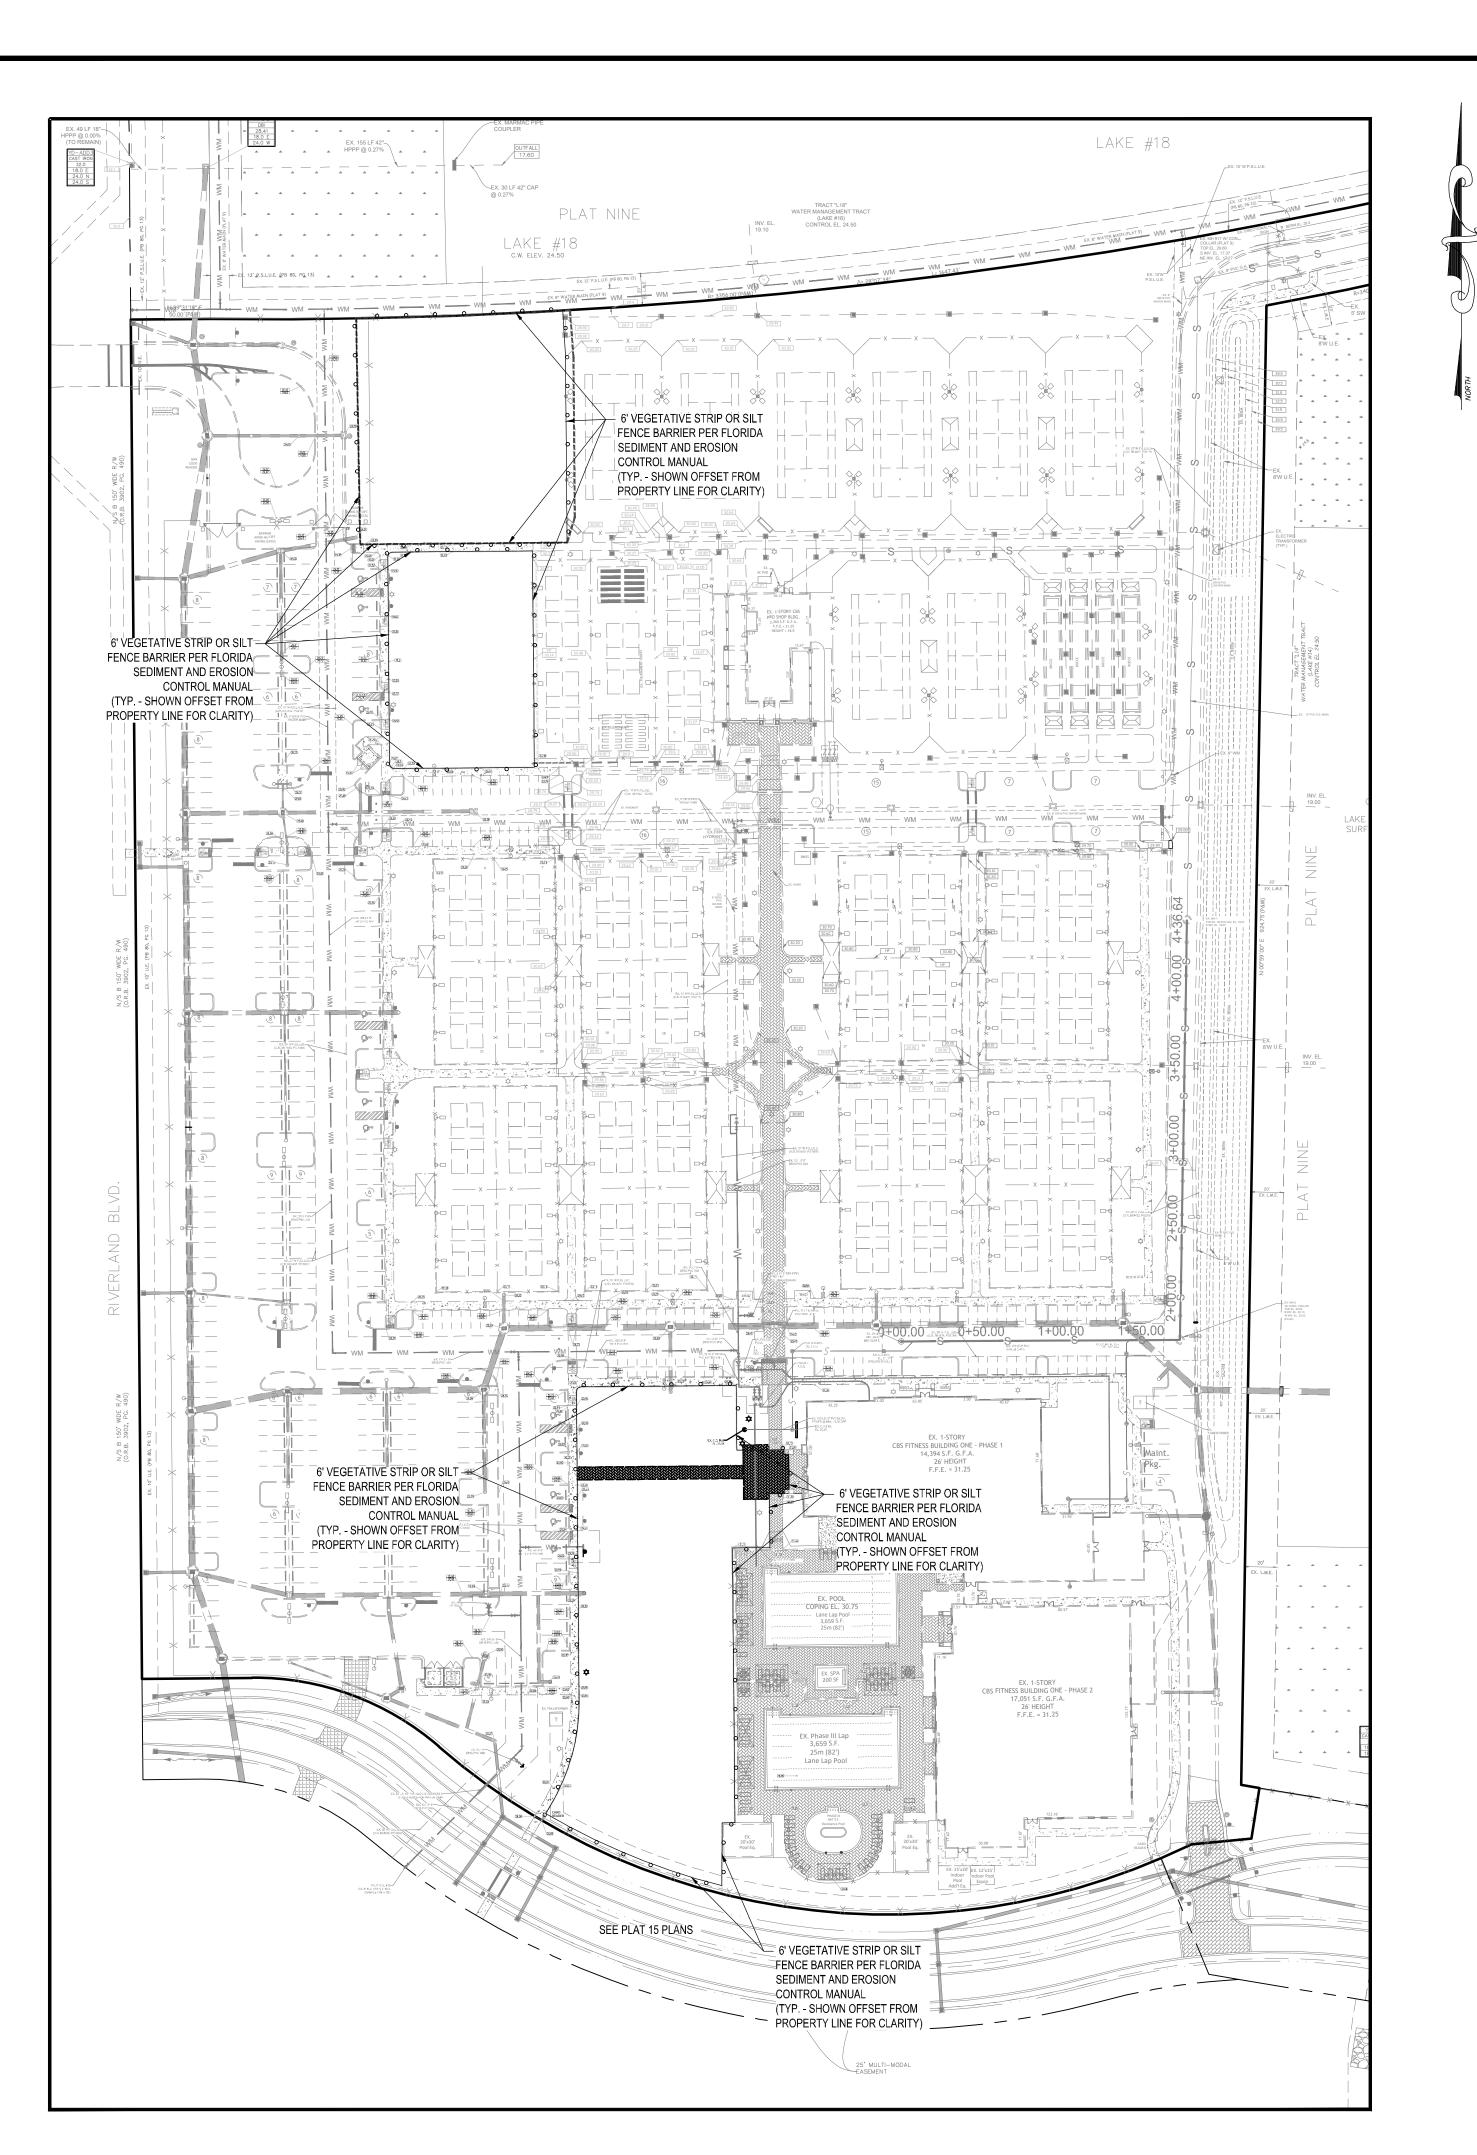

THE PROPERTY OWNER, CONTRACTOR, AND AUTHORIZED REPRESENTATIVES SHALL PROVIDE PICKUP, REMOVAL, AND DISPOSAL OF LITTER WITHIN THE PROJECT LIMITS AND SHALL BE RESPONSIBLE FOR MAINTENANCE OF THE AREA FROM THE EDGE OF PAVEMENT TO THE PROPERTY LINE WITHIN THE CITY'S RIGHT-OF-WAY IN ACCORDANCE WITH CITY CODE, SECTION 41.08(g).

**ENVIRONMENTAL STATEMENT:** THIS SITE WAS INCLUDED IN THE OVERALL RIVERLAND ENVIRONMENTAL SITE ASSESSMENT AND THIS AREA OF THE DEVELOPMENT IS PART OF THE MASTER GRADING PLAN THAT WAS APPROVED BY THE CITY AND IS CURRENTLY IN OPERATION.

> NOTE:
> EROSION AND SEDIMENT CONTROL - CONTRACTOR IS RESPONSIBLE FOR PROVIDING AND MAINTAINING EROSION AND SEDIMENT CONTROL USING THE LATEST F.D.O.T. STANDARDS. BALED HAY, STRAW, AND SILTATION BARRIERS WILL BE INSTALLED WHERE NEEDED TO PREVENT SILTATION OF ADJACENT PROPERTY, PUBLIC RIGHT-OF-WAY, WETLANDS AND WATERWAYS. THESE WILL REMAIN IN PLACE UNTIL GRASSING OR SODDING HAS BEEN COMPLETED OR UNTIL SILTATION AND EROSION ARE NO LONGER A THREAT TO ADJACENT PROPERTIES AND WATERWAYS. STREET SWEEPING SHALL BE PERFORMED ANYTIME SEDIMENT HAS BEEN TRACKED ONTO THE ADJACENT ROADWAYS FROM THE SITE OR THE SITE DRIVEWAYS. SHOULD DUST BECOME AN ISSUE, ALL UNSTABILIZED AREAS SHALL BE WETTED DOWN SUFFICIENTLY IN ORDER TO PREVENT DUST.


#### PERIMETER VEGETATIVE STRIP OR SILT FENCE SHALL BE IN PLACE PRIOR TO CLEARING

PROJECT AREA: 715,719 S.F. (16.430 AC) AREA TO BE CLEARED: 61,803 S.F. (1.419 AC)

LEGEND							
WM	EXISTING WATER MAIN						
FM	EXISTING FORCE MAIN						
s	EXISTING GRAVITY SEWER MAIN						
	EXISTING EDGE OF PAVEMENT TO REMAIN						
	EXISTING EDGE OF PAVEMENT TO BE REMOVED						
	CONCRETE TO BE REMOVED						
<b>\( \)</b>	EXISTING LIGHT POLE TO BE REMOVED						
) <u>0</u> 00	6" VEGETATIVE STRIP OR SILT FENCE						

1449 NW COMMERCE CENTRE DR PORT ST. LUCIE, FL 34986 PHONE: (772) 879-0477 FBPE C.O.A. # 32222 REVISIONS:

COMMENT: REVISED PER SG 03-07-23 SPRC COMMENTS REVISED PER SG 04-10-23 SPRC COMMENTS

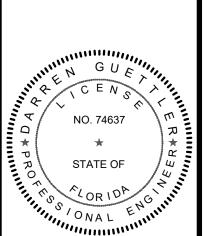

DARREN GUETTLER, PE FLORIDA LICENSE No. 74637 5/3/23

DRAWN BY: CHECKED BY: DATE: 11/29/2022 CAD I.D.:22- 1037 - STORMWATER

**CLEARING AND SEDIMENT & EROSION CONTROL PLAN** 

KNOW WHAT'S BELO ALWAYS CALL 81 BEFORE YOU DIC www.callsunshine.com

Section 19	Provide a detailed description of the maintenance plan for all structural and non-structural controls to assure that they remain in good and effective operating condition.
	Contractor shall provide routine maintenance of permanent and temporary sediment and erosion control
	<ul> <li>• Silt fence shall be inspected at least weekly. Any required repairs shall be made immediately. Sediment deposits shall be removed when they reach approximately one-half the height of the barrier.</li> <li>• Maintenance shall be performed on the rock entrance when any void spaces are full of sediment.</li> <li>• Inlet(s)/outfalls shall be inspected immediately after each rain event and any required repairs to the filter</li> </ul>
	<ul> <li>inlets, silt fence, or filter fabric shall be performed immediately.</li> <li>Bare areas of the site that were previously seeded shall be reseeded per manufactures' instructions.</li> <li>Mulch and sod that has been washed out shall be replaced immediately.</li> <li>Maintain all other areas of the site with proper controls as necessary.</li> </ul>
Section 20	Inspections: Describe the inspection and inspection documentation procedures, as required by the FDEP NPDES Generic Permit for Stormwater Discharge from Large and Small Construction Activities.
	Qualified personnel will inspect all points of discharges, all disturbed areas of construction that have not been stabilized, constructed areas and locations where vehicles enter and exit the site, and all BMPs at least once every 7 calendar days and within 24 hours of the end of a rainfall event that is 0.5 inches or greater. Where sites have been finally stabilized, said inspections shall be conducted at least once every month until the Notice of Termination is filed.
Section 21	Identify and describe all sources of non-stormwater discharges as allowed by the FDEP NPDES Generic Permit for Stormwater Discharge from Large and Small Construction Activities.
	The contractor is required to submit a dewatering plan to SFWMD for approval prior to commencement of any construction activities that require dewatering. This plan shall include any stockpile areas and excavation area The contractor is responsible for documenting this portion of the SWPPP. If contaminated soil or groundwater is encountered, contact the District Hazardous Materials Coordinator
Section 22	Site Map
	The construction plans will substitute as site maps. Locations of the required information are described below Drainage Patterns:
	The drainage flow directions are shown on the Paving and Drainage Plan.  Approximate Slopes:  The slopes of the site can be seen on the Grading and Drainage plan and cross sections.
	Areas of Soil Disturbance:  The areas to be disturbed are indicated on the plan. Any areas where permanent features are
	Areas not to be disturbed:  Those areas shown outside of the limits of the silt fence will not be disturbed.
	Locations of Controls:  The erosion control devices and locations are shown on the Sediment & Erosion Control Plan.
	Areas to be stabilized:  Temporary stabilization practices are also shown on the plans, if applicable. Areas of permanent stabilization are shown on the Paving and Drainage Plan.
	Surface Water: Surface water for the project is collected by inlets and culverts and directed to the Water Management Tracts within the Riverland Development, which are part of the Riverland Master Stormwater Management System. All water quality and attenuation is provided by the master system.
	Receiving Waters:  The Riverland Master Stormwater Management System discharges to the C-23 Canal and the ultimate outfall is the North Fork of the St. Lucie River.
Section 23	All contractor(s) and subcontractor(s) identified in the SWPPP must sign the following certification:
	"I certify under penalty of law that I understand, and shall comply with, the terms and conditions of the State of Florida Generic Permit for Stormwater Discharge from Large and Small Construction Activities and this Stormwater Pollution Prevention Plan prepared thereunder. This document and all attachments were prepare under my direction or supervision in accordance with a system designed to assure that qualified personnel properly gathered and evaluated the information submitted. Based on my inquiry of the person or persons who manage the system, or those persons directly responsible for gathering the information, the information submitted is, to the best of my knowledge and belief, true, accurate, and complete. I am aware that there are significant penalties for submitting false information, including the possibility of fine and imprisonment for knowing violations."


#### Section 23

area shall be designated at all times and will not be located in any area that will allow for the discharge of


polluted runoff.

All construction materials and debris will be placed in a dumpster and hauled off site to a landfill or other proper disposal site. No materials will be buried on site.	Name	Title	Company Name, Address and Phone Number	Responsible Items	Date
Off site vehicle tracking of sediments and dust generation will be minimized via a rock construction entrance, street sweeping and the use of water to keep dust down.					
Florida-friendly fertilizers and pesticides will be used at a minimum and in accordance with the manufacturer's suggested application rates.					
All paints and other chemicals will be stored in a locked covered shed.					
Port-o-lets will be placed away from storm sewer systems, storm inlet(s), surface waters and wetlands. No vehicle maintenance shall be conducted on-site. A washdown					


Name (Operator and/or Responsible Authority)

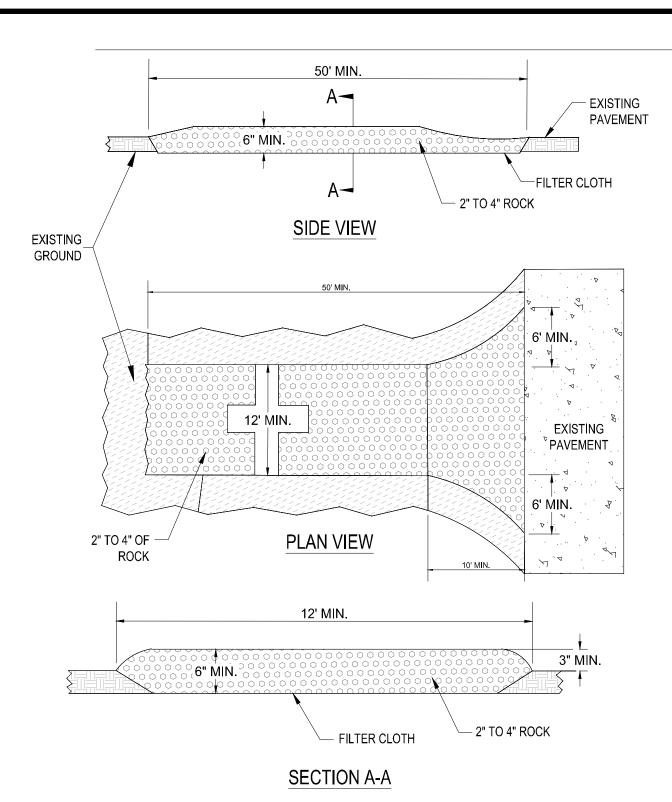

## SOIL TRACKING PREVENTION DEVICE

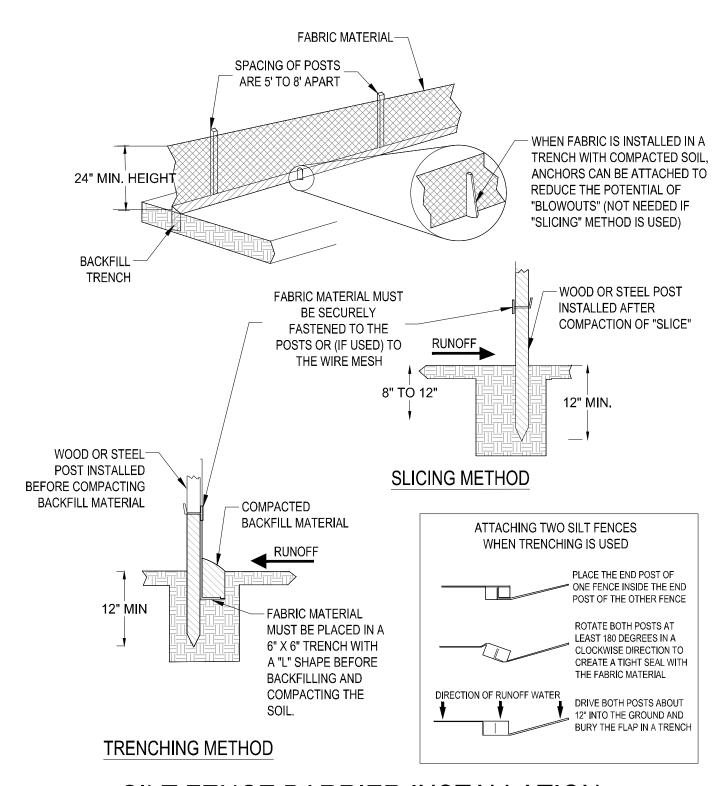


#### SILT FENCE BARRIER INSTALLATION

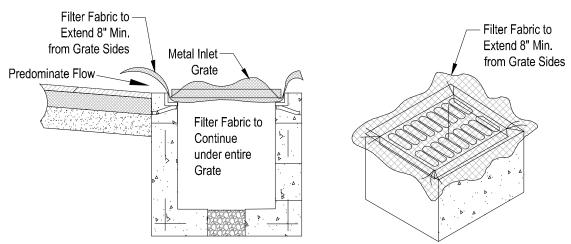

PICTORIAL VIEW

**GENERAL NOTES:** 1. THIS INLET IS DESIGNED WITH FILTER FABRIC PROTRUDING 8" FROM SIDES FOR GRIPPING WHEN SEDIMENT NEEDS TO BE CLEARED AFTER FINAL CONSTRUCTION. 2. FILTER FABRIC TO BE INSTALLED AND TRIMMED BEFORE GRATE IS INSET.

FILTER FABRIC DETAIL

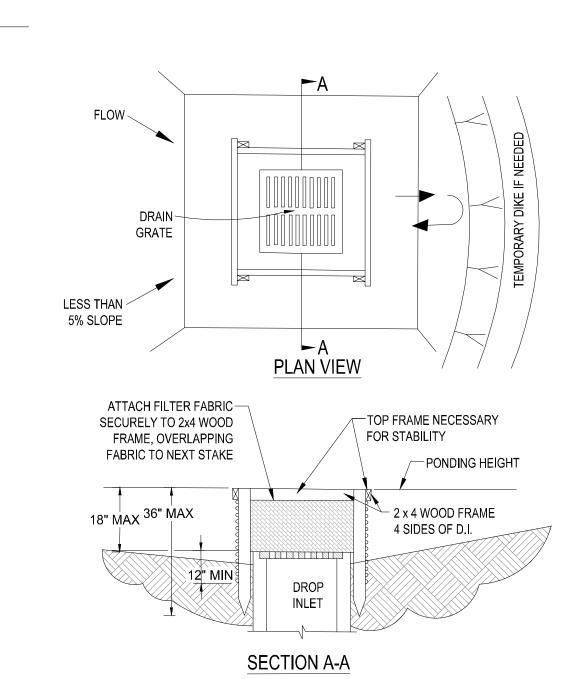


1. DROP INLET SEDIMENT BARRIERS ARE TO BE USED FOR SMALL, NEARLY LEVEL DRAINAGE AREAS. (LESS

2. USE 2 x 4 WOOD OR EQUIVALENT METAL STAKES, (3' MIN. LENGTH)

3, INSTALL 2 x 4 WOOD TOP FRAME TO INSURE STABILITY. 4. THE TOP OF THE FRAME (PONDING HEIGHT) MUST BE WELL BELOW THE GROUND ELEVATION DOWNSLOPE TO PREVENT RUNOFF FROM BYPASSING THE INLET. A TEMPORARY DIKE MAY BE NECESSARY ON THE DOWNSLOPE OF THE STRUCTURE.

## SILT FENCE DROP INLET SEDIMENT BARRIER

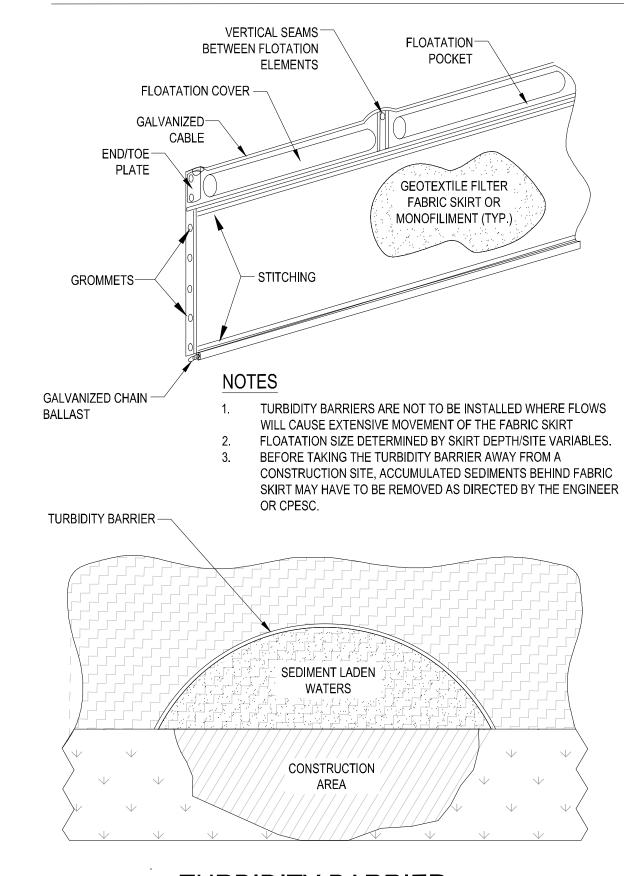





CITY OF PSL PROJECT NO. P20-068-A

Section 18 Other:

PSLUSD FILE NO. 5203I-4

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NGINEERING & SURVEYING,

1449 NW COMMERCE CENTRE DR

PORT ST. LUCIE, FL 34986

COMMENT:

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SPRC COMMENTS

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SPRC COMMENTS

PHONE: (772) 879-047 FBPE C.O.A. # 32222

REVISIONS:

SG 03-07-23

DARREN GUETTLER, PE FLORIDA LICENSE No. 74637 5/3/23

PROJECT No. DRAWN BY: CHECKED BY: DATE: 11/29/2022 CAD I.D.:22- 1037 - STORMWATER

SHEET TITLE: **STORMWATER POLLUTION** PREVENTION PLAN

SHEET NUMBER: